



SAN STRUCTURE TABLE				
NAME	RIM ELEV.	INVERT IN	INVERT OUT	DESCRIPTION
MH2A	75.79	S673.520	N73.278	STRUC. OPSD 701.011 COVER CITY 524 FRAME CITY 525
MH2B	75.25	S73.111	N71.194	STRUC. OPSD 701.011 COVER CITY 524 FRAME CITY 525 C/W EXTERNAL DITCH STRUCTURE PER OPSD 1003.010
MH2C	71.16	S68.710	NW68.650	STRUC. OPSD 701.011 COVER CITY 524 FRAME CITY 525
MH2D	70.11	S667.200	SW66.440	STRUC. OPSD 701.011 COVER CITY 524 FRAME CITY 525 C/W EXTERNAL DITCH STRUCTURE PER OPSD 1003.010
MH2E	69.45	NE65.500	NW65.080	STRUC. OPSD 701.011 COVER CITY 524 FRAME CITY 525

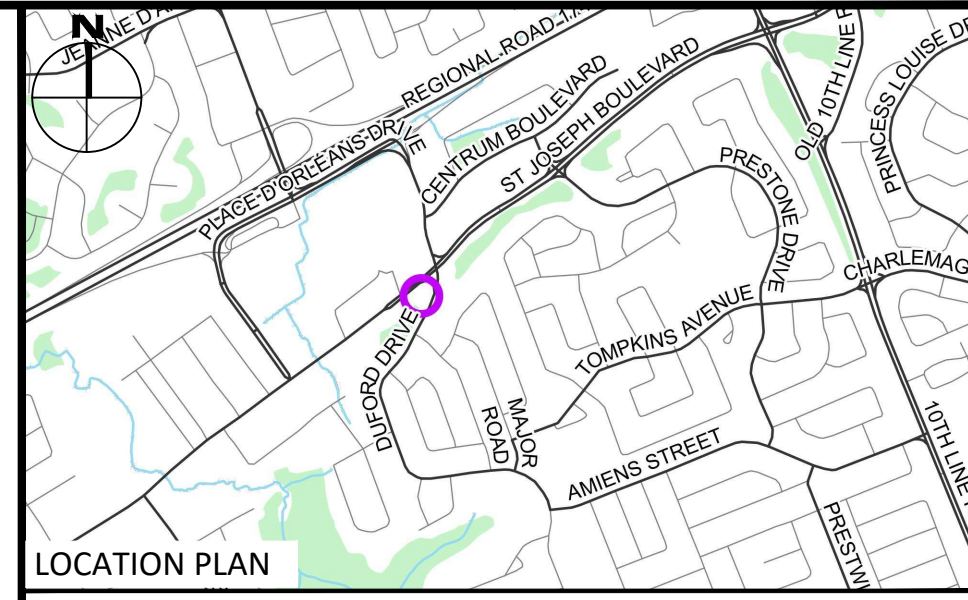

LEGEND	
UC	BARRIER CURB & CURB DEPRESSION
PROPOSED CONCRETE PAVERS	SLOPING AT 3:1 UNLESS SPECIFIED
MHR	STORM MANHOLE
CB	CATCHBASIN, CURB INLET OR DITCH INLET
MHRB	SANITARY MANHOLE
PROPERTY LINE	PROPERTY LINE
EX. WATER VALVE/CHAMBER	EX. WATER VALVE/CHAMBER
PROP. VALVE PER CITY W24	PROP. VALVE PER CITY W24
FIRE HYDRANT	FIRE HYDRANT
PROPOSED WALL	PROPOSED WALL
PROPOSED SIAMENSE CONNECTION	PROPOSED SIAMENSE CONNECTION
PROPOSED WATER METER AND REMOTE METER	PROPOSED WATER METER AND REMOTE METER
PROPOSED CONCRETE SIDEWALK	PROPOSED CONCRETE SIDEWALK
PROP AND EX. REDUCER	PROP AND EX. REDUCER
U/G HYDRO DUCT PER ELEC.	U/G HYDRO DUCT PER ELEC.
EX. STM SEWER	EX. STM SEWER
EX. SAN SEWER	EX. SAN SEWER
PROPOSED ELEVATION EXISTING ELEVATION	PROPOSED ELEVATION EXISTING ELEVATION
SWALE ELEVATION	SWALE ELEVATION
TOP/BOTTOM WALL FACE ELEVATIONS	TOP/BOTTOM WALL FACE ELEVATIONS
PROPOSED EMERGENCY OVERLAND FLOW ROUTE	PROPOSED EMERGENCY OVERLAND FLOW ROUTE
PRE AND POST-DEVELOPMENT DRAINAGE DIRECTIONS	PRE AND POST-DEVELOPMENT DRAINAGE DIRECTIONS
HEAVY DUTY SILT FENCE BARRIER PER OPSD 219.130	HEAVY DUTY SILT FENCE BARRIER PER OPSD 219.130
BUILDING ENTRANCE	BUILDING ENTRANCE
PROPOSED GRASS	PROPOSED GRASS
CENTRELINE OF SWALE	CENTRELINE OF SWALE
PROPOSED ROAD/CUT AND REINSTATEMENT PER CITY R10	PROPOSED ROAD/CUT AND REINSTATEMENT PER CITY R10
CB SILT SACK PER C101 DETAIL	CB SILT SACK PER C101 DETAIL
SERVICE/SEWER CROSSING	SERVICE/SEWER CROSSING
EX. G. STREET LIGHT	EX. G. STREET LIGHT
EX. TRAFFIC LINE	EX. TRAFFIC LINE
EX. WATERMAIN	EX. WATERMAIN
EX. GAS	EX. GAS
EX. OHW	EX. OHW
EX. TRAFFIC CABLE	EX. TRAFFIC CABLE
EX. BELL	EX. BELL
EX. ROGERS	EX. ROGERS

SUBJECT TO APPROVAL

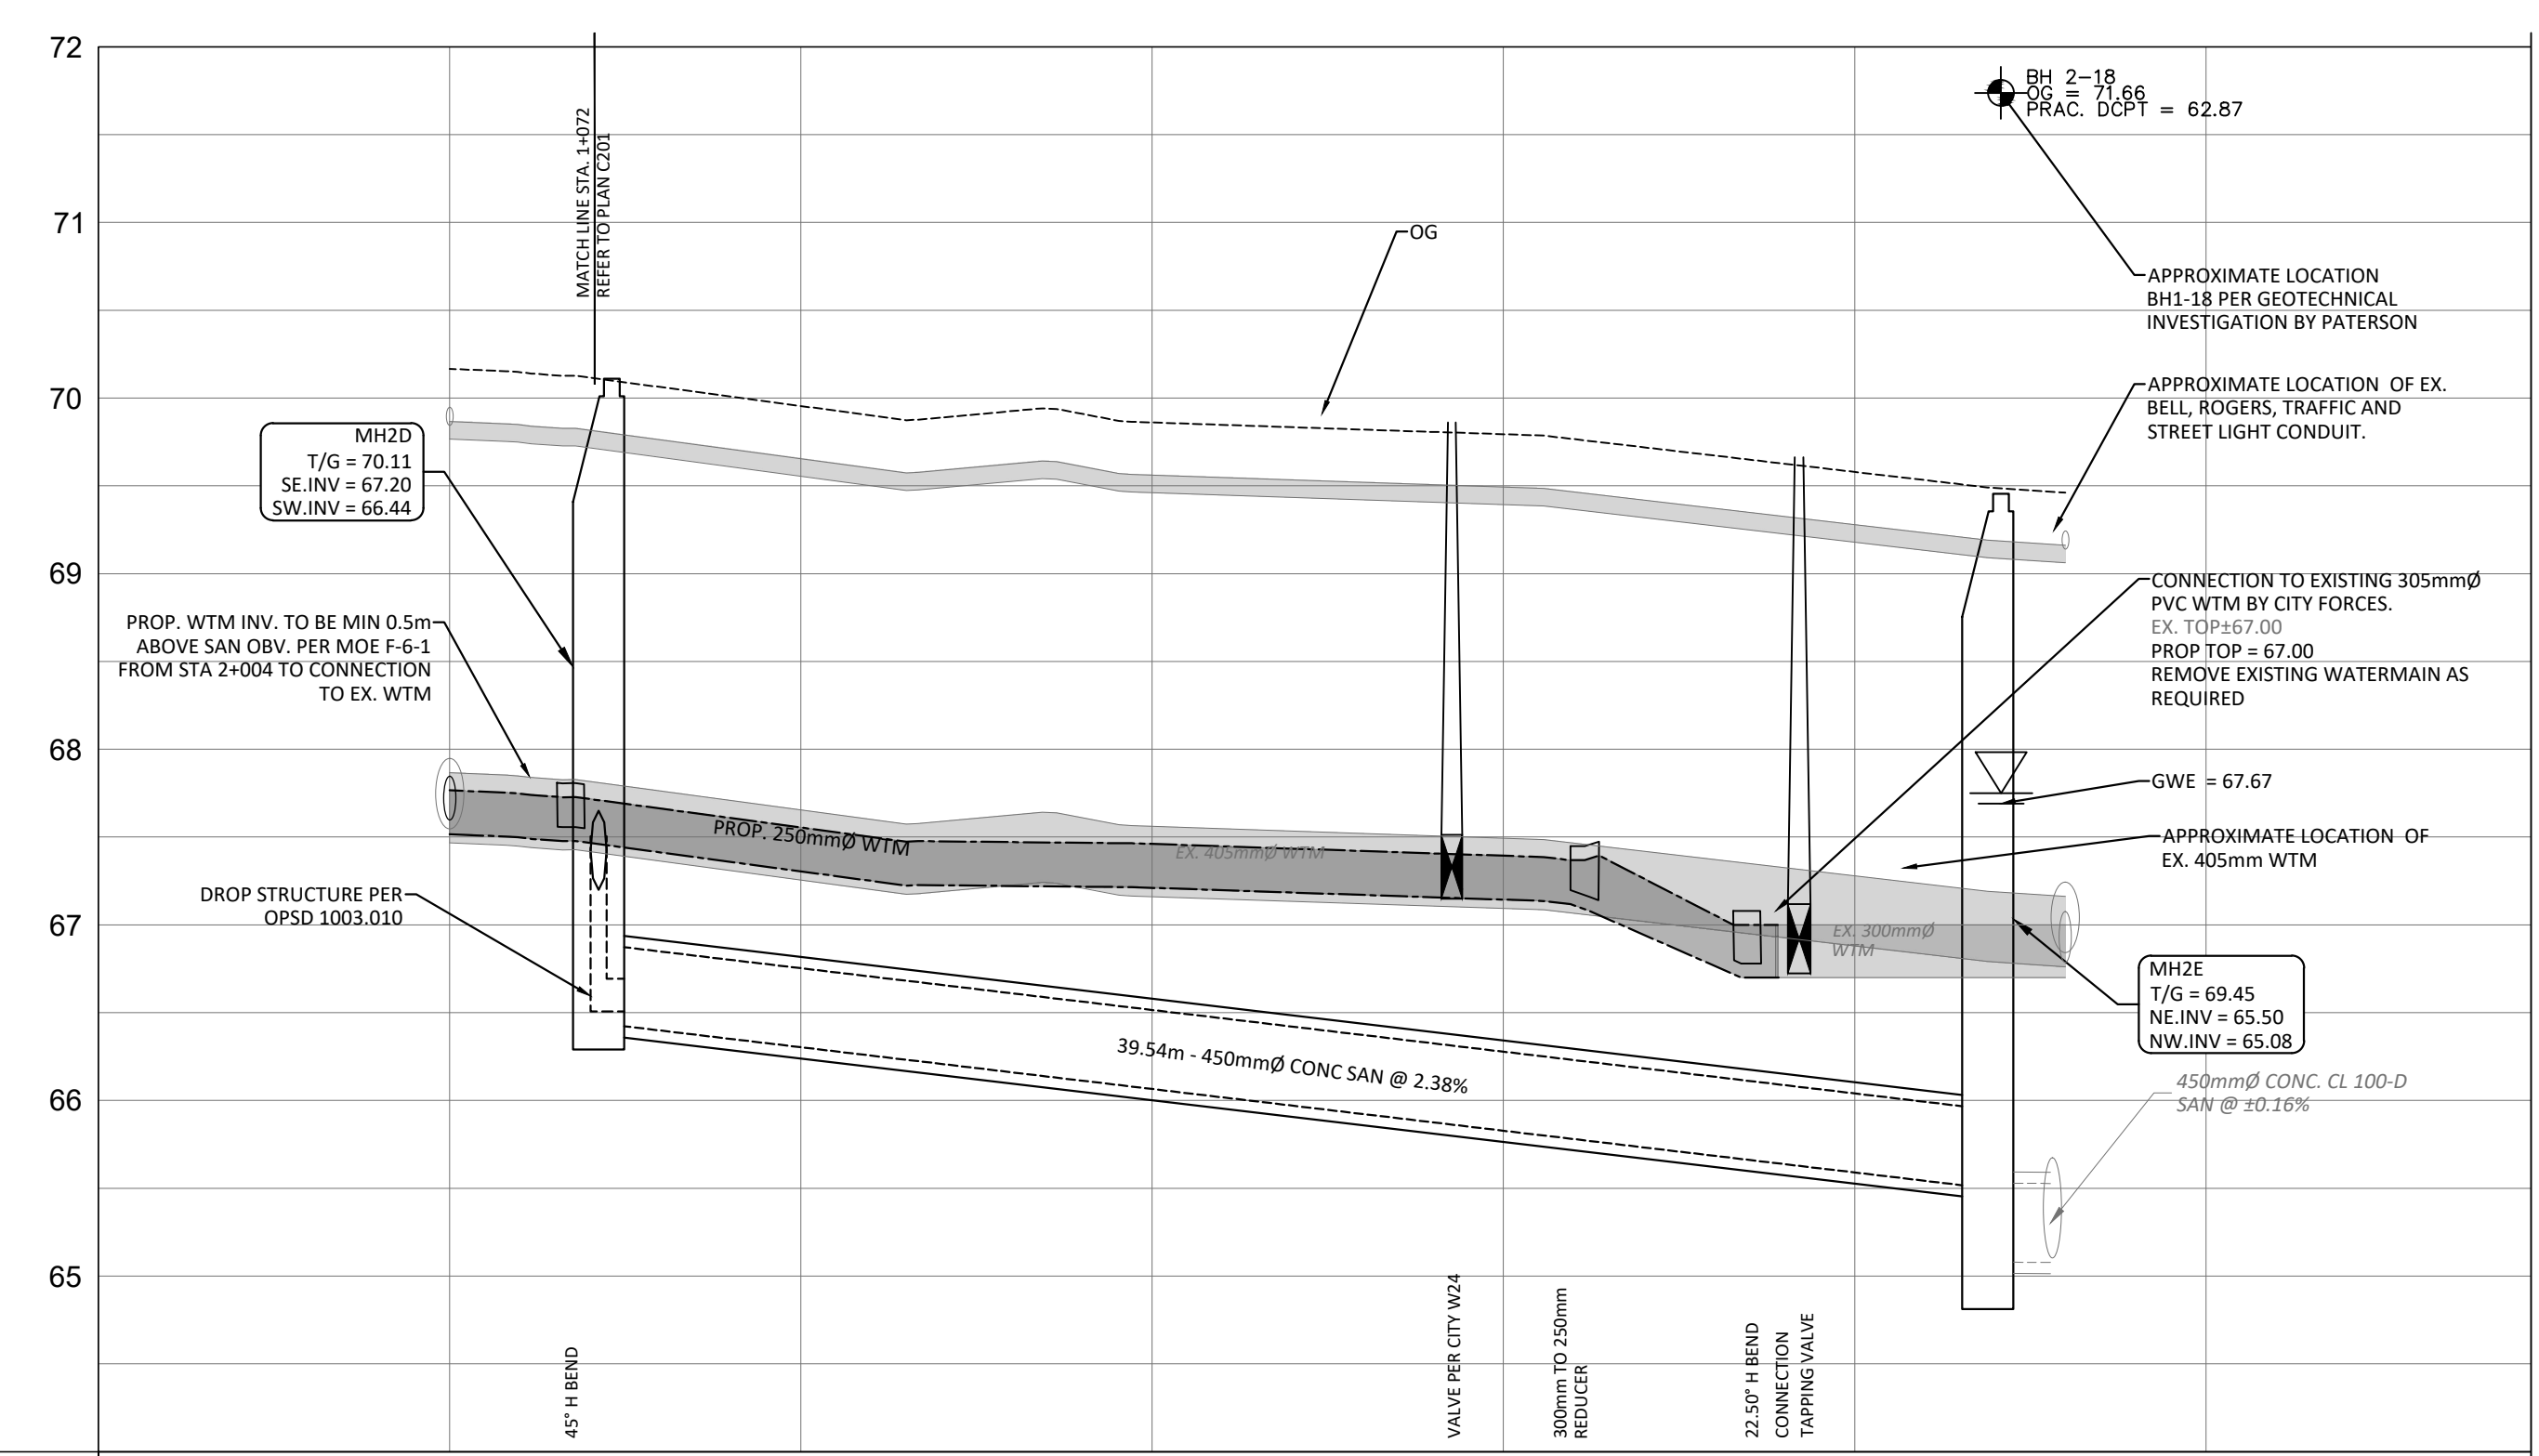


STATION	TOP OF WATERMAIN	SANITARY SEWER	PROPOSED
2+003	67.73	66.44	67.73
2+004	67.71		67.71
2+029			67.40
2+032			67.37
2+037			67.00
2+038			67.00
2+038			67.00


NOTE: CONTRACTOR IS TO PREPARE A SEWER FLOW MANAGEMENT PLAN TO THE SATISFACTION OF THE CITY PRIOR TO CONSTRUCTION.

No.	Revisions	Date
2	ISSUED FOR REVIEW	JUL 31, 2024
1	ISSUED FOR SITE PLAN CONTROL	MAR 07, 2024

Check and verify all dimensions before proceeding with the work. Do not scale drawings.

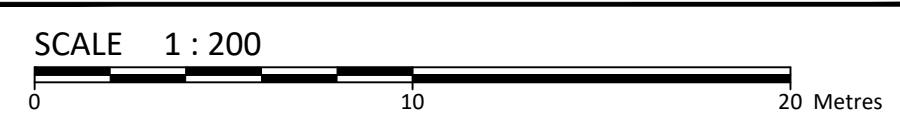

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Client: **THEBERGE DEVELOPMENTS LTD**
1600 LAPERRIERE AVE
OTTAWA, ON K1Z 8P5

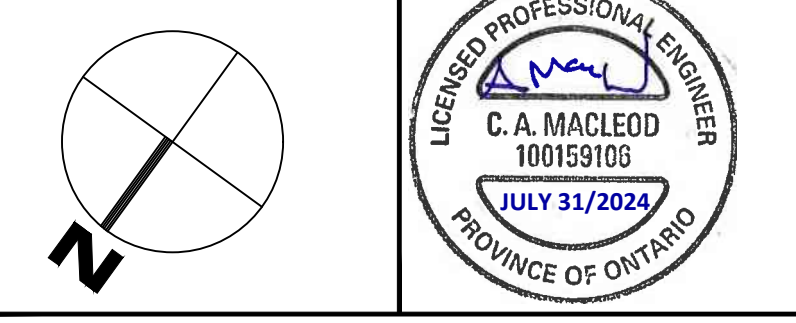Project: **3030 ST. JOSEPH BOULEVARD**
OTTAWA ON

Drawing Title: **PLAN & PROFILE STA. 2+000 TO 2+040**

Scale: 1:200	Project Number: CCO-24-0142
Drawn By: RRR	Checked By: AM
Designed By: RRR	Drawing Number: C202

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LAST SAVED: Wednesday, July 31, 2024 10:54 AM
LAST SAVER: B. J. R. / B. J. R.
LAST PLOTTED: Wednesday, July 31, 2024 10:54 AM
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