EROSION AND SEDIMENT CONTROL MEASURES:

** CONTRACTOR IS RESPONSIBLE FOR ALL INSTALLATION, MONITORING, REPAIR AND REMOVAL OF ALL EROSION AND SEDIMENT CONTROL FEATURES **

1. PRIOR TO START OF CONSTRUCTION:

- 1.1. PRIOR TO THE REMOVAL OF ANY VEGETATIVE COVER, MOVING OF ANY SOIL, AND CONSTRUCTION:1.1.1. INSTALL SILT FENCE IMMEDIATELY DOWNSTREAM
- LOCATION).

 1.1.2. INSTALL GEOSOCK INSERTS WITH AN OVERFLOW IN ALL THE DOWNSTREAM CATCH BASINS AND MANHOLES.

 1.1.3. INSTALL SILTSACK FILTERS IN ALL CONCRETE CATCH BASIN STRUCTURES.
- BASIN STRUCTURES.

 1.1.4. INSPECT MEASURES IMMEDIATELY AFTER INSTALLATION.

FROM AREAS TO BE DISTURBED (SEE PLAN FOR

2. DURING CONSTRUCTION:

DAYS).

- 2.1. WORK TO BE DONE IN THE VICINITY OF MAJOR WATERWAYS TO BE CARRIED OUT FROM JULY TO SEPTEMBER ONLY.
- 2.2. MINIMIZE THE EXTENT OF DISTURBED AREAS AND THE DURATION OF EXPOSURE.
- 2.3. PROTECT DISTURBED AREAS FROM RUNOFF.2.4. PROVIDE TEMPORARY COVER SUCH AS SEEDING OR
- MULCHING IF DISTURBED AREA WILL NOT BE REHABILIATED WITHIN 30 DAYS.

 2.5. INSPECT SILT FENCE, FILTER CLOTHS, AND CATCH BASIN
- SUMPS WEEKLY AND AFTER EVERY MAJOR STORM EVENT.
 CLEAN AND REPAIR WHEN NECESSARY
 2.6. PLAN TO BE REVIEWED AND REVISED AS REQUIRED
- DURING CONSTRUCTION.
 2.7. EROSION CONTROL FENCING TO BE ALSO INSTALLED
- AROUND THE BASE OF ALL STOCKPILES.

 2.8. DO NOT LOCATE TOPSOIL PILES AND EXCAVATION
 MATERIAL CLOSER THAN 2.5m FROM ANY PAVED SURFACE,
 OR ONE WHICH IS TO BE PAVED BEFORE PILE IS REMOVED.
 ALL TOPSOIL PILES ARE TO BE SEEDED IF THEY ARE TO
 REMAIN ON SITE LONG ENOUGH FOR SEEDS TO GROW (30)

- 2.9. CONTROL WIND-BLOWN DUST OFF SITE TO ACCEPTABLE LEVELS BY SEEDING TOPSOIL PILES AND OTHER AREAS
- TEMPORARILY (PROVIDE WATERING AS REQUIRED).

 2.10. ALL EROSION CONTROL STRUCTURE TO REMAIN IN PLACE UNTIL ALL DISTURBED GROUND SURFACES HAVE BEEN STABILIZED EITHER BY PAVING OR RESTORATION OF VEGETATIVE GROUND COVER.

2.11. NO ALTERNATE METHODS OF EROSION PROTECTION

- SHALL BE PERMITTED UNLESS APPROVED BY THIS CONSULTING ENGINEER AND THE CITY DEPARTMENT OF PUBLIC WORKS. "TO PREVENT UNNECESSARY SEDIMENT DISCHARGE, THE CONTRACTOR IS PERMITTED TO PLACE ADDITIONAL SEDIMENT AND EROSION CONTROL MEASURES IN A TIMELY MANNER, IF REQUIRED. THE CONTRACTOR TO ADVISE CONSULTANT ONCE INSTALLED FOR INSPECTION."
- ADVISE CONSULTANT ONCE INSTALLED FOR INSPECTION."

 2.12. CONTRACTOR RESPONSIBLE FOR CITY ROADWAY AND SIDEWALK TO BE CLEANED OF ALL SEDIMENT FROM VEHICULAR TRACKING ETC, AT THE END OF EACH WORK
- 2.13. PROVIDE GRAVEL ENTRANCE WHEREVER EQUIPMENT LEAVES THE SITE TO PREVENT MUD TRACKING ONTO PAVED SURFACES. GRAVEL BED SHALL BE A MINIMUM OF 15m LONG. 4m WIDE AND 0.3m DEEP AND SHALL CONSIST OF COARSE (50mm CRUSHER-RUN LIMESTONE). MAINTAIN GRAVEL ENTRANCE IN CLEAN CONDITION.
- 2.14. DURING WET CONDITIONS, TIRES OF ALL VEHICLES/EQUIPMENT LEAVING THE SITE ARE TO BE SCRAPED.
- 2.15. ANY MUD/MATERIAL TRACKED ONTO THE ROAD SHALL BE REMOVED IMMEDIATELY BY HAND OR RUBBER TIRE LOADER.

 2.16. TAKE ALL NECESSARY STEPS TO PREVENT BUILDING
- MATERIAL, CONSTRUCTION DEBRIS OR WASTE BEING SPILLED OR TRACKED ONTO ABUTTING PROPERTIES OR PUBLIC STREETS DURING CONSTRUCTION AND PROCEED IMMEDIATELY TO CLEAN UP ANY AREAS SO AFFECTED.

3. AFTER CONSTRUCTION:

- 3.1. PROVIDE PERMANENT COVER CONSISTING OF TOPSOIL AND SEED TO DISTURBED AREA.
- 3.2. REMOVE STRAW BALE FLOW CHECK DAMS, SILT FENCES AND FILTER CLOTHS ON CATCH BASINS AND MANHOLE COVERS AFTER DISTURBED AREAS HAVE BEEN REHABILITATED AND STABILIZED.
- 3.3. INSPECT AND CLEAN CATCH BASIN SUMPS AND STORM SEWERS.

<u>LEGEND:</u>

EXISTING PROPERTY LINE TO REMAIN

×50.00 PROPOSED ELEVATION

×50.00 (SW) SWALE ELEVATION

×50.00 (BW) PROPOSED BOTTOM OF WALL ELEVATION

×50.00 (TW) PROPOSED TOP OF WALL ELEVATION

×50.00 (BC) PROPOSED BOTTOM OF CURB ELEVATION

×50.00 (TC) PROPOSED TOP OF CURB ELEVATION

×50.00 (ME) PROPOSED ELEVATION MATCH INTO

×50.00 (ME)

PROPOSED ELEVATION MATCH INTO EXISTING ELEVATION


×70.19

EXISTING ELEVATION


PROPOSED 200mmØ PERFORATED SUBDRAIN

PROPOSED STORM SEWER


- SAN - SAN - PROPOSED SANITARY SEWER

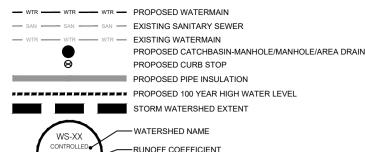


PROPOSED CONCRETE RETAINING WALL

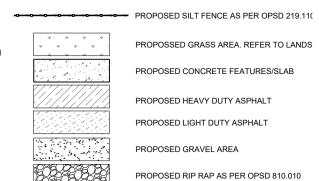


PROPOSED WATER METER

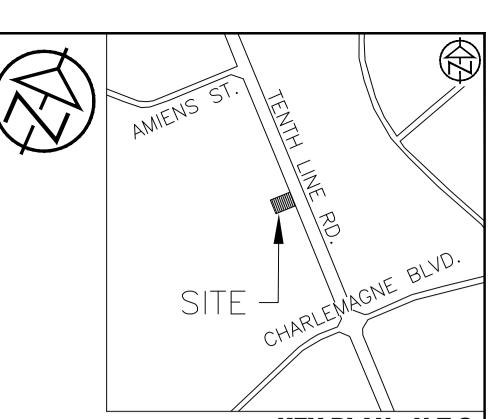

KEY PLAN - N.T.S.

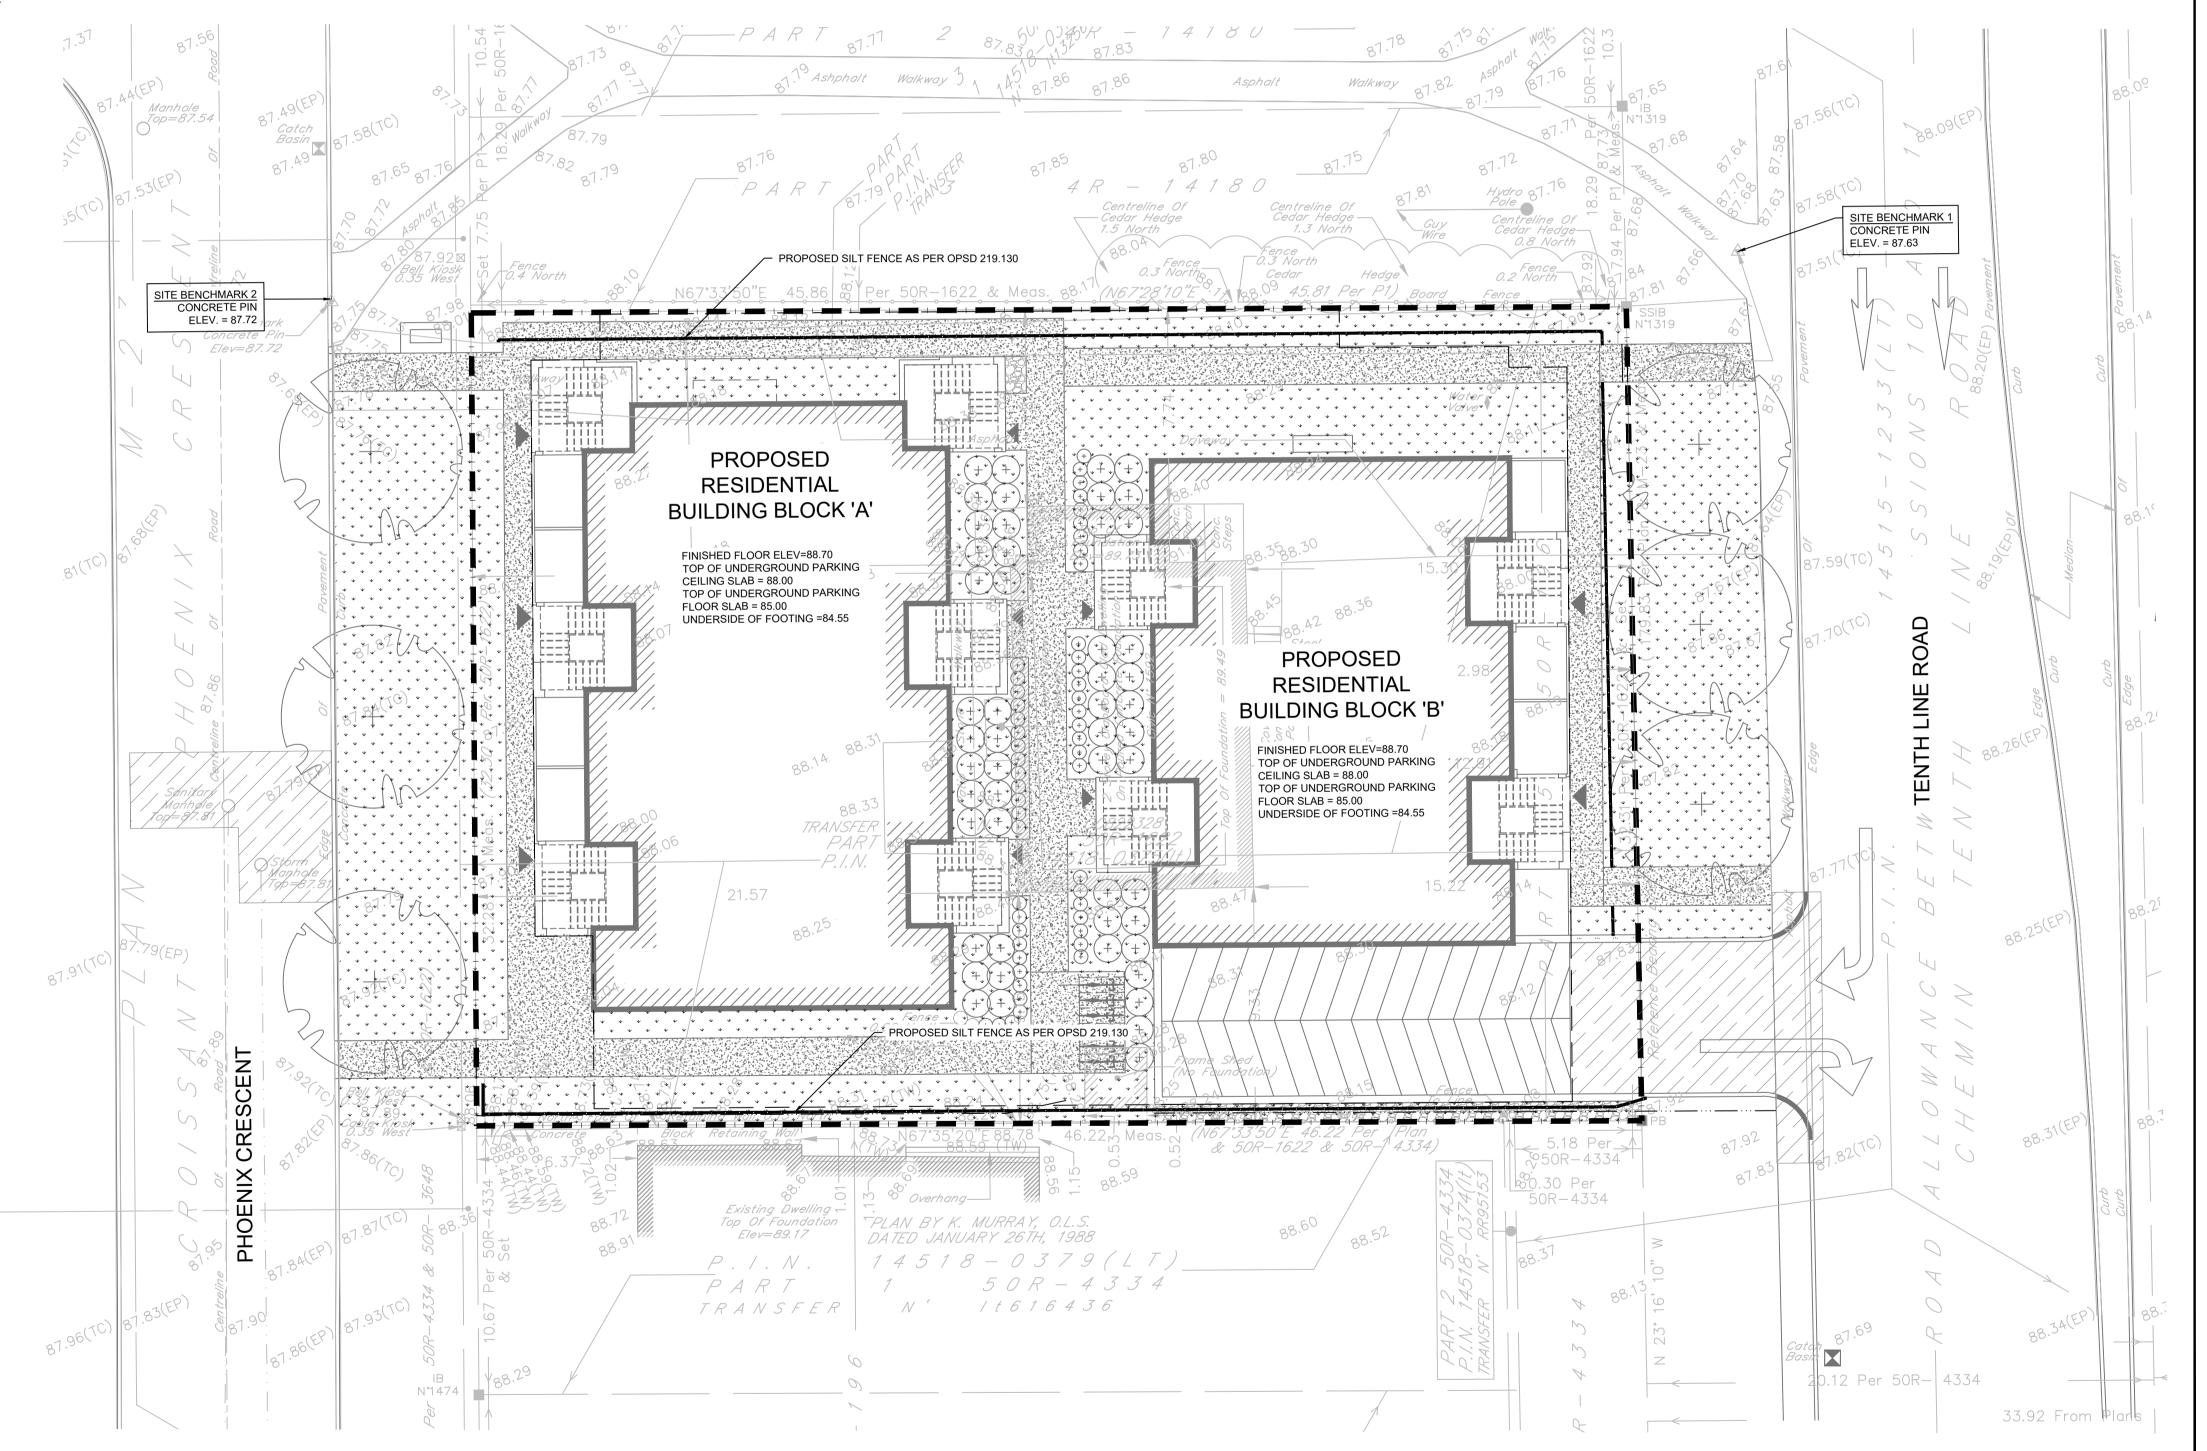

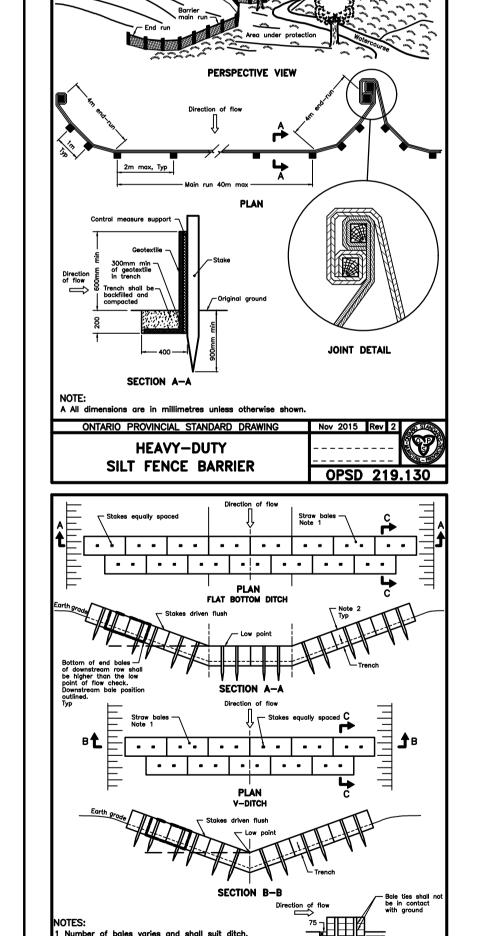

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STRAW BALE FLOW CHECK DAM

ONTARIO PROVINCIAL STANDARD DRAWING Nov 2015 Rev 2

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BENCHMARK2: CONCRETE PIN LOCATED ON NORTH WEST CORNER OF THE SITE, ELEVATION: 87.72

No. REVISION DESCRIPTION DATE

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ENGINEER STAMP

J. R. ASH
100123062

ROYNCE OF ONTROL

BRIDOR DEVELOPMENTS 1592 TENTH LINE ROAD CITY OF OTTAWA

SEDIMENT & EROSION CONTROL PLAN TATHAM
ENGINEERING

//GC FILE: 522677 DWG:

DESIGN: HY/GC FILE: 522677

DRAWN: HY DATE: NOV 2022

CHECK: GC SCALE: 1:150

C100