

1 EAST ELEVATION  
A3.00 Scale: 1: 200

2 EAST ELEVATION -WEST TOWER  
A3.00 Scale: 1: 200

**PROJECT TEAM**

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WIND FRIENDLY GLASS: AS PER CITY OF OTTAWA SAFETY GUIDELINES OUTLINE 2, TYPICAL TO OTTAWA  
1. GLASS PROVIDED FOR ALL BALCONY RAILINGS ON LEVEL 4  
2. GLASS PROVIDED FOR ALL BALCONY RAILINGS ON LEVEL 5  
3. GLASS PROVIDED FOR ALL BALCONY RAILINGS ON ROOF TERRACE LEVELS

1	210827	issued for rezoning
no.	date	revision

It is the responsibility of the appropriate contractor to check and verify all dimensions on site and report all errors and/or omissions to the architect.

All contractors must comply with all pertinent codes and by-laws.

Do not scale drawings.

This drawing may not be used for construction until signed.

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LEGEND:

NEW BUILD	
AF	ALUMINUM FLASHING
AP-1	ALUMINUM PANEL 1
BV-1	BRICK VEENER
GR	GLASS RAILING
MS-1	METAL SIDING 1
SP	SPANDREL PANEL
VG	VISION GLASS

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**HOBIN**  
ARCHITECTURE

PROJECT/LOCATION:  
1081 Carling

DRAWING TITLE:  
ELEVATIONS

DRAWN BY:  
PB/KM

DATE:  
210820

SCALE:  
1:200

PROJECT:  
2117


DRAWING NO.:

A3-00

REVISION NO.:





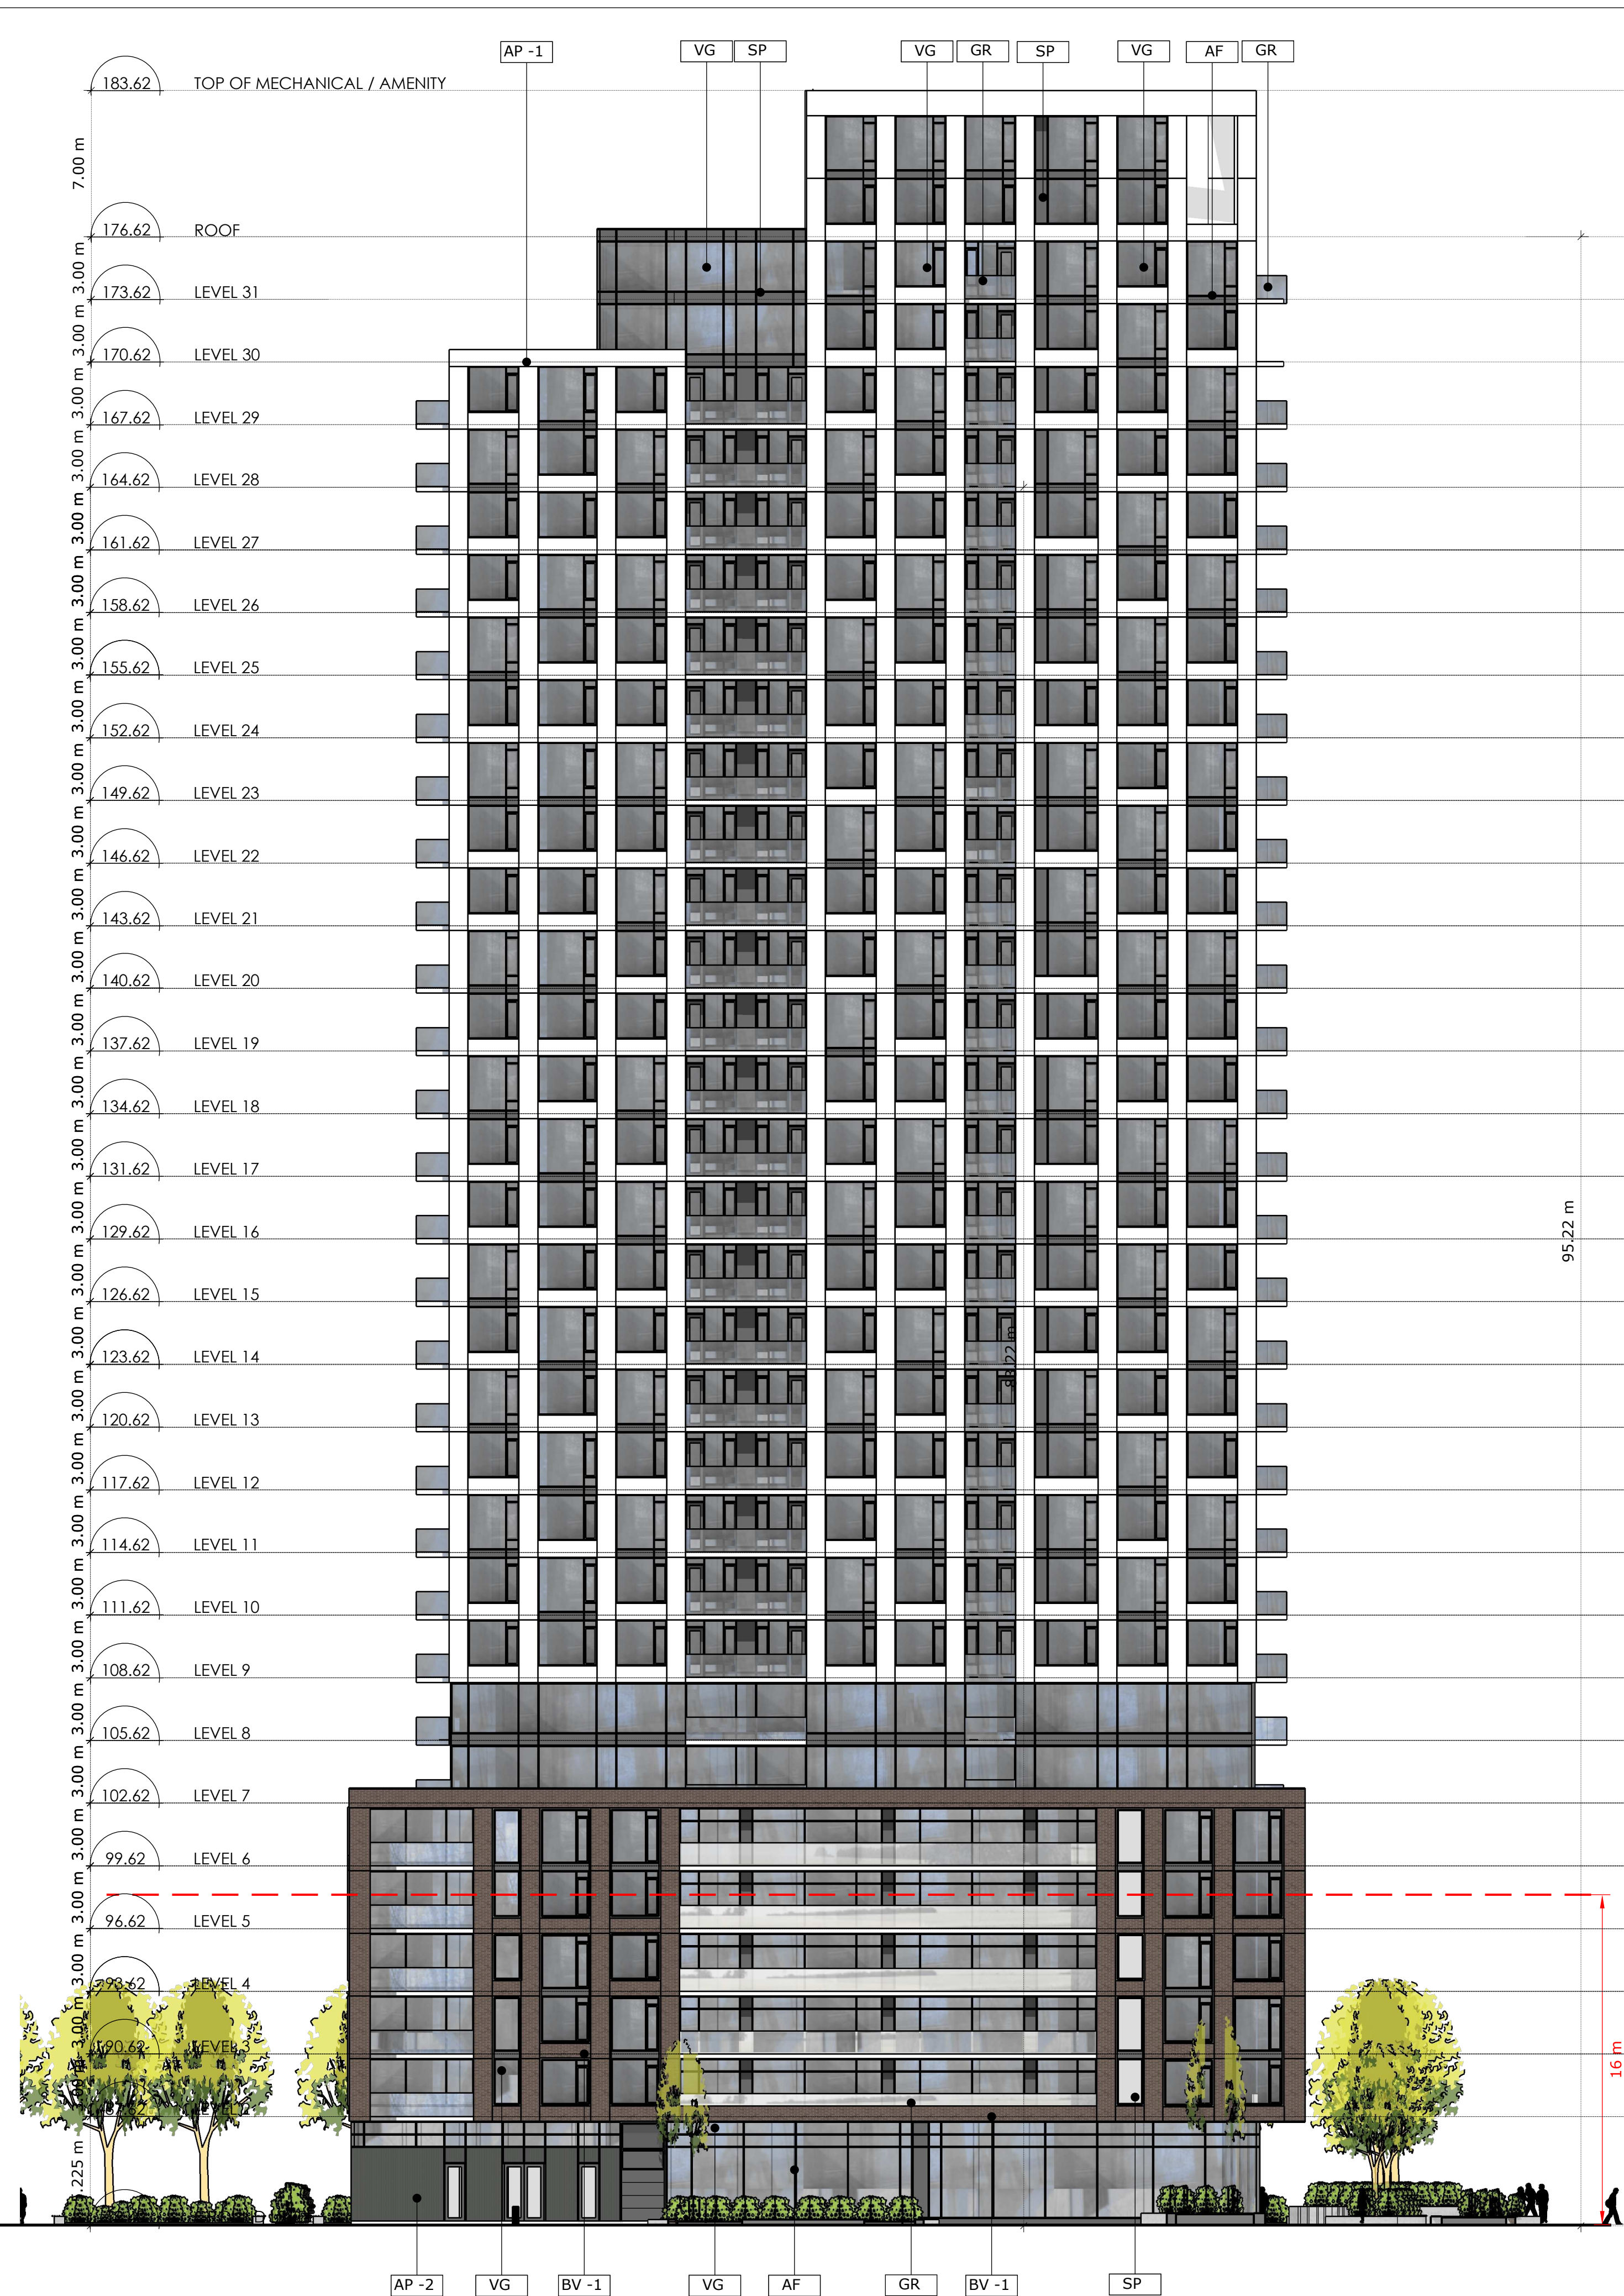

1 WEST ELEVATION  
A3.01 Scale: 1: 200

2 WEST ELEVATION - EAST TOWER  
A3.01 Scale: 1: 200

**PROJECT TEAM**

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WIND FRIENDLY GLASS: AS PER CITY 3RD SAFE GUIDELINES OUTLINE 2.1, TYPICAL 30-30-30  
1) GLASS PROVIDED FOR LOW WIND SPEEDS ONLY  
2) GLASS PROVIDED FOR ALL BALCONY RAILINGS ON LEVEL 4  
3) GLASS PROVIDED FOR ALL BALCONY RAILINGS ON ROOF TERRACE LEVELS

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**LEGEND:**

NEW BUILD	
AF	ALUMINUM FLASHING
AP-1	ALUMINUM PANEL 1
BV-1	BRICK VENEER
GR	GLASS RAILING
MS-1	METAL SIDING 1
SP	SPANDREL PANEL
VG	VISION GLASS

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**PROJECT/LOCATION:**

1081 Carling

**DRAWING TITLE:**

ELEVATIONS

DRAWN BY: PB/KM DATE: 210820 SCALE: 1:200

PROJECT: 2117

DRAWING NO.: A3-01

REVISION NO.:







1 NORTH ELEVATION  
A3.03 Scale: 1: 200

2 SOUTH ELEVATION  
A3.03 Scale: 1: 200

**PROJECT TEAM**

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WIND FRIENDLY GLASS: AS PER CITY BREQ SAFE GUIDELINES OUTLINE 2.1, 2.2 AND 2.3. 1. GLASS PROVIDED FOR ALL BALCONY RAILINGS ON LEVEL 4. 2. GLASS PROVIDED FOR ALL BALCONY RAILINGS ON LEVEL 5. 3. GLASS PROVIDED FOR ALL BALCONY RAILINGS ON ROOF TERRACE LEVELS.

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LEGEND:

NEW BUILD	
AF	ALUMINUM FLASHING
AP-1	ALUMINUM PANEL 1
BV-1	BRICK VENEER
GR	GLASS RAILING
MS-1	METAL SIDING 1
SP	SPANDREL PANEL
VG	VISION GLASS

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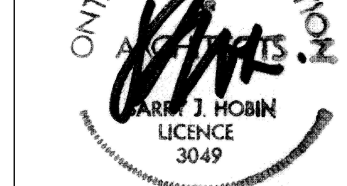


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1081 Carling

**DRAWING TITLE:**  
ELEVATIONS

**DRAWN BY:** PB/KM  
**DATE:** 210820  
**SCALE:** 1:200

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