



REFER TO NOTES
ON DRAWING C-4

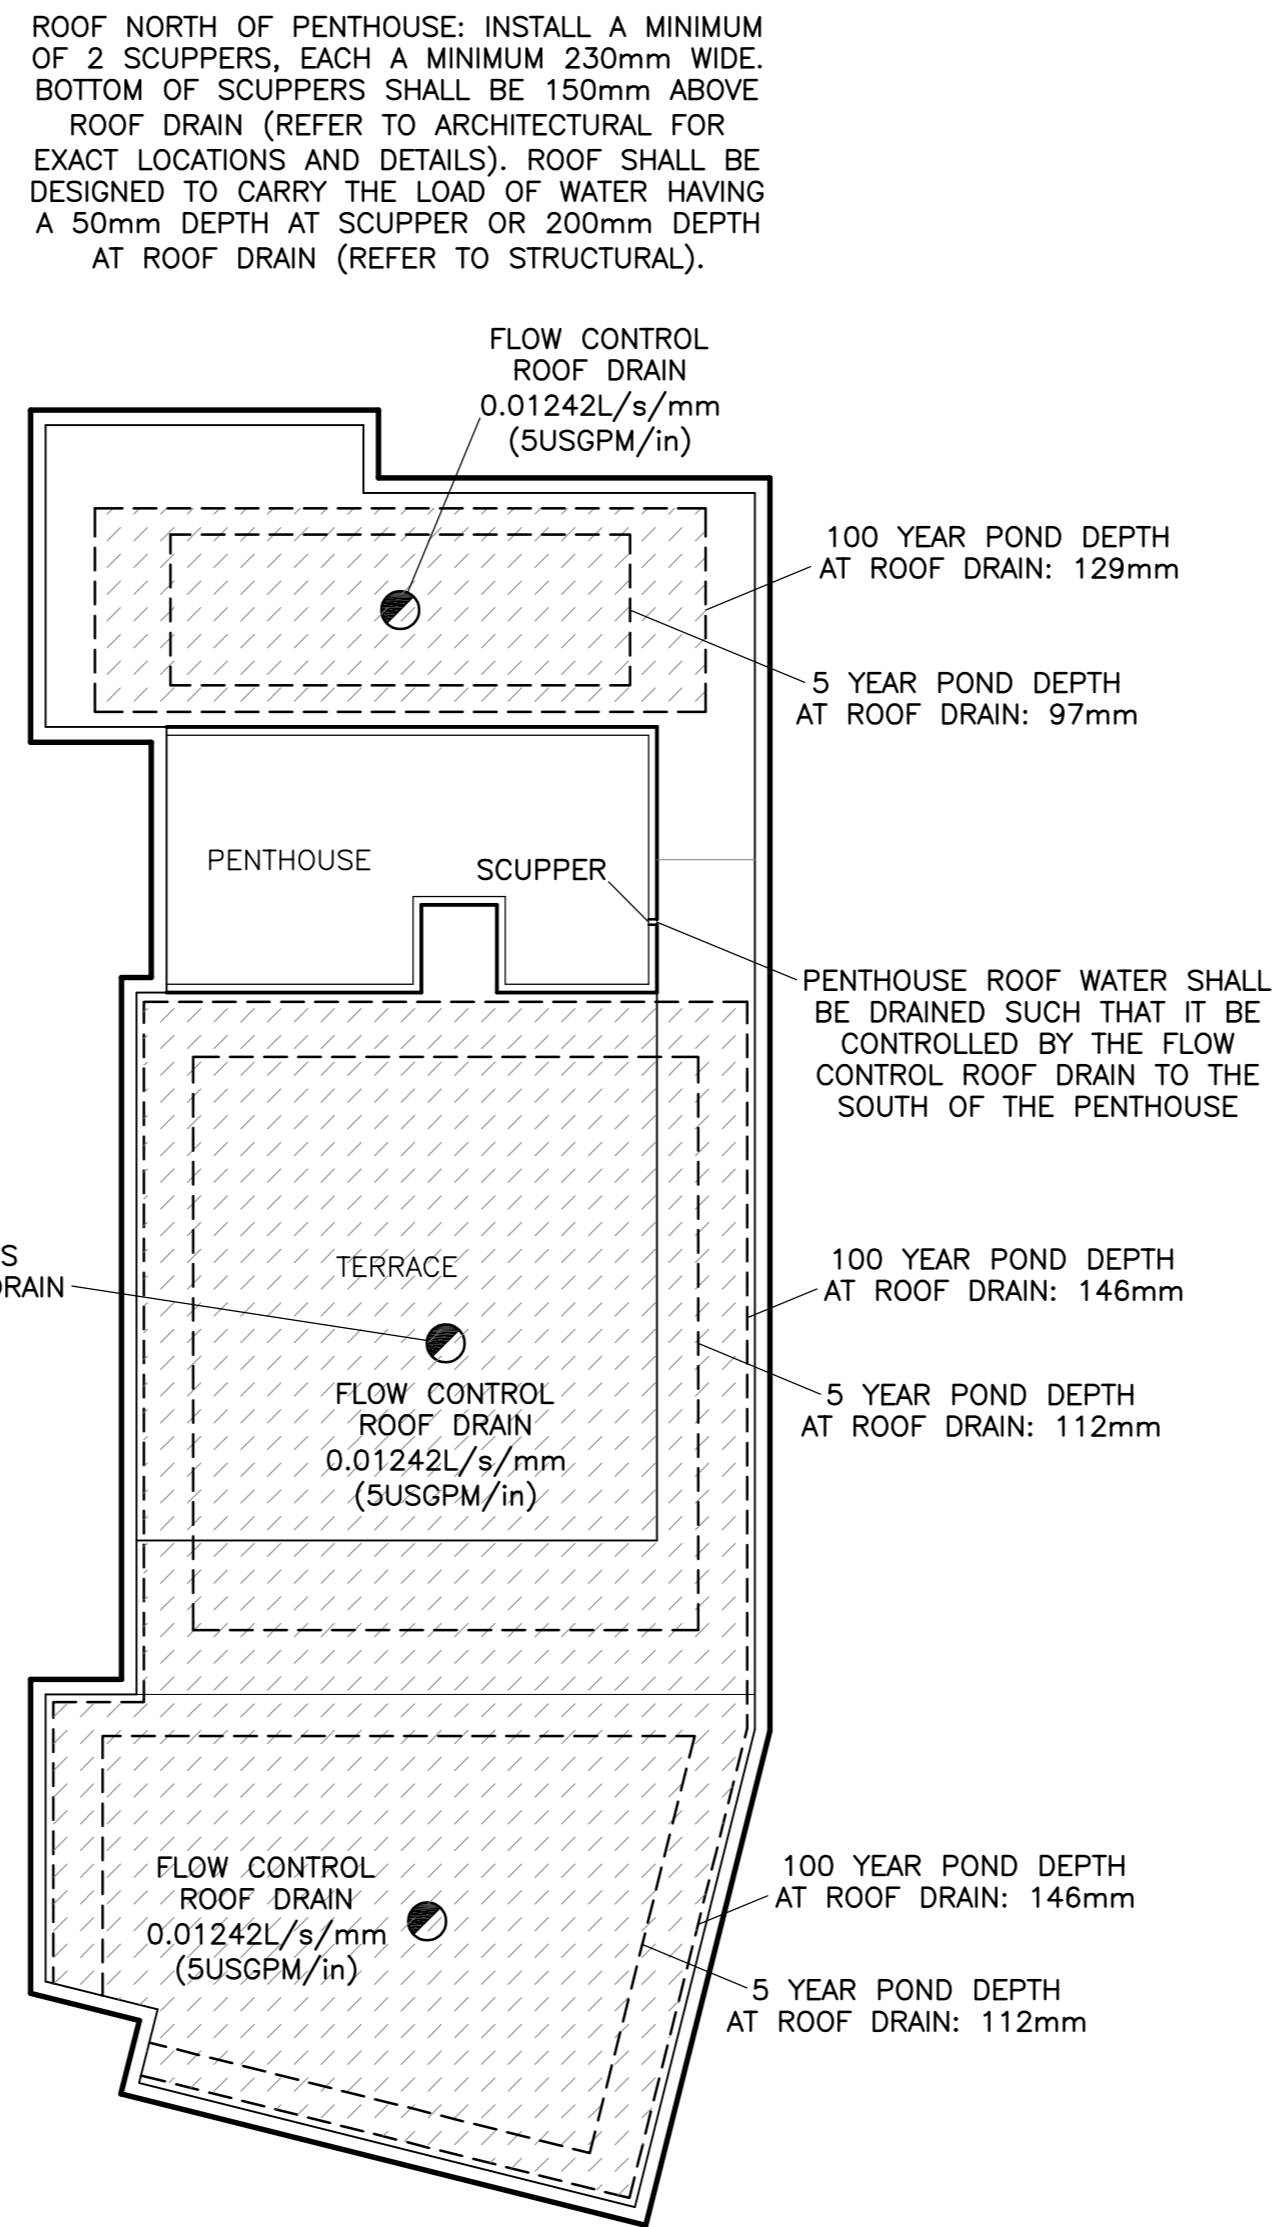

ROOF SOUTH OF PENTHOUSE: INSTALL A MINIMUM OF 6 SCUPPERS, EACH A MINIMUM 310mm WIDE. BOTTOM OF SCUPPERS SHALL BE 150mm ABOVE ROOF DRAINS (REFER TO ARCHITECTURAL FOR EXACT LOCATIONS AND DETAILS). ROOF SHALL BE DESIGNED TO CARRY THE LOAD OF WATER HAVING A 50mm DEPTH AT SCUPPER OR 200mm DEPTH AT ROOF DRAIN (REFER TO STRUCTURAL).


ROOF PLAN

REFER TO NOTES
ON DRAWING C-4

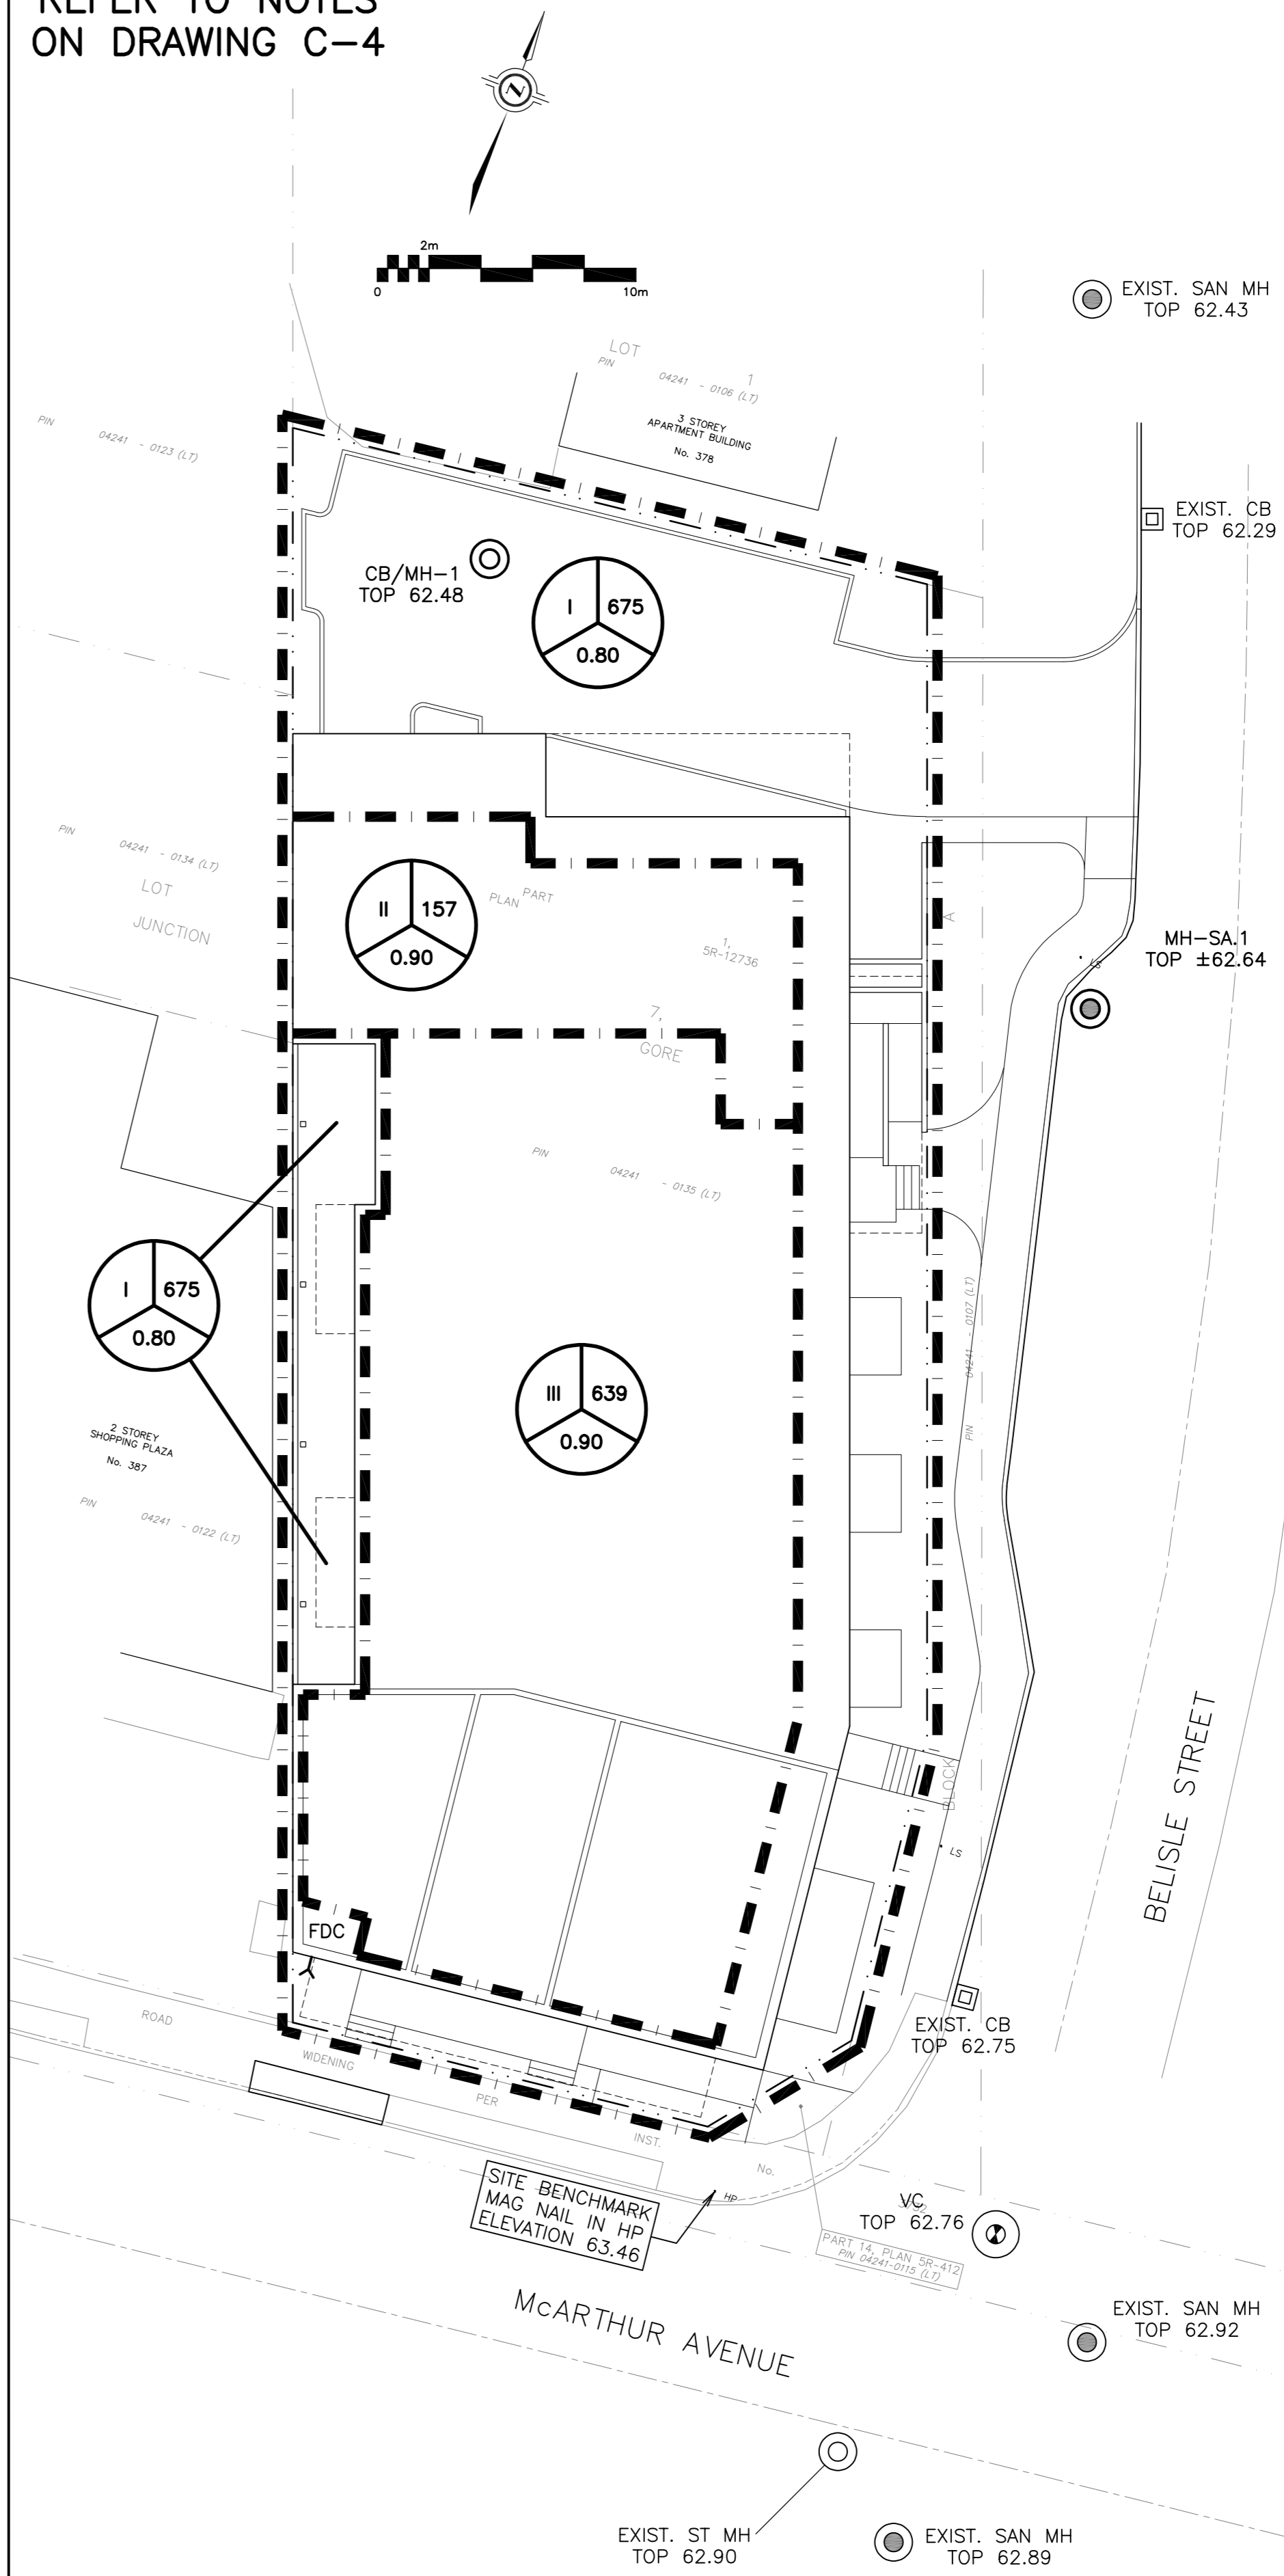


DRAINAGE PLAN

LEGEND

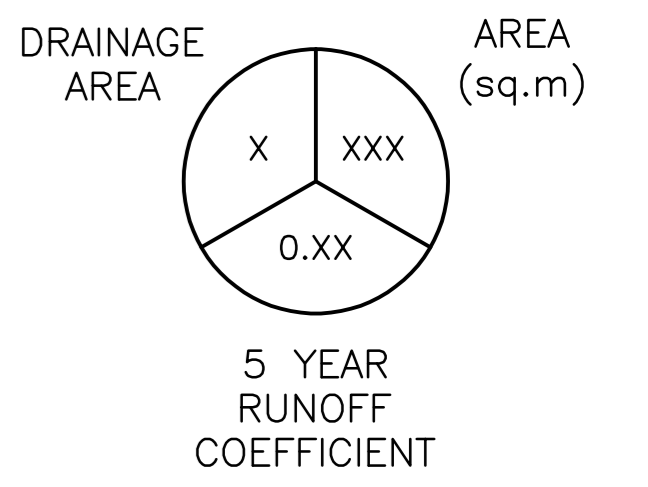

KEY PLAN

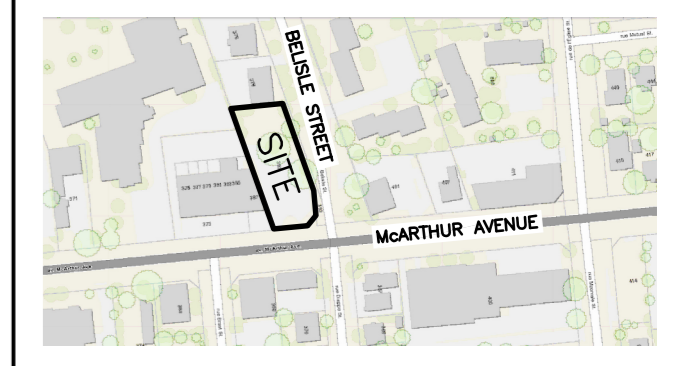

No.	DATE	REVISION
2	JUN 15-22	ISSUED FOR APPROVAL
1	APR 27-22	ISSUED FOR COORDINATION

D. B. GRAY ENGINEERING INC.
Stormwater Management - Grading & Drainage - Storm & Sanitary Sewers - Retention
700 Long Point Circle 613-425-8044
Ottawa, Ontario d.gray@dbgrayengineering.com

Project
**PROPOSED 6-STORY MIXED-USE BUILDING
393 McARTHUR AVENUE
OTTAWA, ONTARIO**

Drawing Title
ROOF PLAN AND DRAINAGE PLAN

Engineer's Seal

 Drawn D.B.G.
 H. Scale 1:200
 V. Scale
 Date APR 27-22
 Job No. 21111
 Drawing No.
**C-3
of 4**

NOT VALID UNLESS SIGNED & DATED