

EXISTING TREE LIST KEY								
KEY	BOTANICAL NAME	COMMON NAME	SIZE	CRITICAL ROOT ZONE	OWNERSHIP	CONDITION	ACTION	
1-AF	Acer x freemanii	Freeman's Maple	90mm DBH	900mm	City of Ottawa	POOR	TO REMAIN	
1-AN	Acer negundo	Manitoba Maple	90mm DBH	1500mm	226 Preston	GOOD	TO REMAIN	
1-RC	Rhamnus cathartica	Common Buckthorn	150mm DBH	1000mm	119 Balsam	GOOD	TO REMAIN	
1-SR	Syringa reticulata	Japanese Tree Lilac	150mm DBH	9000mm	119 Balsam	GOOD	TO REMAIN	
1-UW	Ulmus wilsoniana 'Prospector'	Prospector Elm	110mm DBH	1100mm	City of Ottawa	POOR	TO REMAIN	


KEY QTY.	BOTANICAL NAME	COMMON NAME	SIZE	CONDITION	REMARKS	
TREES						
SB 1	Amelanchier canadensis	Serviceberry	60mm cal.	B&B	Single leader	

GENERAL NOTES:

- 1. It is the responsibility of the appropriate contractor or official to report any errors, omissions or discrepancies on this plan with actual site conditions to the Landscape Architect before proceeding with construction.
- 2. The contractor is to notify all utility companies and authorities prior to any excavation and ascertain locations of underground services.
- 3. The contractor is to reinstate all areas and items damaged as a result of construction activity.
- 4. The contractor is to comply with all pertinent codes and by-laws.
- 5. The contractor is to maintain a positive surface run-off throughout the entire construction period.
- 6. The Landscape Architect is not responsible for subsurface conditions.
- 7. The contractor is to identify all existing trees to remain on site with the Landscape Architect prior to construction.
- 8. The contractor is to stake the proposed location of all plant material in conjunction with the Landscape Architect prior to excavation.
- 9. Minimum distances for selected deciduous trees are as follows:
- Building Foundations 7.5m
- Sidewalks 1.5m Public Streets 2.5m
- Underground Infrastructure 2.0m
- 10. All trees within 1m of underground utility trenches are to be excavated by hand.
- 11. Remove all protective wrapping from tree trunks after installation.
- 12. Staking of trees shall only be performed if necessary.
- 13. Ensure that mulch is pulled back a min. distance of 75mm from base of tree trunk.

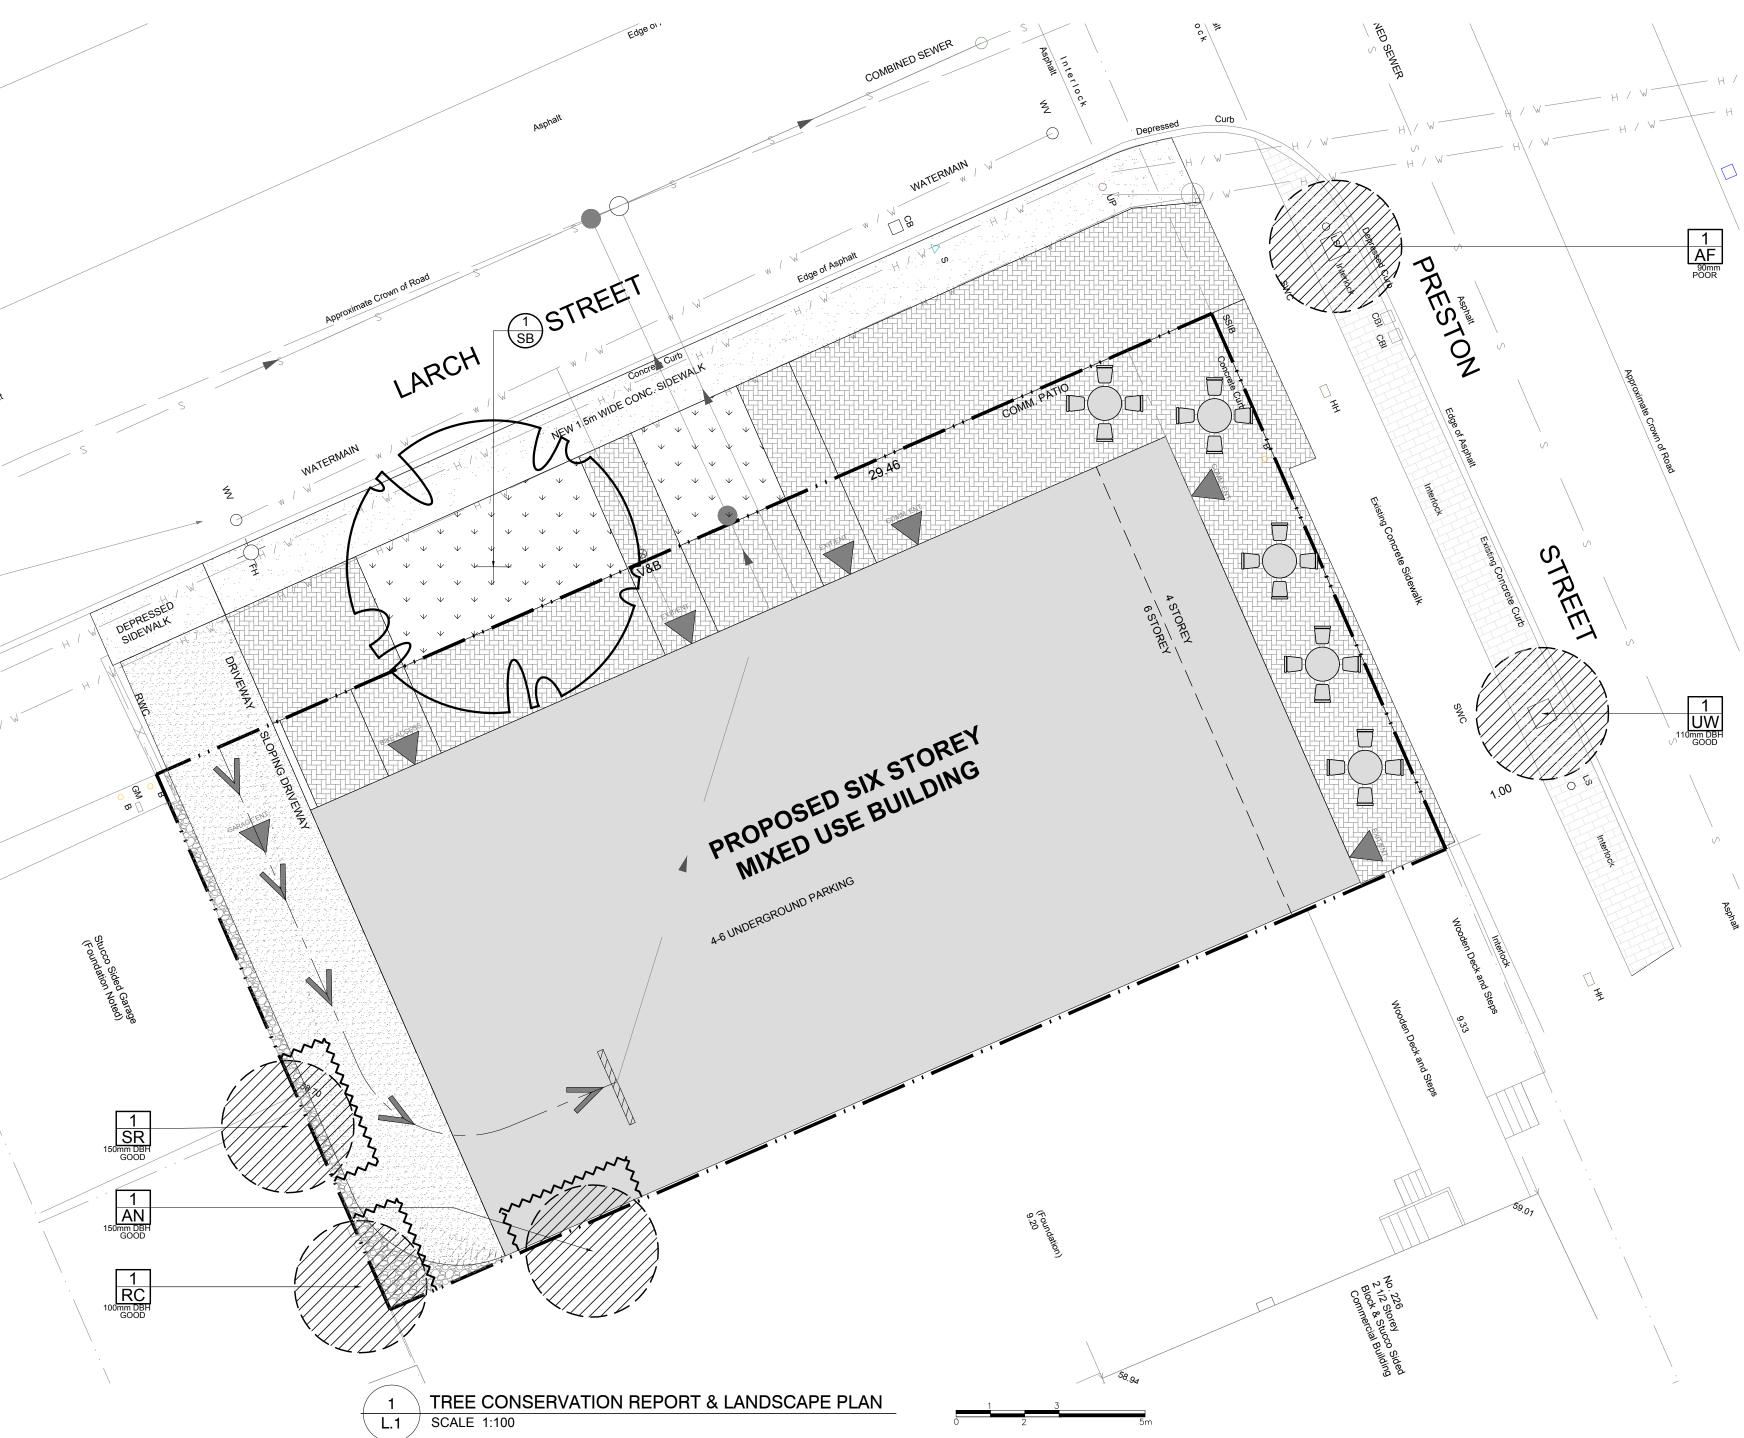

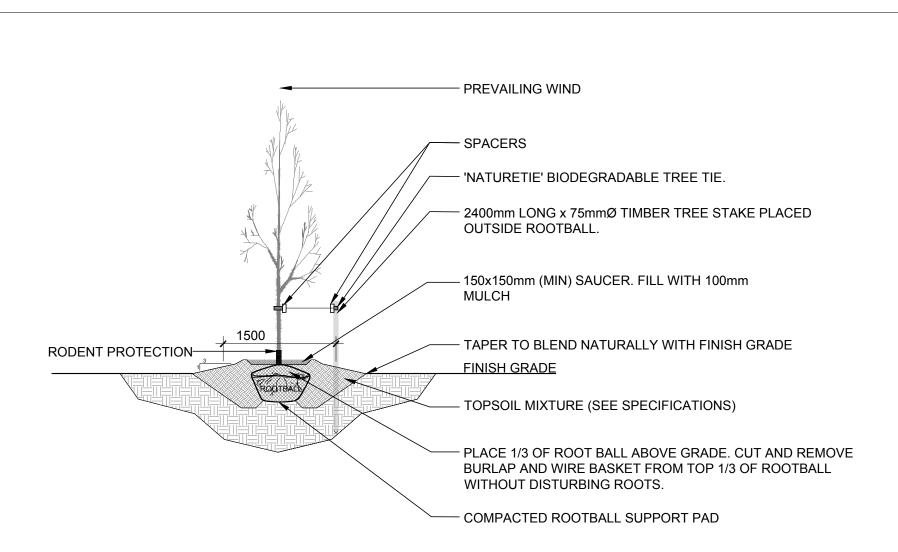

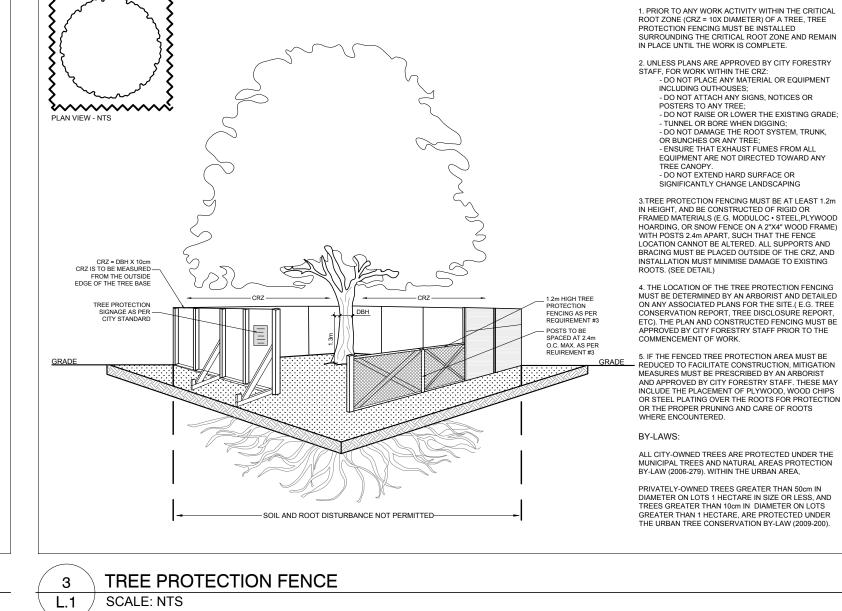

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PROTECTION FENCING MUST BE INSTALLED
SURROUNDING THE CRITICAL ROOT ZONE AND REMAIN
IN PLACE UNTIL THE WORK IS COMPLETE. 2. UNLESS PLANS ARE APPROVED BY CITY FORESTRY 2. UNLESS PLANS ARE APPROVED BY CITY FORESTRY
STAFF, FOR WORK WITHIN THE CRZ:
- DO NOT PLACE ANY MATERIAL OR EQUIPMENT
INCLUDING OUTHOUSES;
- DO NOT ATTACH ANY SIGNS, NOTICES OR
POSTERS TO ANY TREE;
- DO NOT RAISE OR LOWER THE EXISTING GRADE;
TUNNEL OR DOOR MUREL DISCOURCE. - DU NOT HASE OR LOWER THE EXISTING GRADE;
- TUNNEL OR BORE WHEN DIGGING;
- DO NOT DAMAGE THE ROOT SYSTEM, TRUNK,
OR BUNCHES OR ANY TREE;
- ENSURE THAT EXHAUST FUMES FROM ALL
EQUIPMENT ARE NOT DIRECTED TOWARD ANY
TREE CANOPY.
- DO NOT EXTEND HARD SURFACE OR
SIGNIFICANTLY CHANGE LANDSCAPING 3.TREE PROTECTION FENCING MUST BE AT LEAST 1.2m IN HEIGHT, AND BE CONSTRUCTED OF RIGID OR FRAMED MATERIALS (E.G. MODULOC • STEEL, PLYWOOD HOARDING, OR SNOW FENCE ON A 2"X4" WOOD FRAME) WITH POSTS 2.4m APART, SUCH THAT THE FENCE LOCATION CANNOT BE ALTERED. ALL SUPPORTS AND BRACING MUST BE PLACED OUTSIDE OF THE CRZ, AND INSTALLATION MUST MINIMISE DAMAGE TO EXISTING ROOTS. (SEE DETAIL) 4. THE LOCATION OF THE TREE PROTECTION FENCING MUST BE DETERMINED BY AN ARBORIST AND DETAILED ON ANY ASSOCIATED PLANS FOR THE SITE. (E.G. TREE CONSERVATION REPORT, TREE DISCLOSURER REPORT, ETC). THE PLAN AND CONSTRUCTED FENCING MUST BE APPROVED BY CITY FORESTRY STAFF PRIOR TO THE COMMENCEMENT OF WORK 5. IF THE FENCED TREE PROTECTION AREA MUST BE

REDUCED TO FACILITATE CONSTRUCTION, MITIGATION
MEASURES MUST BE PRESCRIBED BY AN ARBORIST
AND APPROVED BY CITY FORESTRY STAFF. THESE MAY
INCLUDE THE PLACEMENT OF PLYWOOD, WOOD CHIPS
OR STEEL PLATING OVER THE ROOTS FOR PROTECTION
OF THE PROPER PUBLISHED AND CASE OF PROCESS. OR THE PROPER PRUNING AND CARE OF ROOTS WHERE ENCOUNTERED. ALL CITY-OWNED TREES ARE PROTECTED UNDER THE MUNICIPAL TREES AND NATURAL AREAS PROTECTION BY-LAW (2006-279). WITHIN THE URBAN AREA,

TREE PROTECTION REQUIREMENTS:

OTTAWA
CARLETON
CONSTRUCTION



ANNIS, O'SULLIVAN, VOLLEBEKK LTD.

14 Concourse Gate, Suite 500
Nepean, Ont. K2E 756
Phone: (613) 727-0850 / Fax: (613) 727-1079

Email: Managan@anutel.com Nepean, Ont. K2E 7S6 Phone: (613) 727-0850 / Fax: (613) 727-1079 Email: Nepean@aovltd.com

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t: +1.613.688.1899 | f: +1.613.225.7330 2650 Queensview Drive, Unit 100 Ottawa, ON K2B 8H6 www.exp.com


LEGEND



EXISTING TREE TO REMAIN





PROPOSED DECIDUOUS TREE

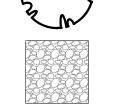

PROPOSED RIVERSTONE



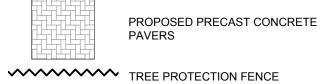

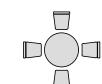

PROPOSED TABLE WITH CHAIRS

2	REVISED PER NEW SITE PLAN	03/15/2023	ML	,				
1	ISSUED FOR DISCUSSION & REVIEW	11/16/2022	ML	,				
No.	Issue	Date MM/DD/YY	DR	C				

JAMES B. LENNOX & ASSOCIATES INC. LANDSCAPE **ARCHITECTS** 3332 CARLING AVE. OTTAWA, ONTARIO K2H 5A8 Tel. (613) 722-5168 Fax. 1(866) 343-3942

PROPOSED SIX STOREY MIXED USE BUILDING 224 PRESTON STREET, OTTAWA ON

TREE CONSERVATION REPORT &

LANDSCAPE PLAN




SCALE AS SHOWN TART DATE NOVEMBER 2022

PROJECT NO.

DRAWING NO.

23MIS2308

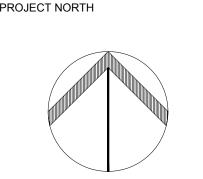

2 DECIDUOUS TREE PLANTING L.1 SCALE: NTS