


LEGEND

- PROPERTY LINE
- - - EXISTING BOTTOM OF SLOPE
- - - EXISTING TOP OF SLOPE
- - - EXISTING CENTER LINE OF DITCH
- EXISTING GATE
- - - EXISTING CHAIN LINK FENCE
- - - EXISTING OVERHEAD HYDRO LINE
- EXISTING UTILITY POLE
- PROPOSED SLOPE MAX. 3:1
- X 100.00 PROPOSED GRADES
- PROPOSED DRAINAGE PATTERN
- AREA A PROPOSED SOIL DUMP AREA
- PROPOSED LANDSCAPING (GRASS)
- PROPOSED 50mm DIA. CLEAR STONE

EROSION AND SEDIMENT CONTROL NOTE:

- PROVIDE TEMPORARY EROSION CONTROL BLANKET ON PROPOSED SLOPES GREATER THAN 7% UNTIL SUFFICIENT LANDSCAPE COVER HAS BEEN ESTABLISHED.
- THE PRODUCT SHOULD BE RATED FOR SLOPES UP TO 3H:1V.
- ADDITIONAL EROSION AND SEDIMENT CONTROL MEASURES TO BE PROVIDED AS PER DRAWING C300.

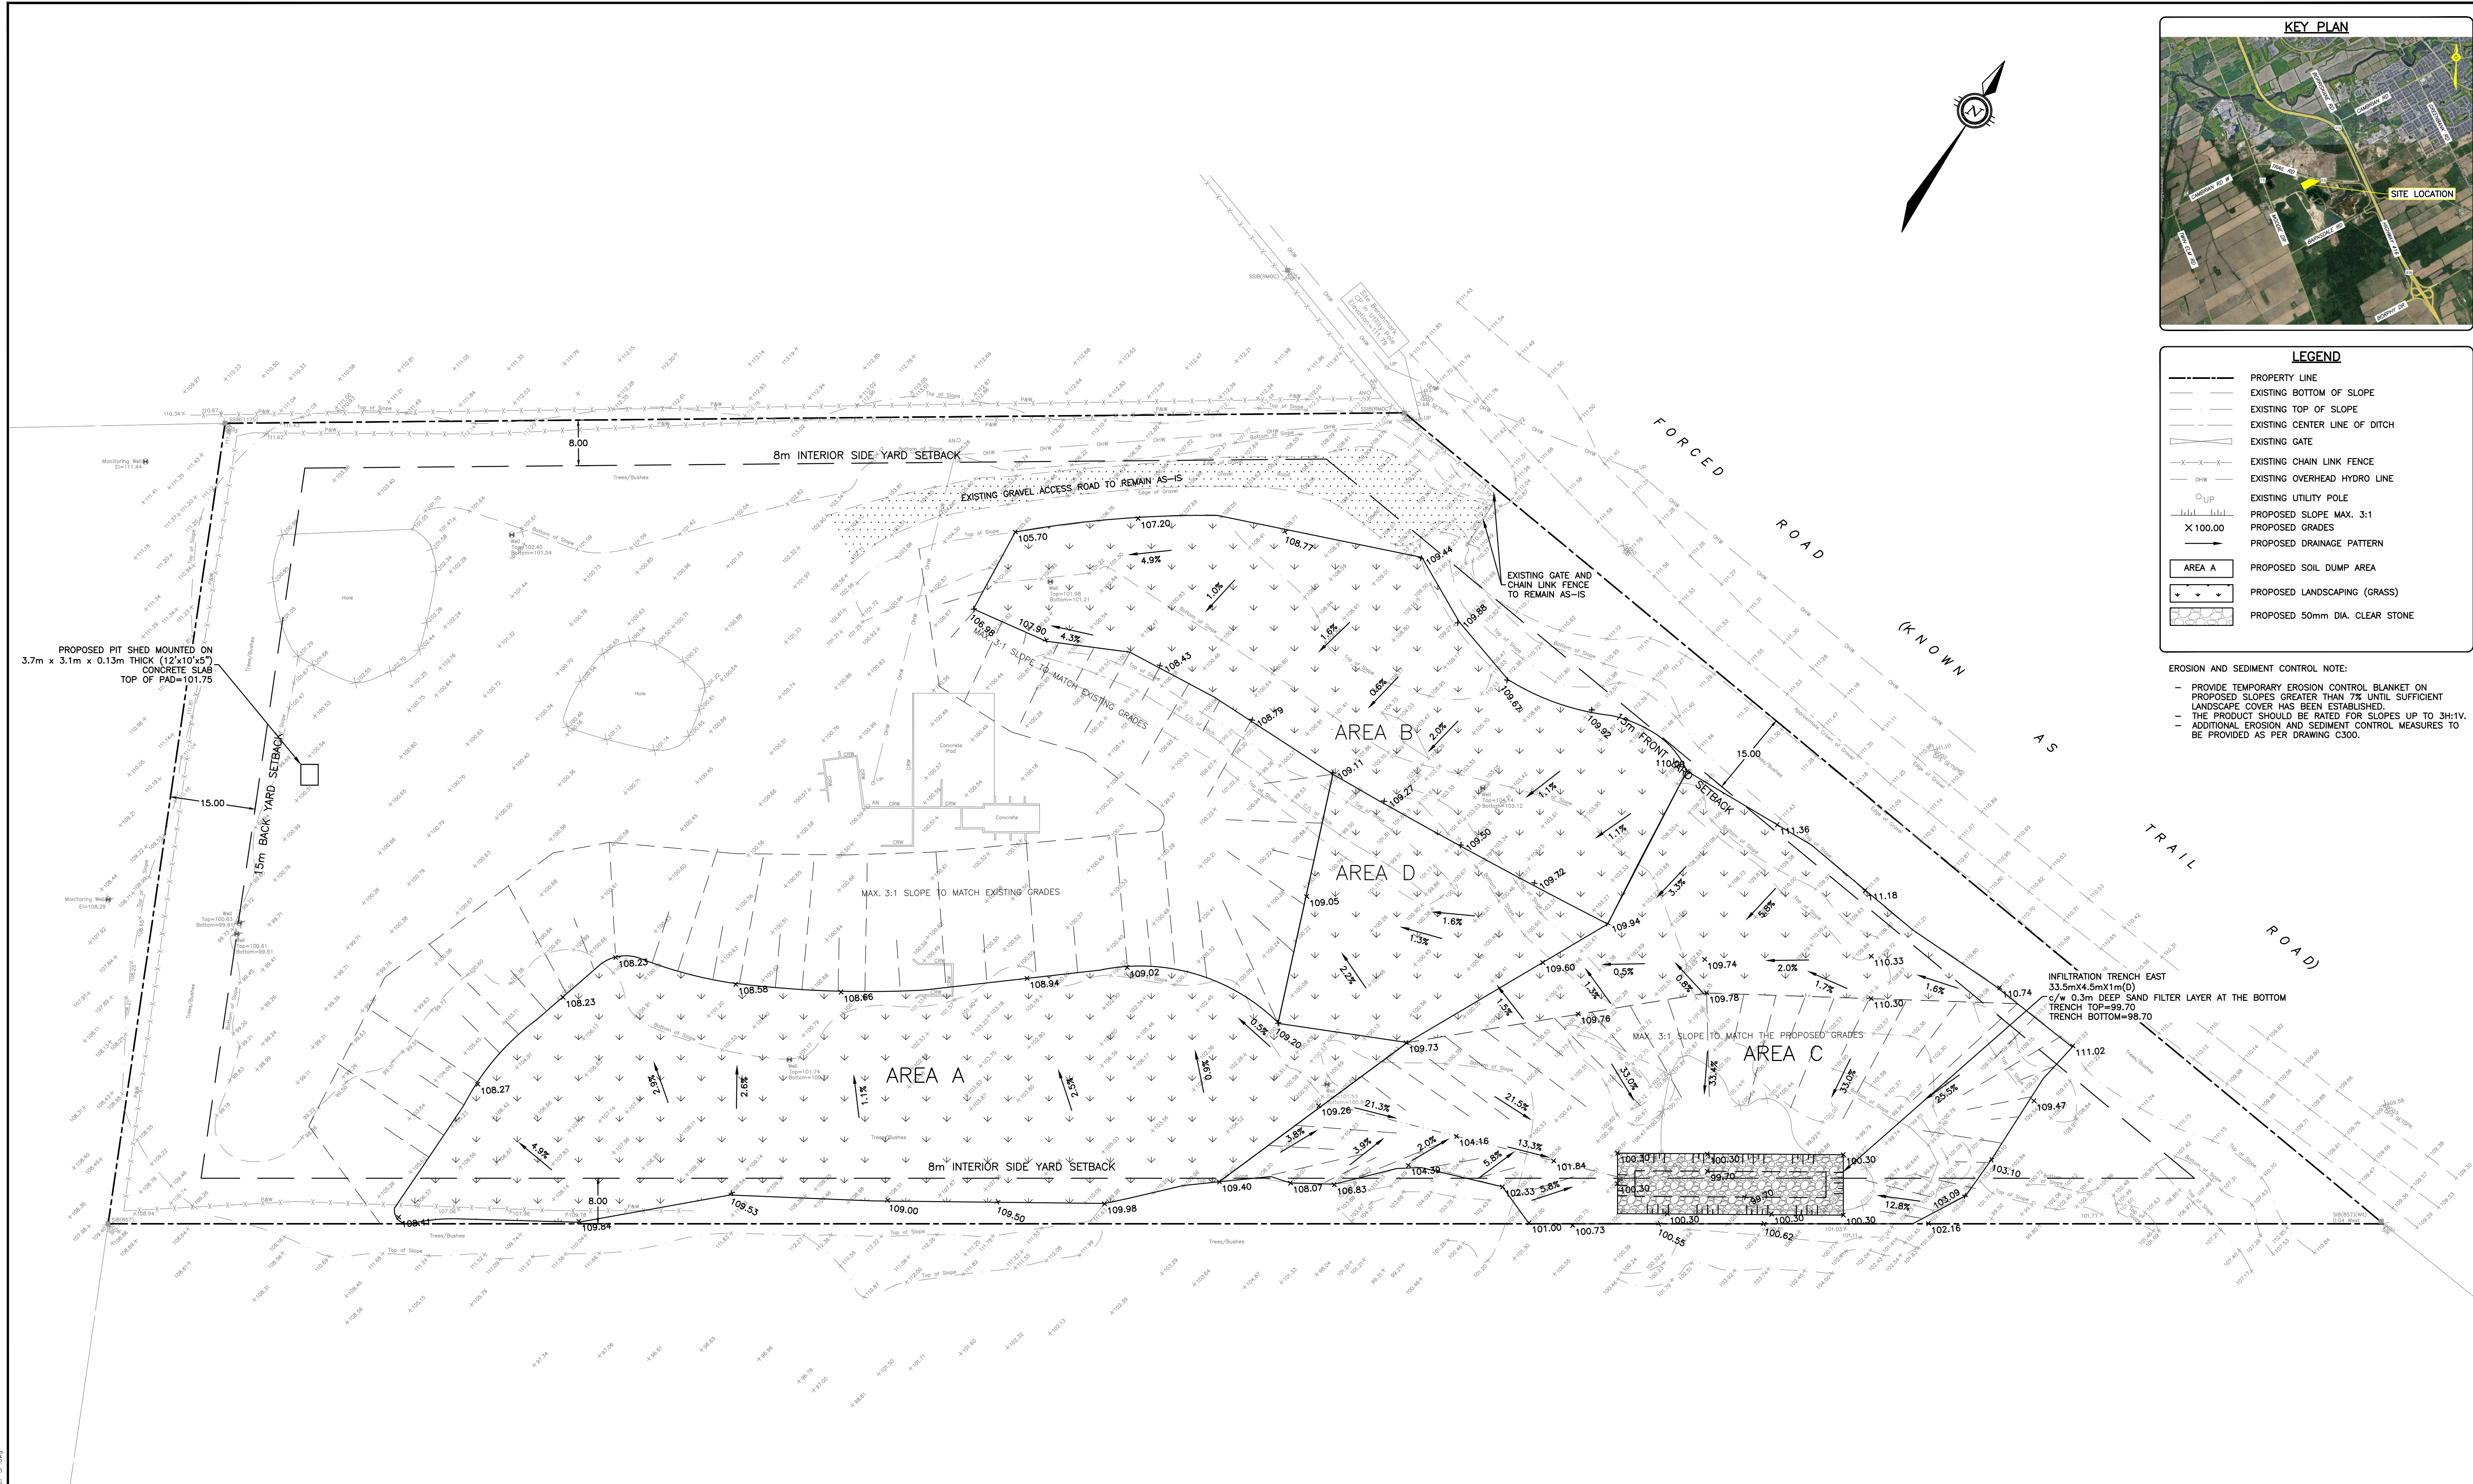

CAUTION
THE POSITION OF ALL POLE LINES, CONDUITS, WATERMAINS, SEWERS AND OTHER UNDERGROUND AND OVERGROUND UTILITIES AND STRUCTURES IS NOT NECESSARILY SHOWN ON THE CONTRACT DRAWINGS, AND WHERE SHOWN, THE ACCURACY OF THE POSITION OF SUCH UTILITIES AND STRUCTURES IS NOT GUARANTEED. BEFORE STARTING WORK, DETERMINE THE EXACT LOCATION OF ALL SUCH UTILITIES AND STRUCTURES AND ASSUME ALL LIABILITY FOR DAMAGE TO THEM.

NOT FOR CONSTRUCTION

REV	REVISION DESCRIPTION	DATE	BY	APPD
2	ISSUED FOR SPA	23/06/23	AJ	AA
1	ISSUED FOR CLIENT REVIEW	20/10/22	AJ	AA

SCALE
0 5m 10m 20m
HORIZONTAL 1:500

DESIGNED BY: [Signature]

REVIEWED BY: [Signature]

CLIENT: DRAIN-ALL LTD
3385 HAWTHORNE ROAD, OTTAWA, ON.
K1G 4G2 613.739.1070

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PROJECT: ENGINEERING SERVICES FOR
4380 TRAIL ROAD,
OTTAWA, ONTARIO.

TITLE: SITE GRADING AND EROSION CONTROL PLAN AREA C & D

PROJECT No. OTT-21023795-AG
SURVEY FSD
DATE 27/04/2022
DRAWING No. C200-3

PROFESSIONAL ENGINEER
M.A. ANSARI
2023/06/23
PROVINCE OF ONTARIO

exp

PROJECT No. OTT-21023795-AG
SURVEY FSD
DATE 27/04/2022
DRAWING No. C200-3

I:\Projects\21023795-AG\06 - EROSION CONTROL\06 - EROSION CONTROL.dwg
 User: jstewart Date: 23/06/2023 12:45:15
 Plot: 21023795-AG.dwg
 Plot Date: 27/04/2022 12:45:15
 Plot Scale: 1:500
 Plot Orientation: Landscape
 Plot Color: Black
 Plot Lineweight: 0.5
 Plot Font: Arial
 Plot Font Size: 10
 Plot Font Color: Black
 Plot Font Weight: Normal
 Plot Font Style: Regular
 Plot Font Orientation: Horizontal
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 Plot Font Color: Black
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 Plot Font Angle: 0

#?????