SITE PLAN KEYNOTES:

- 1 EXISTING SIDEWALK TO REMAIN
- 2 EXISTING ASPHALT PAVING TO REMAIN
- 3 EXISTING CURB TO REMAIN
- 4 EXISTING SIGN TO REMAIN

9123

⁺5428 ⁺

3957

SITE AREA

ZONE:

BUILDING AREA

GROSS FLOOR AREA

BUILDING HEIGHT

SCHEDULE 1:

SCHEDULE 1A:

9432

R5B H(19)

AREA B

AREA X

937.6m²

633.56m²

3,810.12m²

35m 9 STOREYS

6062

19238

5 EXISTING LANDSCAPING TO REMAIN.

EXISTING

2.5 STOREY BUILDING

TO REMAIN

41047

NEW BUILDING

84 UNITS

254 ARGYLE AVE.

46.50m N 31° 57' 10" W

EXISTING

7 STOREY BUILDING

TO REMAIN

37090

RESIDENTIAL SPACES

ACCESSIBLE PARKING

42 (.5/UNIT)

VISITOR SPACES

BICYCLE PARKING

PROVIDED

20.17m

937.05m²

1.42m

3.759m

1.5m

34.5m

582.5m²

270.94m²

42732

REQUIRED

22.5m

675m²

7.5m

1.5m (6m past 21m)

504m² (6m²/unit)

281.12m²

ZONING PROVISION

MIN. FRONT YARD SETBACK

MIN. REAR YARD SETBACK

MIN. INTERIOR YARD SETBACK

MIN. LOT WIDTH

MIN. LOT AREA

MAX. HEIGHT

AMENITY AREA

LANDSCAPED AREA

- 21 RELOCATE EXISTING CHURCH FACADE TO NEW LOCATION
- 22 VENTED CISTERN LID
- 23 NEW CONCRETE SIDEWALK PER CIVIL
- 24 REINSTATE TOP SOIL AND GRASS IN BETWEEN ROAD AND SIDEWALK AT AREAS EFFECTED BY CONSTRUCTION
- 25 NEW CURB PER CIVIL
- 26 REINSTATE EXISTING ROAD ASSEMBLY PER CIVIL AT AREAS EFFECTED BY DEMOLITION AND CONSTRUCTIONS. PROVIDE SMOOTH TRANSITION TO EXISTING PAVING.

33

- 27 BACKFILL TRENCHES AS REQUIRED PER CIVIL AND GEOTECHNICAL.
- 28 RELOCATE EXISTING FIRE HYDRANT PER CIVIL
- 29 NEW DRIVEWAY PER CIVIL
- 30 NEW CURB WALL PER CIVIL

13070

46.50m N 31° 56' 30" W

31 OVERHEAD DOOR TO UNDERGROUND PARKING

- 32 WOOD PRIVACY FENCE PER LANDSCAPING
- 33 TERMINATE WOOD PRIVACY FENCE FLUSH TO THE RETAINING WALL PER LANDSCAPING
- 34 PEDESTRIAN GATE

14132

42

UNIT TYPES

1 BEDROOM

2 BEDROOM

3 BEDROOM

TOTAL

STUDIO

- 35 WALKWAY PER LANDSCAPING
- 36 PATIO PER LANDSCAPING
- 37 PLANTS PER LANDSCAPING
- 38 VAULT
- 39 RAISED PLANTER WALL PER LANDSCAPING
- 40 STEPBACK AT LEVELS 2 TO ROOF
- 41 SETBACK AT LEVEL 1B
- 42 SETBACK AT LEVELS 1C TO ROOF

EXISTING 1 STOREY GARAGE

TO REMAIN

5759

4017

30 39

3759

GFA BREAKDOWN

RESIDENTIAL

WINE BAR

TOTAL

PROVIDED

3718.81m²

91.31m²

3810.12m²

SITE PLAN LEGEND:

SITE PLAN GENERAL NOTES:

2. DO NOT SCALE THIS DRAWING

CONSULTANT

CONSULTANT

EXCAVATION

EXCAVATION

TO DIGGING

FROM EXISTING PLANS AND SURVEYS

UNKNOWN SUBSURFACE CONDITIONS

3. REPORT ANY DISCREPANCIES PRIOR TO COMMENCING WORK.

SITE AND REPORT ANY ERRORS AND/OR OMISSIONS TO THE

5. REINSTATE ALL AREAS AND ITEMS DAMAGED AS A RESULT OF CONSTRUCTION ACTIVITIES TO THE SATISFACTION OF THE

6. CONTRACTOR TO LAYOUT PLANTING BEDS, PATHWAYS ETC.

TO APPROVAL OF CONSULTANT PRIOR TO ANY JOB

7. THE ACCURACY OF THE POSITION OF UTILITIES IS NOT

GUARANTEED - CONTRACTOR TO VERIFY PRIOR TO

9. ALL DISTURBED AREAS TO BE RESTORED TO ORIGINAL


CONDITION OR BETTER UNLESS OTHERWISE NOTED

8. INDIVIDUAL UTILITY COMPANY MUST BE CONTACTED FOR

CONFIRMATION OF UTILITY EXISTENCE AND LOCATION PRIOR

NO RESPONSIBILITY IS BORN BY THE CONSULTANT FOR

4. CONTRACTOR TO CHECK AND VERIFY ALL DIMENSIONS ON

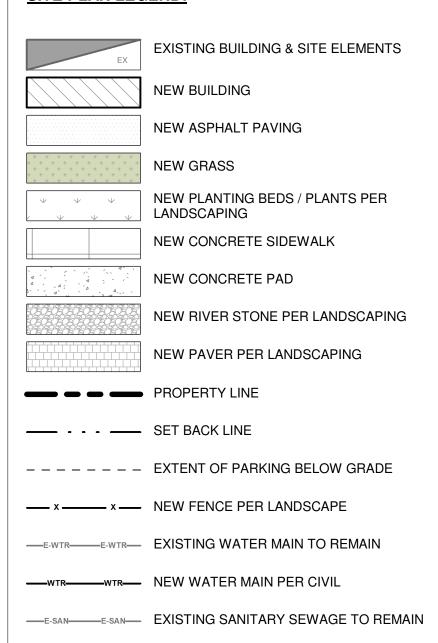

ELECTRICAL

——E-G——E-G—— EXISTING GAS LINE TO REMAIN

——E-B———E-B—— EXISTING BELL LINE TO REMAIN

——E-R——E-R—— EXISTING ROGER LINE TO REMAIN

— G — NEW GAS LINE PER CIVIL

——E-ST——E-ST— EXISTING STORM SEWAGE TO REMAIN

—онw— oнw— NEW ELECTRICAL OVERHEAD SERVICE PER

COMMENT RESPONSE 01 2024.08.29 ISSUED FOR SPC AND REZONING 2024.05.08 ISSUED FOR PHASE 2 PRECONSULT

NOTES —E-OHW——E-OHW— EXISTING ELECTRICAL OVERHEAD SERVICE TO

> REMAINS WITH CSV ARCHITECTS, AND MAY NOT BE REPRODUCED IN ANY FORM WITHOUT THE WRITTEN CONSENT OF CSV ARCHITECTS. 2. THE DRAWINGS, PRESENTATIONS AND SPECIFICATIONS AS INSTRUMENTS OF SERVICE ARE AND SHALL REMAIN THE PROPERTY OF CSV ARCHITECTS. THEY ARE NOT TO BE USED BY THE CLIENT ON OTHER PROJECTS OR ON EXTENSIONS TO THIS PROJECT WITHOUT THE WRITTEN CONSENT OF CSV ARCHITECTS.

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MAIN ENTRANCE

ENTRANCE/ BARRIER-FREE ENTRANCE

VEHICLE ACCESS \triangle NEW AREA DRAIN PER CIVIL

> CATCH BASIN: EXISTING TO REMAIN / NEW MAINTENANCE HOLE: EXISTING TO REMAIN /

VALVE AND VALVE BOX : EXISTING TO REMAIN

NEW PER CIVIL UTILITY POLE: EXISTING TO REMAIN / NEW

NEW PER CIVIL EX. V&VB V&VB LIGHT STANDARD ⊕ LS

> NEW FIRE HYDRANT PER CIVIL -O_{FH} NEW WATER METER PER CIVIL NEW REMOTE WATER METER PER CIVIL

NEW SIAMESE CONNECTION

DC NEW DROPPED CURB

NEW TREE PER LANDSCAPING

EXISTING TREE TO REMAIN

ARCHITECT OF RECORD

CSV ARCHITECTS 1. ALL GENERAL SITE INFORMATION AND CONDITIONS COMPILED

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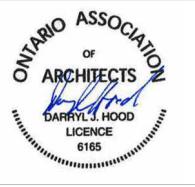
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CLIENT



OTTAWA ONTARIO, CANADA

PROJECT

254 ARGYLE

254 Argyle Avenue, Ottawa, Ontario

TITLE

SITE PLAN

PROJECT NO: 2023-0250 EF / IK DRAWN: APPROVED: DH SCALE: As indicated

DATE PRINTED: 12/13/2024 2:08:59 PM

REV

DRAWING NO.

A100



SHRUB: EXISTING TO REMAIN / NEW PER

MUNICIPAL ADDRESS 254 ARGYLE AVE. OTTAWA, ON

1 NEW SITE PLAN

LOT 16 (SOUTH ARGYLE AVENUE)

LOT 16 (SOUTH ARGYLE AVENUE)

DRAFT OF TOPOGRAPHIC PLAN OF SURVEY OF

PREPARED BY SURVEYED BY ANNIS, O'SULLIVAN,

LEGAL DESCRIPTION

REGISTERED PLAN 30


REFERENCE SURVEY

REGISTERED PLAN 30

CITY OF OTTAWA

VOLLEBEKK LTD.

CITY OF OTTAWA

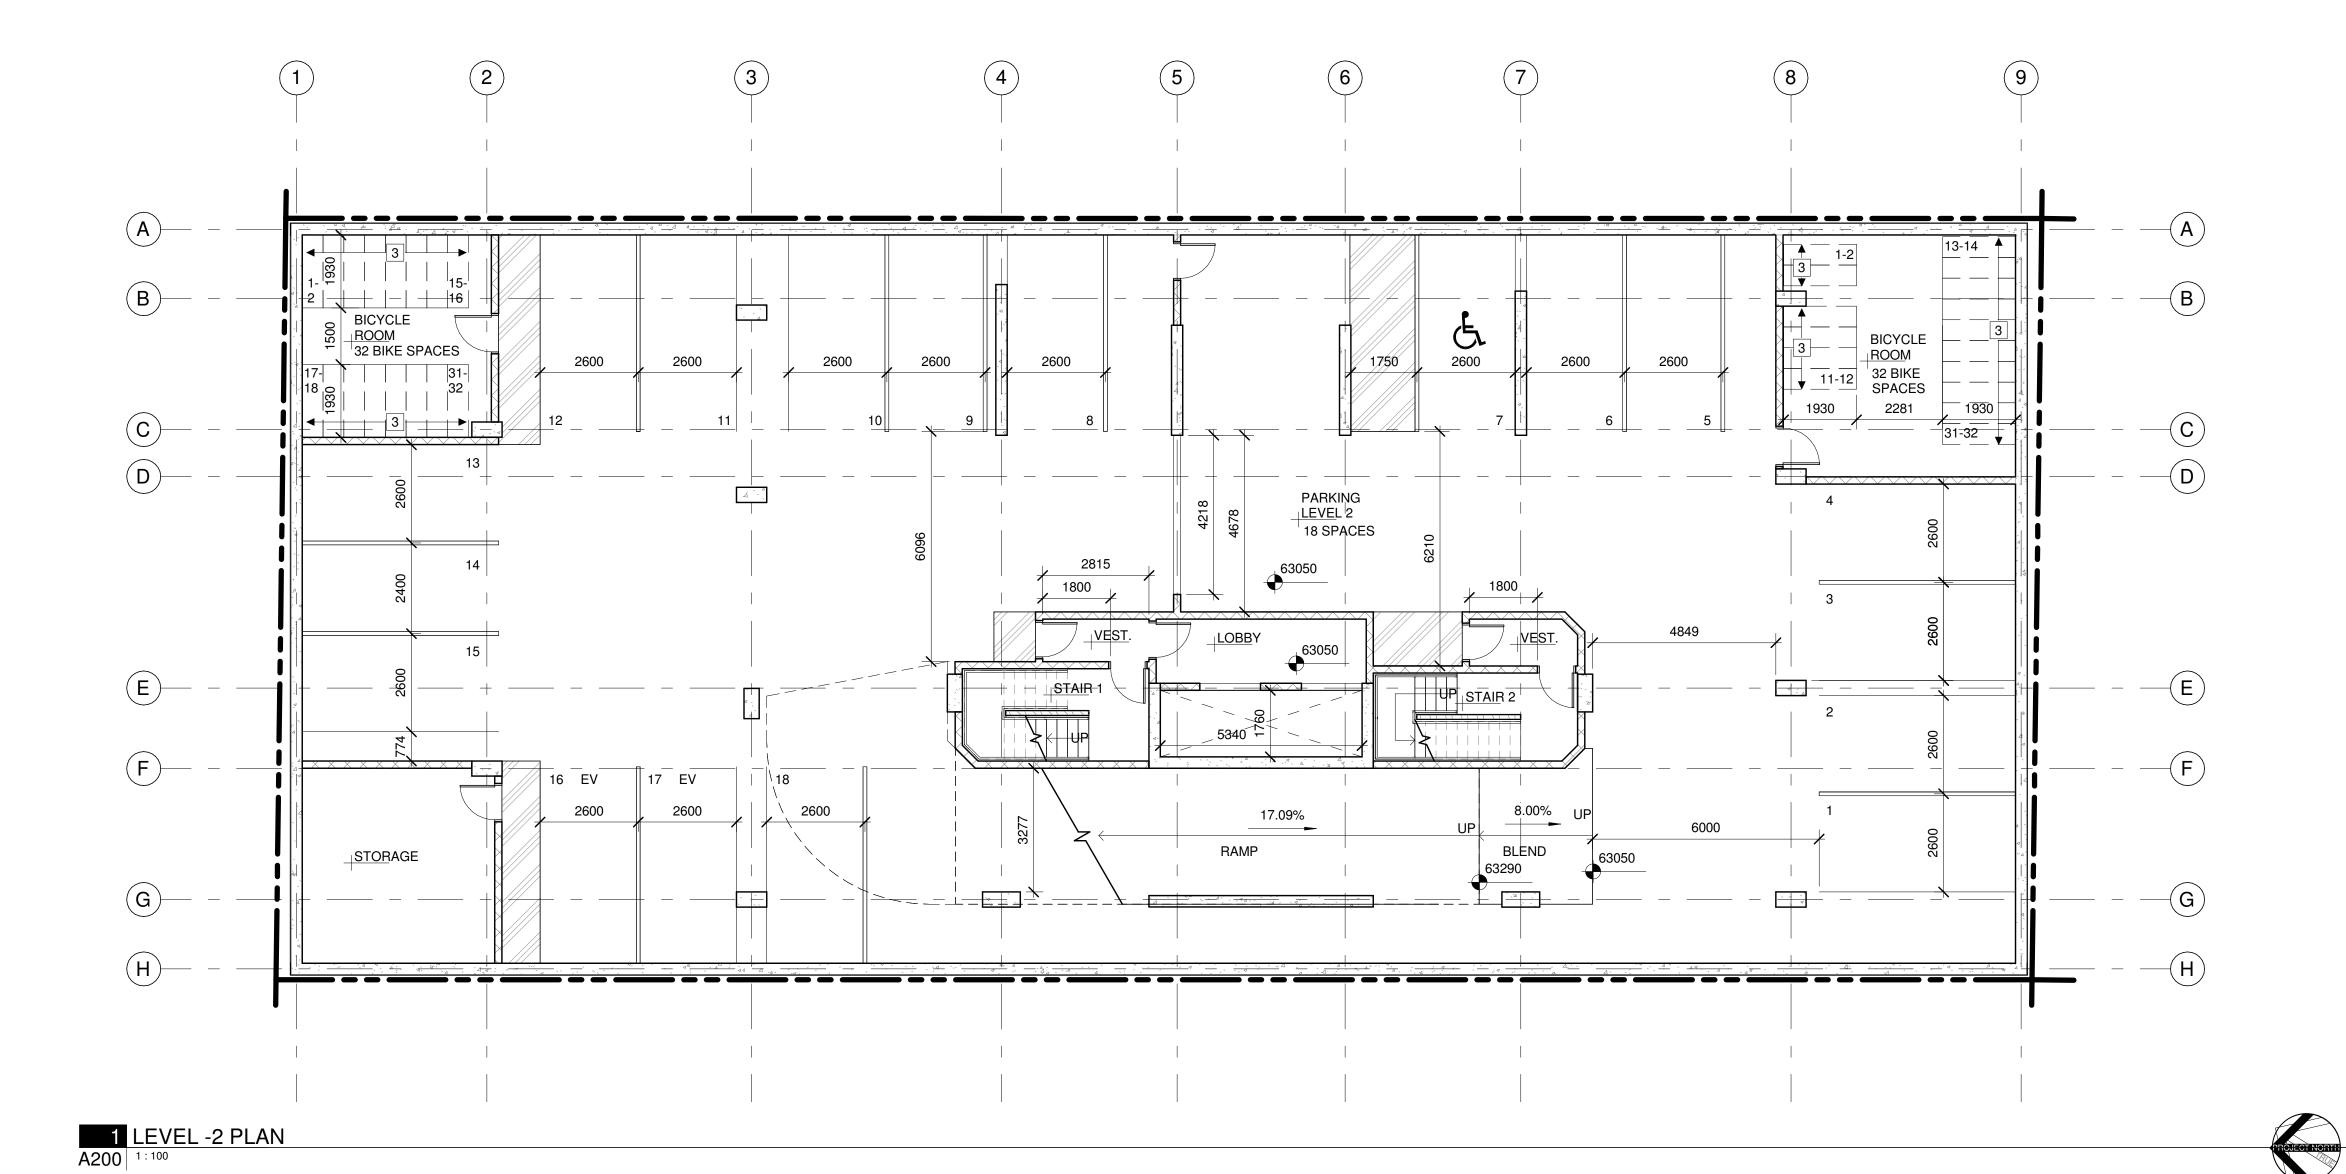

GENERAL REFERENCE PLAN NOTES:

- A. DO NOT SCALE DRAWINGS. FOUNDATION WALL SIZES.
- C. REFER TO MECHANICAL + ELECTRICAL DRAWINGS FOR DETAILS OF UNDERGROUND SERVICES.
- NOTED.
- WINDOW OPENING, UNLESS OTHERWISE NOTED.
- OPENING, INCLUDING SIDELIGHT FRAMING, UNLESS OTHERWISE NOTED
- H. ALL EXTERIOR WALLS ARE DIMENSIONED TO THE EXTERIOR FINISHED FACE, UNLESS NOTED OTHERWISE.
- OTHERWISE NOTED.
- CONCRETE STRUCTURAL COLUMNS AND WALLS.

REFERENCE PLAN KEYNOTES:

- 1 CISTERN OVERFLOW AND HATCH / VENTED CISTERN LID

- 4 EXIT ONLY

- B. DIMENSIONS ARE FOR LOCATION ONLY. REFER TO STRUCTURAL DRAWINGS FOR FOOTINGS, COLUMNS AND
- D. ALL EXTERIOR FOUNDATION WALLS ARE DIMENSIONED TO
- EXTERIOR FACE OF ASSEMBLY UNLESS OTHERWISE NOTED. E. ALL INTERIOR FOUNDATION WALLS + FOOTINGS ARE DIMENSIONED FROM GRIDLINE TO FACE UNLESS OTHERWISE
- F. ALL WINDOWS ARE DIMENSIONED TO CENTERLINE OF
- G. ALL DOORS ARE DIMENSIONED TO CENTERLINE OF DOOR
- I. ALL INTERIOR DIMENSIONS ARE DIMENSIONED FROM INTERIOR FINISHED FACES OF EXTERIOR WALLS, UNLESS
- J. ALL INTERIOR WALLS ARE DIMENSIONED TO CENTERLINE OF PARTITION, UNLESS OTHERWISE NOTED. CONSIDER OFFSET FROM PARTITION CENTERLINE TO STUD FRAMING CENTER
- BASED ON WALL ASSEMBLY. K. ENSURE 25mm MINIMUM THICKNESS OF CONCRETE COVER OVER VERTICAL STEEL REINFORCEMENT TO ALL REINFORCED

- 2 EXTENT OF DROPPED SLAB ABOVE
- 3 DOUBLE TEAR BICYCLE STORAGE SPACES
- 5 EXTENT OF FOUNDATION WALL BELOW

REFERENCE PLAN LEGEND:



NOT IN CONTRACT

PAINTED PARKING ISLAND

ARCHITECT OF RECORD

DESIGN CONCEPT ARCHITECT

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3 2024.10.25 REISSUED FOR SPC AND REZONING 2 2024.08.29 ISSUED FOR SPC AND REZONING REV DATE ISSUE

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5. ALL WORK SHALL BE IN ACCORDANCE WITH THE

ONTARIO BUILDING CODE AND ALL SUPPLEMENTS

OTTAWA ONTARIO, CANADA

PROJECT

254 ARGYLE

254 Argyle Avenue, Ottawa, Ontario

TITLE

REV


LEVEL -2 PLAN

PROJECT NO: 2023-0250 DRAWN: Author APPROVED: Approver 1:100


DRAWING NO.

DATE PRINTED: 2025-03-24 11:59:31 AM

A200

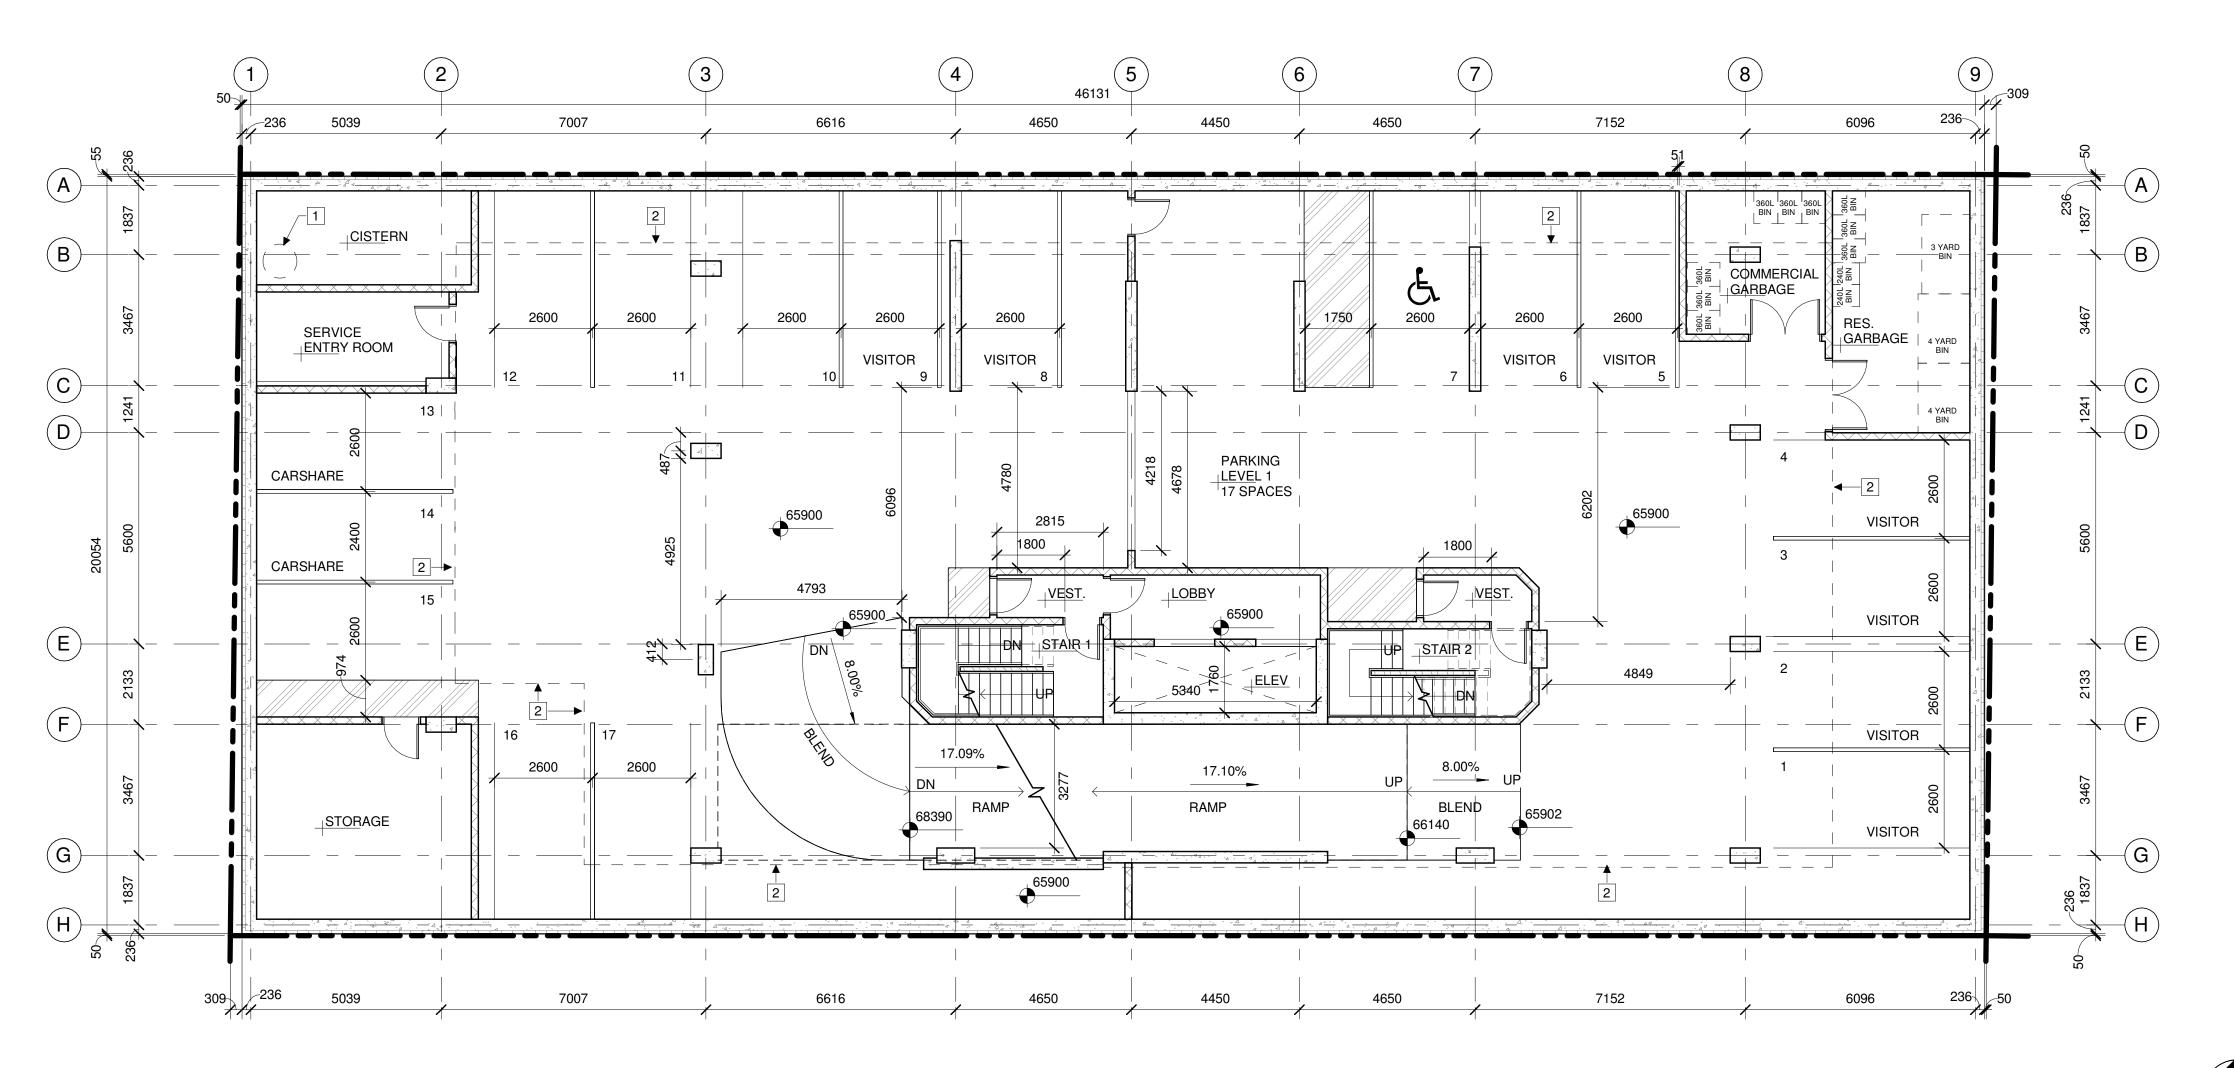

1 LEVEL -1 PLAN A201 1:100

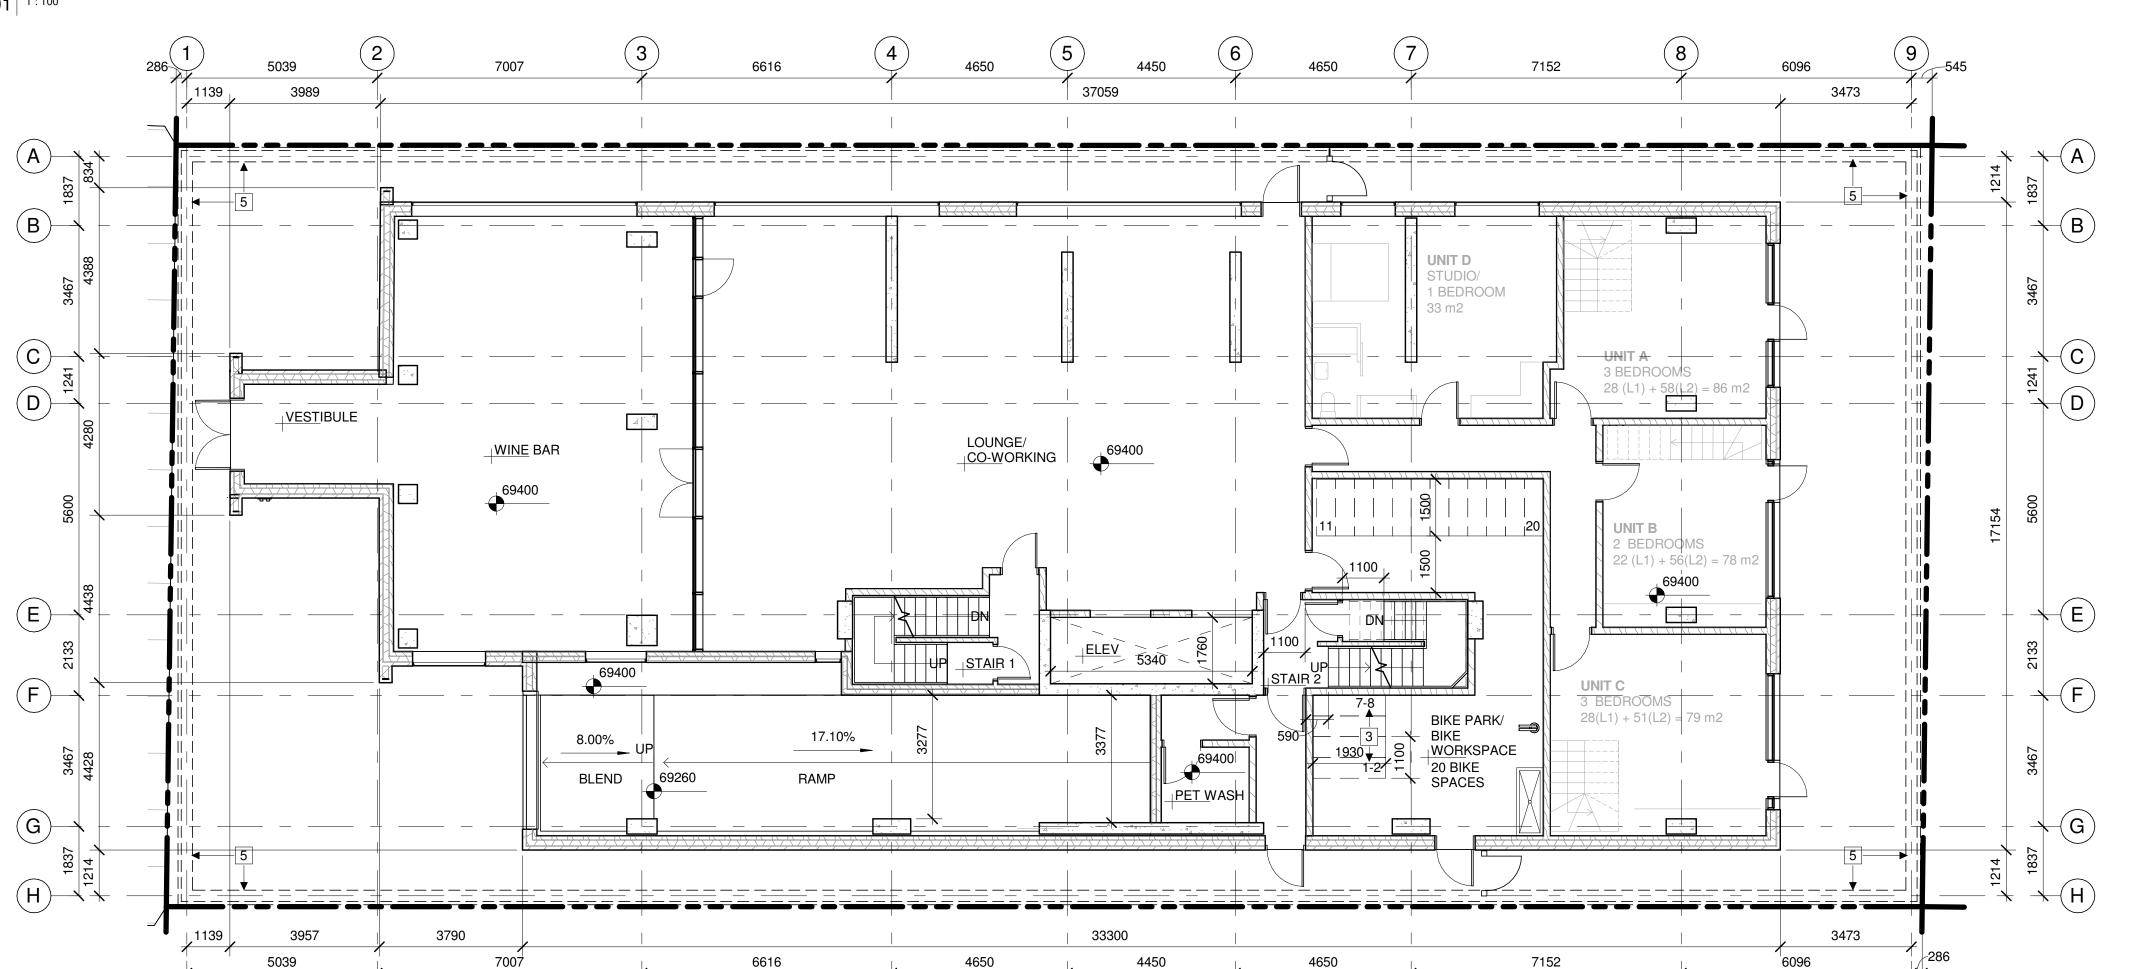

2 GROUND FLOOR REFERENCE PLAN

A201 1:100

GENERAL REFERENCE PLAN NOTES:

- A. DO NOT SCALE DRAWINGS. B. DIMENSIONS ARE FOR LOCATION ONLY. REFER TO STRUCTURAL DRAWINGS FOR FOOTINGS, COLUMNS AND FOUNDATION WALL SIZES.
- C. REFER TO MECHANICAL + ELECTRICAL DRAWINGS FOR DETAILS OF UNDERGROUND SERVICES. D. ALL EXTERIOR FOUNDATION WALLS ARE DIMENSIONED TO
- EXTERIOR FACE OF ASSEMBLY UNLESS OTHERWISE NOTED. E. ALL INTERIOR FOUNDATION WALLS + FOOTINGS ARE DIMENSIONED FROM GRIDLINE TO FACE UNLESS OTHERWISE
- F. ALL WINDOWS ARE DIMENSIONED TO CENTERLINE OF
- WINDOW OPENING, UNLESS OTHERWISE NOTED. G. ALL DOORS ARE DIMENSIONED TO CENTERLINE OF DOOR OPENING, INCLUDING SIDELIGHT FRAMING, UNLESS
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- K. ENSURE 25mm MINIMUM THICKNESS OF CONCRETE COVER OVER VERTICAL STEEL REINFORCEMENT TO ALL REINFORCED CONCRETE STRUCTURAL COLUMNS AND WALLS.

REFERENCE PLAN KEYNOTES:

- 1 CISTERN OVERFLOW AND HATCH / VENTED CISTERN LID
- 2 EXTENT OF DROPPED SLAB ABOVE
- 3 DOUBLE TEAR BICYCLE STORAGE SPACES
- 4 EXIT ONLY
- 5 EXTENT OF FOUNDATION WALL BELOW

REFERENCE PLAN LEGEND:



NOT IN CONTRACT

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- 4 2024.12.20 ISSUED FOR SPC AND REZONING COMMENT RESPONSE 01
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ONTARIO BUILDING CODE AND ALL SUPPLEMENTS

OTTAWA ONTARIO, CANADA

PROJECT 254 ARGYLE

254 Argyle Avenue, Ottawa, Ontario

REV

TITLE


LEVEL -1 AND GROUND FLOOR PLANS

PROJECT NO: 2023-0250 DRAWN: IK / EF APPROVED: DH 1:100

DATE PRINTED: 2025-03-24 11:59:32 AM

A201

DRAWING NO.

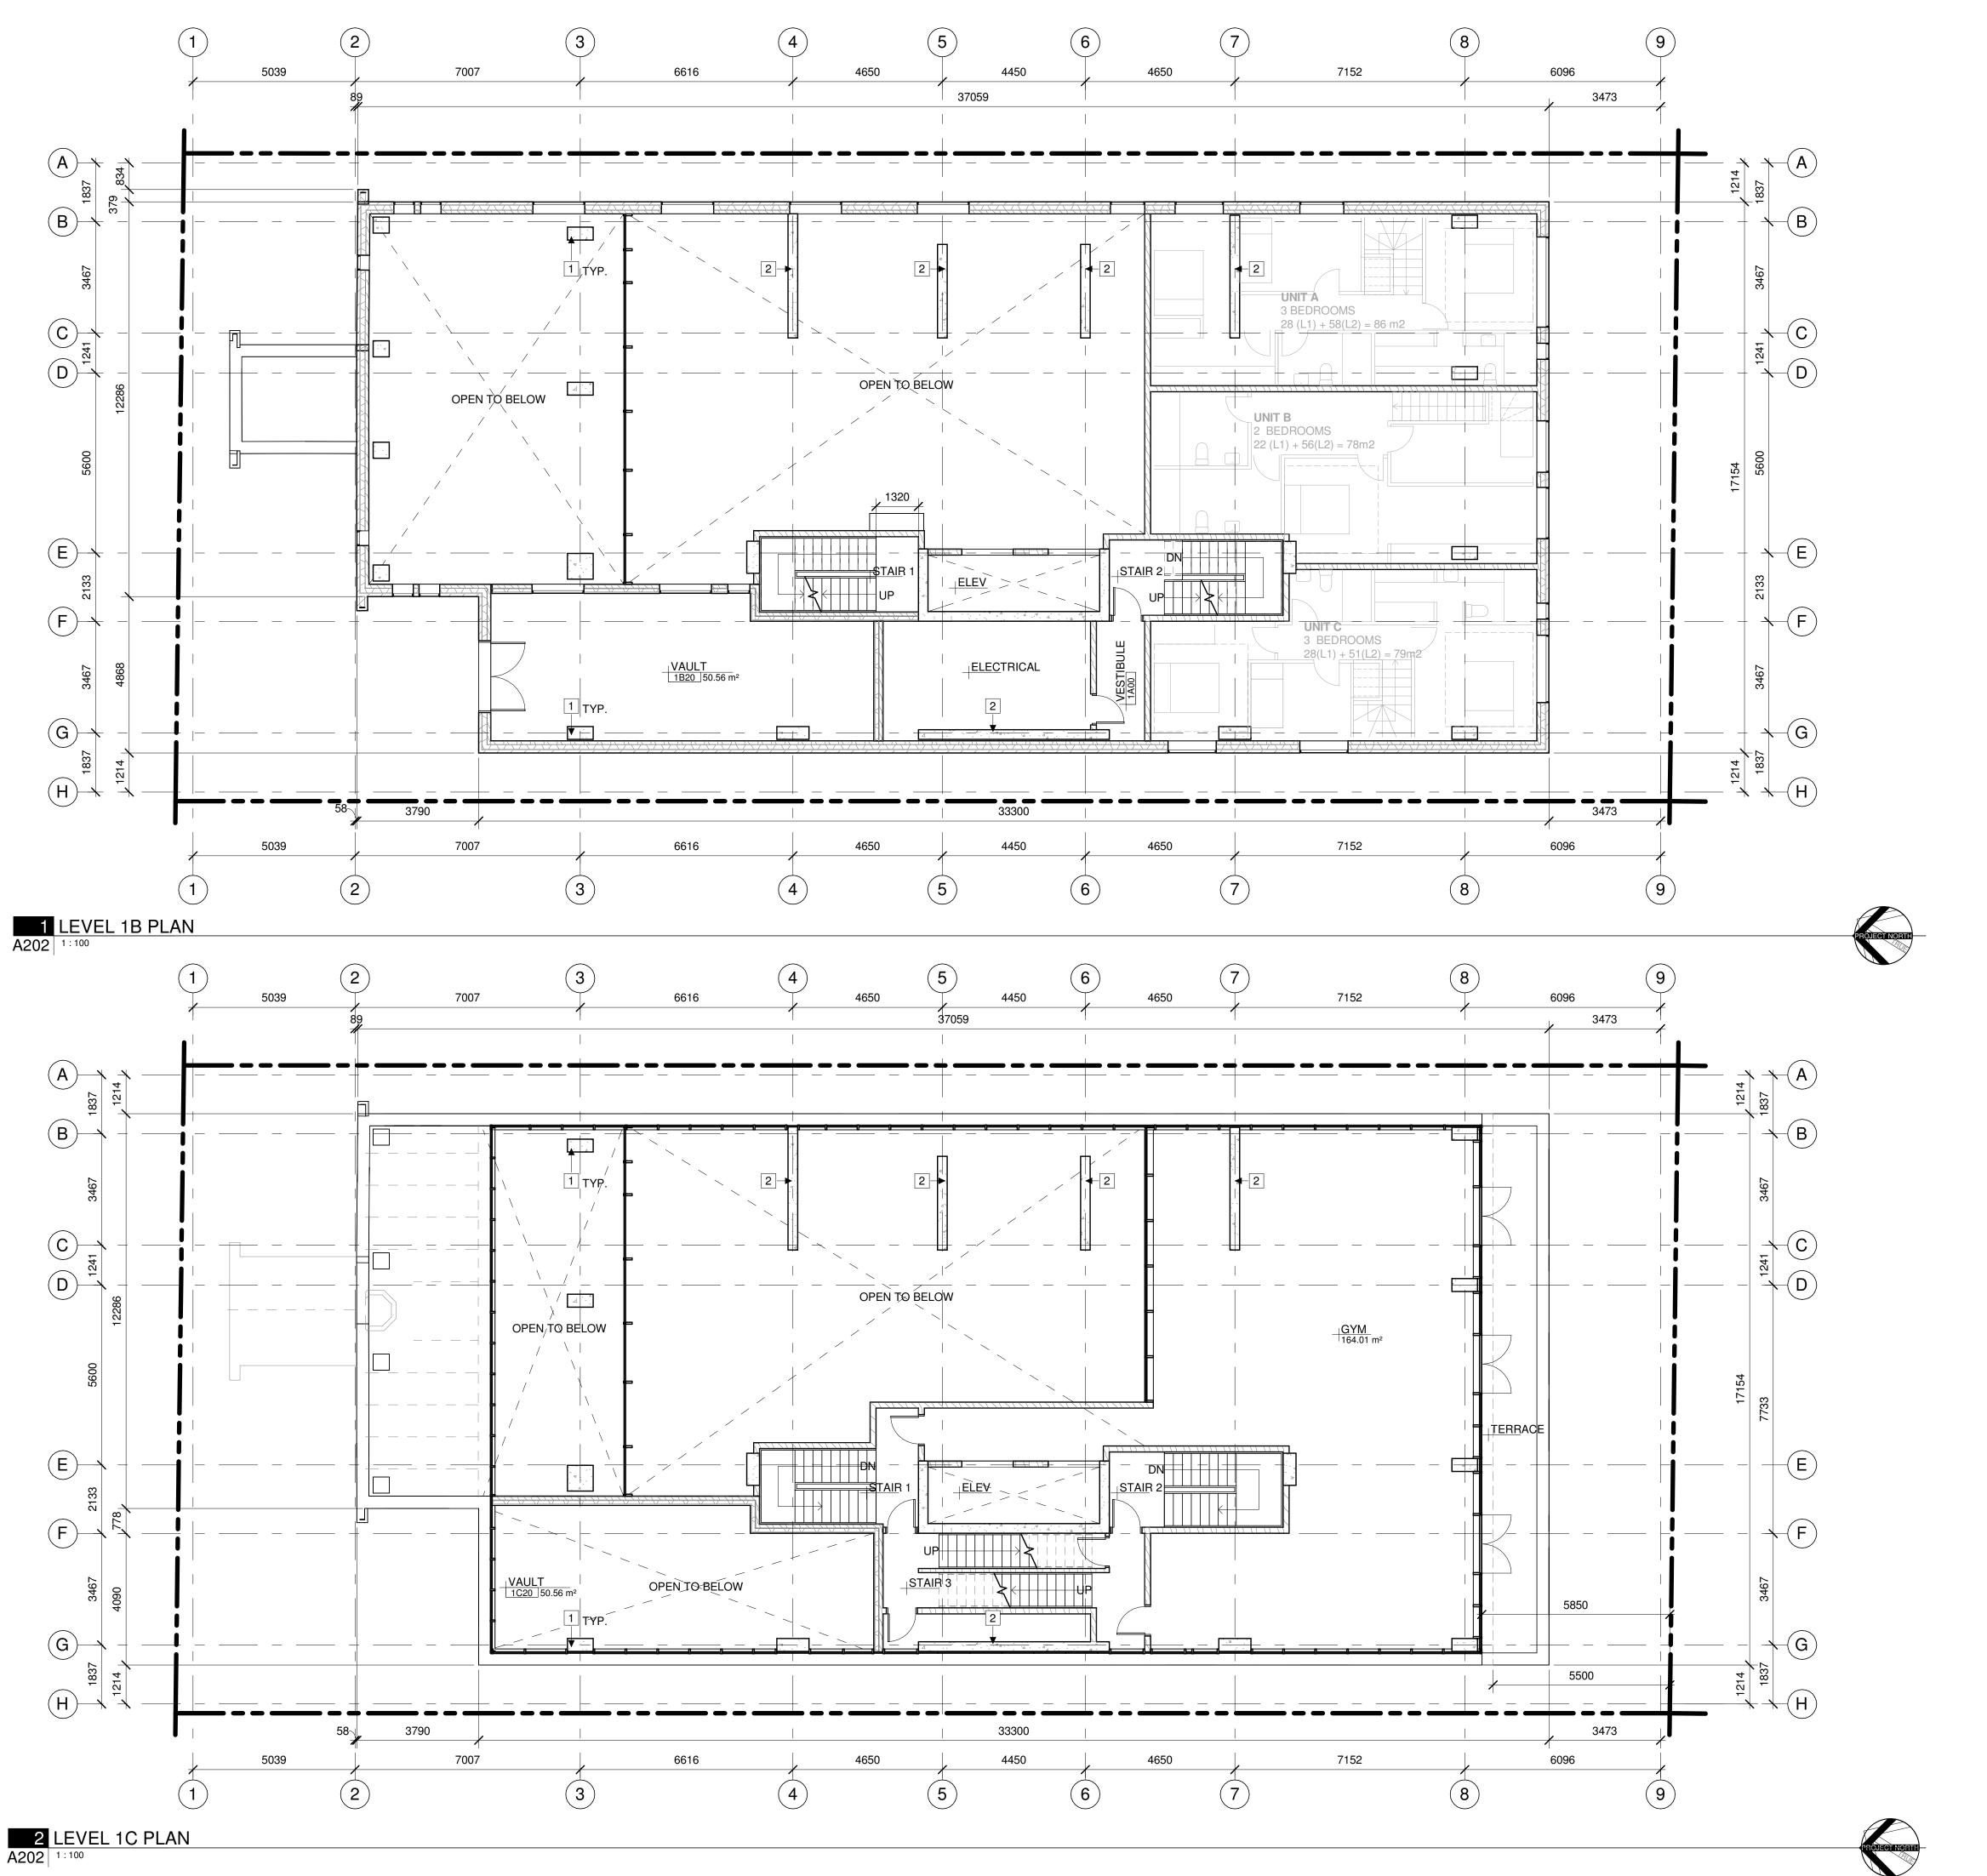

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- C. REFER TO MECHANICAL + ELECTRICAL DRAWINGS FOR DETAILS OF UNDERGROUND SERVICES.
- D. ALL WINDOWS ARE DIMENSIONED TO CENTERLINE OF WINDOW OPENING, UNLESS OTHERWISE NOTED. E. ALL DOORS ARE DIMENSIONED TO CENTERLINE OF DOOR OPENING, INCLUDING SIDELIGHT FRAMING, UNLESS
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- G. ALL INTERIOR DIMENSIONS ARE DIMENSIONED FROM INTERIOR FINISHED FACES OF EXTERIOR WALLS, UNLESS OTHERWISE NOTED. H. ALL INTERIOR WALLS ARE DIMENSIONED TO CENTERLINE OF
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- ENSURE 25mm MINIMUM THICKNESS OF CONCRETE COVER OVER VERTICAL STEEL REINFORCEMENT TO ALL REINFORCED CONCRETE STRUCTURAL COLUMNS AND WALLS.

REFERENCE PLAN KEYNOTES:

- 1 COLUMN PER STRUCTURAL
- 2 WALL PER STRUCTURAL

REFERENCE PLAN LEGEND:

NOT IN CONTRACT

STAMP

3 2024.10.25 REISSUED FOR SPC AND REZONING 2 2024.08.29 ISSUED FOR SPC AND REZONING 1 2024.05.08 ISSUED FOR PHASE 2 PRECONSULT

REV DATE ISSUE

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CLIENT



OTTAWA ONTARIO, CANADA

PROJECT

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254 Argyle Avenue, Ottawa, Ontario


TITLE

LEVEL 1B AND LEVEL 1C PLANS

PROJECT NO: 2023-0250 DRAWN: IK / EF / RK APPROVED: DH 1:100 DATE PRINTED: 2025-03-20 9:35:07 AM

REV DRAWING NO.

A202

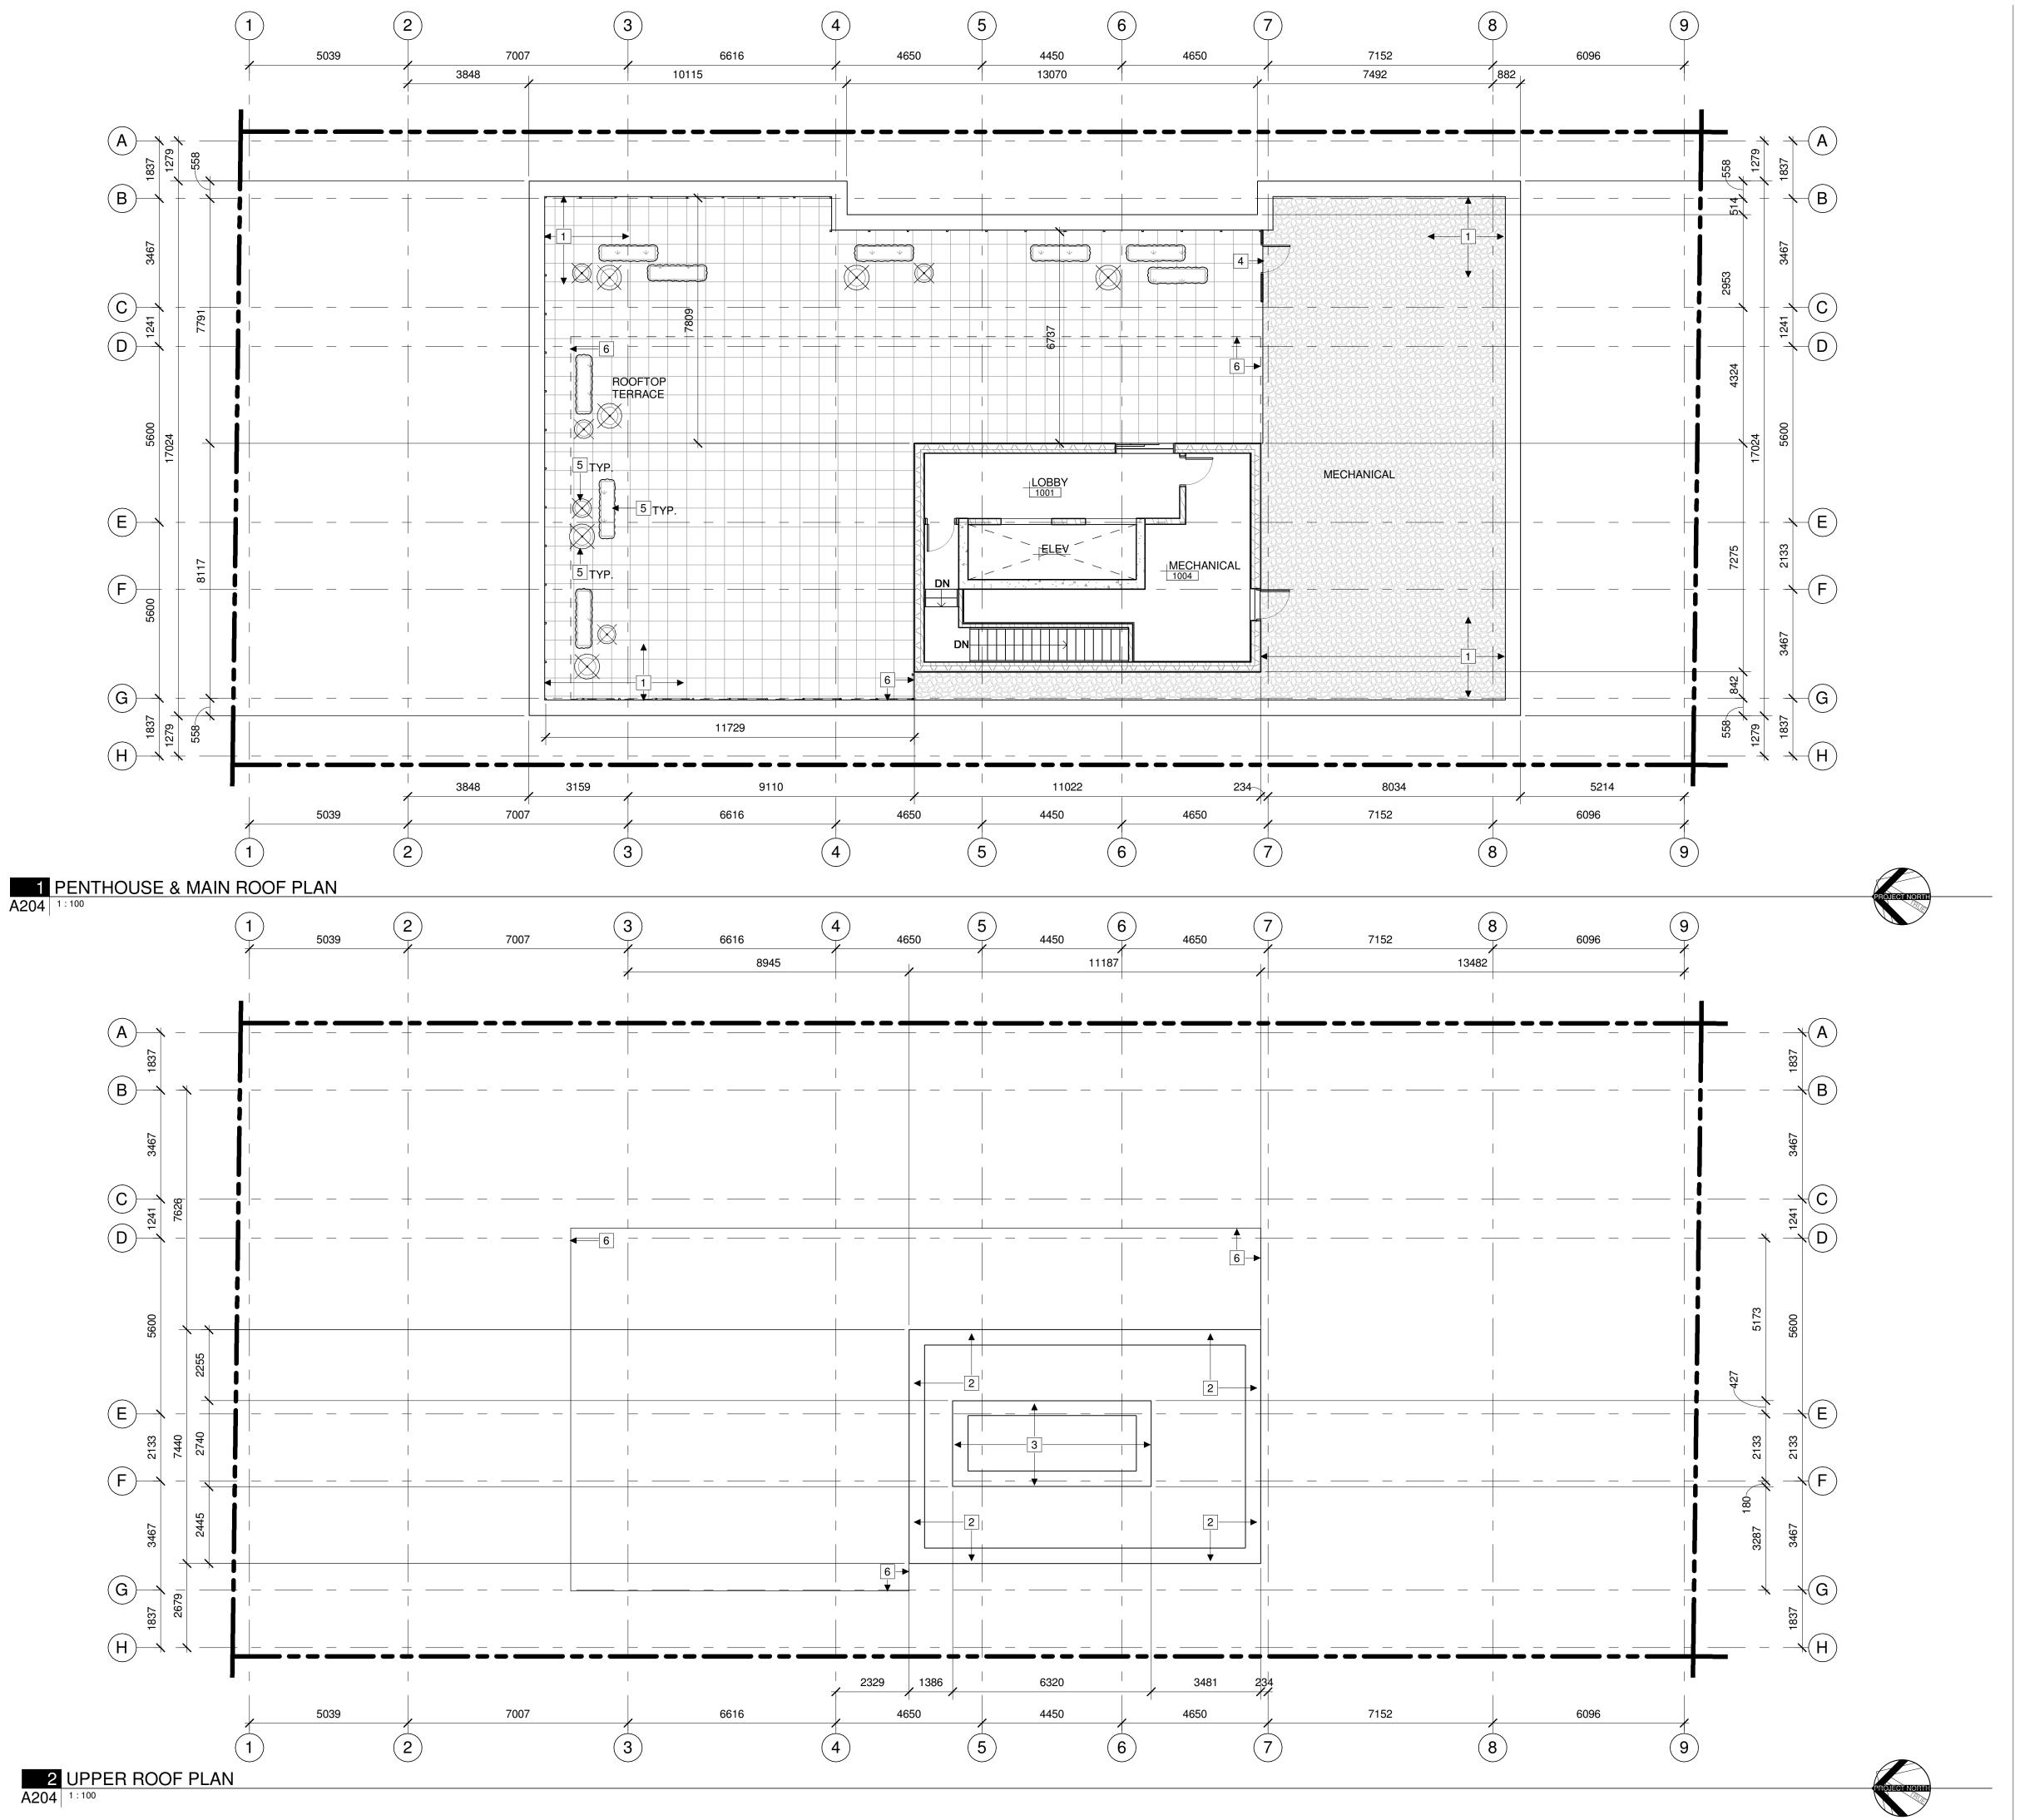

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- OTHERWISE NOTED F. ALL EXTERIOR WALLS ARE DIMENSIONED TO THE EXTERIOR
- FINISHED FACE, UNLESS NOTED OTHERWISE. G. ALL INTERIOR DIMENSIONS ARE DIMENSIONED FROM
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- FROM PARTITION CENTERLINE TO STUD FRAMING CENTER BASED ON WALL ASSEMBLY. ENSURE 25mm MINIMUM THICKNESS OF CONCRETE COVER OVER VERTICAL STEEL REINFORCEMENT TO ALL REINFORCED CONCRETE STRUCTURAL COLUMNS AND WALLS.

REFERENCE PLAN KEYNOTES:

- 1 LOWER LEVEL ROOF
- 2 UPPER ROOF
- 3 ELVATOR SHAFT ROOF
- 4 ROOF SCREEN AND GATE
- 5 SHRUBS IN PLANTER
- 6 EXTENT OF PERGOLA

REFERENCE PLAN LEGEND:



NOT IN CONTRACT

ARCHITECT OF RECORD

CSV ARCHITECTS

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DESIGN CONCEPT ARCHITECT

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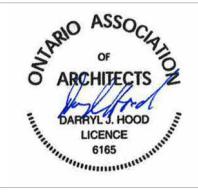
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1 2024.05.08 ISSUED FOR PHASE 2 PRECONSULT REV DATE ISSUE

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OTTAWA ONTARIO, CANADA

PROJECT

254 ARGYLE

254 Argyle Avenue, Ottawa, Ontario

TITLE

ROOFS & PENTHOUSE PLANS

PROJECT NO: 2023-0250 DRAWN: IK / EF / RK APPROVED: DH 1:100

DATE PRINTED: 12/13/2024 2:09:08 PM DRAWING NO.

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