

THESE DOCUMENTS ARE NOT COMPLETE IN ALL DETAILS AND MAY BE SUBJECT TO CHANGE AS DESIGN DEVELOPMENT AND

CODE REVIEW IS ADVANCED.

01	ISSUED TO CITY FOR REVIEW FIRST ENGINEERING SUBMISSION	19/07/22		
No.	ISSUE / REVISION	DD/MM/Y		
This drawing is copyright protected and may not be reproduced				

This drawing is copyright protected and may not be reproduced or used for purposes other than execution of the described work without the express written consent of J.L. Richards & Associates Limited.

/ERIFY SHEET SIZE AND SCALES. BAR TO THE IGHT IS 25mm IF THIS IS A FULL SIZE DRAWING.

SCALE: N.T.S



ARCADIA STAGE 6

450 HUNTMAR DRIVE

ELECTRICAL DETAILS

DESIGN: OS DRAWN: OS RAWING #: CHECKED: RH

JLR #: 26299-006

Statistics							Targets	
Description	Symbol	Avg	Min	Avg/Min	Туре	CLASSIFICATION	Avg	Avg/Min
I - STREET 1 / STREET 2 NORTH	+	8.2 lux	2.5 lux	3.3:1	INTERSECTION	LOCAL	8.0 lux	6.0:1
I - STREET 1 / STREET 2 SOUTH	+	10.0 lux	2.4 lux	4.2:1	INTERSECTION	LOCAL	8.0 lux	6.0:1
I - STREET 1 / STREET 3	+	10.4 lux	4.6 lux	2.3:1	INTERSECTION	LOCAL	8.0 lux	6.0:1
I - STREET 1 / STREET 4	+	8.6 lux	3.0 lux	2.9:1	INTERSECTION	LOCAL	8.0 lux	6.0:1
I - STREET 1 / STREET 5	+	8.8 lux	4.1 lux	2.1:1	INTERSECTION	LOCAL	8.0 lux	6.0:1
I - STREET 1 / STREET 6	+	8.9 lux	3.3 lux	2.7:1	INTERSECTION	LOCAL	8.0 lux	6.0:1
I - STREET 2 / STREET 3	+	8.9 lux	3.6 lux	2.5:1	INTERSECTION	LOCAL	8.0 lux	6.0:1
I - STREET 2 / STREET 4	+	8.5 lux	4.5 lux	1.9:1	INTERSECTION	LOCAL	8.0 lux	6.0:1
STREET 1 - ENTRANCE	+	7.1 lux	1.9 lux	3.7:1	ROAD	LOCAL	4.0 lux	6.0:1
STREET 3	+	8.0 lux	2.5 lux	3.2:1	ROAD	LOCAL	4.0 lux	6.0:1
STREET 5	+	7.2 lux	2.2 lux	3.3:1	ROAD	LOCAL	4.0 lux	6.0:1
STREET 6	+	8.9 lux	3.9 lux	2.31	ROAD	LOCAL	4.0 lux	6.0:1

FIXTURE AND POLE SCHEDULE:


TYPE:	FIXTURE:	POLE:
XA ⊗	L40U LED PENDANT LUMINAIRE 55W LED - ROADWAY LUMINAIRE - 3000K L40U-STM-55W48LED3K-G2-C-LE2	MADISON CONCRETE OCTAGONAL POLE 9.1m MANUFACTURED BY USI MA-300-B-2-BE-60-F-OTT WITH 1.4m BRACKET

NOTE:
ALL LUMINAIRES ARE TO BE COMPLETE WITH LUMEN IQ ADAPTIVE NODE A440 PHOTOCELL. CONTRACTOR TO INSTALL CONTROL

NODE ADDITIONAL IDENTIFICATION STICKER ON DRAWINGS AT EACH STREET LIGHT POLE LOCATION. COORDINATE WITH CITY OF OTTAWA STREET LIGHT PROJECT COORDINATOR.


NOTES: 1. ALL FIXTURE POLES TO HAVE INTEGRAL FUSING AND PHOTO CELL.


- 2. UNLESS NOTED OTHERWISE ALL UNDERGROUND WIRING TO BE MINIMUM #8 TWU OR RWU TYPE, SIZED SO THAT MAXIMUM VOLTAGE DROP AT THE END OF THE CIRCUIT DOES NOT EXCEED 5% OF SUPPLY VOLTAGE. GROUNDING WIRING (LAST POLE AND EVERY FIFTH POLE) #8 AWG CU RWU CONDUCTOR SHOULD BE USED.
- 3. ALL ROADS CROSSING ARE TO BE CONCRETE ENCASED AS PER CITY OF OTTAWA SPECIFICATION, c/w SPARE DUCT.
- 4. ALL DIRECT BURIED CONDUIT TO BE INSTALLED AS PER CITY OF OTTAWA AND HYDRO OTTAWA SPECIFICATIONS.
- 5. ALL DIRECT BURIED CONDUIT TO BE MINIMUM 75mm PVC TYPE DB2 CONDUIT, REFER TO CITY OF OTTAWA SPECIFICATION LID0001A AND HYDRO
- 6. PROVIDE GROUND RODS AS SHOWN ON ELECTRICAL WIRING DRAWING.
- 7. ALL EMPTY CONDUIT TO BE c/w NYLON PULL STRING.

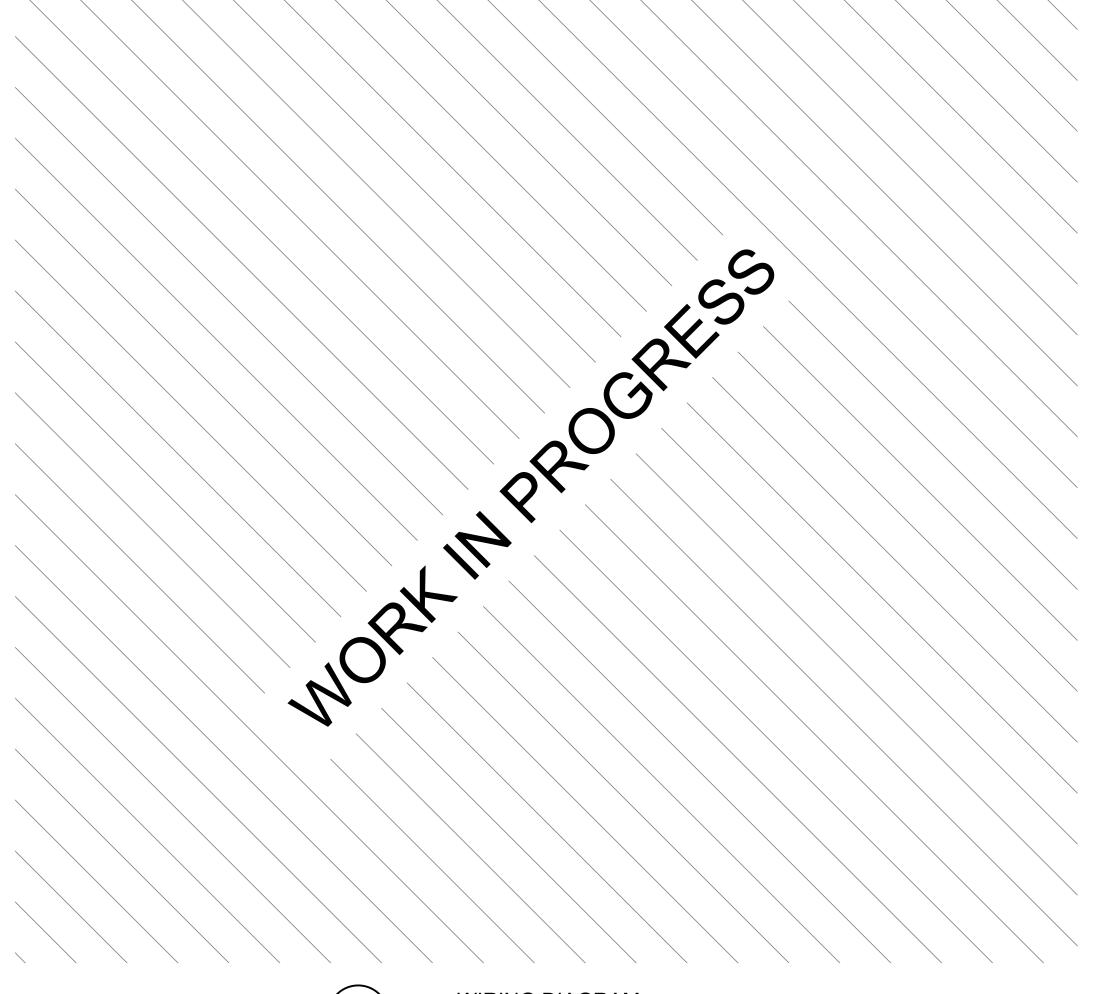


GENERAL NOTES:

1. ALL STREETLIGHT MATERIALS AND INSTALLATIONS MUST COMPLY WITH CITY OF OTTAWA STANDARDS AND SPECIFICATIONS.

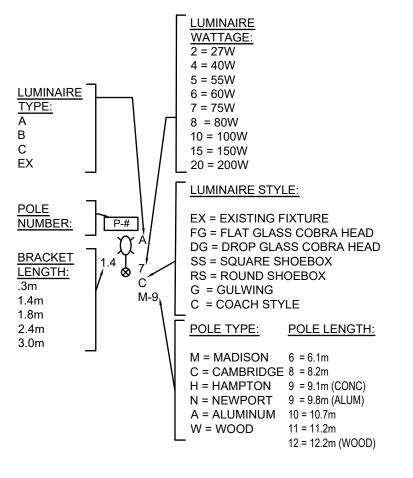

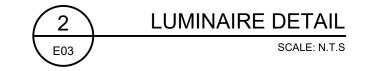



——— 1411mm ———

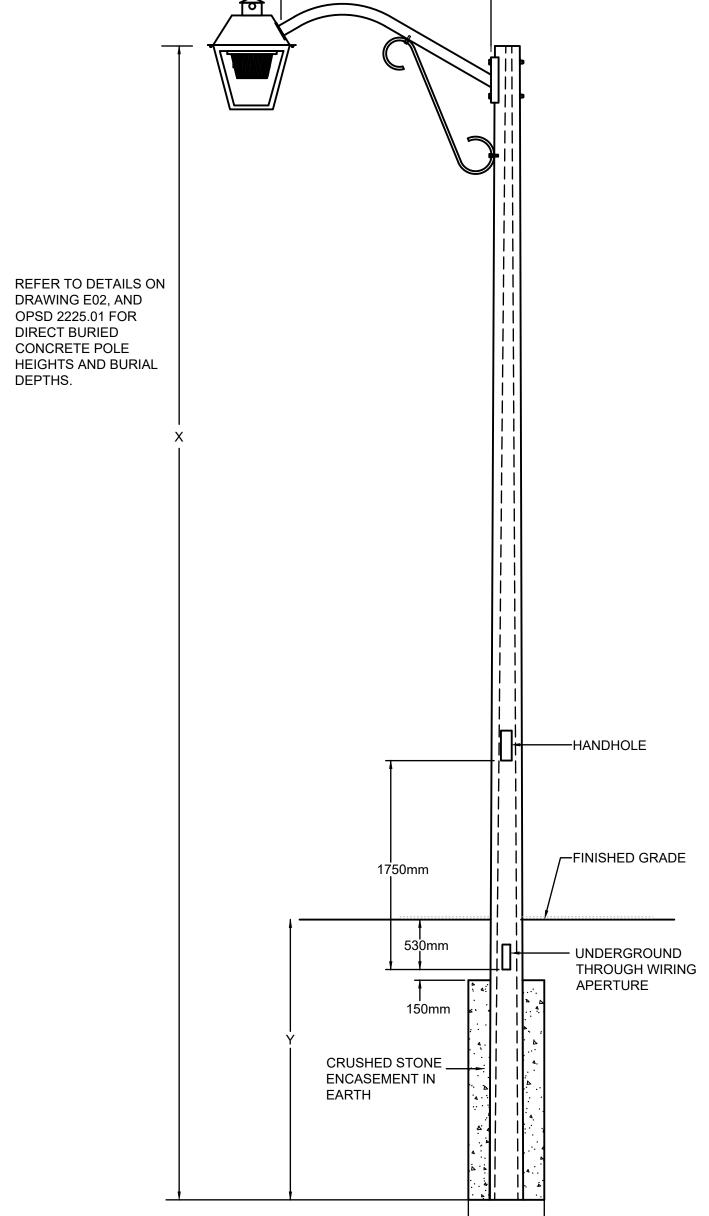

760mm DIA. ———

CONCRETE STREET LIGHT POLE DETAIL

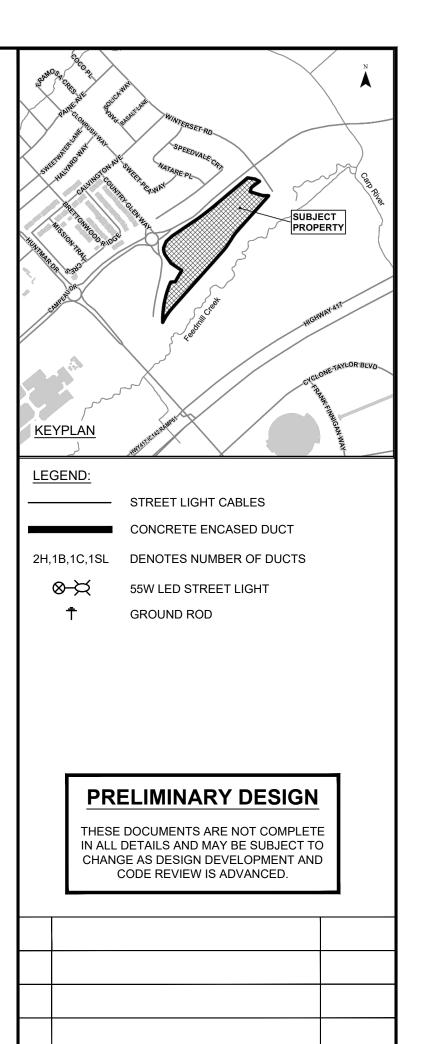


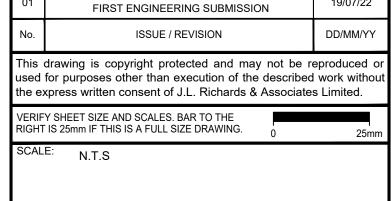


ISSUED TO CITY FOR REVIEW





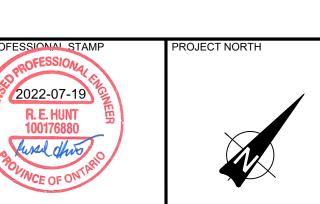

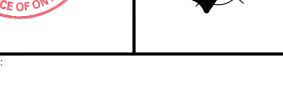

ARCADIA STAGE 6


450 HUNTMAR DRIVE

ELECTRICAL WIRING DIAGRAM & LIGHTING STATISTICS

DESIGN: OS DRAWN: OS CHECKED: RH E03 JLR #: 26299-006

WIRING DIAGRAM SCALE: N.T.S



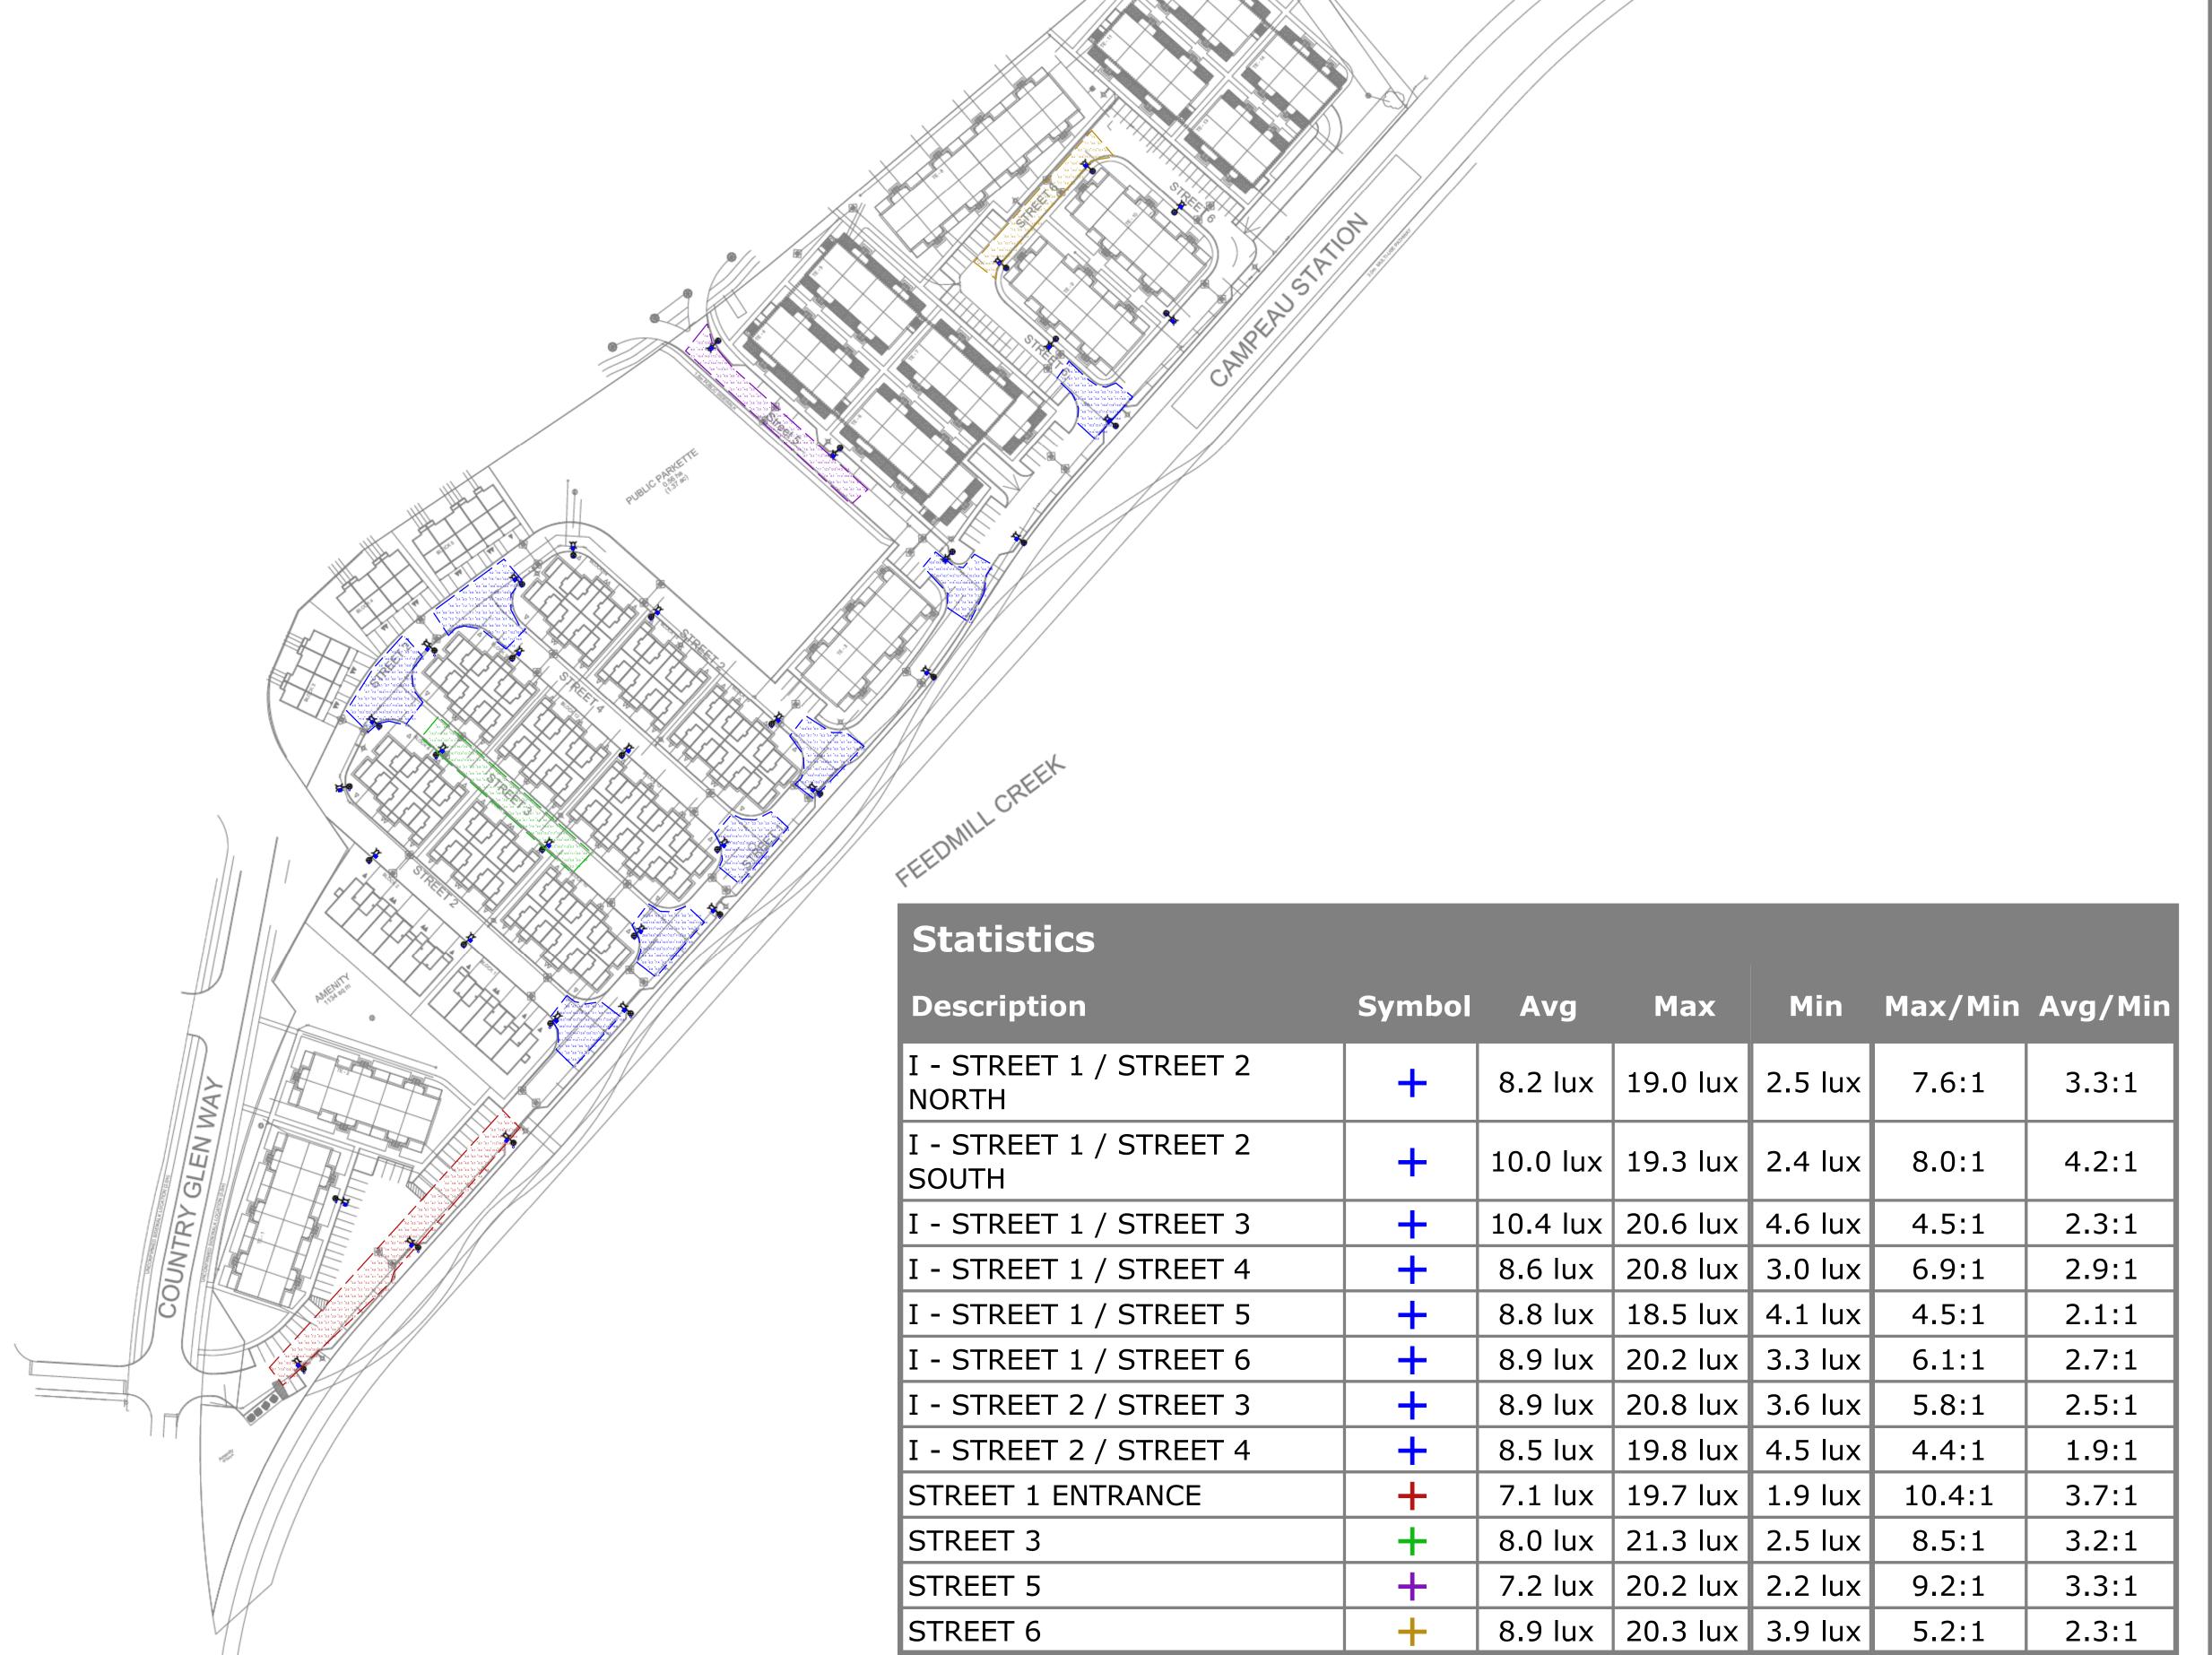

Designer
OS
Date
2022-07-18
Scale
Not to Scale
Drawing No.
Summary