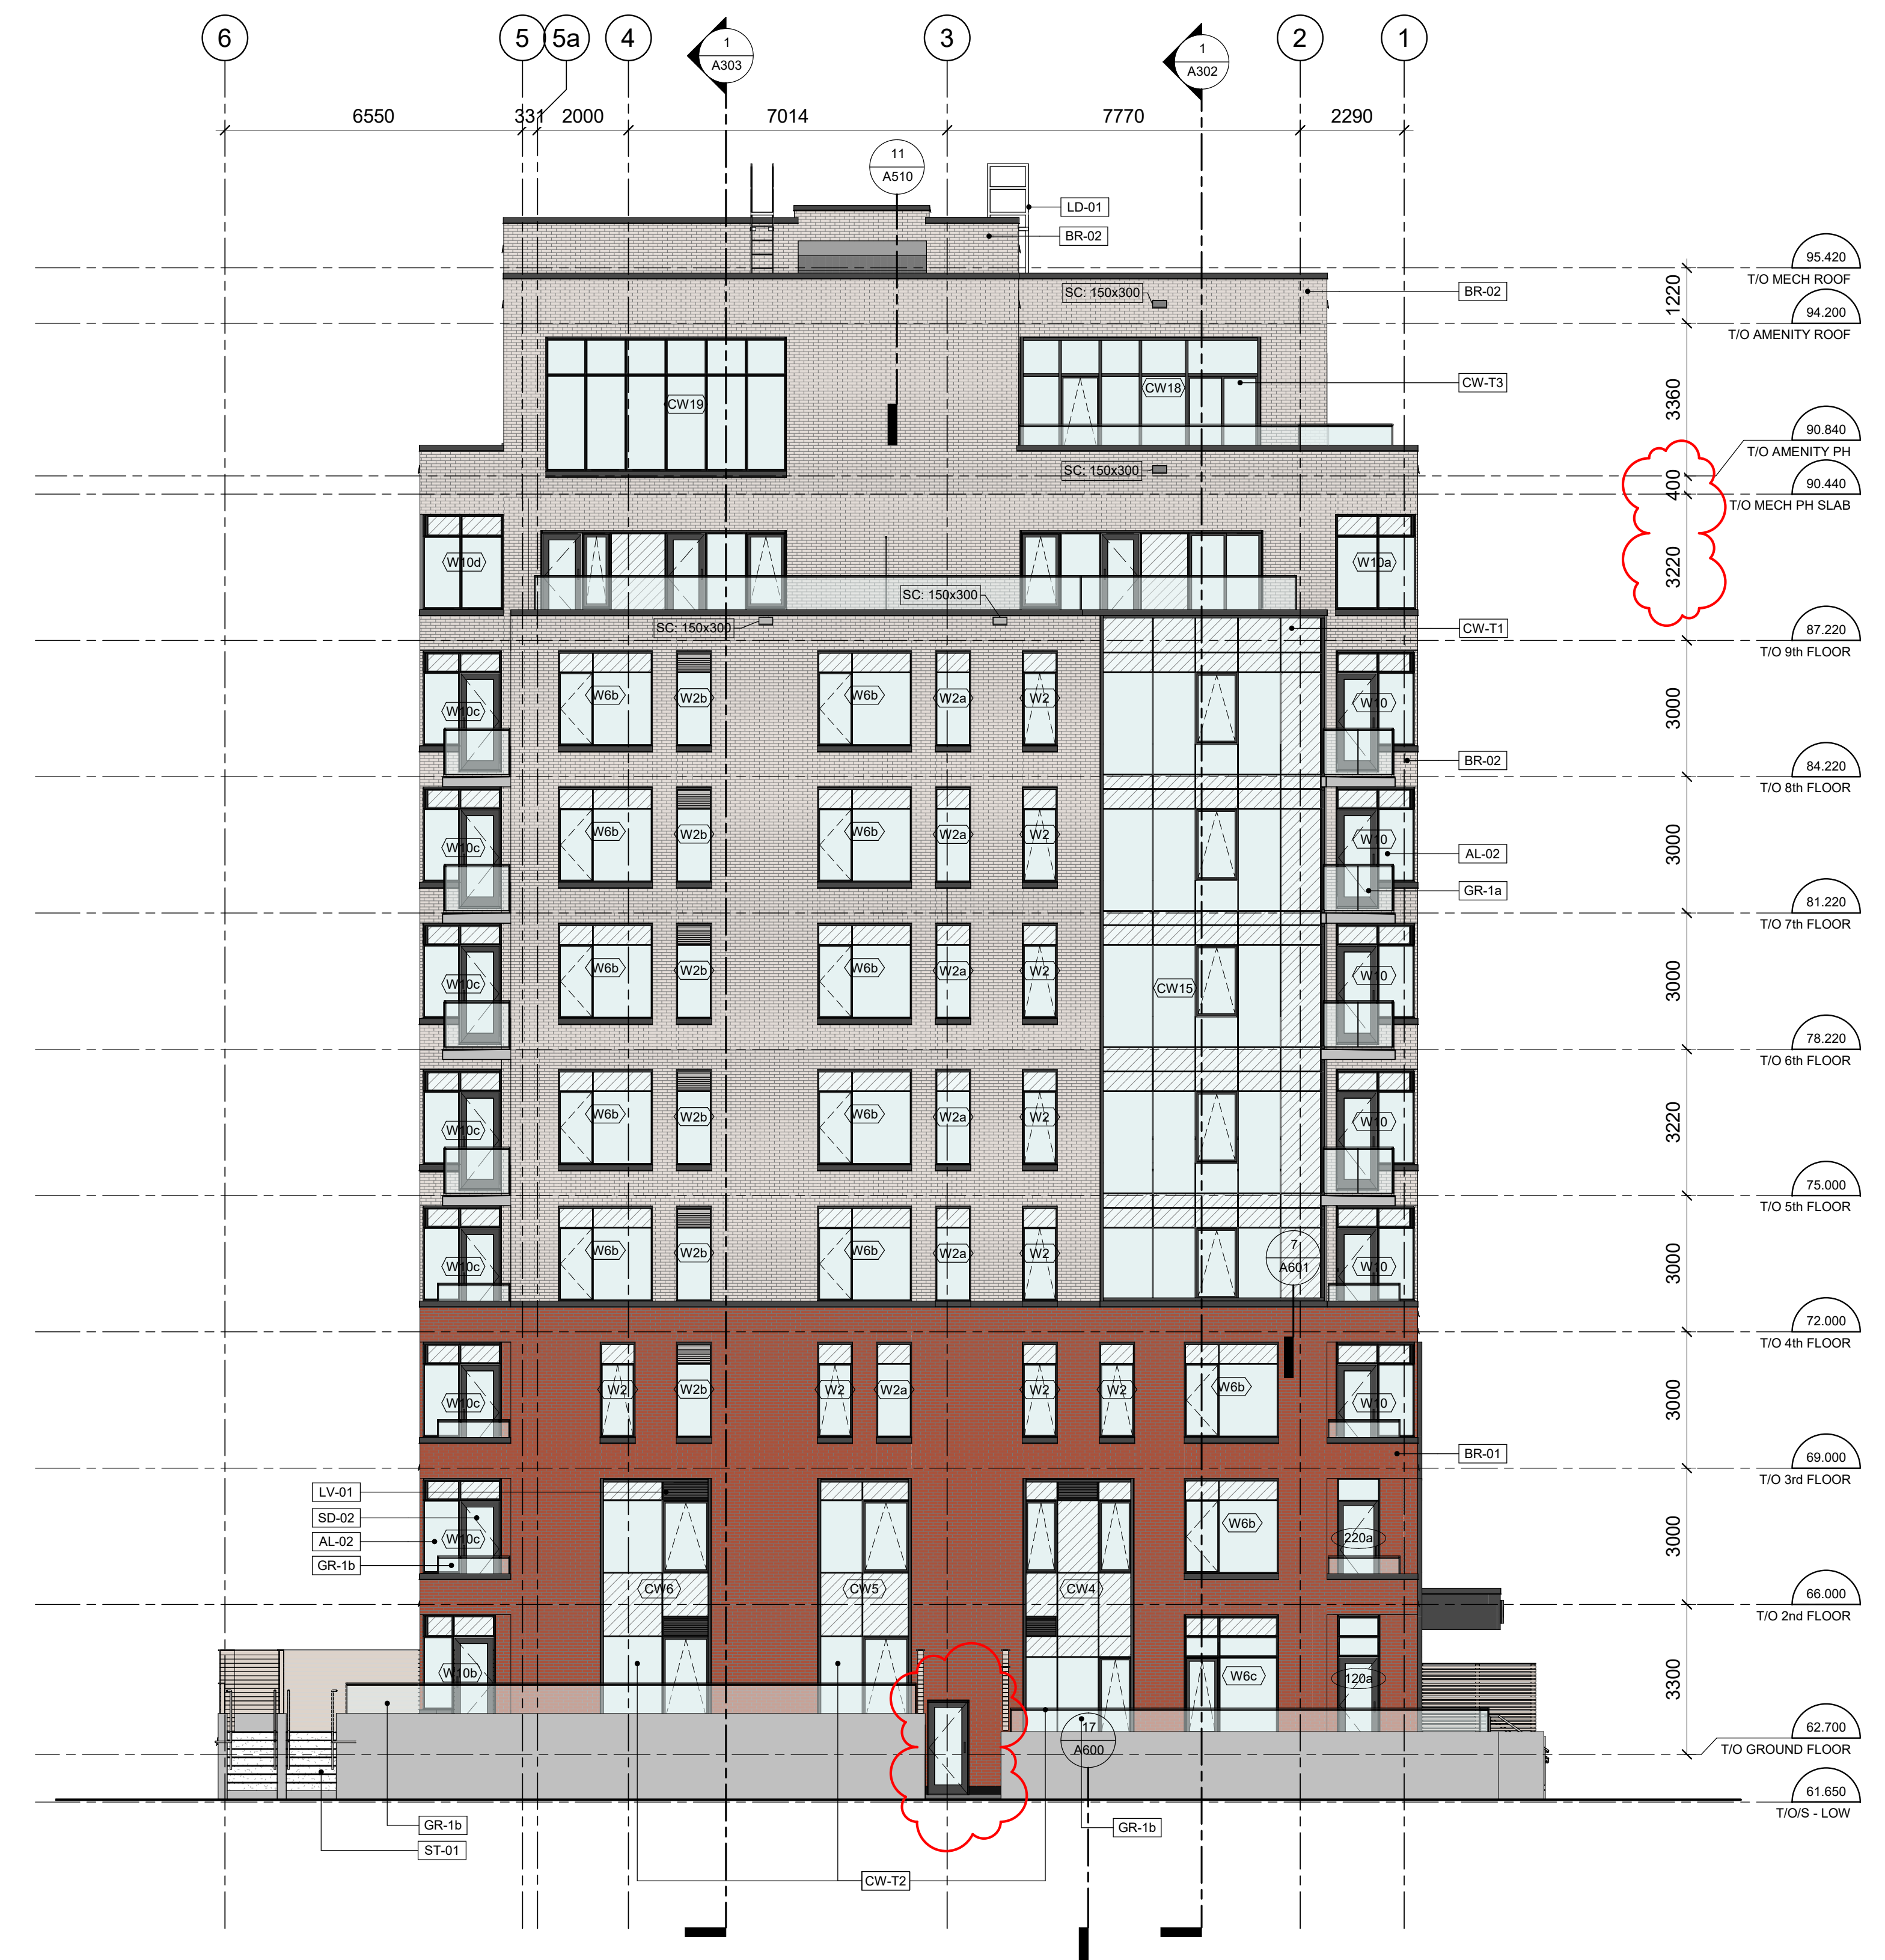


IT IS THE RESPONSIBILITY OF THE APPROPRIATE CONTRACTOR TO CHECK AND VERIFY ALL DIMENSIONS ON SITE AND TO REPORT ALL ERRORS AND/OR OMISSIONS TO THE ARCHITECT.  
 ALL CONTRACTORS MUST COMPLY WITH ALL PERTINENT CODES AND BY-LAWS.  
 THIS DRAWING MAY NOT BE USED FOR CONSTRUCTION UNTIL SIGNED BY THE ARCHITECT.  
 DO NOT SCALE DRAWINGS.  
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KEYNOTE	DESCRIPTION
AL-01	ALUMINUM PUNCHED WINDOW. SEE WINDOW SCHEDULE.
AL-02	ALUMINUM PUNCHED WINDOW w/ OUTSIDE CORNER SSG. SEE WINDOW SCHEDULE.
BR-01	MASONRY BRICK TYPE 1: STANDARD MODULAR BRICK, RUNNING BOND, LIGHT BROWN.
BR-02	MASONRY BRICK TYPE 2: STANDARD MODULAR BRICK, RUNNING BOND, LIGHT BROWN.
CW-T1	CURTAIN WALL TYPE 1: PERIMETER CAPPED CURTAIN WALL c/w INTERMEDIATE SSG FRAMES. SEE WINDOW SCHEDULE.
CW-T2	CURTAIN WALL TYPE 2: PERIMETER CAPPED (w/ SPECIAL EXTRUSION) CURTAIN WALL c/w INTERMEDIATE SSG FRAMES. SEE WINDOW SCHEDULE.
CW-T3	CURTAIN WALL TYPE 3: PERIMETER CAPPED CURTAIN WALL c/w INTERMEDIATE CAPPED FRAMES. SEE WINDOW SCHEDULE.
FL-01	FLASHING TYPE 1: BLACK PARAPET CAP FLASHING, TYP.
GR-1a	1070mm HIGH GLASS BALCONY GUARDRAIL: TOP-MOUNTED.
GR-1b	1070mm HIGH GLASS BALCONY GUARDRAIL: WALL-MOUNTED.
LD-01	ROOF ACCESS LADDER.
LV-01	WINDOW LOUVER. REFER TO MECH.
PO	PROTECTED OPENING. COORDINATE SUPPLY OF SPRINKLER PROTECTION, DAMPERS AND FUSIBLE LINKS TO SUIT ARCHITECTURAL AND MECHANICAL.
PS-1a	PRIVACY SCREEN TYPE 1: 1880mm HIGH, 6mm TEMPERED GLASS.
PS-2a	PRIVACY SCREEN TYPE 2a: WOOD CEDAR SLATS. REFER TO LANDSCAPE.
SD-02	ALUMINUM SWING DOOR (INSULATED).

KEYNOTE	DESCRIPTION
ST-01	CAST-IN PLACE CONCRETE STAIR.


*Douglas James*  
**DOUGLAS JAMES, MCIP, RPP**  
 MANAGER, DEVELOPMENT REVIEW - CENTRAL  
 PLANNING, INFRASTRUCTURE & ECONOMIC  
 DEVELOPMENT DEPARTMENT, CITY OF OTTAWA

**APPROVED**  
 By Jamesdo at 11:44 am, Nov 25, 2021

1 EAST ELEVATION  
 A202 1:100

2 WEST ELEVATION  
 A202 1:100

No.	DESCRIPTION	DATE
15	ISSUED FOR LEVEL 9 REVISIONS	2021-11-09
13	ISSUED FOR CURTAIN WALL AND WINDOW WALL TENDER	2021-10-25
11	ISSUED FOR BUILDING PERMIT	2021-09-13
10	ISSUED FOR COORDINATION	2021-09-01
9	ISSUED FOR 90% REVIEW	2021-08-24
8	ISSUED FOR 75% REVIEW	2021-08-13
6	ISSUED FOR FOUNDATION PERMIT	2021-07-26
5	ISSUED FOR COORDINATION	2021-07-23
4	ISSUED FOR 60% REVIEW	2021-06-29
3	ISSUED FOR UDRP COMMENTS RESPONSE	2021-06-04
2	ISSUED FOR 30% INTERNAL REVIEW	2021-04-01
1	ISSUED FOR SITE PLAN APPROVAL	2021-03-08

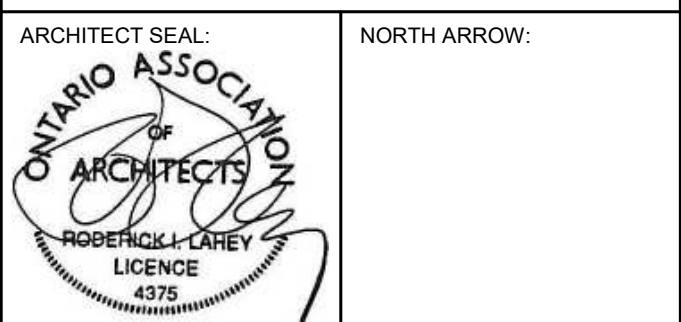

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PROJECT TITLE:  
 93 NORMAN  
 93 NORMAN ST  
 SHEET TITLE:  
 EAST & WEST ELEVATION

DRAWN: VM	CHECKED: KR
SCALE: 1:100	SHEET No: A202
PROJECT No: 2032	

PAPER SIZE: ISO Full Sheet B1 (707.00 x 1000.00mm) PLOT SCALE: 1:1  
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