GENERAL NOTES:

CONTRACTOR TO VERIFY ALL DIMENSIONS AND SITE CONDITIONS AND BRING ANY DISCREPANCY TO THE ATTENTION OF THE ENGINEER

CONTRACTOR TO ABIDE BY ALL APPLICABLE LEGISLATION, CITY OF OTTAWA SPECIFICATIONS, MOE REGULATIONS, AND BEST TRADE PRACTICES. THE LOCATION OF UTILITIES, WHERE SHOWN, IS APPROXIMATE ONLY, AND THE EXACT LOCATION MUST BE DETERMINED BY CONTACTING THE PROPER AUTHORITIES CONCERNED. THE CONTRACTOR MUST PROVE THE LOCATION OF UTILITIES AND SHALL BE RESPONSIBLE FOR THEIR ADEQUATE

PROTECTION FROM DAMAGE DURING CONSTRUCTION. 4. CONTRACTOR TO INSTALL ALL OBC REQUIRED, BARRIER-FREE COMPONENTS ASSOCIATED WITH BARRIER-FREE PARKING AND EXTERIOR WALKS.

5. CONTRACTOR TO INSTALL A TACTILE ATTENTION INDICATOR AT BASE OF EXTERIOR WALK RAMP AS PER OBC 3.8.3.2.(h) AND 3.8.3.18.

6. REFER TO GEOTECHNICAL REPORT PREPARED BY PATERSON GROUP, DATED JANUARY 9TH, 2019, FOR GEOTECHNICAL INFORMATION.

. ALL BEDDING MATERIALS TO CONFORM TO CITY OF OTTAWA STANDARD DRAWING S6, LATEST EDITION.

2. GRANULAR A BEDDING MATERIAL TO BE IN ACCORDANCE WITH OPSS 1010, 314, 501 AND INSTALLED TO OPSD 708.030, 802.010M (GRAN. 'A' ONLY), AND 802.030M (CLASS B, GRAN. 'A' BEDDING AND COVER).

3. ALL BEDDING TO BE COMPACTED TO 95% STANDARD PROCTOR DENSITY AND TESTED BY AN INDEPENDENT COMPANY. HSP ENGINEER TO RECEIVE COPIES OF ALL TESTING REPORTS.

4. BACKFILL MAY CONSIST OF EXCAVATED SILT AND SAND AND/OR GLACIAL TILL AND TO BE COMPACTED TO 95% STANDARD PROCTOR DENSITY IN 300mm

. STORM PIPING MATERIAL TO BE PVC SDR35 (GREEN ONLY)

2. SANITARY PIPING MATERIAL TO BE PVC DR29 (WHITE ONLY).

3. WATER SERVICE TO BE HDPE AS APPROVED BY THE CITY /w CURB BOX AND W3 VALVE CHAMBER. CONNECT TO EXISTING WATERMAIN AS PER CITY

STANDARD DRAWING W50. 4. WATER METER TO BE INSTALLED PER CITY STANDARD DRAWING W32.

5. GRANULAR 'A' BEDDING MATERIAL TO BE INSTALLED AS PER ABOVE.

6. CONNECTION AT EXISTING STORM SEWER SHALL BE THROUGH INSERTA TEE. 7. DEPTH OF BURY OF WATER SERVICE TO BE MINIMUM 2.3m

MAINTENANCE HOLES AND CATCHBASINS: MAINTENANCE HOLES TO BE 1200mm Ø AND AS PER OPSD 701.010 AND 701.030.

3. CATCHBASIN GRATING TO BE "FISH TYPE" AS PER CITY OF OTTAWA STANDARD DETAIL S19.9.

4. MAINTENANCE HOLE LID FOR ALL STORM CATCH BASIN MANHOLES TO BE AS PER CITY OF OTTAWA STANDARD S19.

4. MAINTENANCE HOLE LID FOR ALL STORM MANHOLES TO BE AS PER CITY OF OTTAWA STANDARD S24.1.

4. SANITARY MAINTENANCE HOLE LID FOR TO BE AS PER CITY OF OTTAWA STANDARD S24.

5. ADJUSTMENT UNITS AS PER OPSD 704.010.

6. ALL MAINTENANCE HOLES TO BE EQUIPPED WITH STEPS AS PER OPSD 405.010.

1. AT ALL SEWER CROSSINGS, THE WATERMAIN SHALL BE LOCATED ABOVE THE SEWER. IF NOT FEASIBLE, THEN THE WATERMAIN SHALL GO BELOW WITH A MINIMUM SEPARATION OF 0.5m, AS PER MOE REQUIREMENTS.

STORM WATER QUANTITY NOTES:

1. MH100 TO BE FITTED WITH A HYDROVEX 200 VHV-2, DESIGNED FOR 41L/s AND 2.2m OF HEAD.

GRADING REQUIREMENTS: 1. EMBANKMENTS MUST NOT EXCEED 3:1 IN SLOPE.

. ALL SITE CURBING TO BE INSTALLED AS PER CITY OF OTTAWA DETAIL SC1.1. CONCRETE IS TO BE 32 MPa WITH 7% AIR, AS PER CITY STANDARD. 2. SITE ASPHALT PAVEMENT IS TO BE CONSTRUCTED WITH MINIMUM 400mm GRANULAR B TYPE II, 150mm GRANULAR 'A', 50mm SUPERPAVE SP19.0 AND

40mm SUPERPAVE SP12.5 IN ALL ACCESS LANES.

3. SITE ASPHALT PAVEMENT IS TO BE CONSTRUCTED WITH MINIMUM 300mm GRANULAR B TYPE II, 150mm GRANULAR 'A' AND 50mm SUPERPAVE SP12.5 IN ALL CAR PARKING AREAS.

4. GRANULARS TO BE COMPACTED TO 100% STANDARD PROCTOR DENSITY AND ASPHALT TO BE COMPACTED TO 96% MARSHALL DENSITY. COMPACTION


OF GRANULAR 'A' TO BE TESTED BY AN INDEPENDENT COMPANY WITH COPIES OF ALL REPORTS SENT TO THE HSP ENGINEER. 5. CONCRETE SIDEWALKS ARE TO BE CONSTRUCTED AS PER OPSD 310.010 AND 310.050 WITH 250mm GRANULAR A AND 32 MPa CONCRETE WITH 5±1% AIR.

1. HYDRANT TO BE INSTALLED ON PROPERTY IN LOCATION AS SHOWN IN ACCORDANCE WITH CITY STANDARD W18 AND W19.

2. HYDRANT TO BE CATHODICALLY PROTECTED PER CITY STANDARD DRAWING W49.

CULTEC STORM WATER STORAGE SYSTEM:

1. ALL SITE STORM WATER TO BE STORED UNDERGROUND USING CULTEC STORAGE INFILTRATION SYSTEM.

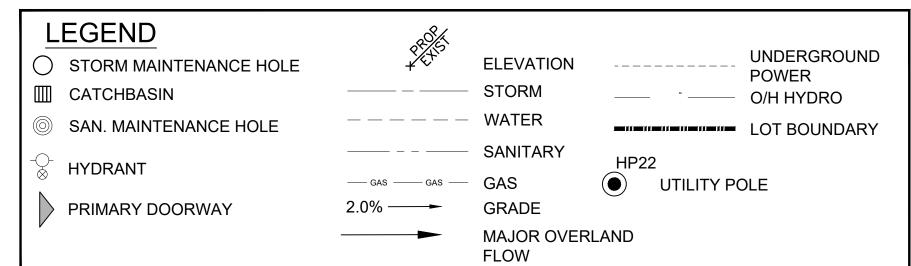

CROSSING TABLE		LE
CROSSING	CLEARANCE	DETAIL NO.
PROPOSED WATER SERVICE & EXISTING GAS	CONFIRM ELEVATION OF GAS LINE	DETAIL 1, DRAWING SP5
PROPOSED SANITARY & EXISTING GAS	CONFIRM ELEVATION OF GAS LINE	DETAIL 2, DRAWING SP5
PROPOSED STORM & EXISTING GAS	CONFIRM ELEVATION OF GAS LINE	DETAIL 3, DRAWING SP5
PROPOSED SANITARY SERVICE & EXISTING WATERMAIN	1020mm VERTICAL	DETAIL 4, DRAWING SP5
PROPOSED STORM SERVICE & EXISTING WATERMAIN	830mm VERTICAL	DETAIL 5, DRAWING SP5
PROPOSED STORM SERVICE & EXISTING SANITARY SEWER	450mm	DETAIL 6, DRAWING SP5
PROPOSED SANITARY SERVICE & PROPOSED STORM SEWER	454mm VERTICAL	DETAIL 7, DRAWING SP5
PROPOSED WATER SERVICE & PROPOSED STORM SEWER	470mm VERTICAL	DETAIL 8, DRAWING SP5

APPROVED ☑

REFUSED □

THIS _29_ DAY OF September, 2020

ERIN O'CONNELL, MCIP, RPP, MANAGER (A) **DEVELOPMENT REVIEW, WEST** PLANNING, INFRASTRUCTURE AND ECONOMIC

DEVELOPMENT DEPARTMENT, CITY OF OTTAWA

REVISION

REVISION

	F	09/01/20	REISSUED FOR SITE PLAN CONTROL	TMG	KJM
	Е	08/12/20	REISSUED FOR SITE PLAN CONTROL	TMG	KJM
	D	08/05/20	REISSUED FOR MVCA COMMENTS	TMG	KJM
	С	06/23/020	REISSUED FOR SITE PLAN CONTROL	TMG	KJM
	В	03/12/20	REISSUED FOR SITE PLAN CONTROL	TMG	KJM
	Α	03/10/20	ISSUED FOR SITE PLAN APPLICATION	TMG	KJM
JE	REV.	DATE (MM/DD/YY)	REASON FOR ISSUE	BY	APP'D BY

ISSUE



5715 Warner Drive Long Sault, ON Canada K0C 1P0 T: 613-932-3289 F: 613-937-0125 www.hsp.ca

Kristopher D. Benes, OAA, MRAIC, LEED AP





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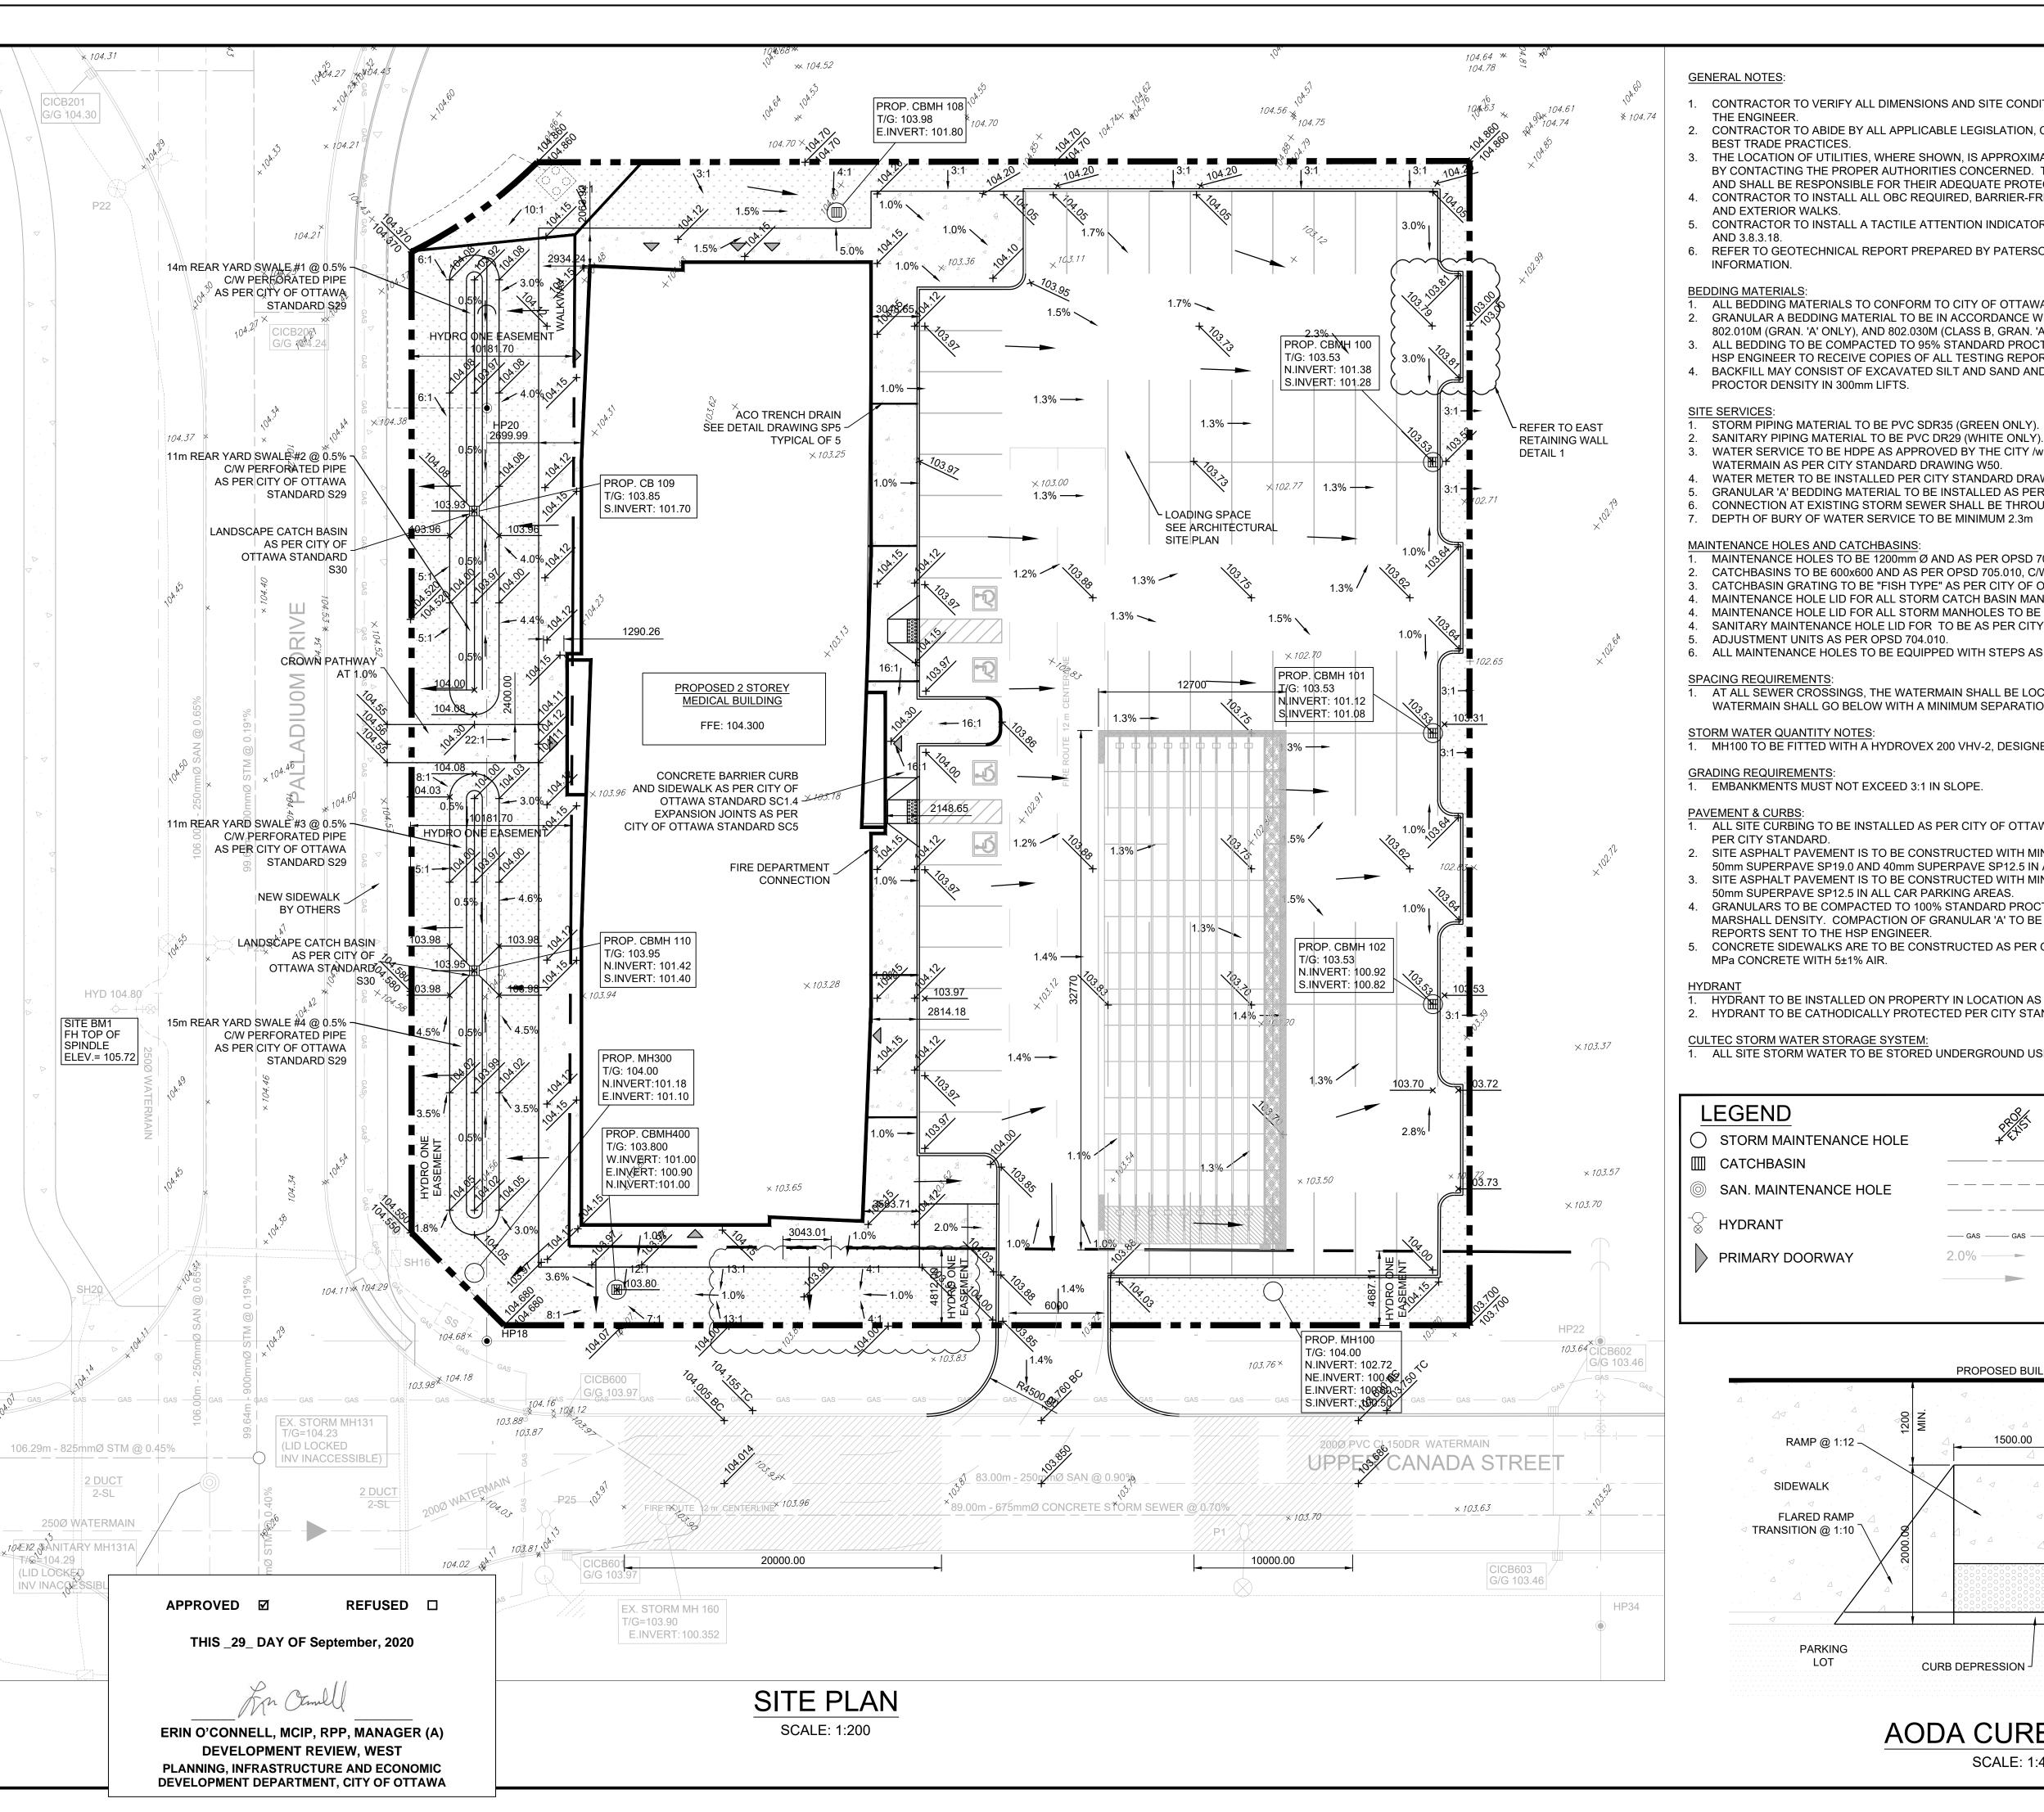


GOVAN BROWN & ASSOCIATES LTD. 31-2000 THURSTON DRIVE OTTAWA, ON K1G 4K7

PANORAMA WELLNESS CENTRE 1380 UPPER CANADA STREET SITE SERVICING PLAN

DESIGNED BY:		CHECKED BY:
T.GOVE	_	B. SAMIS
DRAWN BY:		APPROVED BY:
T.GOVE	Ē	K. MACDONALD
SCALE: 1:200		DRAWING No.
	PROJECT No.	CD1

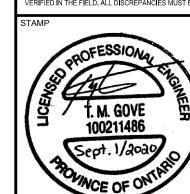20-005

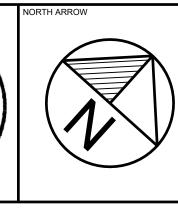

- CONTRACTOR TO VERIFY ALL DIMENSIONS AND SITE CONDITIONS AND BRING ANY DISCREPANCY TO THE ATTENTION OF
- 2. CONTRACTOR TO ABIDE BY ALL APPLICABLE LEGISLATION, CITY OF OTTAWA SPECIFICATIONS, MOE REGULATIONS, AND BEST TRADE PRACTICES.
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- CONTRACTOR TO INSTALL ALL OBC REQUIRED, BARRIER-FREE COMPONENTS ASSOCIATED WITH BARRIER-FREE PARKING AND EXTERIOR WALKS.
- 5. CONTRACTOR TO INSTALL A TACTILE ATTENTION INDICATOR AT BASE OF EXTERIOR WALK RAMP AS PER OBC 3.8.3.2.(h)
- 6. REFER TO GEOTECHNICAL REPORT PREPARED BY PATERSON GROUP, DATED JANUARY 9TH, 2019, FOR GEOTECHNICAL

- ALL BEDDING MATERIALS TO CONFORM TO CITY OF OTTAWA STANDARD DRAWING S6, LATEST EDITION. 2. GRANULAR A BEDDING MATERIAL TO BE IN ACCORDANCE WITH OPSS 1010, 314, 501 AND INSTALLED TO OPSD 708.030,
- 802.010M (GRAN. 'A' ONLY), AND 802.030M (CLASS B, GRAN. 'A' BEDDING AND COVER).
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- GRANULAR 'A' BEDDING MATERIAL TO BE INSTALLED AS PER ABOVE.
- CONNECTION AT EXISTING STORM SEWER SHALL BE THROUGH INSERTA TEE.
- 7. DEPTH OF BURY OF WATER SERVICE TO BE MINIMUM 2.3m

MAINTENANCE HOLES AND CATCHBASINS:

- 1. MAINTENANCE HOLES TO BE 1200mm Ø AND AS PER OPSD 701.010 AND 701.030.
- 2. CATCHBASINS TO BE 600x600 AND AS PER OPSD 705.010, C/W SUMP. 3. CATCHBASIN GRATING TO BE "FISH TYPE" AS PER CITY OF OTTAWA STANDARD DETAIL \$19.9.
- 4. MAINTENANCE HOLE LID FOR ALL STORM CATCH BASIN MANHOLES TO BE AS PER CITY OF OTTAWA STANDARD S19.
- 4. MAINTENANCE HOLE LID FOR ALL STORM MANHOLES TO BE AS PER CITY OF OTTAWA STANDARD S24.1.
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MH100 TO BE FITTED WITH A HYDROVEX 200 VHV-2, DESIGNED FOR 41L/s AND 2.2m OF HEAD.

GRADING REQUIREMENTS


EMBANKMENTS MUST NOT EXCEED 3:1 IN SLOPE.


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CULTEC STORM WATER STORAGE SYSTEM:

1. ALL SITE STORM WATER TO BE STORED UNDERGROUND USING CULTEC STORAGE INFILTRATION SYSTEM.



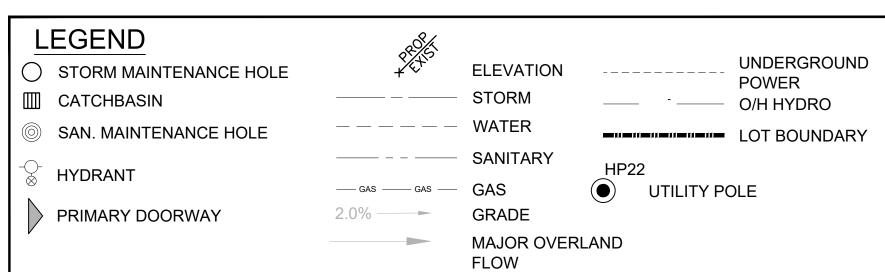

AODA CURB RAMP SCALE: 1:40

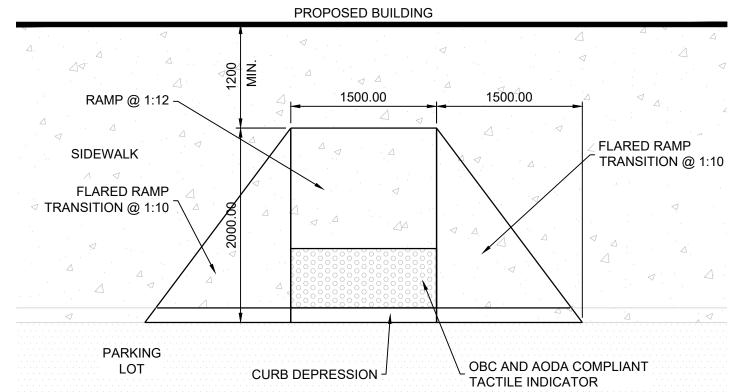6	F	09/01/20	REISSUED FOR SITE PLAN CONTROL	TMG	KJM
5	Е	08/12/20	REISSUED FOR SITE PLAN CONTROL	TMG	KJM
4	D	08/05/20	REISSUED FOR MVCA COMMENTS	TMG	KJM
3	С	06/23/020	REISSUED FOR SITE PLAN CONTROL	TMG	KJM
2	В	03/12/20	REISSUED FOR SITE PLAN CONTROL	TMG	KJM
1	Α	03/10/20	ISSUED FOR SITE PLAN APPLICATION	TMG	KJM
ISSUE No.	REV. No.	DATE (MM/DD/YY)	REASON FOR ISSUE	BY	APP'D BY

ISSUE

REVISION

REVISION



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Kristopher D. Benes, OAA, MRAIC, LEED AP

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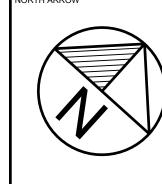
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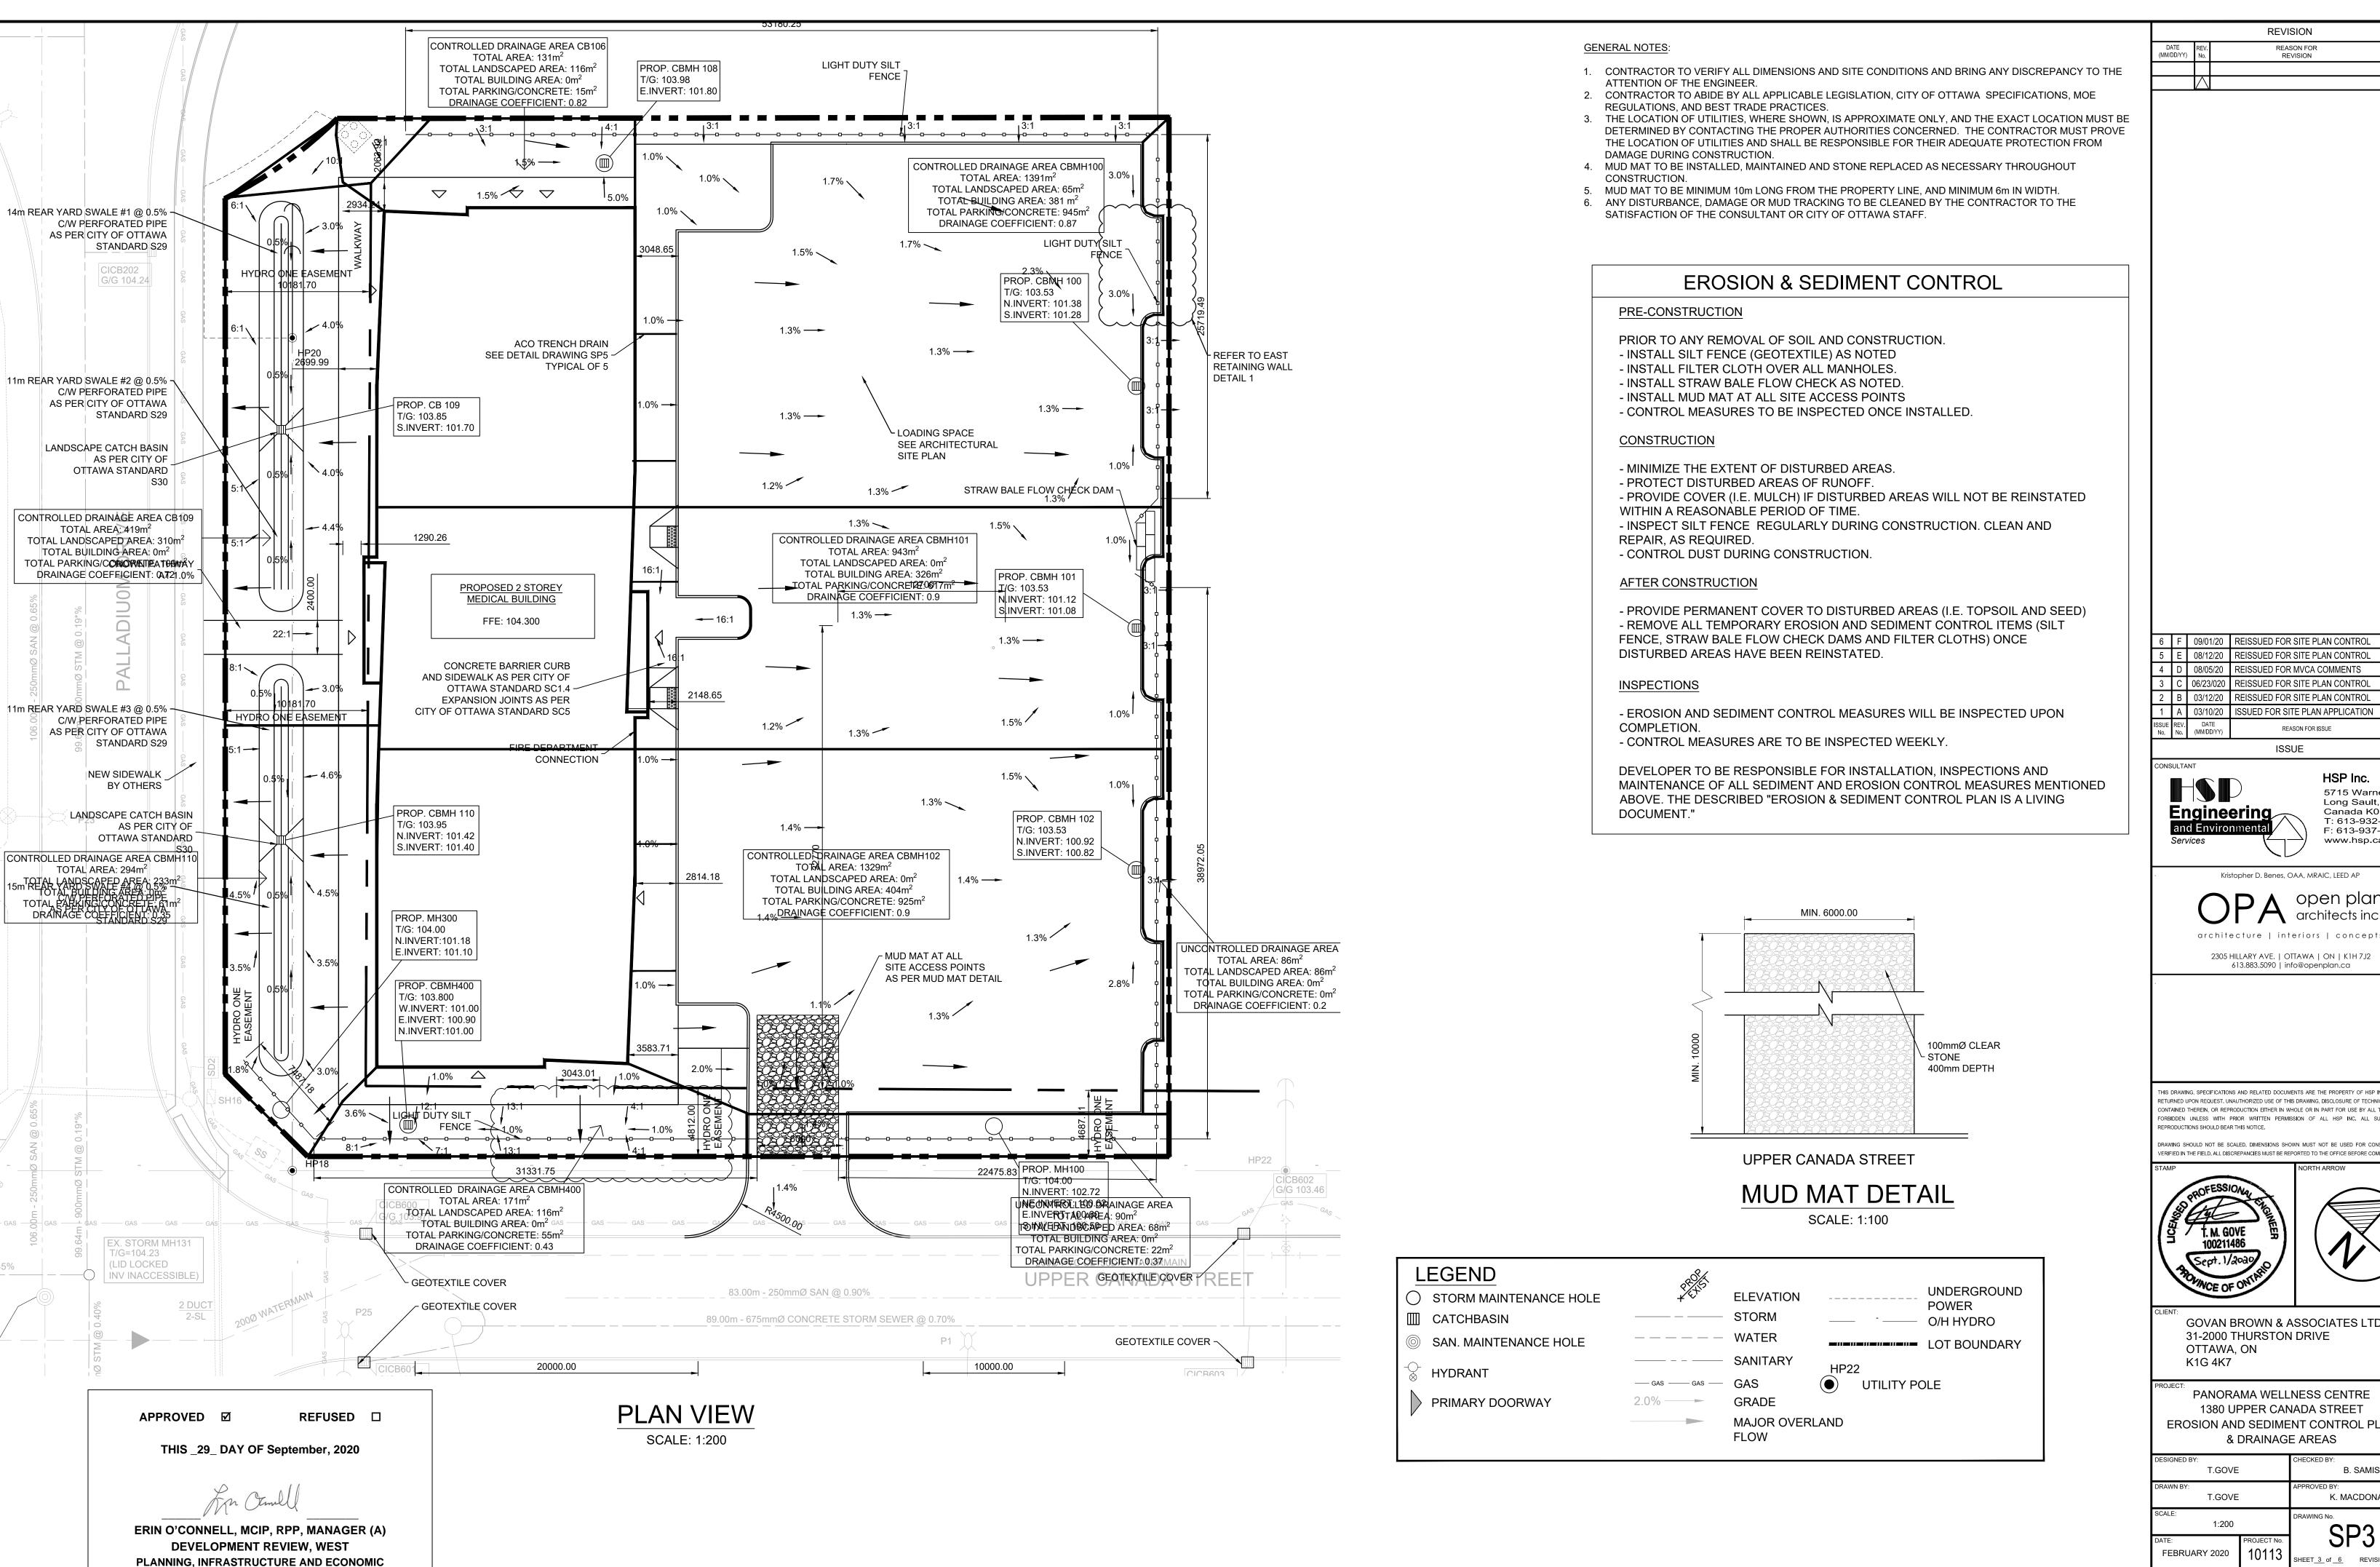
GOVAN BROWN & ASSOCIATES LTD. 31-2000 THURSTON DRIVE OTTAWA, ON K1G 4K7

PANORAMA WELLNESS CENTRE 1380 UPPER CANADA STREET SITE GRADING PLAN

T.GOVE		B. SAMIS
DRAWN BY: T.GOVE		APPROVED BY: K. MACDONALD
SCALE: 1:200		DRAWING No.
DATE: FEBRUARY 2020	PROJECT No. 10113	SPZ

#18123

0-005



DEVELOPMENT DEPARTMENT, CITY OF OTTAWA

REASON FOR REVISION

REVISION

6 F 09/01/20 REISSUED FOR SITE PLAN CONTROL TMG KJM 5 E 08/12/20 REISSUED FOR SITE PLAN CONTROL 4 D 08/05/20 REISSUED FOR MVCA COMMENTS 3 C 06/23/020 REISSUED FOR SITE PLAN CONTROL 2 B 03/12/20 REISSUED FOR SITE PLAN CONTROL 1 A 03/10/20 ISSUED FOR SITE PLAN APPLICATION REASON FOR ISSUE

ISSUE



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Kristopher D. Benes, OAA, MRAIC, LEED AP


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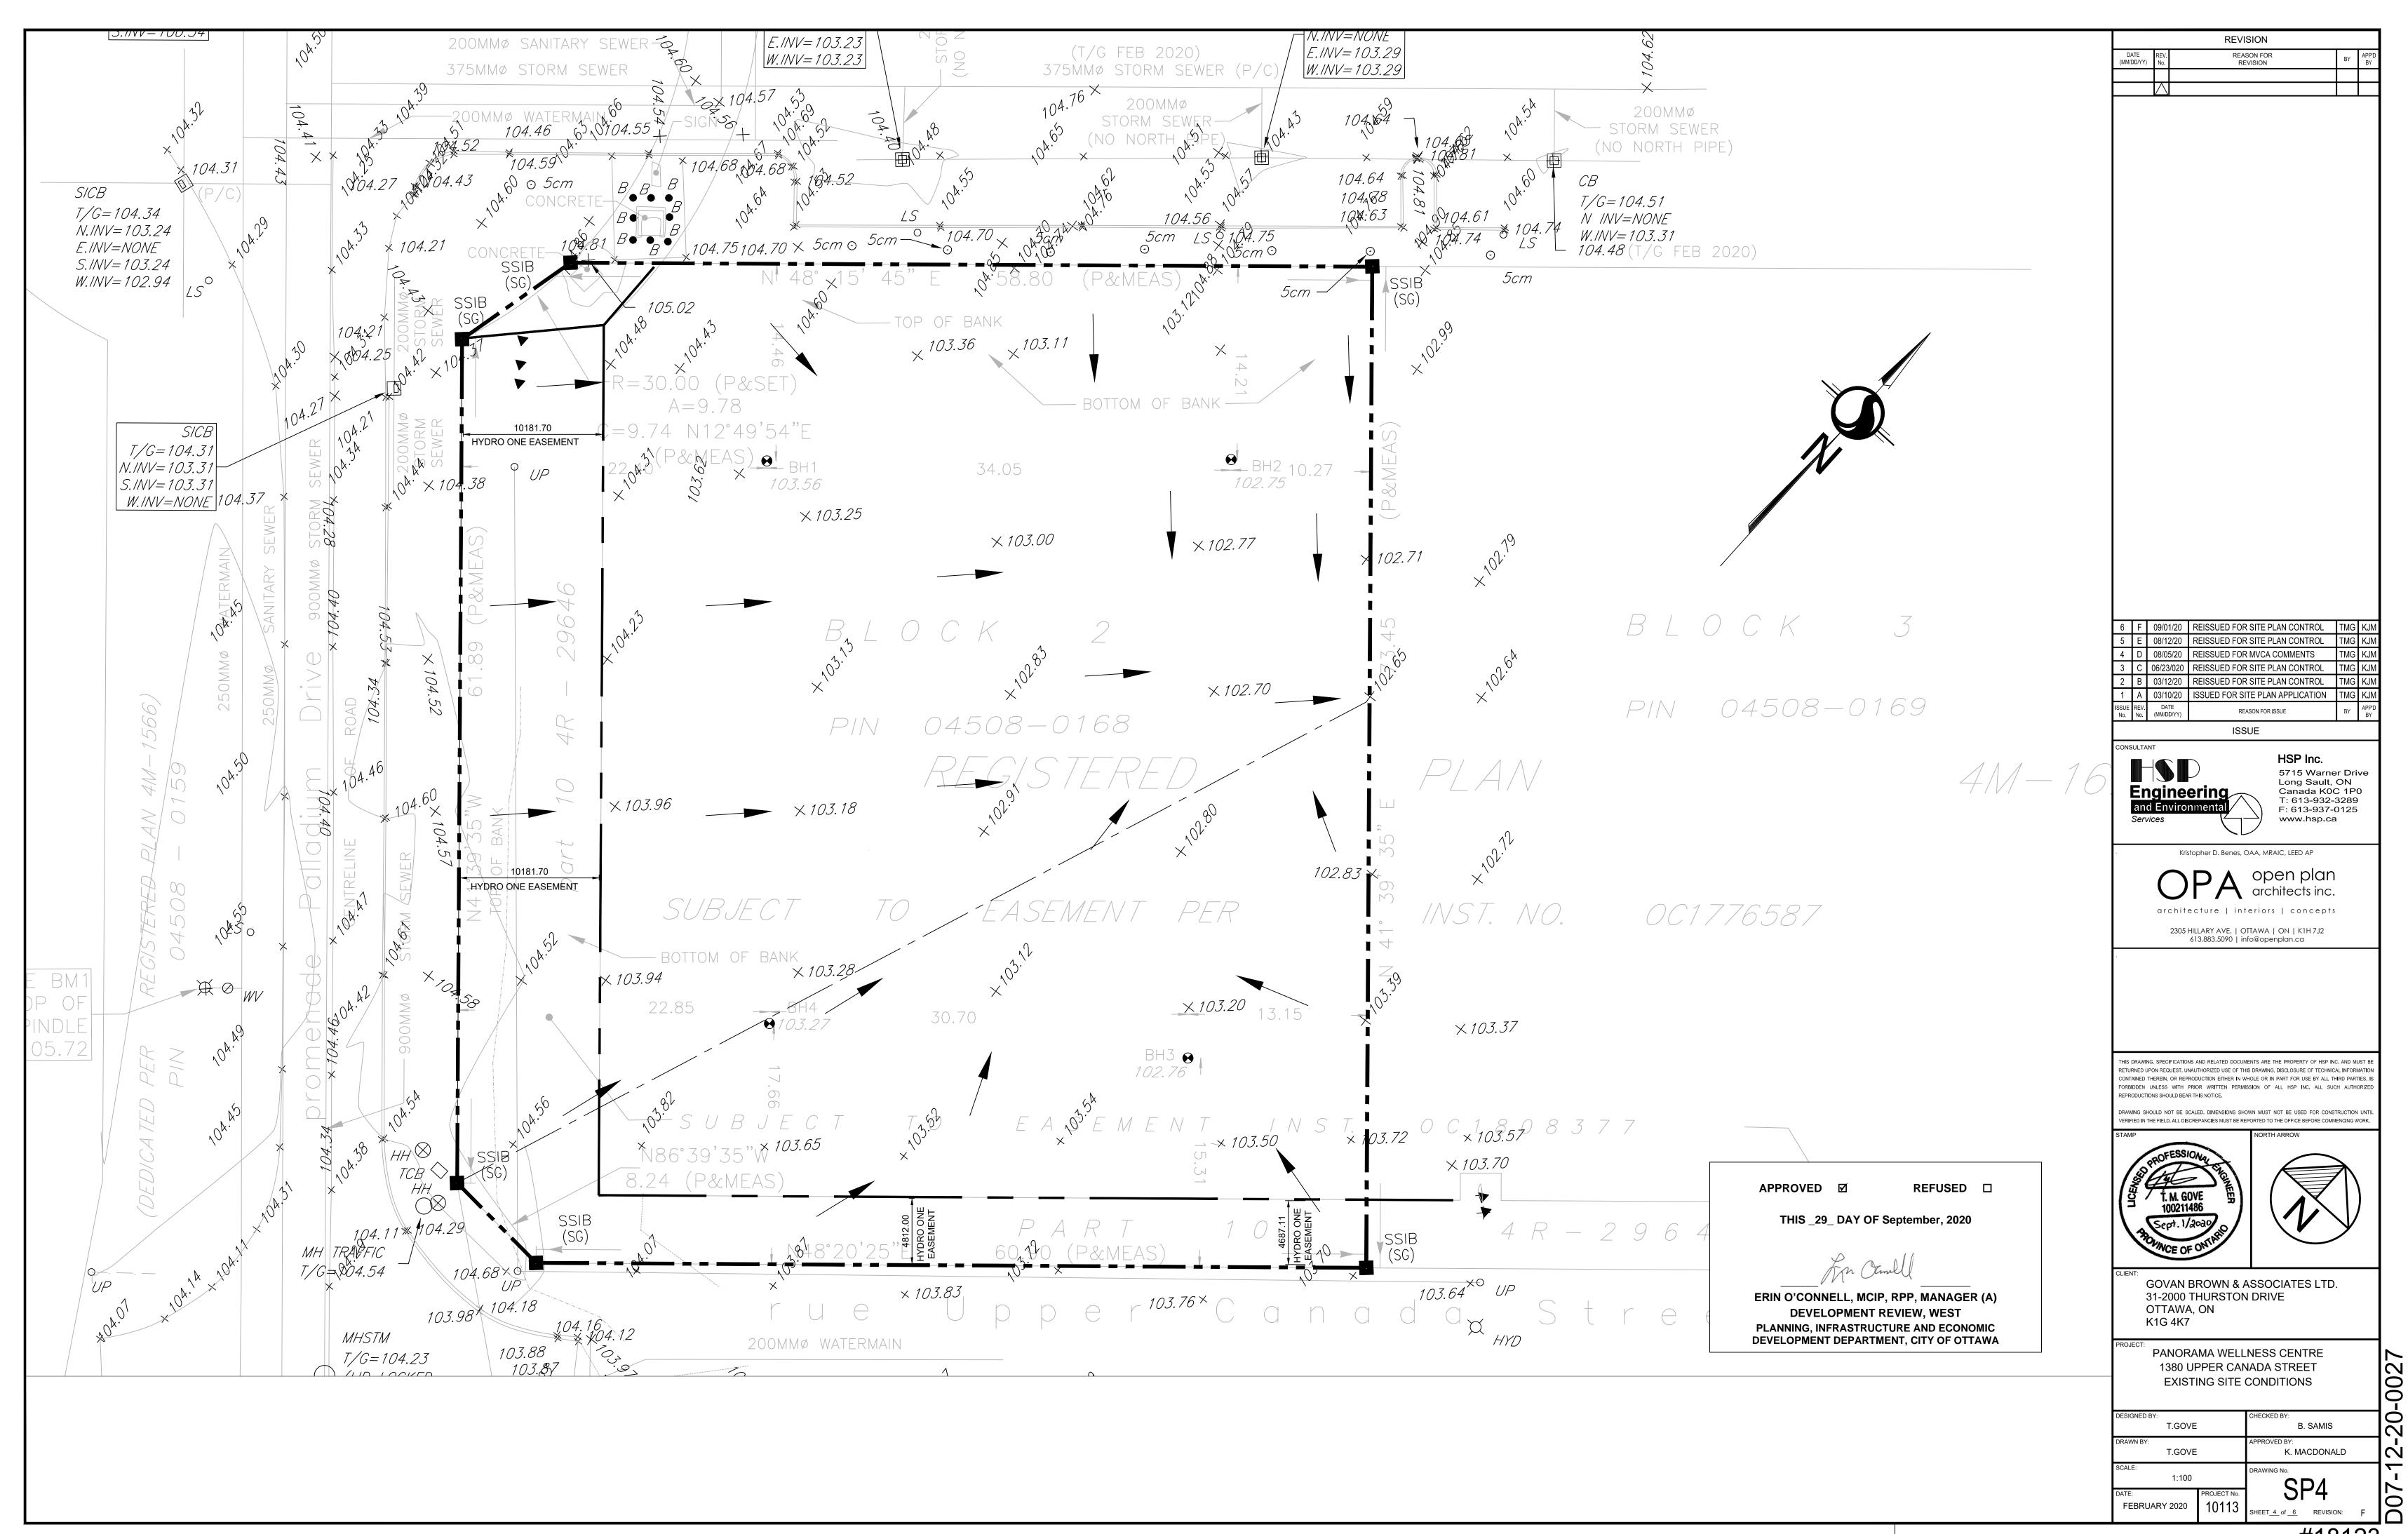
GOVAN BROWN & ASSOCIATES LTD. 31-2000 THURSTON DRIVE OTTAWA, ON K1G 4K7

PANORAMA WELLNESS CENTRE 1380 UPPER CANADA STREET EROSION AND SEDIMENT CONTROL PLAN & DRAINAGE AREAS


T.GOVE B. SAMIS T.GOVE K. MACDONALD 1:200 10113 FEBRUARY 2020


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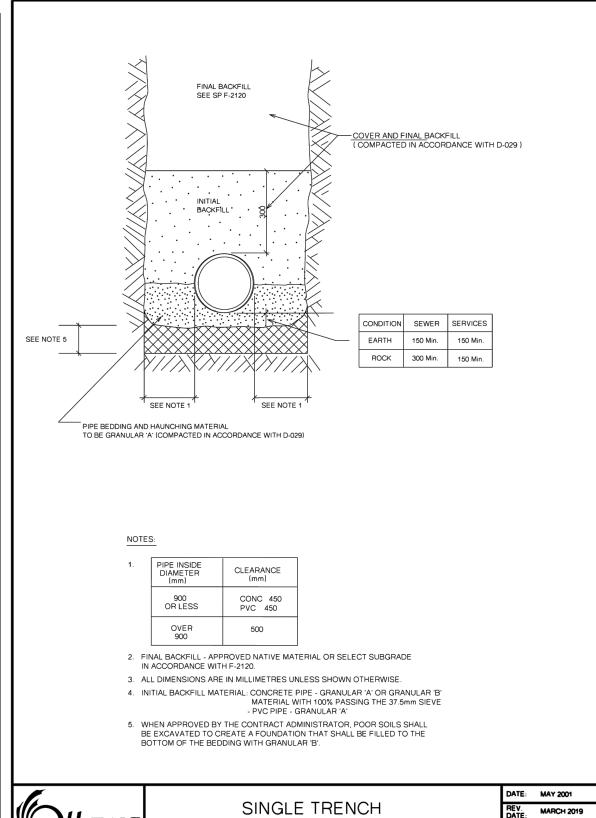
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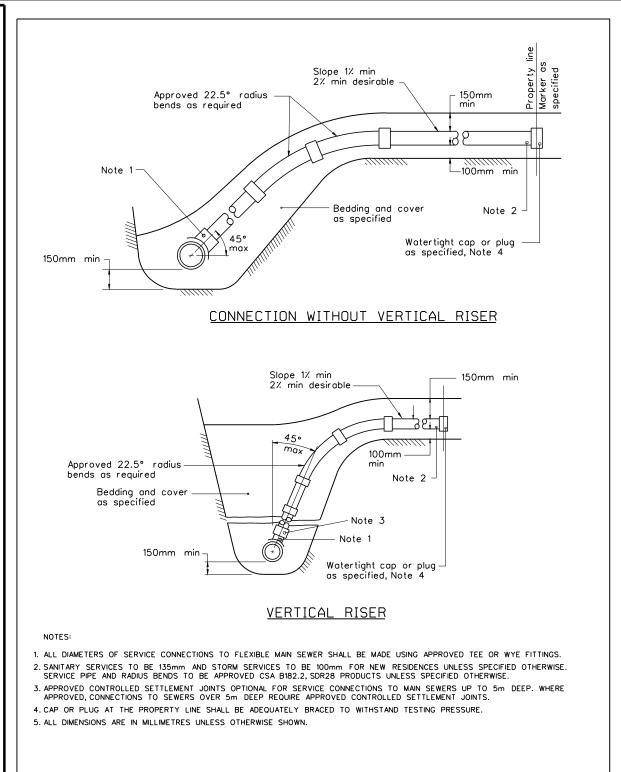
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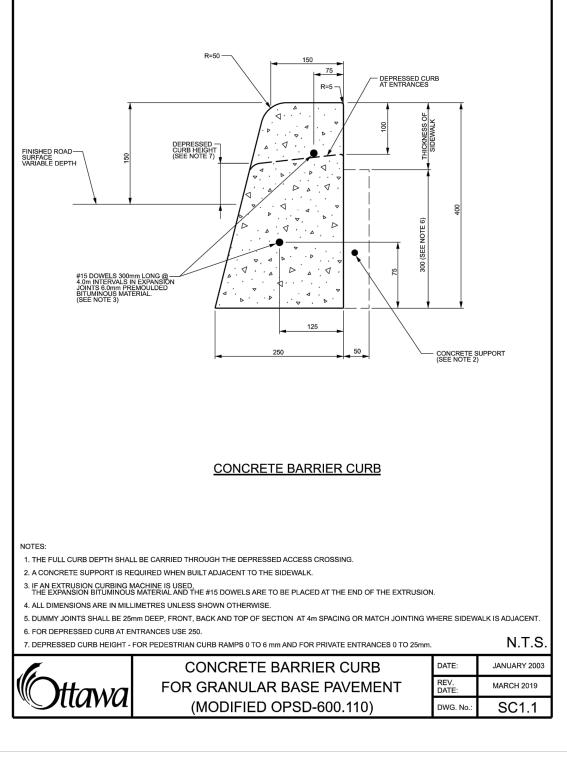



(SEWER & SEWER SERVICES)

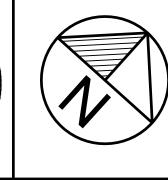



SEWER SERVICE CONNECTIONS

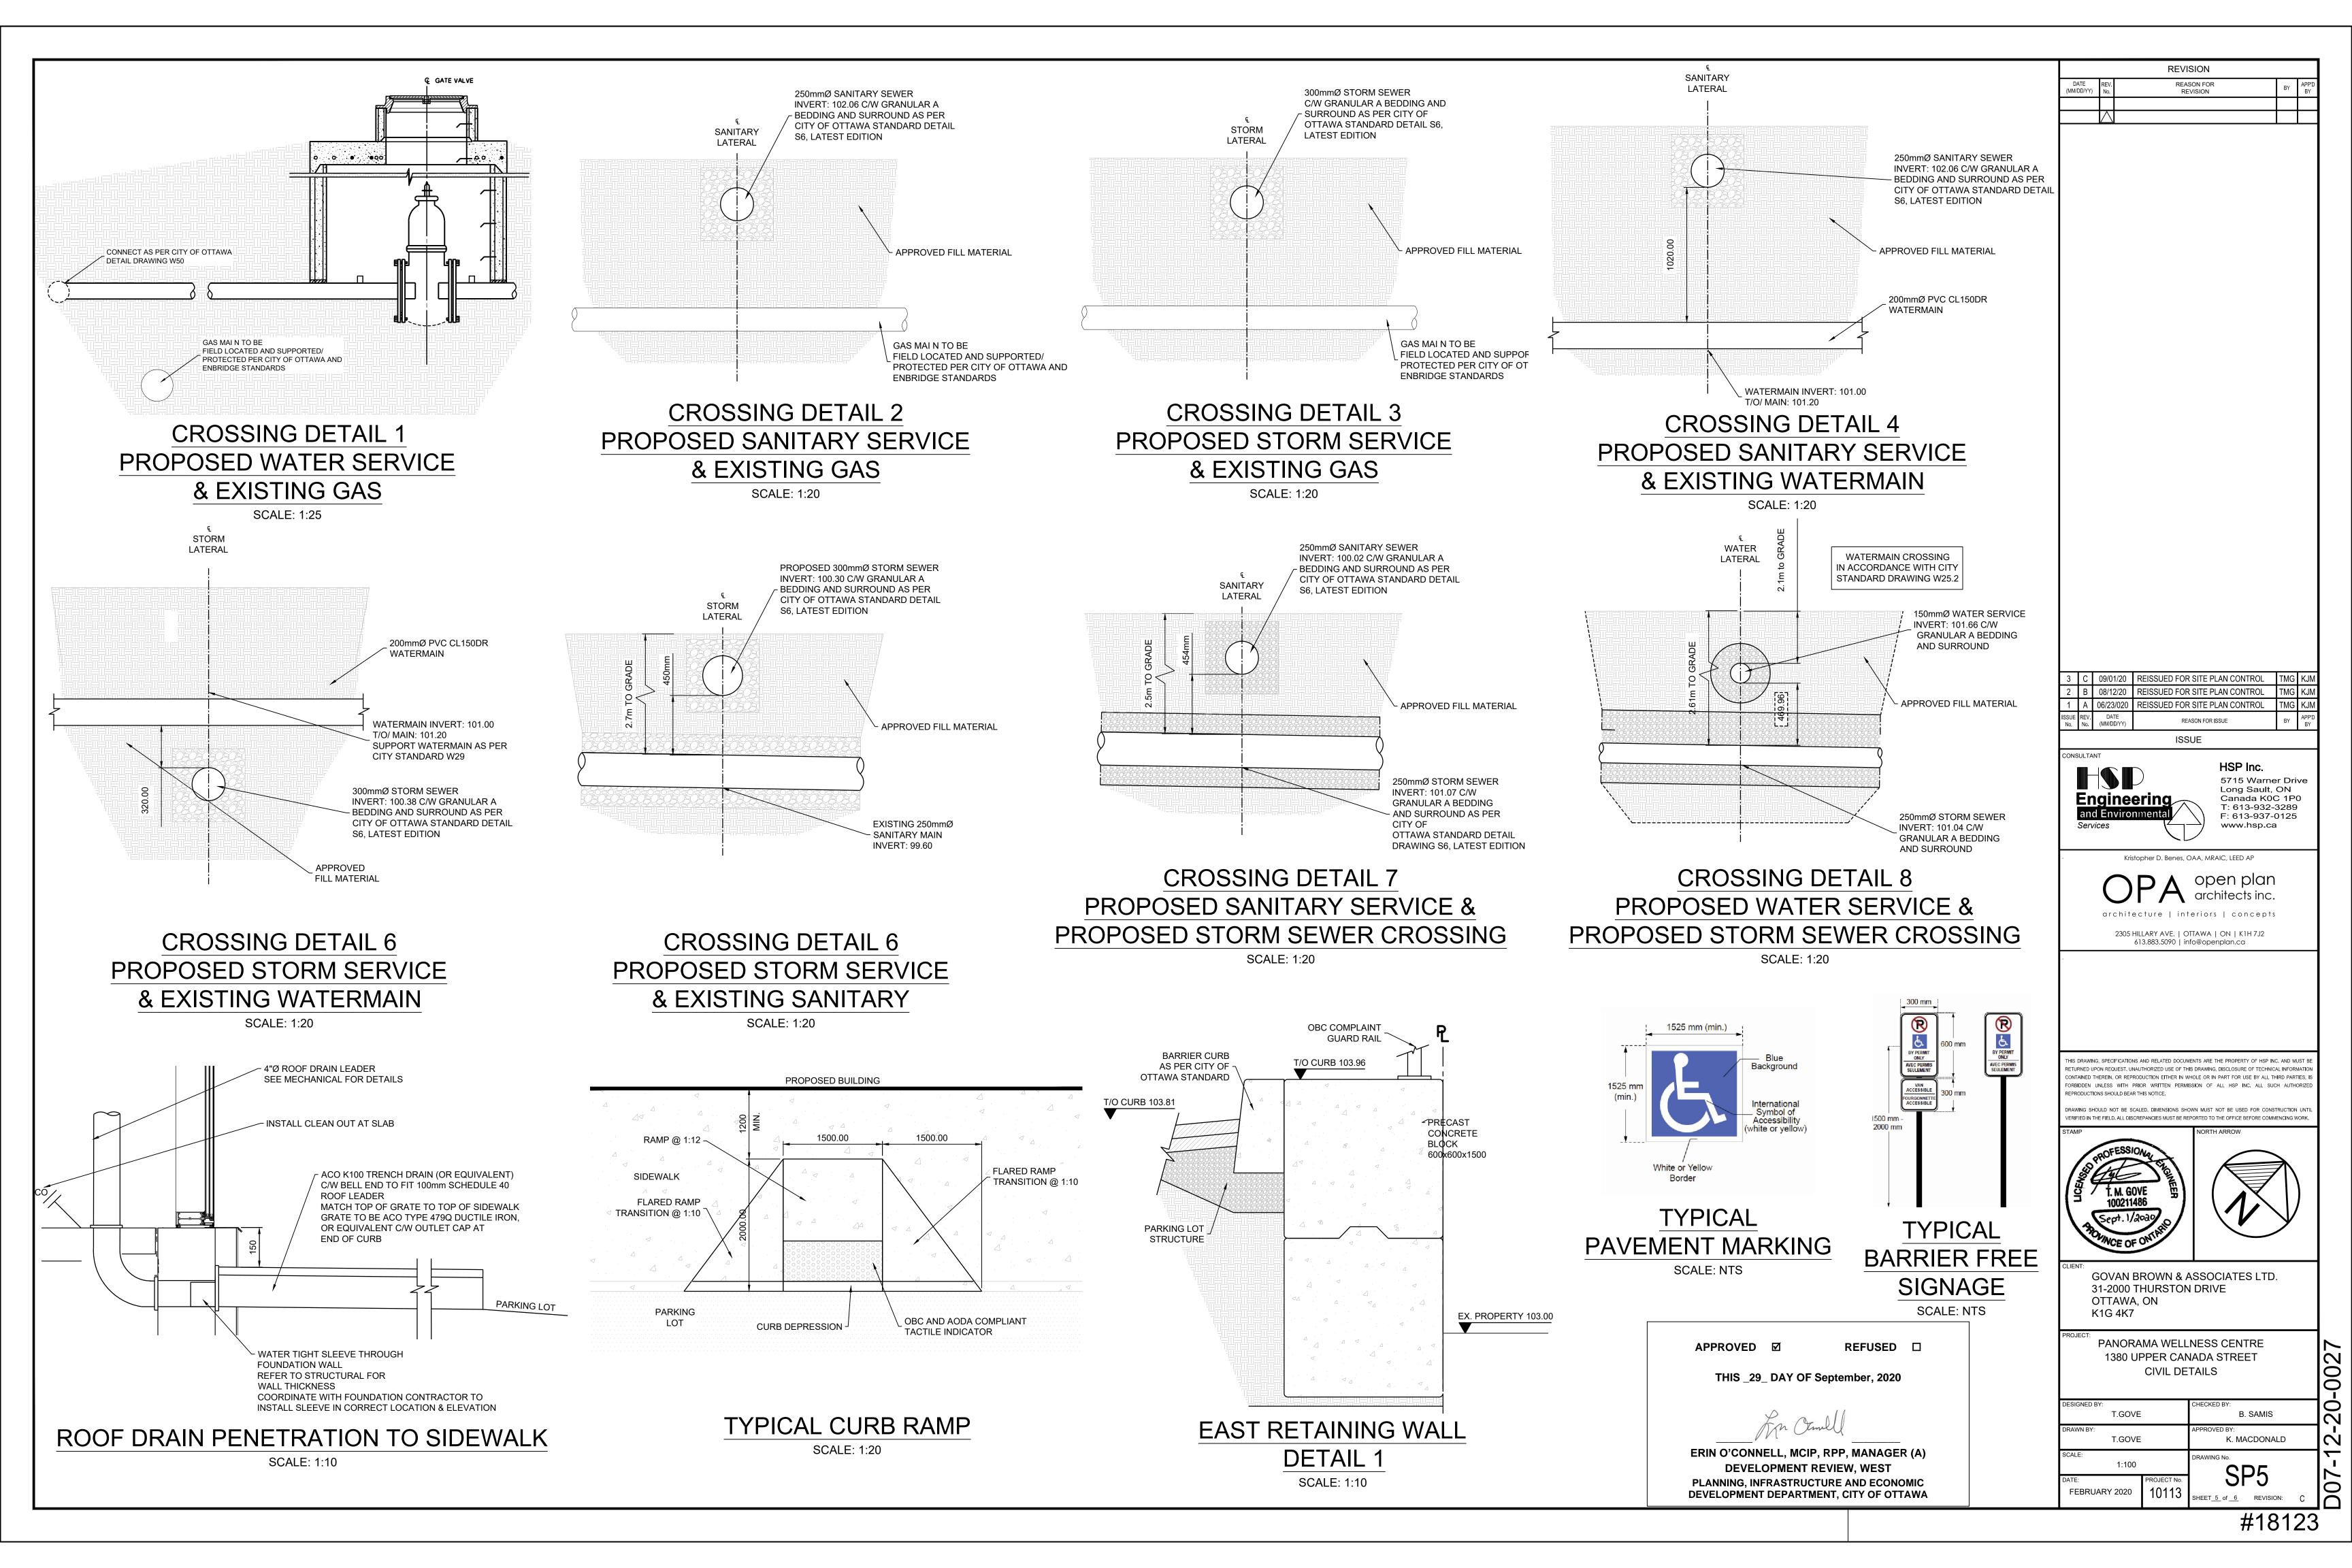
FOR FLEXIBLE MAIN SEWER PIPE

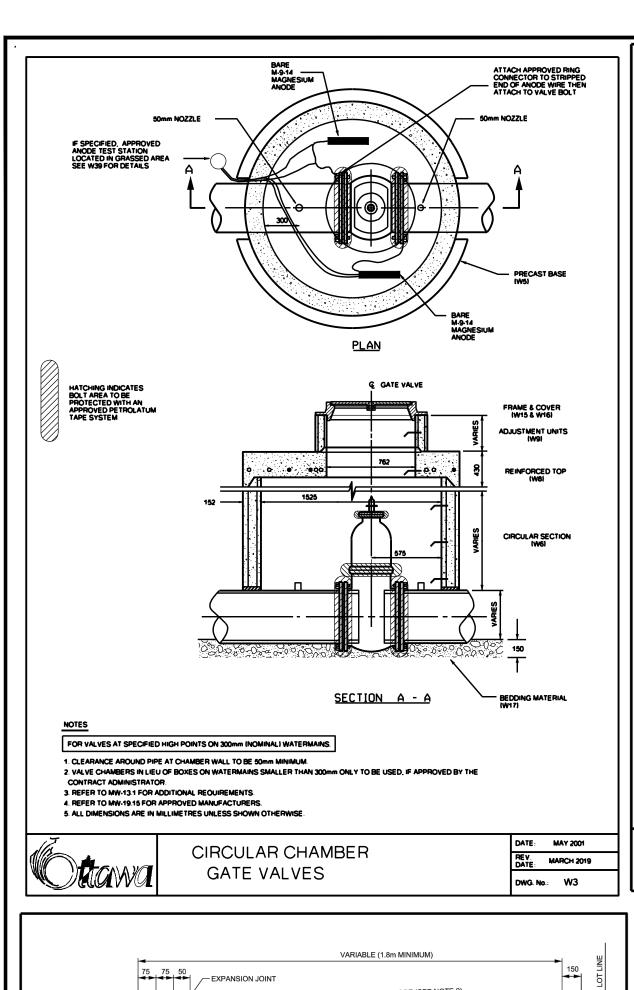


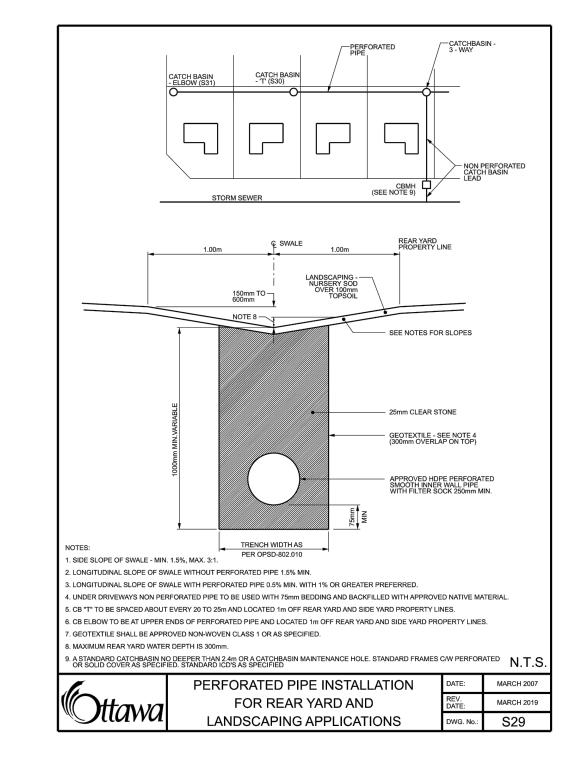


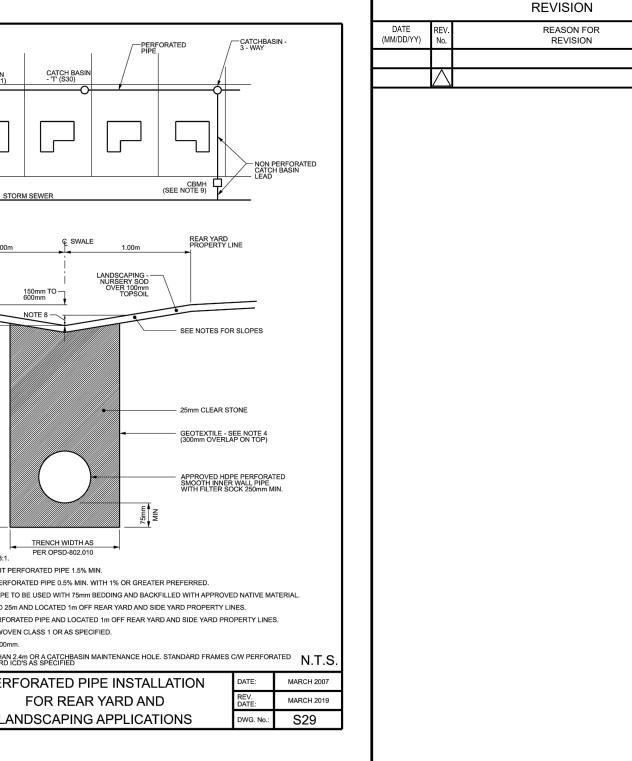

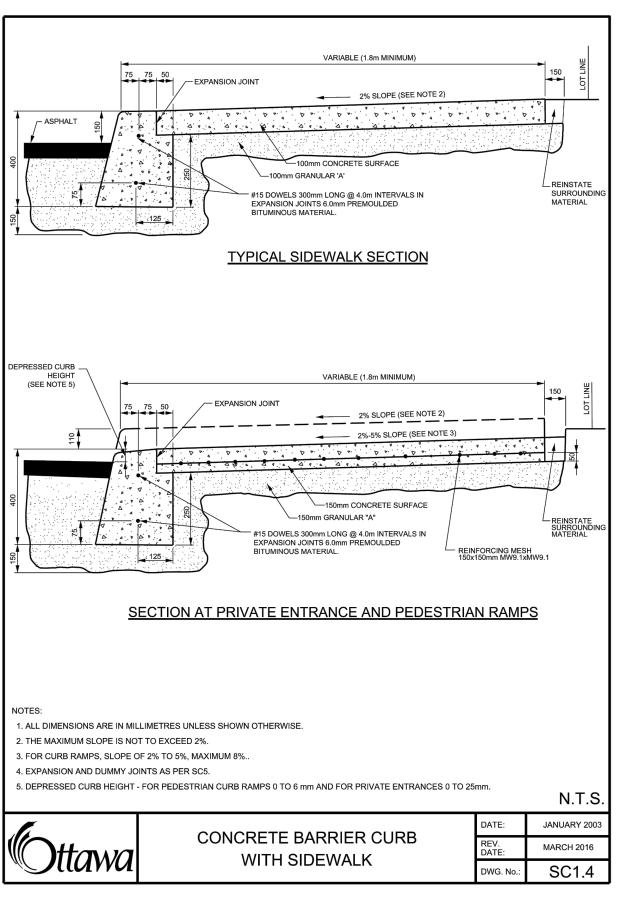


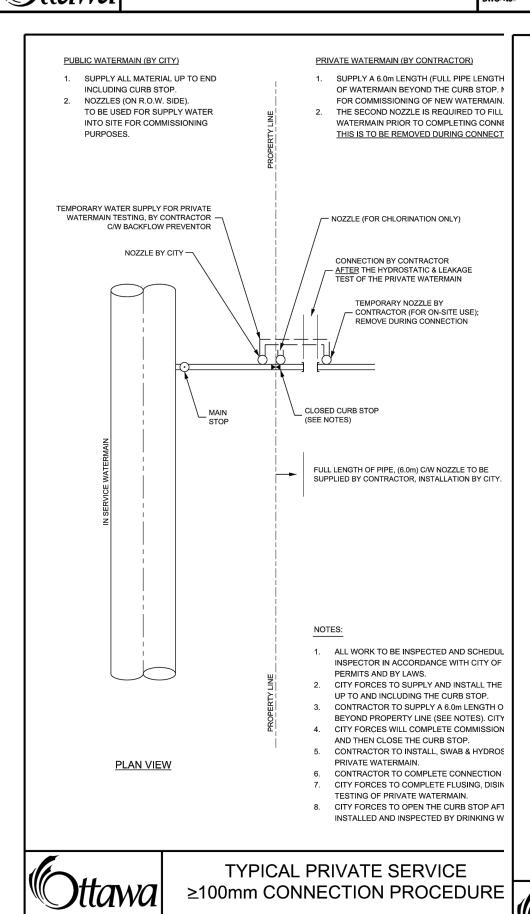

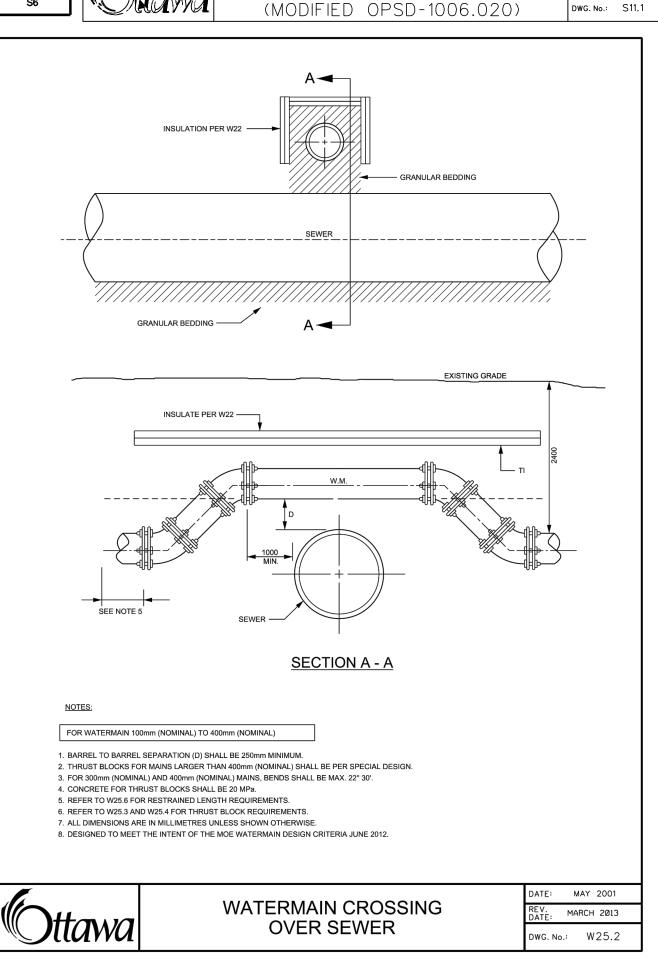

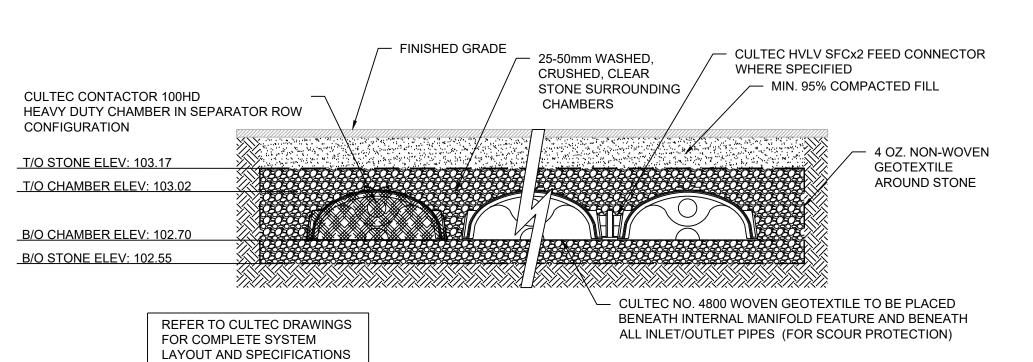

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3 C 09/01/20 REISSUED FOR SITE PLAN CONTROL TMG KJM

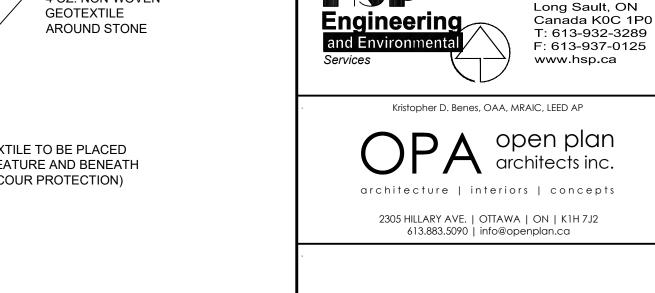ISSUE

REASON FOR ISSUE


HSP Inc.


5715 Warner Drive

2 B 08/12/20 REISSUED FOR SITE PLAN CONTROL

1 A 06/23/020 REISSUED FOR SITE PLAN CONTROL

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GOVAN BROWN & ASSOCIATES LTD. 31-2000 THURSTON DRIVE OTTAWA, ON K1G 4K7

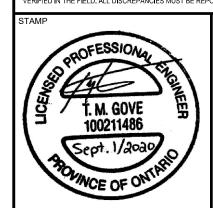PANORAMA WELLNESS CENTRE 1380 UPPER CANADA STREET CITY STANDARD DETAILS

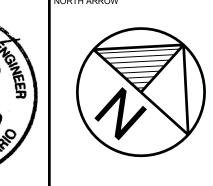DRAWN BY: APPROVED BY: K. MACDONALD	SCALE: 1:100	DRAWING No.

REFUSED □ APPROVED
☑ THIS _29_ DAY OF September, 2020 ERIN O'CONNELL, MCIP, RPP, MANAGER (A) **DEVELOPMENT REVIEW, WEST** PLANNING, INFRASTRUCTURE AND ECONOMIC **DEVELOPMENT DEPARTMENT, CITY OF OTTAWA**

-20-002