


KEY MAP




PROJECT INFORMATION

ZONING:	Arterial Mainstreet, Subzone 10 [AM10]	ZONING MECHANISMS	REQUIRED	PROVIDED
SITE LOCATION: 1420 Richmond Road, 365 Forest Street, and 2583 to 2589 Bond Street.		Arterial Mainstreet, Subzone 10 [AM10] Table 185 - AM10 Subzone:		
SITE AREA:	5433.87 m² (58489.69 ft²)	MAX. BUILDING HEIGHT (m):	30m	Tower A 12 Storey Building + Mech. Penthouse (±37.4m)
PRC	JECT STATISTICS			<u>Tower B</u>
GRADE (ZONING DEFIN	ITION): 75.60m (geo.)			12 Storey Building + Mech. Penthouse (±37.4m)
BUILDING HEIGHT (TOV	VER A): ±40.5m	MIN. FRONT YARD SETBACK (m):	0m	7.8m
BUILDING HEIGHT (TOV	VER B): ±40.5m	MIN. CORNER SIDE YARD SETBACK (m):	0m	3m
LANDSCAPE OPEN SPA PROVIDED:	ACE 1409 m ² (15166.4 ft ²)	MIN. INTERIOR SIDE YARD SETBACK (m):	N/A	1m
AMENITY SPACE PROV		MIN. REAR YARD SETBACK (m):	3m	1m DEROGATORY
	(12626 ft²)	MIN. DISTANCE BETWEEN TOWERS:	15m	15m
ROOF TERRACE SPACE (TOWER A):	= 100 m² (1076.39 ft²)	MIN. WIDTH OF DRIVING AISLES:	6m	7.5m
(TOWER B):	73 m ² (785.77 ft ²)			
GROSS BUILDING - AREAS - (TOWER A) (CITY OF OTTAWA ZONING DEFINITION)		GROSS BUILDING - AREAS - (TOWER B) (CITY OF OTTAWA ZONING DEFINITION)		
PARKING LEVEL (P1 - P	P4): 0 m ² (0 ft ²)			
GROUND FLOOR:	1217 m² (13099.68 ft²)	GROUND FLOOR:		1467 m² (15790.66 ft²)
2nd FLOOR:	1217 m² (13099.68 ft²)	2nd FLOOR:		1497 m² (16113.57 ft²)
3rd - 6th FLOOR:	(1246m² x 4) 4984 m² (53647.33 ft²)	3rd - 6th FLOOR:	(1629 x 4) 6516 m² (70137.64 ft²)
7th FLOOR:	1146 m² (12335.44 ft²)	7th FLOOR:		1465 m² (15769.13 ft²)
8th - 11th FLOOR:	(1188m² x 4) 4752 m² (51150.01 ft²)	8th - 11th FLOOR:	(1513 x 4) 6052 m² (65143.19 ft²)

	(0110010111)		
12th FLOOR:	1045 m² (11248.29 ft²)	12th FLOOR:	1388 m² (14940.31 ft²)
MECHANICAL & PENTHOUSE:	219 m² (2357.30 ft²)	MECHANICAL & PENTHOUSE:	271 m² (2917 ft²)
TOTAL BUILDING AREA:	14580 m² (156,937.81 ft²)	TOTAL BUILDING AREA:	18656 m² (200,811.51 ft²)
UNIT STATISTICS			cs
1 BRD:	13	1 BRD:	12
1 BRD + DEN:	102	1 BRD + DEN:	145
2 BRD:	42	2 BRD:	43
BACHELOR:	11	BACHELOR:	23
TOTAL:	168	TOTAL:	223
CAR PARKING		BICYCLE PARKI	NG
REQUIRED:	0 / UNIT	REQUIRED:	50% OF TOTAL UNITS
PROVIDED:	442	TOWER A:	84 MIN. EXTERIOR: 42
VISITORS:	30 MAX.		INTERIOR: 42
		TOWER B:	112 MIN. EXTERIOR: 56 INTERIOR: 56

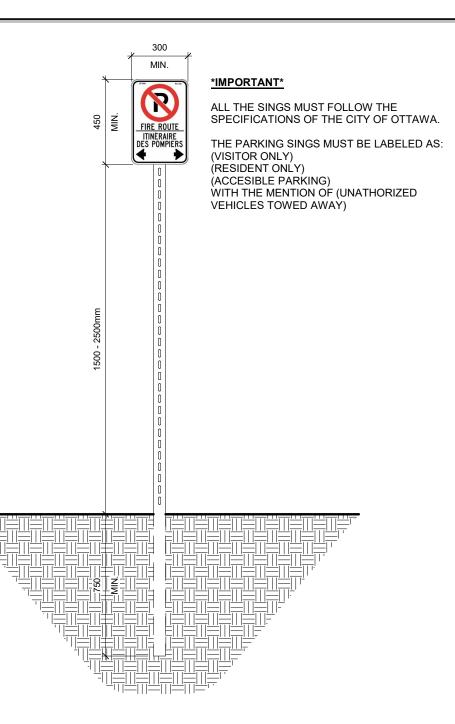

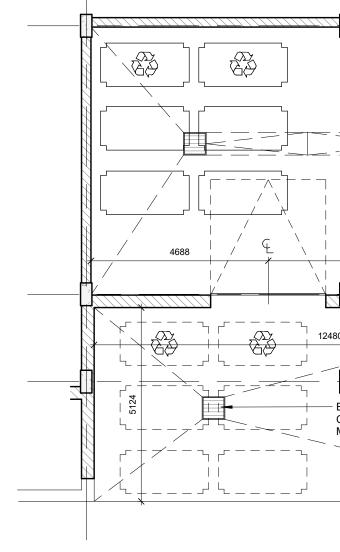

FIRE ROUTE SING ÉCHELLE: 1:20


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A002


DÉTAIL

A002

ÉCHELLE: 1 : 100

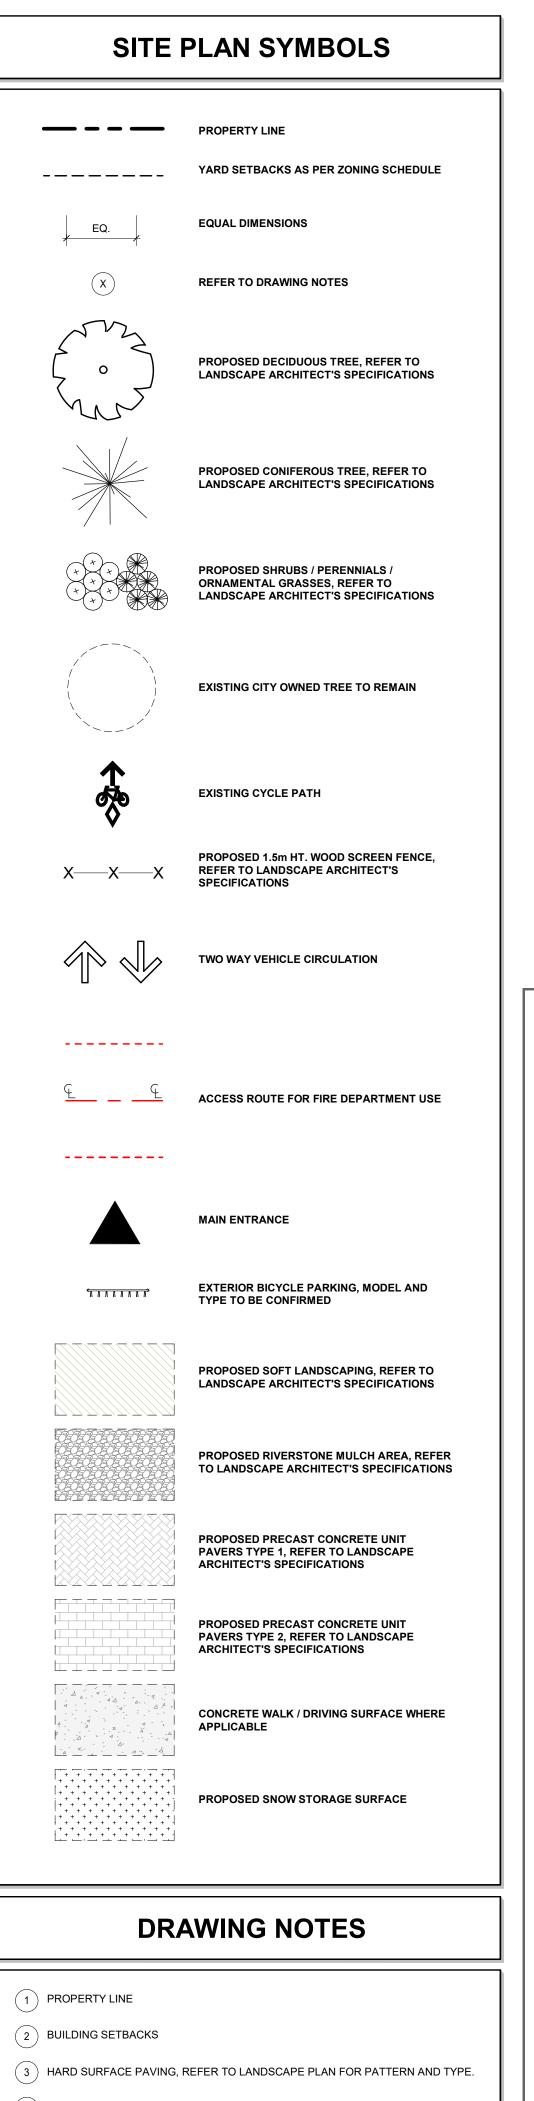

- (4) OUTLINE OF UNDERGROUND PARKING LEVELS.
- (5) SOFT LANDSCAPING, REFER TO LANDSCAPE PLAN.
- 6 OUTLINE OF TOWER ABOVE.
- (7) CONCRETE WALK, WIDTH AS SHOWN.
- 8 SITE FURNITURE (AS PER LANDSCAPE PLAN).
- (9) VEHICLE ENTRANCE RAMP TO UNDERGROUND GARAGE.
- (10) EXTERIOR BICYCLE RACKS, REFER TO LANDSCAPE PLANS.
- 11) OUTLINE OF BALCONIES ABOVE.
- (12) DEPRESSED CURB AS PER CITY STANDARDS, REFER TO CIVIL ENGINEER.
- (13) TACTILE WALKING SURFACE INDICATOR.
- (14) FIRE ROUTE SING AS PER CITY STANDARDS.

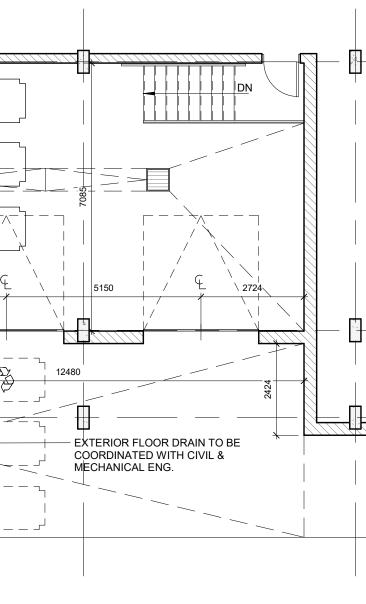







PU	PMA ARCHITECTES

A002

GROUP HEAFEY		
365 Forest Street, Ottawa, ON K2B 7Z7		
TENDER NO. :	CLIENT PROJECT NO. : Groupe Heafey	
DRAWING :		
SITE PLAN		

AWN BY : Indrew Buchillon	DATE : 05/28/2021
PROVED BY : Christian Rheault	PROJECT NO. :
SIGNED BY : Christian Rheault	1887-2303-19