



# SOUTH NEPEAN TOWN CENTRE BLOCK 4

3288 GREENBANK ROAD






# **LIST OF DRAWINGS:**

L-01 - LANDSCAPE PLAN L-02 - LANDSCAPE PLAN


-01 - DETAILS

D-02 - ROW & SOIL VOLUME



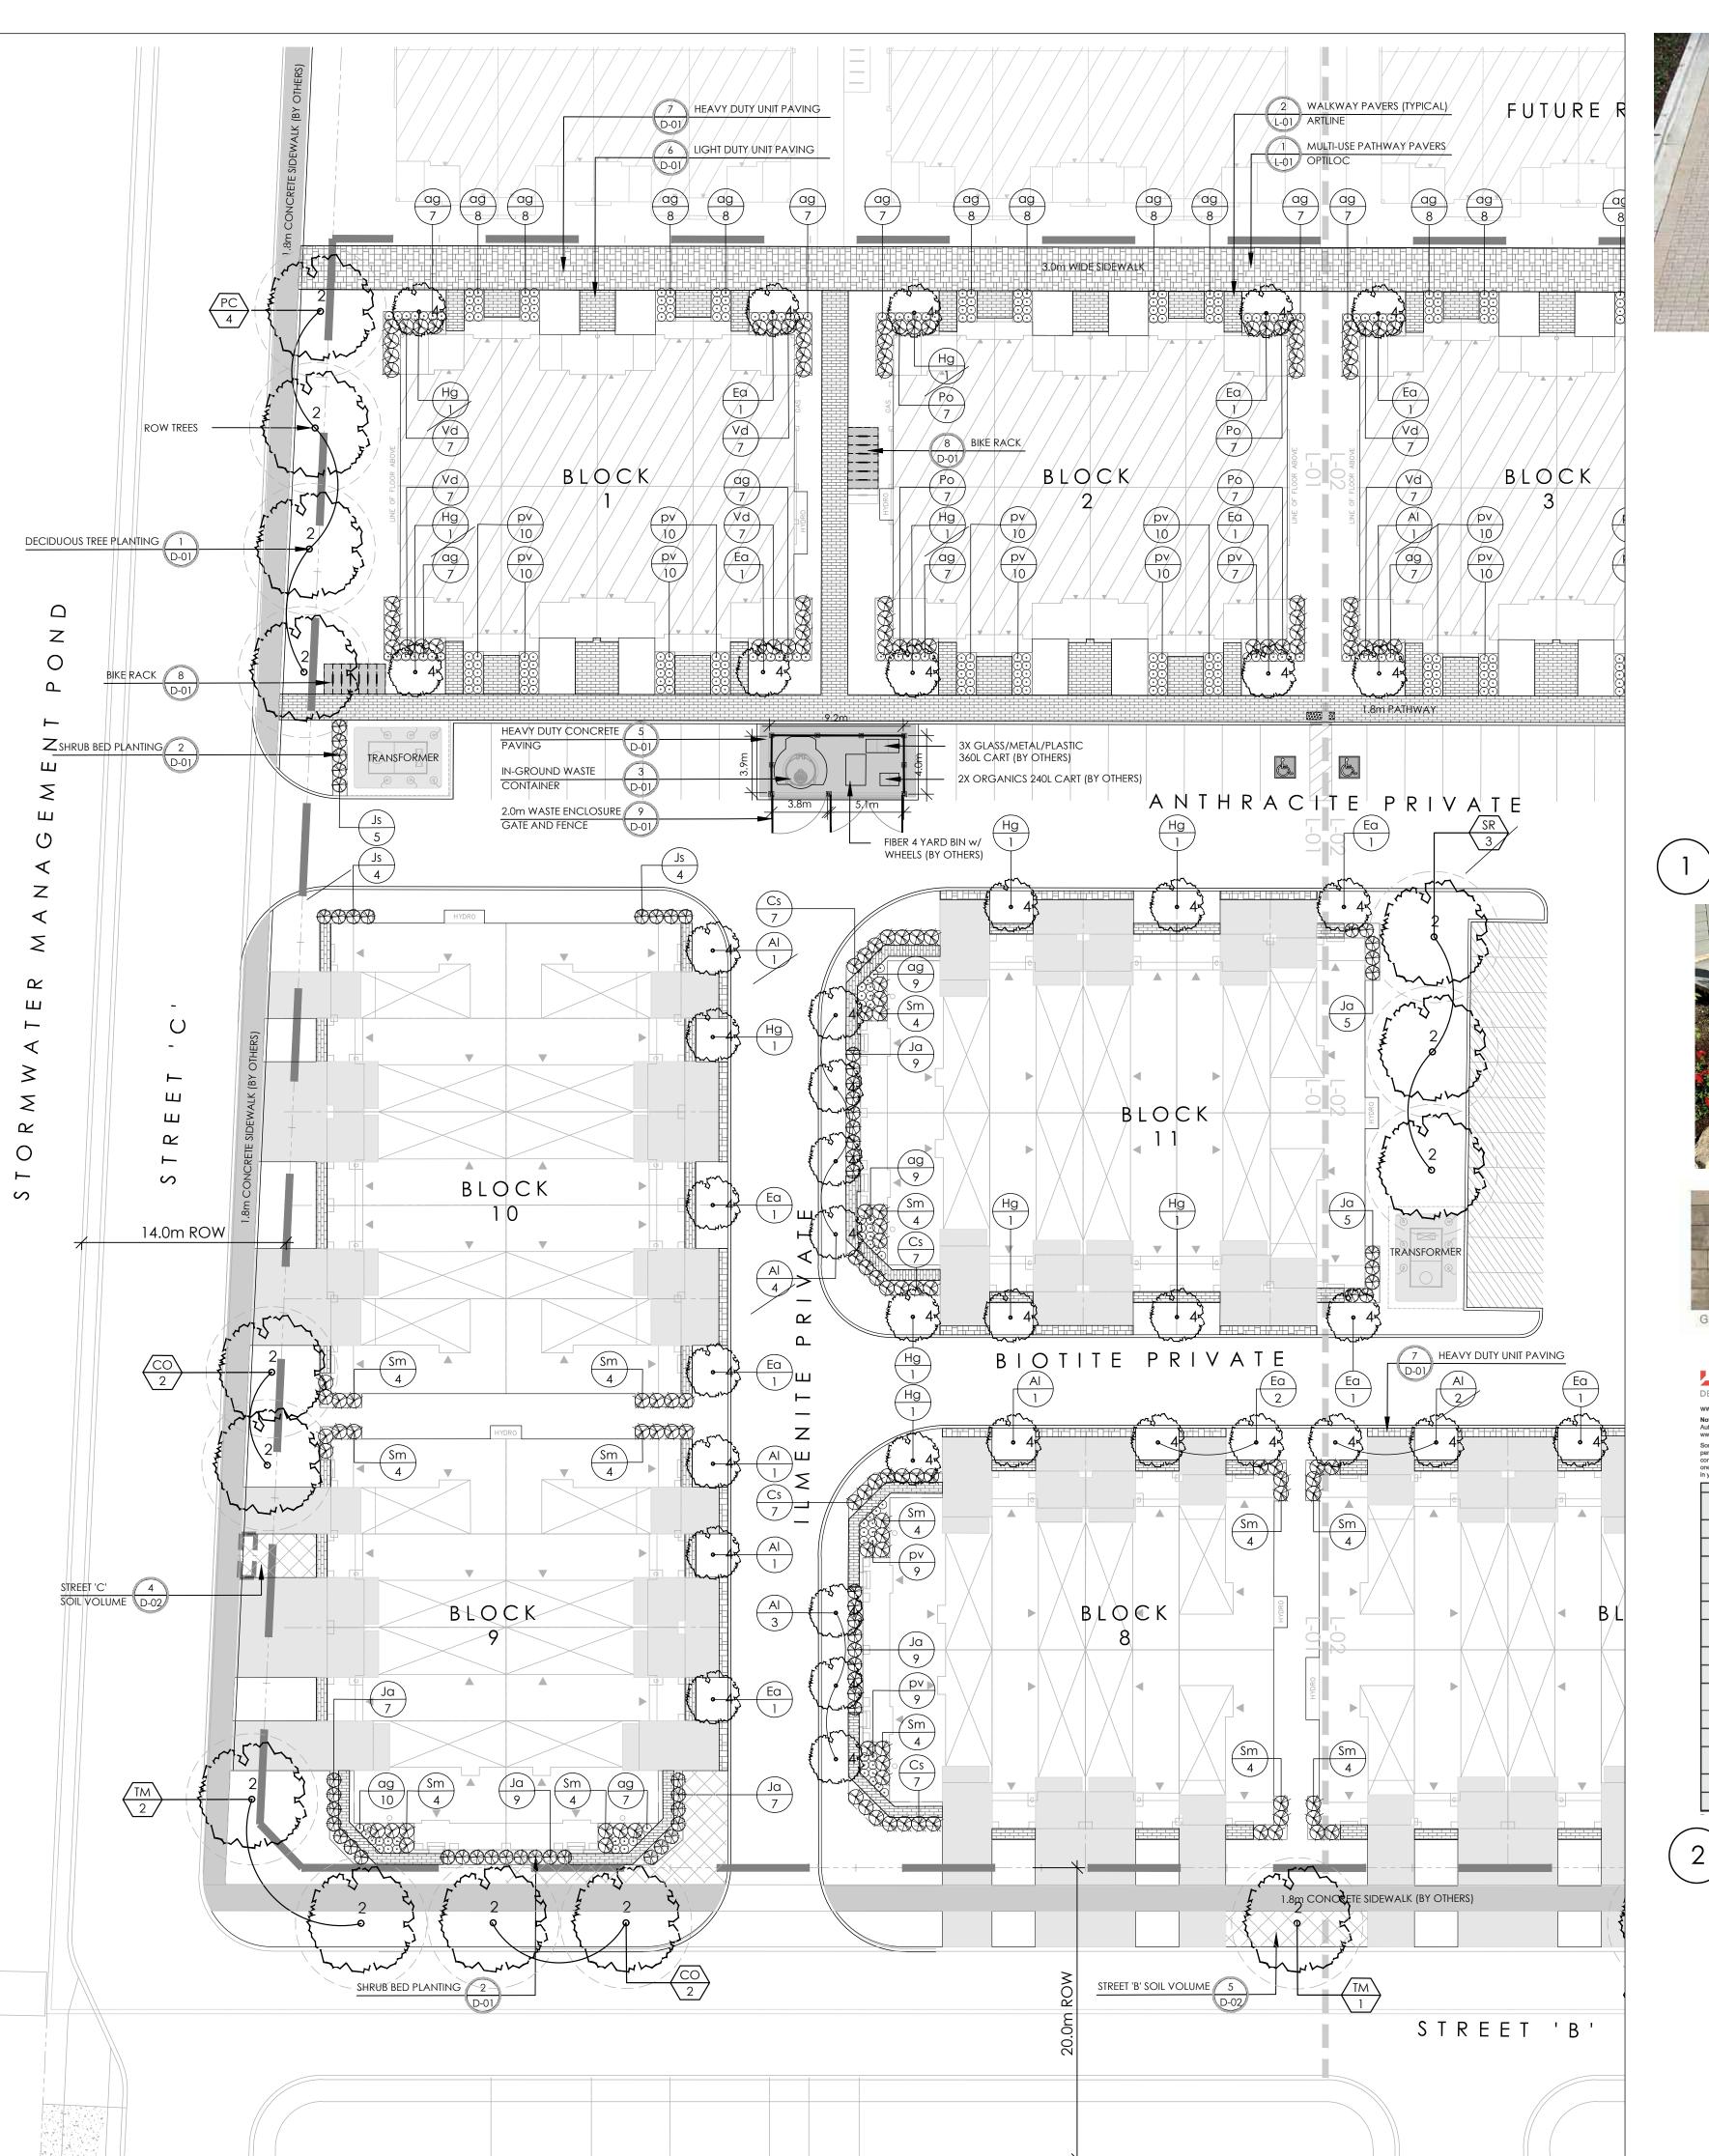



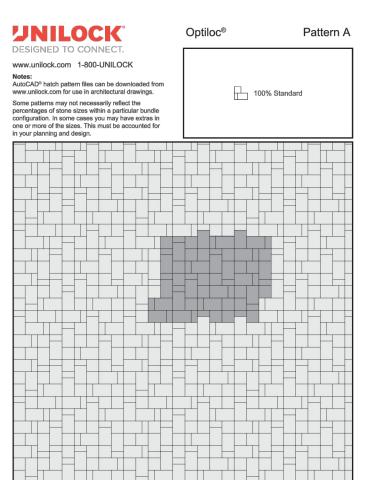


MULTI-USE PATHWAY PAVERS - OPTILOC







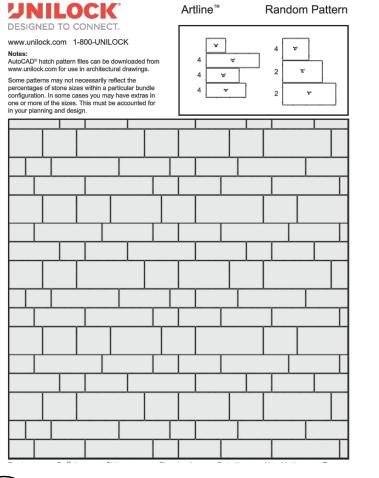

TYPICAL WALKWAY PAVERS - ARTLINE

- ACER RUBRUM AND CELTIS OCCIDENTALIS TO BE SPRING DUG SPECIMENS AND PLANTED IN THE SPRING ONLY.
- THIS PLAN MUST BE READ IN CONJUNCTION WITH THE APPROVED CUP AND CITY CROSS SECTIONS. 3. CONTRACTOR SHALL ENSURE THAT ALL UTILITY LOCATIONS ARE OBTAINED PRIOR TO ANY EXCAVATION FOR
- LANDSCAPING.
- 4. LOCATION OF ALL PLANT MATERIALS TO BE STAKED BY THE CONTRACTOR AND VERIFIED IN THE FIELD BY LANDSCAPE ARCHITECT & CITY OF OTTAWA PRIOR TO THE EXCAVATION OF PITS.

2. THE LOCATION OF THE TREES SHOWN ON THIS PLAN IS APPROXIMATE AND SHALL NOT BE SCALED FROM THIS DRAWING.

- 5. ALL PLANT MATERIAL SHALL BE NURSERY GROWN STOCK UNLESS OTHERWISE NOTED.
- 6. TREES TO HAVE A MINIMUM 1800 CLEAR STEM ABOVE GRADE.
- 7. PLACE SOD ON A MINIMUM 150mm TOPSOIL.
- 8. CONTRACTOR TO MAKE GOOD ALL EXISTING AREAS DAMAGED BY HIS WORK TO THE SATISFACTION OF THE CITY OF
- 9. THE CITY WILL BE NOTIFIED IF ANY TREES CANNOT BE LOCATED OR PLANTED DUE TO CONFLICTS WITH UTILITIES OR DRIVEWAYS. THE REQUIRED TREES NOT PLANTED ARE SUBJECT TO TREE BANKING. THE FINAL NUMBER OF TREES TO BE BANKED WILL BE PROVIDED TO THE CITY FOLLOWING ALL PLANTINGS (REFERS TO ROW TREES ONLY).
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  - 3.0m HYDRO TRANSFORMER 1.5m - PATH, DRIVEWAY, FENCE, SOUND WALL
  - 4.5m CONIFERS MINIMUM SETBACK FROM CURB
  - 2.5m FIRE HYDRANTS 1.5m - WATER SERVICE / CURB STOP
  - 1.0m BELL / CABLE PEDESTALS

# TREE PLANTING IN MARINE CLAY SOILS

- 1. THIS LANDSCAPE PLAN CONFORMS WITH THE TREE-TO-FOUNDATION SETBACK, SOIL VOLUME, AND SURFACE-GRADING REQUIREMENTS OUTLINED IN THE CITY OF OTTAWA'S GUIDELINES FOR TREE PLANTING IN SENSITIVE MARINE CLAY SOILS (2017), BASED ON THE FINDINGS OUTLINED IN THE PROJECT GEOTECHNICAL REPORT.
- 2. ADDITIONAL REQUIREMENTS OUTLINED IN THE CITY OF OTTAWA'S GUIDELINES FOR TREE PLANTING IN SENSITIVE MARINE CLAY SOILS (2017), INCLUDING USF DEPTH, FOUNDATION WALL REINFORCEMENT, AND SUBDIVISION GRADING, SHOULD BE CONFIRMED BY THE PROJECT ENGINEER(S).
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- 4. <u>CITY OF OTTAWA: GUIDELINES FOR TREE PLANTING IN SENSITIVE MARINE CLAY SOILS (2017):</u> THE FOLLOWING GUIDELINES ARE PRIMARILY FOCUSED ON SMALL AND MEDIUM SIZE STREET TREES. HOWEVER, LARGE TREES (MATURE HEIGHT OVER 14M) CAN STILL BE PLANTED IN AREAS OF SMC SOILS PROVIDED A TREE TO FOUNDATION SETBACK EQUAL TO THE FULL MATURE HEIGHT OF THE TREE CAN BE PROVIDED (E.G. IN A PARK OR OTHER GREEN SPACE). FOR STREET TREES IN THE ROAD RIGHT-OF-WAY WHERE SMC SOILS HAVE BEEN IDENTIFIED, THE TREE TO FOUNDATION SETBACKS MAY BE REDUCED TO 4.5M FOR SMALL (MATURE TREE HEIGHT UP TO 7.5M) AND MEDIUM SIZE TREES (MATURE TREE HEIGHT 7.5M-14M) PROVIDED ALL OF THE FOLLOWING SIX CONDITIONS ARE MET:
- 1. THE MODIFIED PLASTICITY INDEX OF THE SOIL BETWEEN THE UNDERSIDE OF FOOTING (USF) AND A DEPTH OF 3.5M GENERALLY DOES NOT EXCEED 40%. THIS CORRESPONDS TO SOILS WITH LOW/MEDIUM POTENTIAL FOR SOIL VOLUME CHANGE. CLAY SOILS THAT EXCEED THE 40% PLASTICITY INDEX ARE CONSIDERED TO HAVE HIGH POTENTIAL FOR SOIL VOLUME CHANGE. FOR THESE WORST-CASE SOILS, THE SETBACKS AND TREE PLANTING RESTRICTIONS REMAIN UNCHANGED FROM THE 2005 CLAY SOILS POLICY (TREE SETBACK MUST EQUAL THE MATURE HEIGHT OF THE TREE - I.E. 7.5M SETBACK FOR SMALL TREES).
- 2. THE USF IS 2.1M OR GREATER BELOW THE LOWEST FINISHED GRADE. NOTE: THIS FOOTING LEVEL MUST BE SATISFIED FOR FOOTINGS WITHIN 10M OF THE TREE, AS MEASURED FROM THE CENTRE OF THE TREE TRUNK, AND VERIFIED BY MEANS OF THE GRADING PLAN AS INDICATED IN THE PROCEDURAL CHANGES BELOW.
- 3. A SMALL SIZE TREE MUST BE PROVIDED WITH A MINIMUM OF 25M3 OF AVAILABLE SOIL VOLUME, AS DETERMINED BY A LANDSCAPE ARCHITECT. A MEDIUM SIZE TREE MUST BE PROVIDED WITH A MINIMUM OF 30M3 OF AVAILABLE SOIL VOLUME, AS DETERMINED BY A LANDSCAPE ARCHITECT. THE DEVELOPER WILL ENSURE THE SOIL IS GENERALLY UNCOMPACTED WHEN BACKFILLING IN STREET TREE
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SCHIZACHYRIUM SCOPARIUM

KEY	QTY.	BOTANICAL NAME	COMMON NAME	CAL/HT.	ROOT	_	
MEDII		DUOUS TREES (10.15m)		(mm)			
CO	11	DUOUS TREES (10-15m)  CELTIS OCCIDENTALIS	HACKBERRY	70	B&B		
PC	9	PYRUS CALLERYANA	ORNAMENTAL PEAR	70 70	B&B		
SR	7	SYRINGA RETICULATA	JAPANESE LILAC	70	B&B		
TM	6 32	TILIA MONGOLICA	MONGOLIAN LINDEN	70	B&B		
PLA	.NT LIS	T B - BLOCK 4 PLANTING					
KEY	QTY.	BOTANICAL NAME	COMMON NAME	CAL/HT.	ROOT	SPREAD(	m) HEIGHT(m
	-			(mm)	-		
		DUOUS TREES (10-15m)	LABANIESE III A O	70	D 0 D		
SR	4	SYRINGA RETICULATA	JAPANESE LILAC	70	B&B		
LARG	E DECIDU	JOUS TREES					
AR	2	ACER RUBRUM	RED MAPLE	70	B&B		
TDEE :	FOD: 4 0: :	DUDG					
<u>TREE I</u> Al	FORM SH 18	RUBS AMELANCHIER LAEVIS	ALLEGHENY SERVICEBERRY	40	B&B	6	6
Ea	18	EUONYMUS ALATUS	BURNING BUSH		TOPGRAFT		10
Hg	<u>20</u>	HYDRANGEA PANICULATA 'GRANDIFLORA'	PEE GEE HYDRANGEA	40	B&B	5	8
0	56						
DECI	DUOUS SH	2ALIGH					
Cs	66	CORNUS SERICEA 'FARROW'	ARCTIC FIRE DOGWOOD		3 GAL.		
Ро	49	PHYSOCARPUS OPULIFOLIUS	COMMON NINEBARK		3 GAL.		
Sm	56	SYRINGA MEYERI 'PALIBIN'	DWARF KOREAN LILAC		3 GAL.		
Vd	<u>63</u>	VIBURNUM DENTATUM	ARROWWOOD		3 GAL.		
	234						
CONI	IFEROUS S	SHRUBS					
Ja	60	JUNIPERUS SABINA	Sabina juniper		3 GAL.		
Js	<u>42</u> 102	JUNIPERUS SCOPULORUM 'SKYROCKET'	SKYROCKET JUNIPER	200cm	WB.		
	102						
GRAS	SSES						
ag	384	ANDROPOGON GERARDII	BIG BLUE STEM		1 GAL.		
pν	<u>261</u>	PANICUM VIRGATUM	SWITCH GRASS		1 GAL.		
	645						
РΙΔ	יצון דוא	T C - AMENITY AREA PLANTING					
KEY	QTY.	BOTANICAL NAME	COMMON NAME	CAL	ROOT	SPREAD	m) HEIGHT(m
<u> </u>	QIII.	BOTH THO RETURNE	COMMONITY	(mm)	KOOI	ין שו ישווים	in incionin
	UM DECII	DUOUS TREES (10-15m)		, ,			
SR	5	SYRINGA RETICULATA	Japanese lilaC	70	B&B		
REE I	FORM SH	RUBS					
Al	3	AMELANCHIER LAEVIS	ALLEGHENY SERVICEBERRY	40	B&B	6	6
Hg	3	HYDRANGEA PANICULATA 'GRANDIFLORA'	PEE GEE HYDRANGEA	40	B&B	5	8
רכיים	DOUS SHF	29110					
<u>JECIL</u> Ck	9 9	CORNUS SERICEA 'KELSEYI'	KELSEY RED OSIER DOGWOOD		3 GAL.	0.6	0.6
٠.,	•		COLLA COLLA DOCTATION		J J/ \L.	0.0	0.0


LITTLE BLUESTEM

SITE INFORMATION				
SITE PLAN	PROVIDED BY KORSIAK URBAN PLANNING DATED MARCH 19, 2020			
COMPOSITE UTILITY PLAN	CUP PROVIDED BY STANTEC/PROJ. NO. 160401085/DATED APRIL 2020			
GEOTECHNICAL STUDY	GEOTECHNICAL INVESTIGATION REPORT PROPOSED RESIDENTIAL DEVELOPMENT 3288 GREENBANK ROAD BY PATERSON GROUP.REPORT NO.PG2743-2 DATED MARCH 6, 2019			
CITY FILE NUMBER	D07-12-20-0058			

0.4 1


1 GAL. PT


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LEGEND

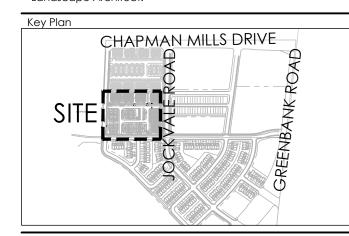PROPERTY LINE





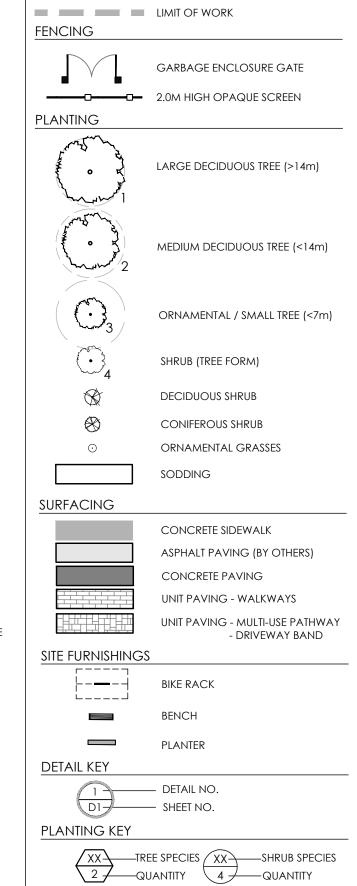

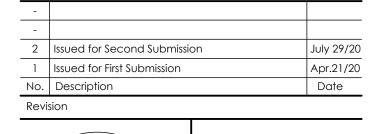


1285 WELLINGTON STREET WEST, OTTAWA, ON K1Y 3A8 CANADA T 613.237.2345 F 613.237.6423 NAKDESIGNSTRATEGIES.COM


BLOCK 4 SOUTH NEPEAN TOWN CENTRE

LANDSCAPE PLAN

Apr 2020 Scale 1:250 Drawn TM Checked DE, JH Job No. 19-282

Plan number: 18168

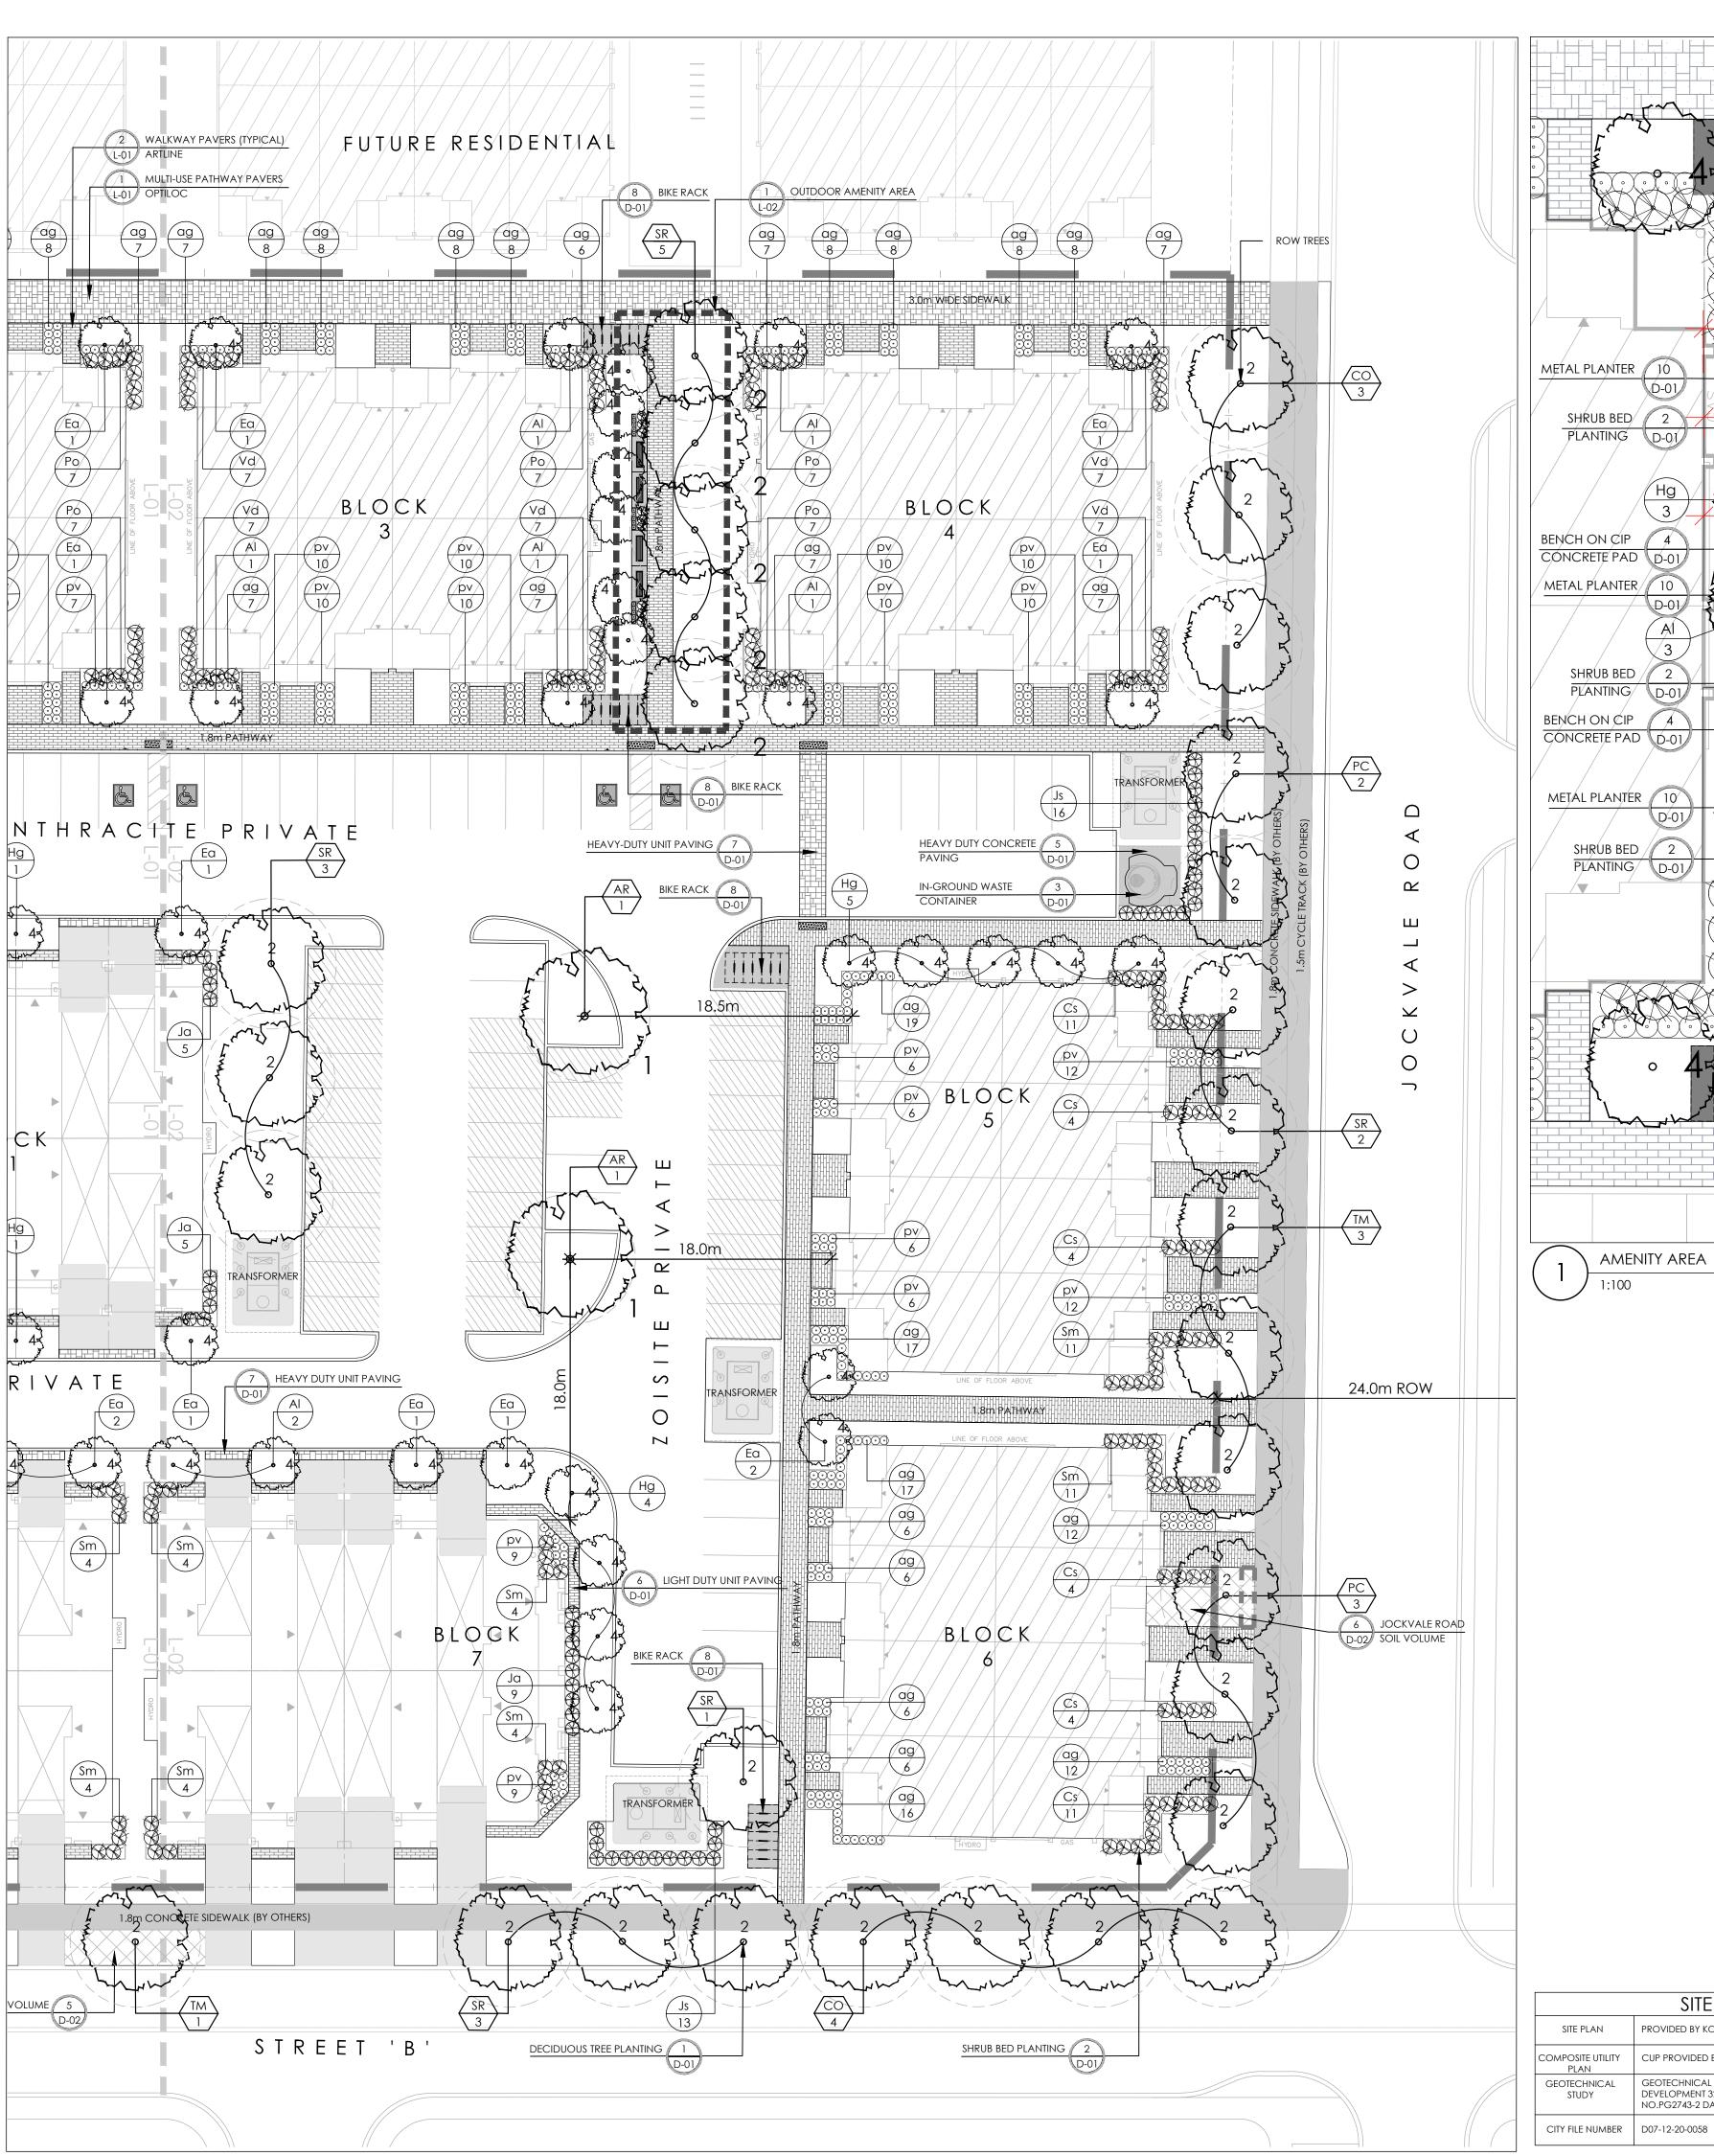

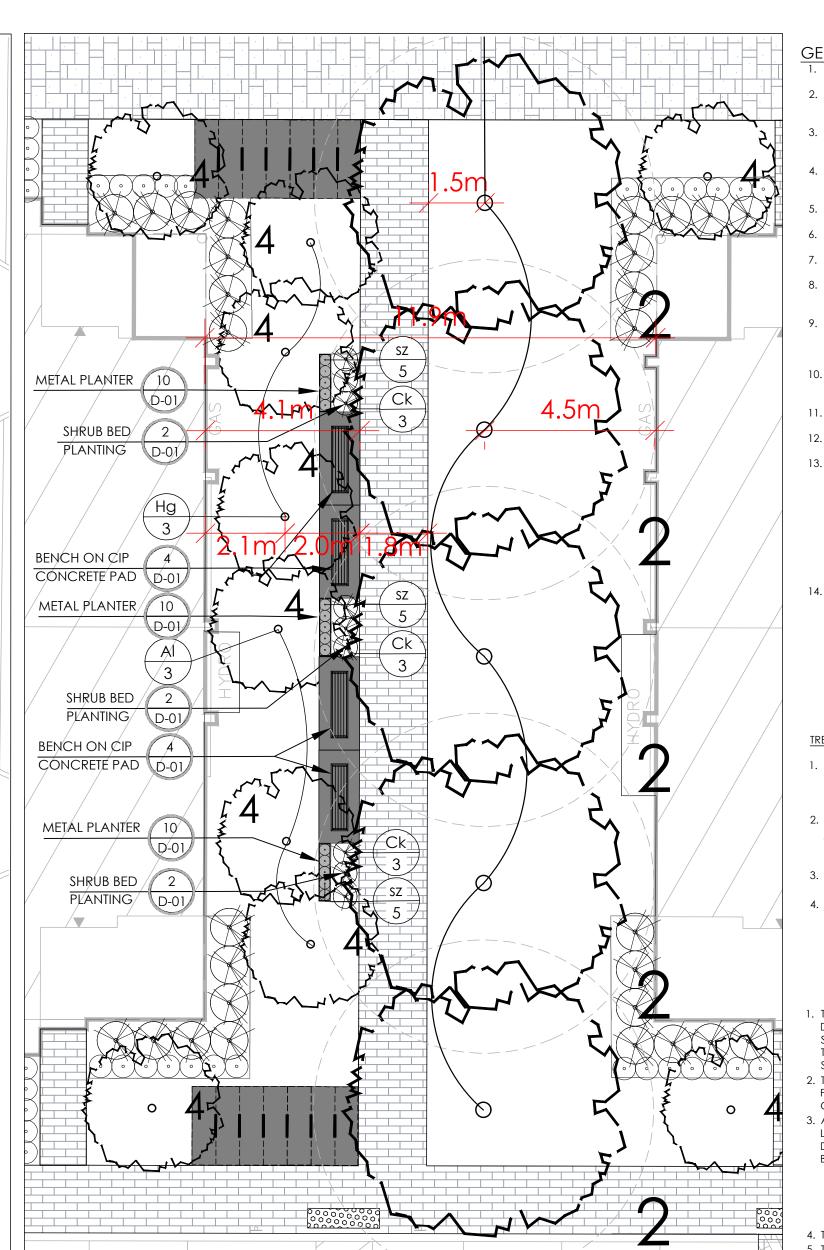

SITE INFORMATION

NO.PG2743-2 DATED MARCH 6, 2019

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GEOTECHNICAL INVESTIGATION REPORT PROPOSED RESIDENTIAL

CUP PROVIDED BY STANTEC/PROJ. NO. 160401085/DATED APRIL 2020

DEVELOPMENT 3288 GREENBANK ROAD BY PATERSON GROUP.REPORT

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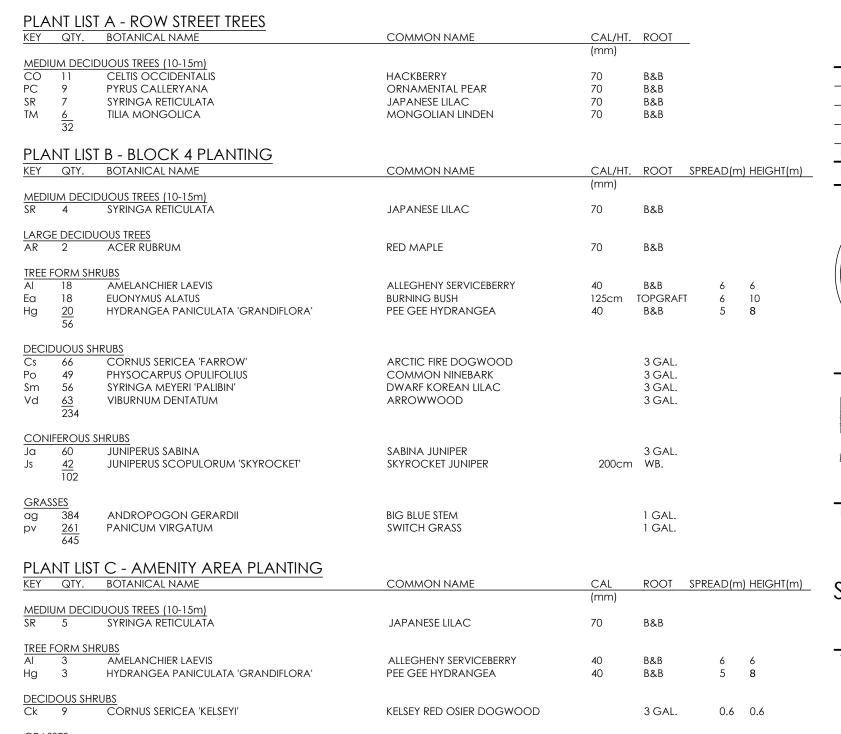
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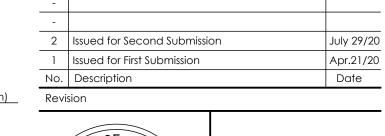
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0.4 1



LITTLE BLUESTEM

SCHIZACHYRIUM SCOPARIUM



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GARBAGE ENCLOSURE GATE

LARGE DECIDUOUS TREE (>14m)

MEDIUM DECIDUOUS TREE (<14m)

ORNAMENTAL / SMALL TREE (<7m)

SHRUB (TREE FORM)

**DECIDUOUS SHRUB** 

CONIFEROUS SHRUB

SODDING

ORNAMENTAL GRASSES

CONCRETE SIDEWALK

CONCRETE PAVING

ASPHALT PAVING (BY OTHERS)

UNIT PAVING - WALKWAYS

UNIT PAVING - MULTI-USE PATHWAY

- DRIVEWAY BAND

CHAPMAN MILLS DRIVE

Landscape Architect.

PROPERTY LINE


**FENCING** 

PLANTING

SURFACING

LIMIT OF WORK

2.0M HIGH OPAQUE SCREEN

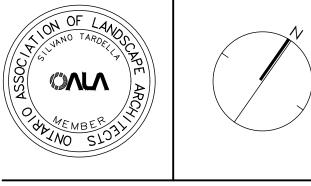




design strategies 1285 WELLINGTON STREET WEST, OTTAWA, ON K1Y 3A8 CANADA T 613.237.2345 F 613.237.6423 NAKDESIGNSTRATEGIES.COM

BLOCK 4 SOUTH NEPEAN TOWN CENTRE


LANDSCAPE PLAN


Date Apr 2020 Scale 1:250 Drawn TM Checked DE, JH Job No. 19-282


Plan number: 18168

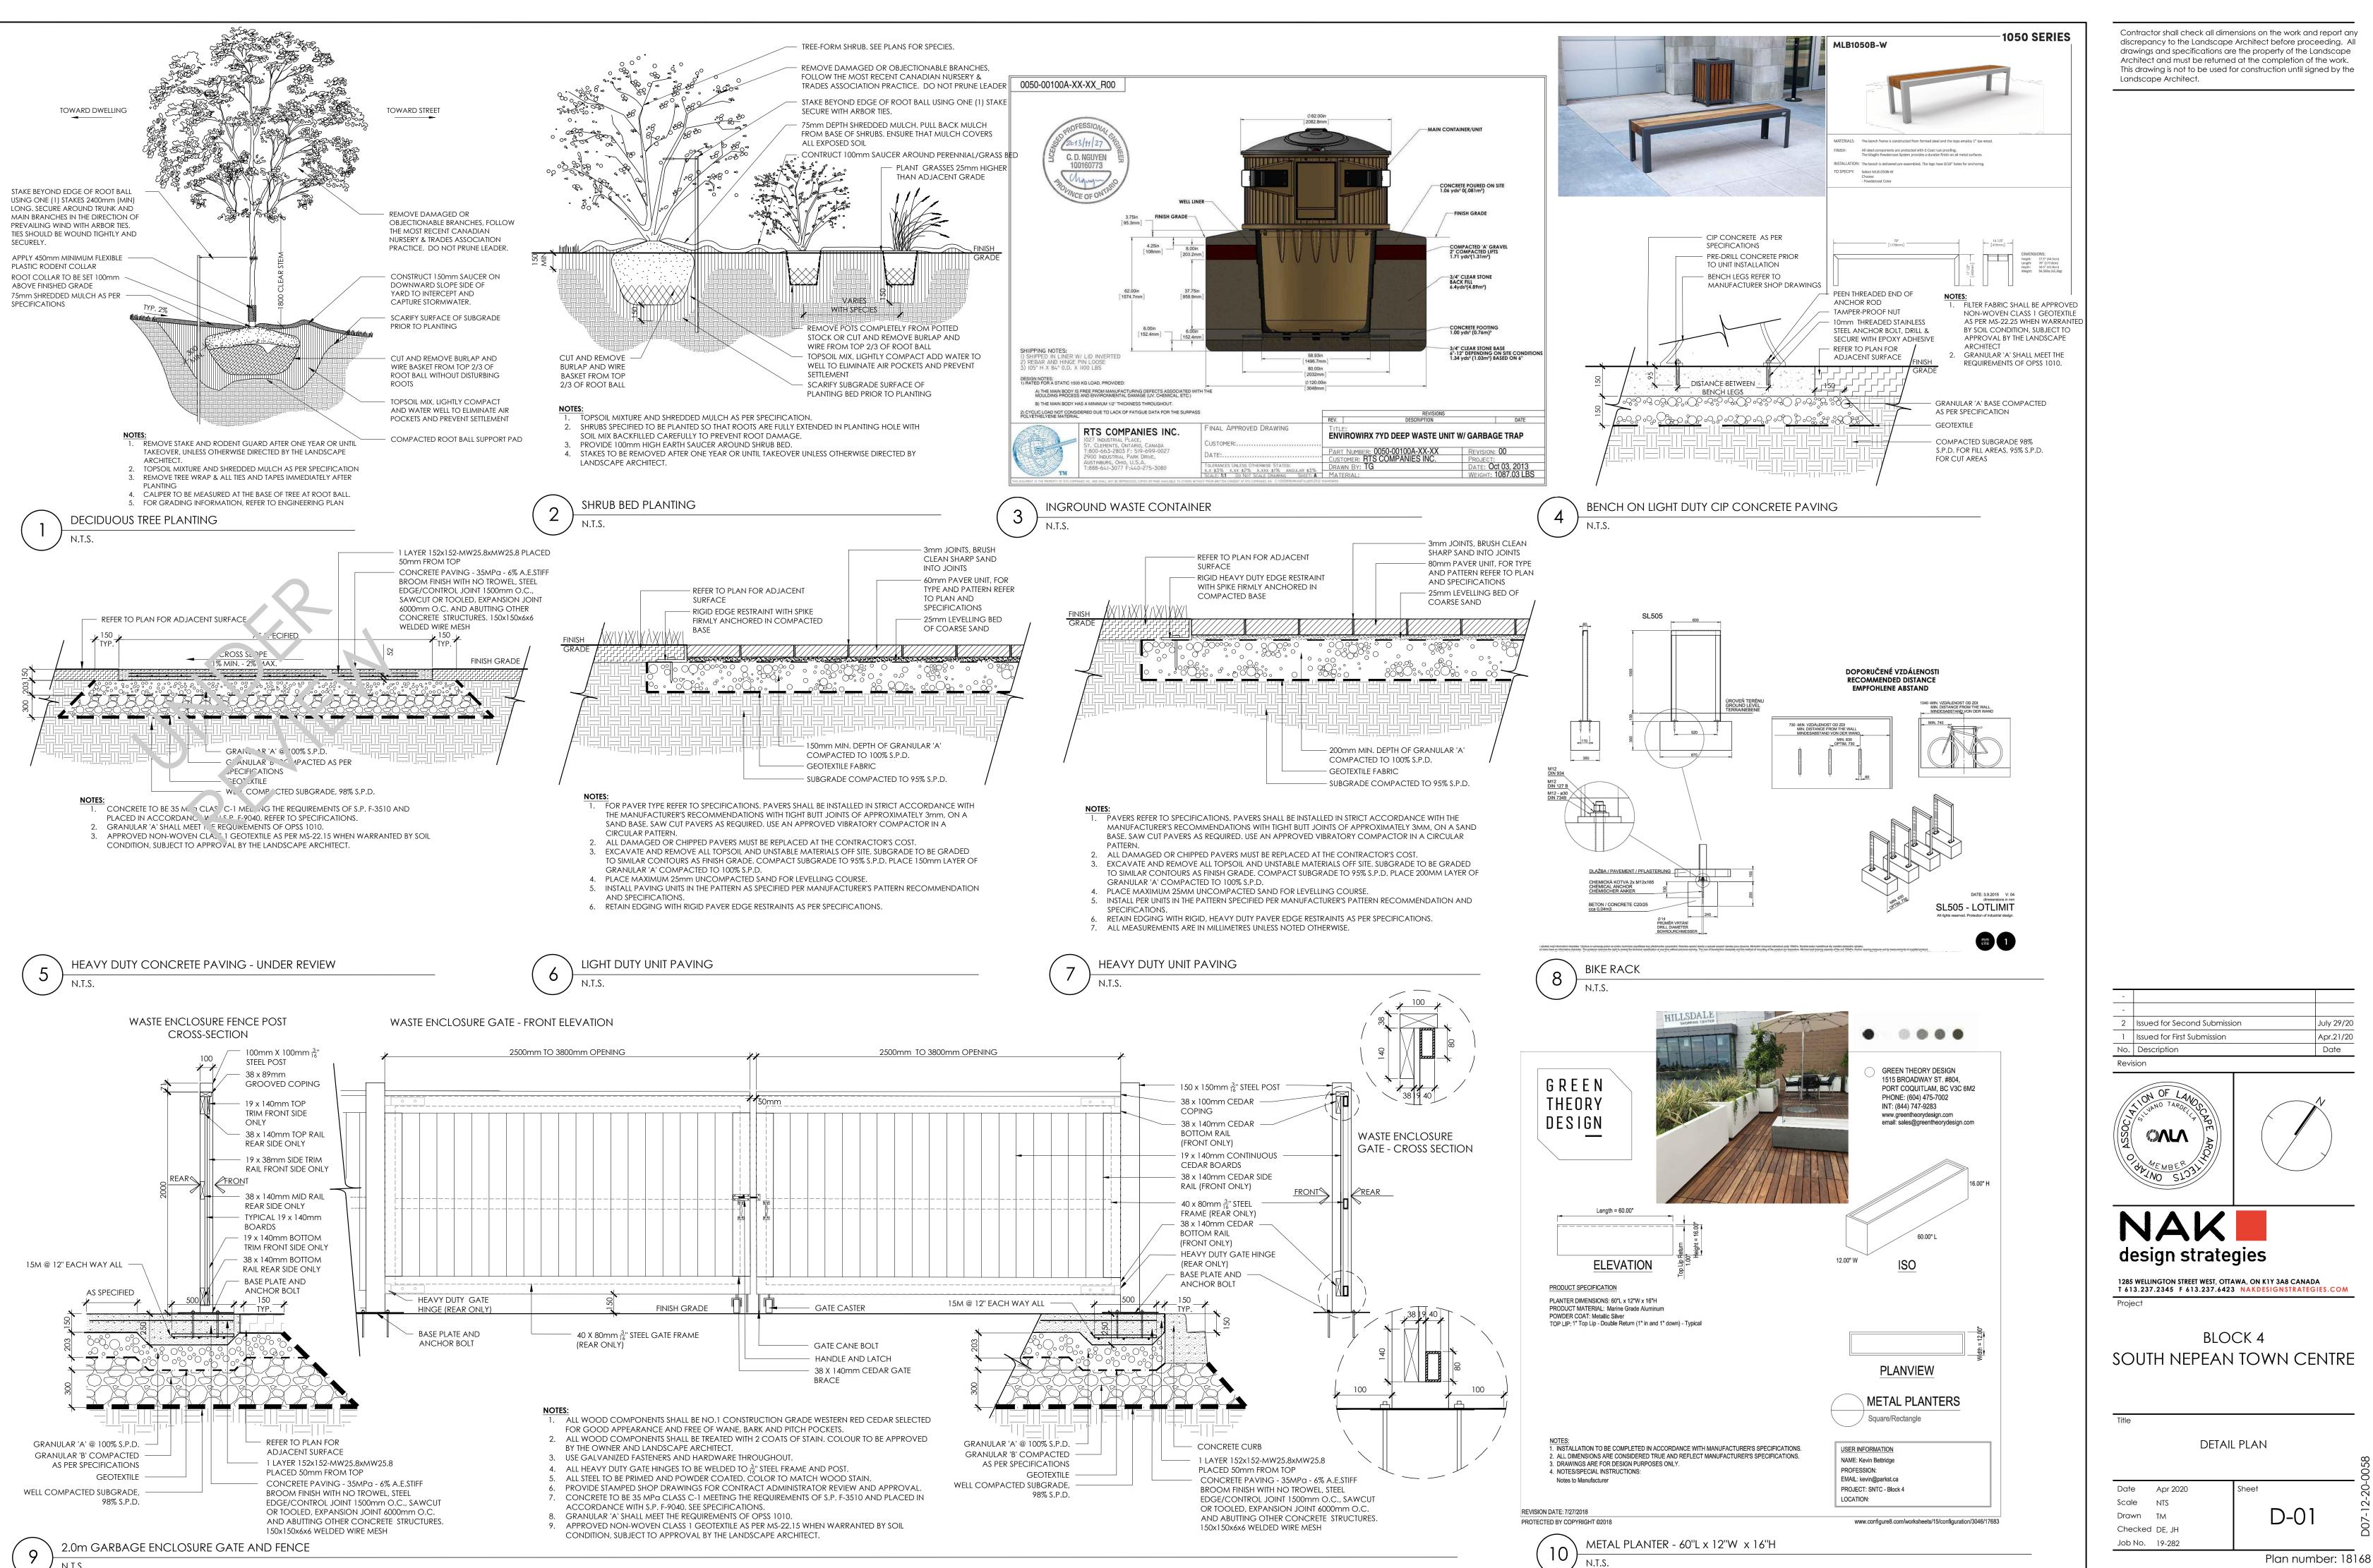




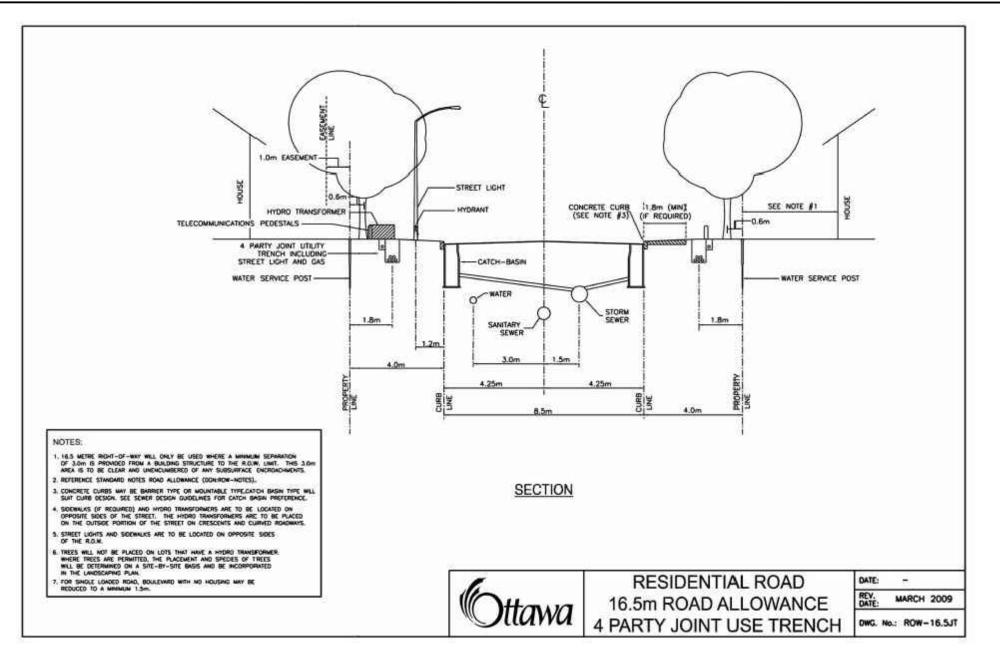

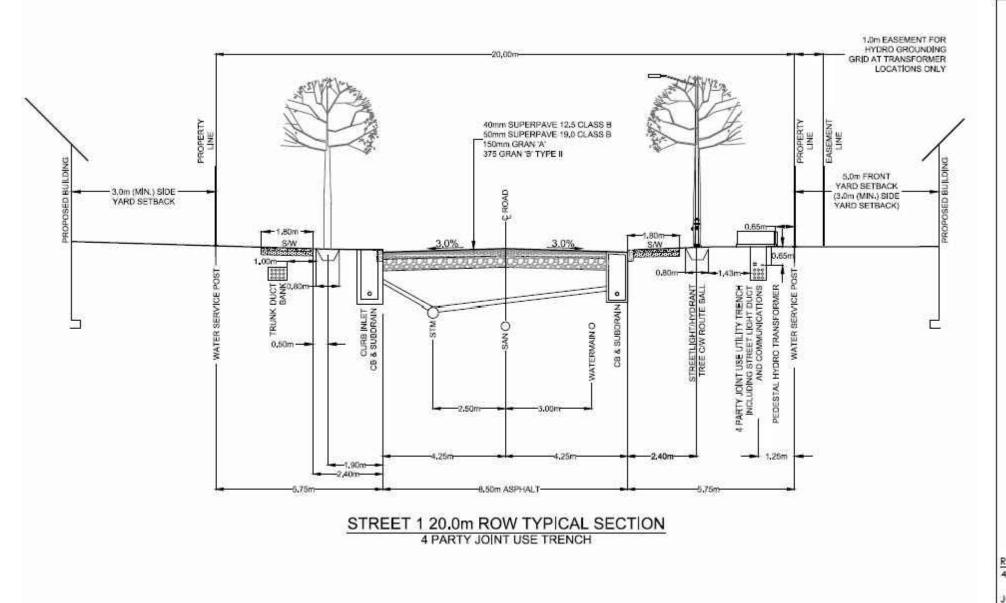

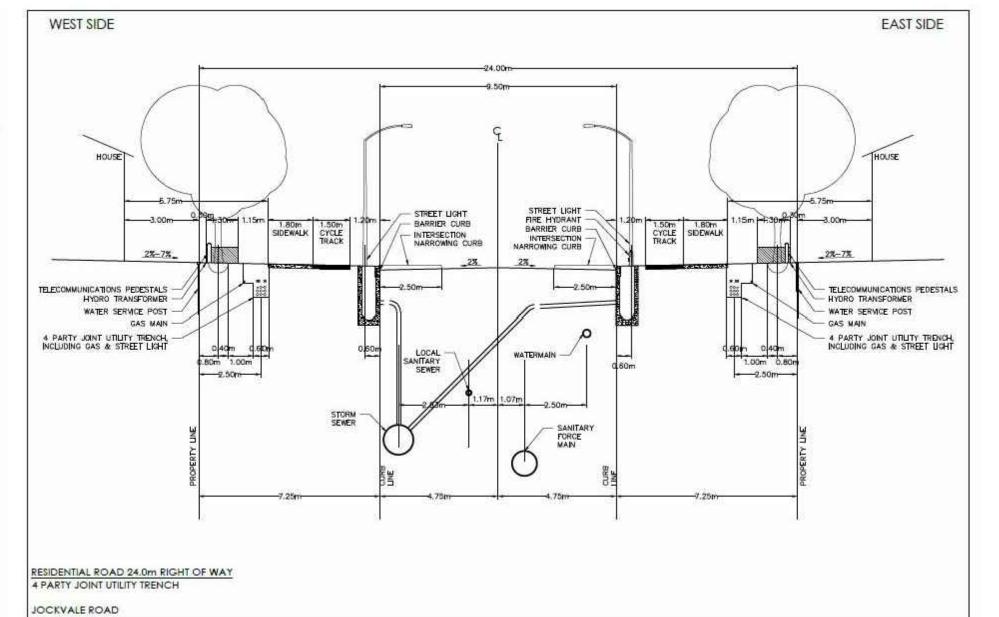

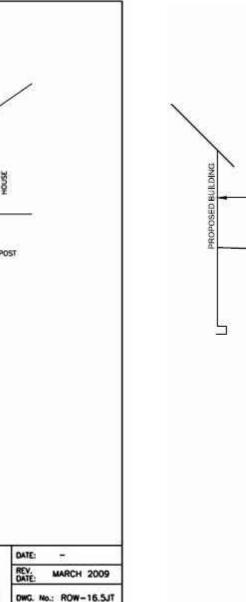

14.0m ROW - STREET 'C' (REFER TO NOTE 7)


STREET 'C' SOIL VOLUME

20.0m ROW - STREET 'B'

24.0m ROW - JOCKVALE ROAD N.T.S.

5.2m Small Trees Require: 25.0m3 Main Trench Along Row: 2.96m2(area) x 1.5m(depth) = 4.44m3 Total Volume: 15.46m2 x 1.5m(depth) = 23.19m3 Available Soil Volume: 22.62m3 - 4.44m3 = 18.75m3

STREET 'B' SOIL VOLUME

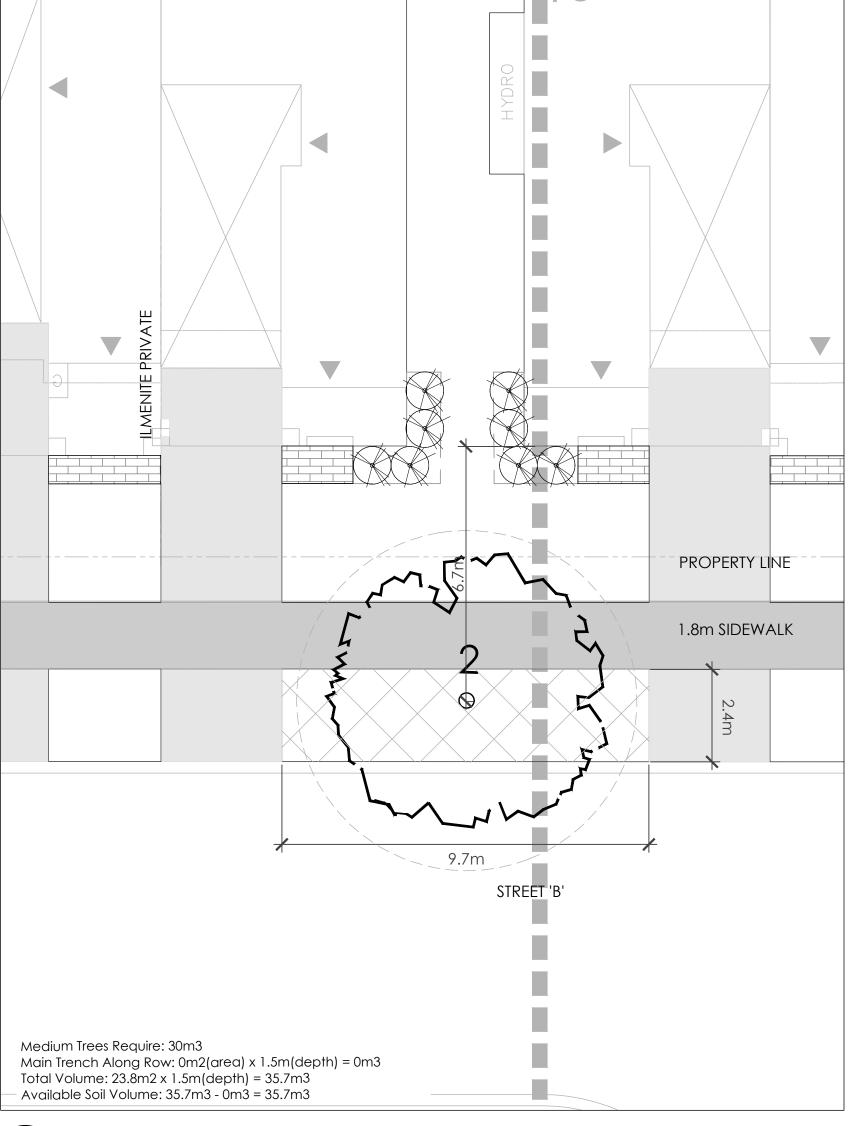

Medium Trees Require: 30m3

Main Trench Along Row: 3.70m2(area) x 1.5m(depth) = 5.55m3

Total Volume: 30.13m2 x 1.5m(depth) = 45.19m3

Available Soil Volume: 45.19m3 - 5.55m3 = 39.64m3 JOCKVALE ROAD SOIL VOLUME


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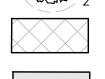
PLANTING

MAIN AND LATERAL SERVICE TRENCH

SMALL DECIDUOUS STREET TREE



MEDIUM DECIDUOUS STREET TREE

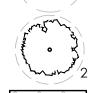



SOIL VOLUME CALCULATION



DRIVEWAY

VOLUME OF SHALLOW SERVICE

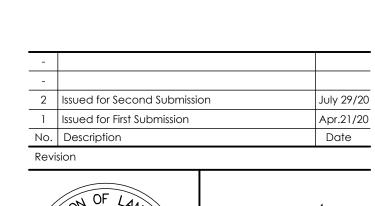

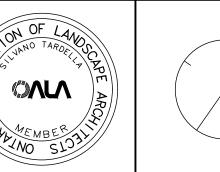



1285 WELLINGTON STREET WEST, OTTAWA, ON K1Y 3A8 CANADA T 613.237.2345 F 613.237.6423 NAKDESIGNSTRATEGIES.COM

BLOCK 4

SOUTH NEPEAN TOWN CENTRE

ROW & SOIL VOLUME

Date Apr 2020 Scale NTS Drawn TM Checked DE, JH Job No. 19-282

D-02

Plan number: 18168

