
DOUGLAS JAMES, MCIP, RPP MANAGER, DEVELOPMENT REVIEW - CENTRAL PLANNING, INFRASTRUCTURE & ECONOMIC DEVELOPMENT DEPARTMENT, CITY OF OTTAWA

By Douglas James at 3:00 pm, Feb 12, 2022

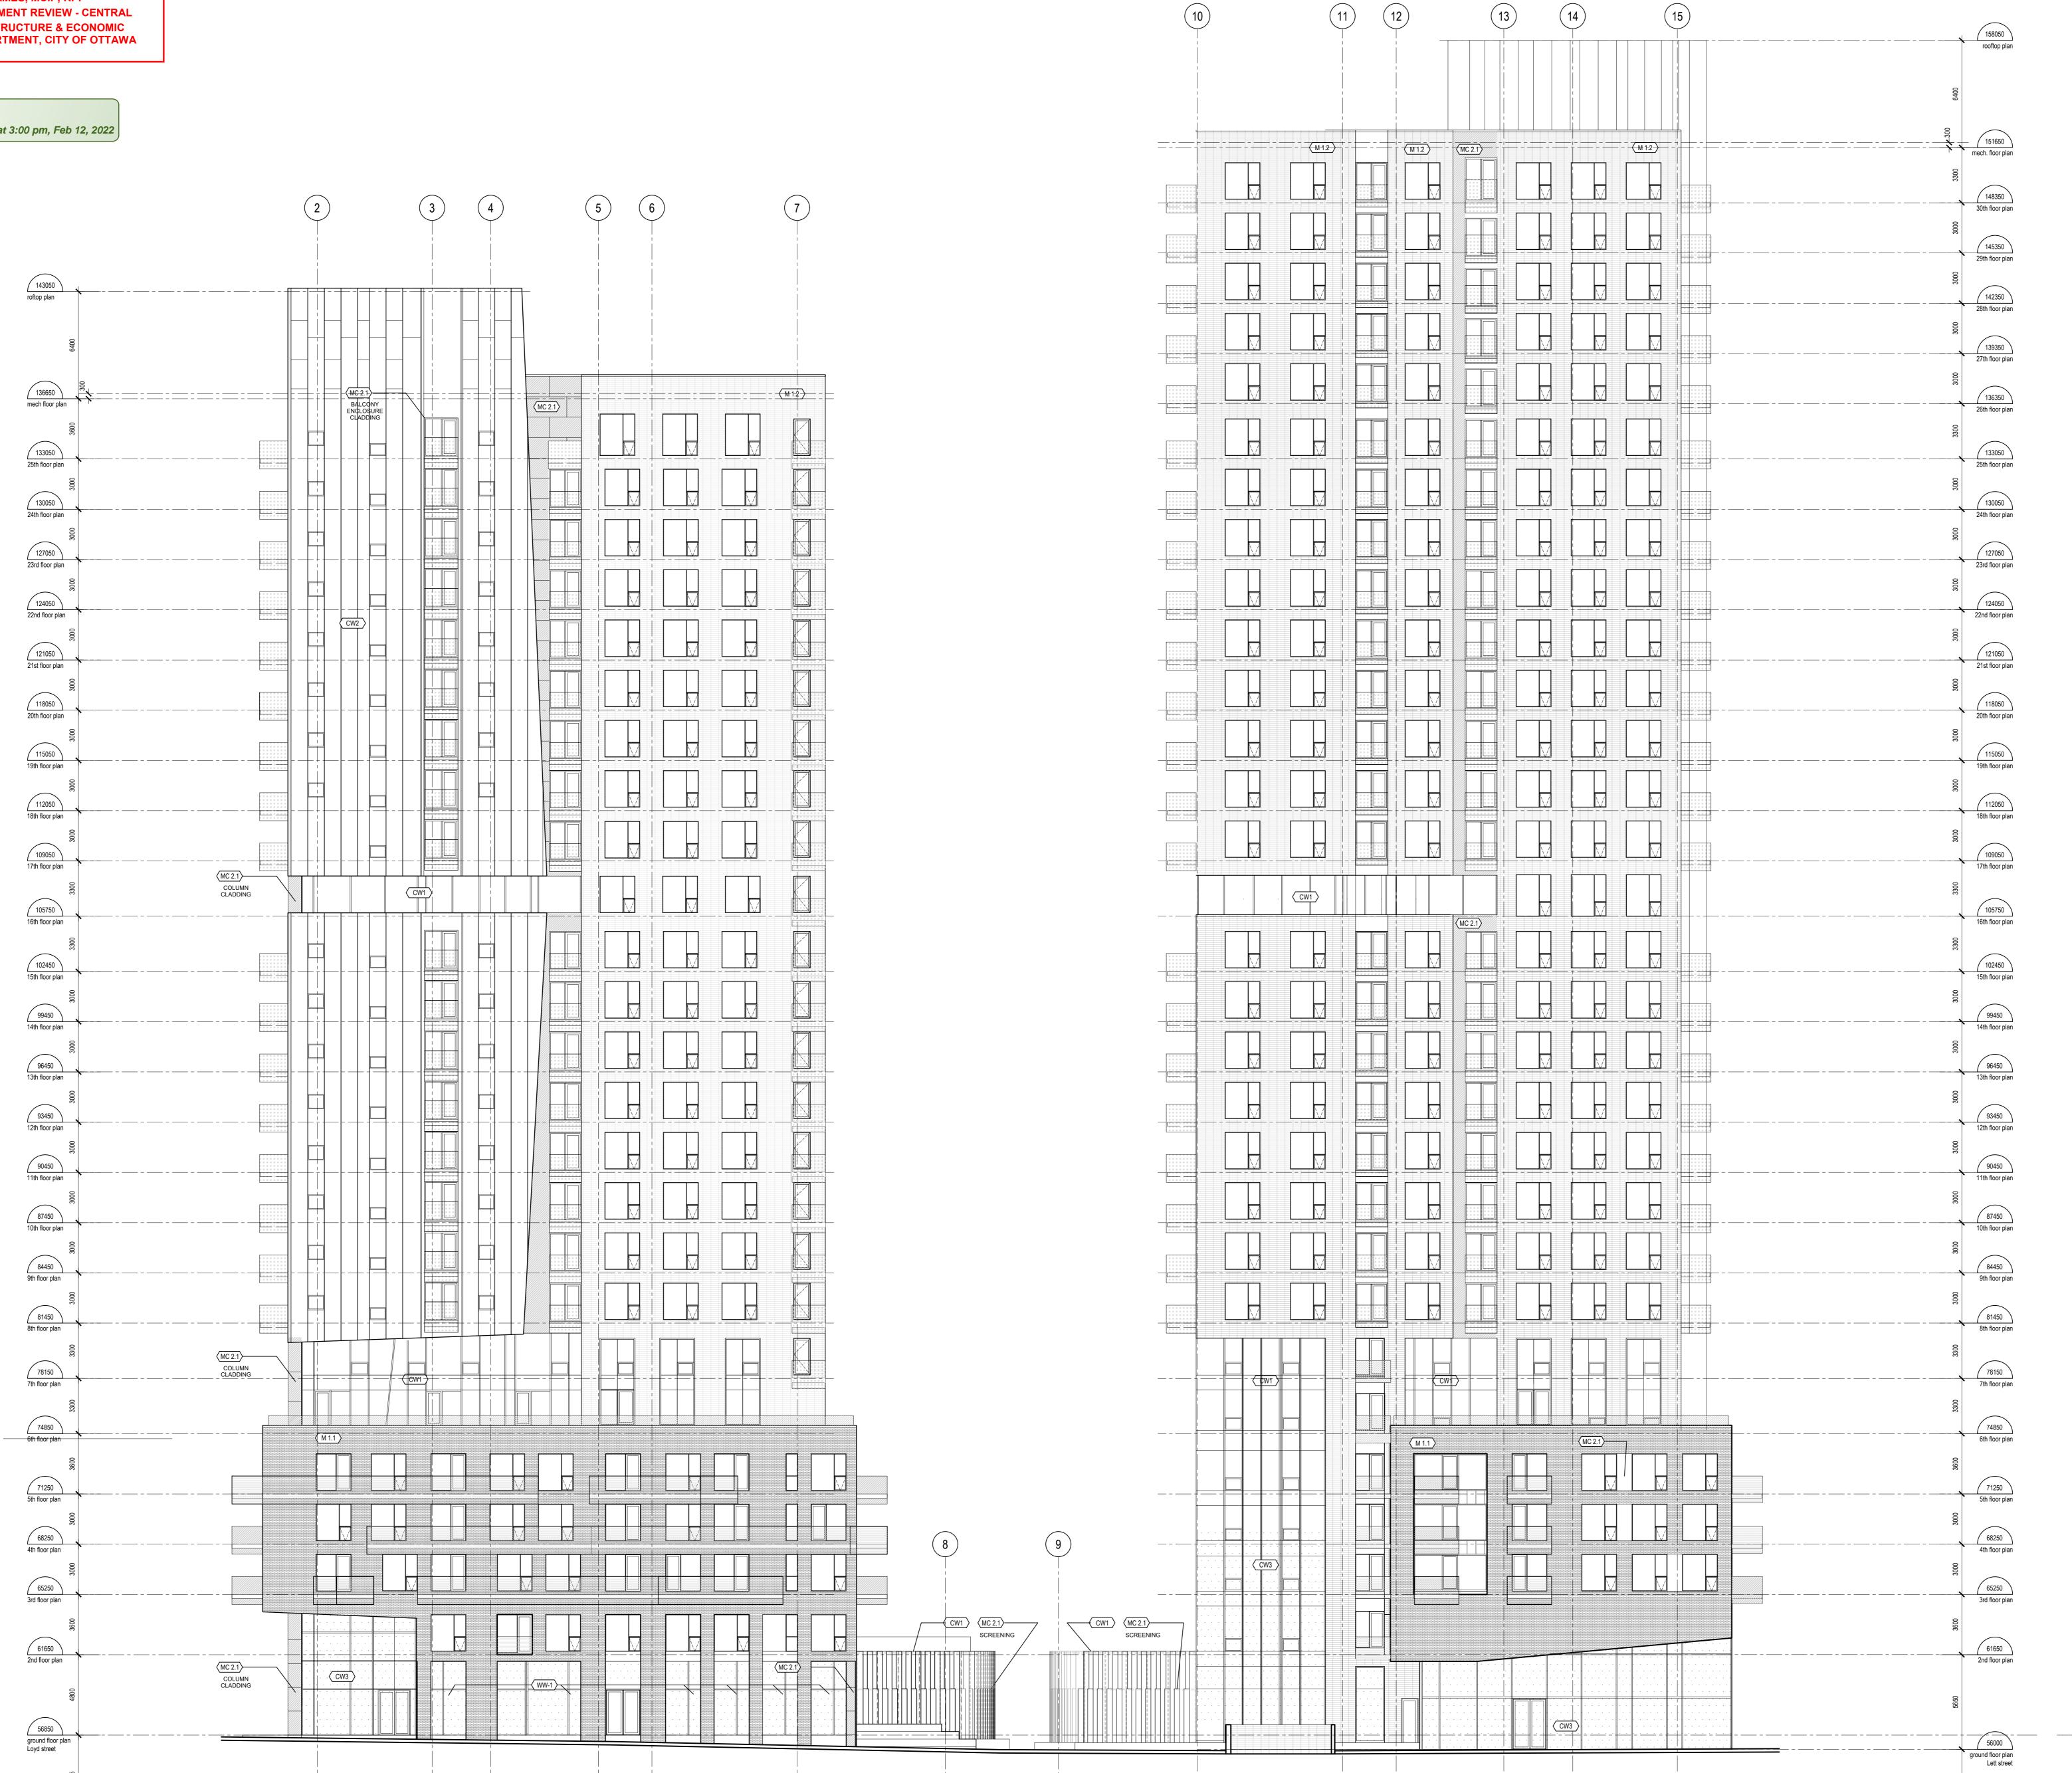

BRICK SIOUX CITY BRICK
BLACK HILL SMOOTH
FORMAT NORMAN MASONRY DAY & CAMPBELL (MMAL) LINE #301 ACTON GREY FORMAT ASHLER MC 2.1 METALLIC CLADDING DOFASCO-ARCELORMITTAL INDATEN WEATHERING STEEL PRE-FORMED ALUMINUM PANELS
DURANAR XL BLACK
UC40577XL-Black W/XL HR 3.1 ALUMINUM GUARDRAIL SYSTEM - CLEAR TEMPERED GLASS PANEL HR 3.2 ALUMINUM GUARDRAIL SYSTEM - PERFORATED ALUMINUM PANEL HR 3.3 ALUMINUM GUARDRAIL SYSTEM - SILK-SCREENED GLASS PANEL (TRANSLUCENT) HR 3.4 ALUMINUM GUARDRAIL SYSTEM - FRITTED GLASS PANEL (5mm 'DOTS" SPACED 100mm) WINDOWS AND CURTAIN WALL FRAME PRE-FORMED ALUMINUM PANELS DURANAR XL BLACK # UC40577XL-Black W/XL CW2 STRUCTURAL SILICONE JOINT CURTAIN WALL GLAZING SYSTEM CW3 STRUCTURAL SILICONE JOINT CURTAIN WALL GLAZING SYSTEM FRITTED GLASS (5mm 'DOTS' SPACED 100 mm) WW WINDOW-WALL WW-1 WINDOW-WALL FRITTED GLASS (5mm 'DOTS' SPACED 100mm) S.S.A. STRUCTURAL SHELF ANGLE

LEGEND - MATERIALS

GENERAL NOTES 1. ALL GLASS TO CONFORM TO CAN/CGSB-12.20-2. WINDOWS IN PUBLIC AREA TO CONFORM TO OBC 2012 3.3.1.187 (6) 3. USE TEMPERED GLASS WHERE REQUIRED TO MEET MINIMUM STRENGTH REQUIREMENTS

CONTROL JOINT

LOOSE LINTEL

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LANDSCAPE ARCHITECTS: James B. Lennox and Associates Inc.

STRUCTURAL ENGINEERS:

CIVIL ENGINEERS:

Landscape Architects 361 Hinton Avenue South,

Ottawa, Ontario, K1Y 1A6 T : (613) 722 5168

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MECANICAL + ELECTRICAL ENGINEERS: TOPOGRAPHICAL SURVEYOR: Stantec Smith + Andersen

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LETT STREET BUILDING D

ISSUED FOR REVISED SITE PLAN APPROVAL ISSUED FOR REVISED SITE PLAN APPROVAL ISSUED FOR COORDINATION - STRUCTURAL 0 ISSUED FOR COORDINATION N°: DESCRIPTION:

THE GENERAL CONTRACTOR:

1. SHALL BE RESPONSIBLE FOR VERIFYING ALL DIMENSIONS ON SITE TO ENSURE COMPLIANCE WITH THE DIMENSIONS GIVEN ON THE DRAWINGS. 2. SHALL BE RESPONSIBLE TO IMMEDIATELY SUBMIT A REPORT TO THE ARCHITECT OR ENGINEER OUTLINING ANY INACCURACIES.

4. ANY INDIVIDUAL OR FIRM THAT HAVE RECEIVED ELECTRONIC DOCUMENT SHALL USE THEM AT THEIR OWN RISK. ONLY ORIGINAL DRAWINGS, STAMPED BY THE ARCHITECT, MAY BE USED FOR CONSTRUCTION.

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LEBRETON - PHASE 4-5

LLOYD STREET ELEVATIONS

ground floor plan

DESIGN: NG APPROVED: NG DRAWN: NG,EF,PS VERIFIED: NG SCALE: 1:200

PROJECT Nº: 9360-20

A-300