




1 TREE CONSERVATION REPORT & LANDSCAPE PLAN
SCALE: 1:200

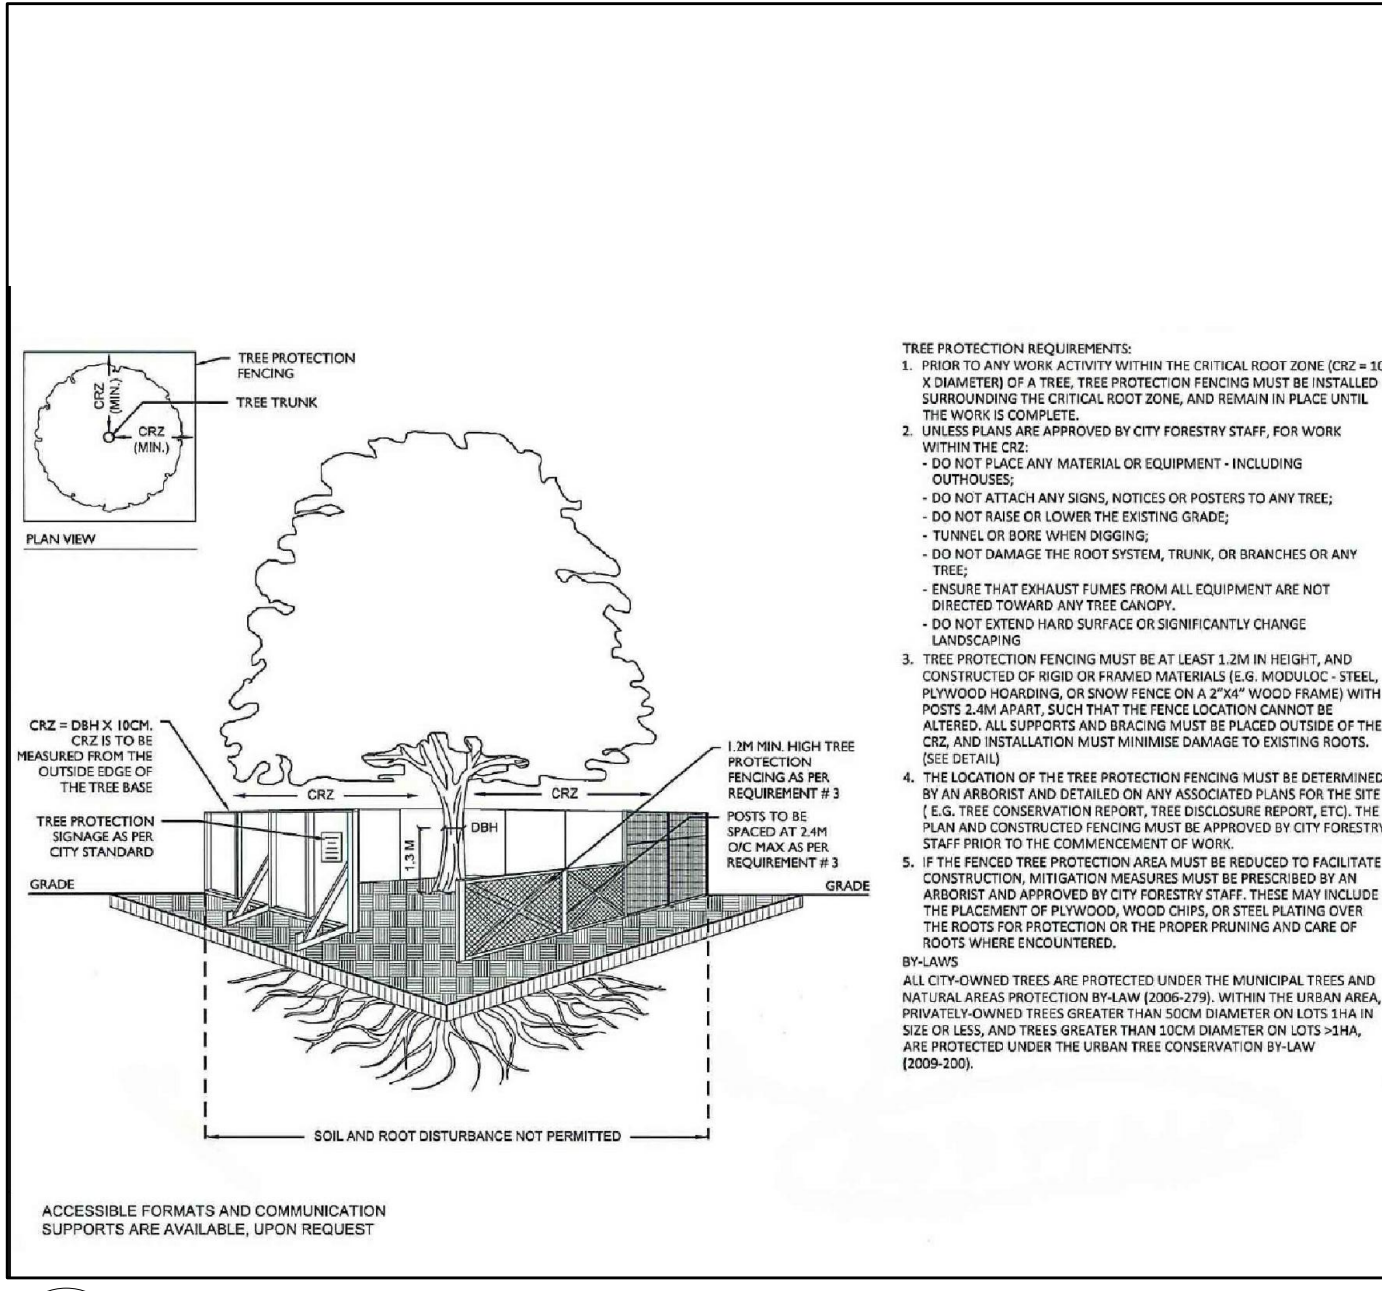

2 TREE PROTECTION FENCE
SCALE: NTS

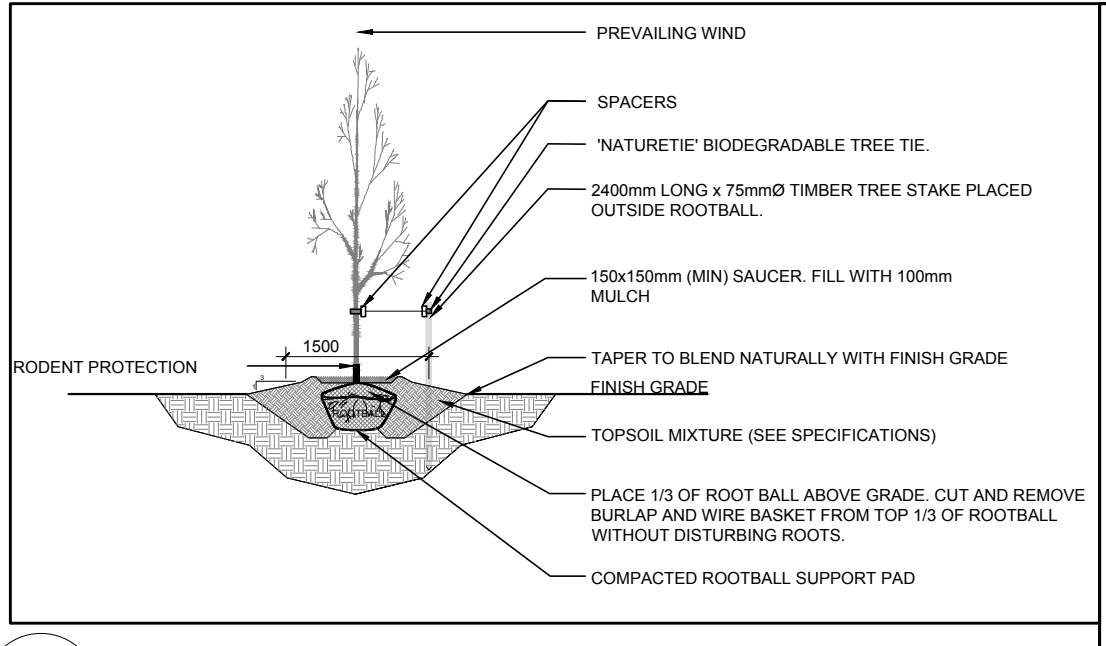

3 DECIDUOUS TREE PLANTING
SCALE: NTS

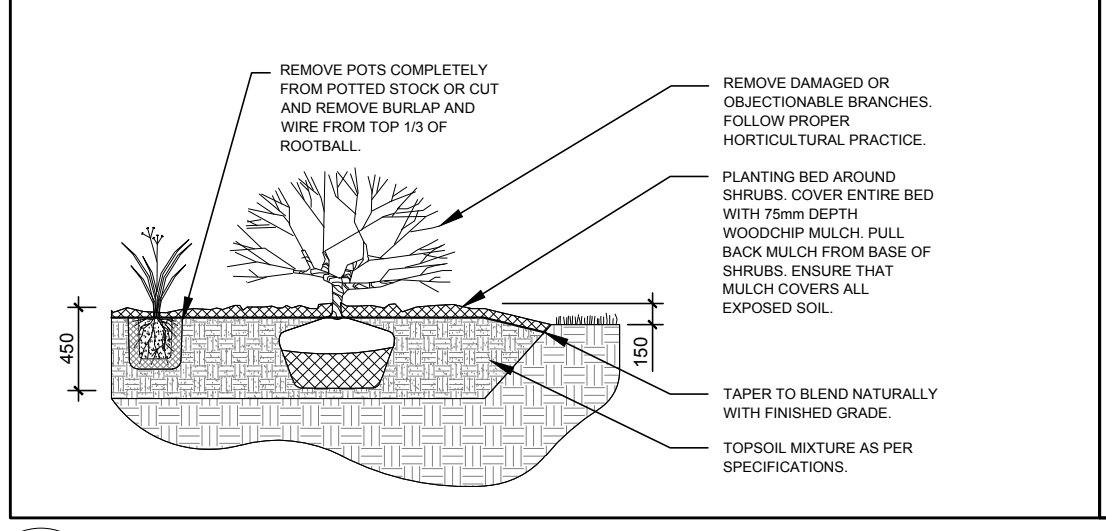

4 SHRUB / PERENNIAL / ORNAMENTAL GRASS PLANTING
SCALE: NTS

PROPOSED PLANT LIST						
KEY	QTY	BOTANICAL NAME	COMMON NAME	SIZE	CONDITION	REMARKS
TREES						
GB	10	Ginkgo biloba	Maidenhair Tree	60mm ø	B&B	Male tree
HB	2	Callis occidentalis	Hackberry	60mm ø	B&B	
HL	6	Olethia triacanthos	Honey Locust	60mm ø	B&B	
JL	2	Syringa reticulata	Japanese Tree Lilac	60mm ø	B&B	
SB	1	Amelanchier canadensis	Serviceberry	60mm ø	B&B	
SHRUBS						
AH	27	Hydrangea arborescens 'Annabelle'	Annabelle Hydrangea	1 Gallon pot	Potted	1200 mm o.c.
AW	25	Spiraea japonica 'Anthony Waterer'	Anthony Waterer Spiraea	600mm ht.	Potted	800 mm o.c.
JH	19	Juniperus horizontalis 'Compact Andorra'	Compact Andorra Juniper	600mm spr.	Potted	800 mm o.c.
PC	8	Coloneaster acutifolia	Peking Coloneaster	600mm ht.	Potted	1000 mm o.c.
PF	32	Potentilla fruticosa 'Goldfinger'	Goldfinger Cinquefoil	600mm ht.	Potted	800 mm o.c.
PO	4	Physocarpus opulifolius	Ninespark	800mm ht.	Potted	800 mm o.c.
SS	18	Sorbaria sorbifolia 'Sem'	Sem False Spiraea	600mm ht.	Potted	1000 mm o.c.
PERENNIALS AND ORNAMENTAL GRASSES						
AJ	20	Sedum 'Autumn Joy'	Autumn Joy Sedum	100mm pot	Potted	400 mm o.c.
BS	63	Rudbeckia fulgida 'Goldsturm'	Yellow Coneflower	250mm pot	Potted	500 mm o.c.
KF	44	Calamagrostis x acutiflora 'Karl Foerster'	Feather Reed Grass	250mm pot	Potted	800 mm o.c.
PU	8	Echinacea purpurea 'Magnus'	Magnus' Purple Coneflower	100mm pot	Potted	400 mm o.c.
SD	11	Hemerocallis 'Stella D'Oro'	Stella D'Oro Daylily	100mm pot	Potted	400 mm o.c.
SG	10	Panicum virgatum 'Shenandoah'	Shenandoah Switch Grass	250mm pot	Potted	800 mm o.c.

EXISTING TREE LIST						
KEY	QTY	BOTANICAL NAME	COMMON NAME	SIZE	CONDITION	REMARKS
TREES						
AC	2	Amelanchier canadensis	Serviceberry	50-200mm DBH	Good	See Plan
AC1	1	Amelanchier canadensis	Serviceberry	50mm DBH	Good	See Plan
AP	1	Acer platanoides	Norway Maple	300mm DBH	Good	See Plan
AR	1	Acer rubrum	Red Maple	700mm DBH	Good	See Plan
AS	1	Acer saccharum	Sugar Maple	150mm DBH	Fair	See Plan
CK	5	Acer platanoides 'Crimson King'	Crimson King Maple	300-400mm DBH	Good	See Plan
CO	6	Callis occidentalis	Hackberry	80-100mm DBH	Good	See Plan
QR	2	Quercus rubra	Red Oak	500-700mm DBH	Good	See Plan
TO	*	Thuja occidentalis	Eastern White Cedar	100-200mm DBH	Good	See Plan
WM	1	Morus alba 'Pendula'	Weeping Mulberry	100mm DBH	Good	See Plan

GENERAL NOTES:

- It is the responsibility of the appropriate contractor or official to report any errors, omissions or discrepancies on this plan with actual site conditions to the Landscape Architect before proceeding with construction.
- The contractor is to notify all utility companies and authorities prior to any excavation and ascertain locations of underground services.
- The contractor is to reestablish all areas and items damaged as a result of construction activity.
- The contractor is to comply with all pertinent codes and by-laws.
- The contractor is to maintain a positive surface run-off throughout the entire construction period.
- The Landscape Architect is not responsible for subsurface conditions.
- The contractor is to identify all existing trees to remain on site with the Landscape Architect prior to construction.
- The contractor is to stake the proposed location of all plant material in conjunction with the Landscape Architect prior to excavation.
- Minimum distances for selected deciduous trees are as follows:
 - Building Foundations 7.5m
 - Sidewalks 1.5m
 - Public Streets 2.5m
 - Underground Infrastructure 2.0m
- All trees within 1m of underground utility trenches are to be excavated by hand.
- Remove all protective wrapping from tree trunks after installation.
- Staking of trees shall only be performed if necessary.
- Ensure that mulch is pulled back a min. distance of 75mm from base of tree trunk.

CLIENT: MR. GEORGE ELIAS
31 WOODVIEW CRESCENT
OTTAWA, ON K1B 3B1

CONSULTANTS:
ARCHITECTS: **RH**
Rosaline J. Hill Architect Inc.

SURVEYORS: FARLEY, SMITH & DENIS SURVEYING LTD.
ONTARIO LAND SURVEYORS
190 COLBYN ROAD, OTTAWA, ONTARIO K2E 7J5
TEL: (613) 721-8226 FAX: (613) 721-8228

CIVIL ENGINEERS: **K** Kollaard Associates
Engineers (613) 860-0923
P.O. BOX 888, 215 PEBBLECOT ST.
KESWILLIE, ONTARIO
K0J 1S0 TEL: (613) 268-0475
FAX: (613) 268-0475
WWW.KOLLAARD.CO

LEGEND:
- EDGE OF CRITICAL ROOT ZONE
- EXISTING TREE TO REMAIN
- EXISTING CEDAR HEDGE TO REMAIN
- EXISTING CEDAR HEDGE TO BE REMOVED
- EXISTING TREE TO BE REMOVED
- PROPOSED SOD
- PROPOSED RIVERSTONE MULCH
- PROPOSED CLEAR STONE
- PROPOSED DECIDUOUS TREE
- PROPOSED SHRUBS / PERENNIALS / ORNAMENTAL GRASSES
- EXISTING WOOD BOARD FENCE
- PROPOSED TREE PROTECTION FENCE

12	FOUR (4) NEW TREES ADDED	03/28/2022	ML	JL
11	REVISED PER NEW SITE PLAN	03/24/2022	ML	JL
10	REVISED PER NEW SITE PLAN	03/23/2022	ML	JL
9	REVISED PER NEW SITE PLAN	02/28/2022	ML	JL
8	REVISED PER NEW SITE PLAN	01/05/2022	ML	JL
7	REVISED PER NEW SITE PLAN	01/04/2022	ML	JL
6	LIGHT STANDARDS REVISED	05/17/2021	ML	JL
5	LIGHT STANDARDS ADDED	05/13/2021	ML	JL
4	REVISED PER CITY COMMENTS	05/07/2021	ML	JL
3	ISSUED FOR DISCUSSION AND REVIEW	06/18/2020	ML	JL
2	ISSUED FOR DISCUSSION AND REVIEW	06/17/2020	ML	JL
1	ISSUED FOR DISCUSSION AND REVIEW	06/04/2020	ML	JL

No. Issue Date (MM/DD/YY) DR CK

JAMES B. LENNOX & ASSOCIATES INC.
LANDSCAPE ARCHITECTS
3332 CARLING AVE. OTTAWA, ONTARIO K2H 5A8
Tel. (613) 722-5168 Fax. (1-866) 343-3942

PROJECT: 6173 RENAUD ROAD, OTTAWA ON

DRAWING: TREE CONSERVATION REPORT & LANDSCAPE PLAN

STAMP: ASSOCIATION OF LANDSCAPE ARCHITECTS OF ONTARIO MEMBER

SCALE: AS SHOWN
START DATE: JUNE 2020
PROJECT NO.: 20MIS2002
DRAWING NO.: L.1
PLOT SIZE ARCH-D