


	WALL ASSEMBLY FRR LEGEND:	GENE	ERAL NOTES
Ī	1.5 HOUR FIRE RESISTANCE RATING, REFER		OO NOT SCALE DRAWIN ARE TO BE USED. WHE
	TO ASSEMBLY SCHEDULE ————————————————————————————————————	F	OR INTERPRETATION / T IS THE RESPO
	TO ASSEMBLY SCHEDULE • WHERE OBC SB-2 IS REFERENCED TO ACHIEVE THE		CONTRACTOR TO VERI
	 WHERE OBC 35-2 IS REFERENCED TO ACHIEVE THE REQUIRED MINIMUM FRR, THE FOLLOWING COMPONENT RATINGS WERE USED VIA THE ADDITIVE METHOD: 	C	GENERAL CONTRACT
	2x13mm TYPE 'X' GYPSUM BOARD: 80 min (TABLE 2.3.4 A)	(TO COORDINATE THE N COMPLY WITH DESIGN
	16mm TYPE 'X' GYPSUM BOARD: 40 min (TABLE 2.3.4 Å) 13mm TYPE 'X' GYPSUM BOARD: 25 min (TABLE 2.3.4 Å)	5	ALL WORK DESCRIBI SPECIFICATIONS ARE EDITION OF THE ONT
	WOOD STUDS:20 min (TABLE 2.3.4 E)FULL DEPTH INSULATION:15 min (TABLE 2.3.4 G)	1	NATIONAL BUILDING
	INTERIOR WALL ASSEMBLIES:	5. C	DRAWINGS AND SPECI AND ARE TO BE READ T
-		COPY	YRIGHT
	PARTY WALL PARTY WALL 2 LAYERS 13mm TYPE 'X' GYPSUM BOARD		DRAWING IS AN INS
	 13mm RESILIENT FURRING CHANNEL 38x140 WOOD STUD FRAMING @ 400mm o/c c/w FULL DEPTH INSULATION 	ARCH	TECTED BY COPYRIGH
		FOR	ES MAY ONLY BE USE THE SINGLE PROJECT MAY NOT BE OFFE
	1 HOUR FRR ACHIEVED THROUGH OBC SB-2. STC RATING: 53, OBC SB-3, W6c	WITH	IOUT THE EXPRESS
	* NOTE: MAKE THE FOLLOWING SUBSTITUTION AT		
	SHEAR-WALLS (REFER TO STRUCTURAL) 2 LAYERS STRUCTURAL SHEATHING		
	16mm TYPE 'X' GYPSUM BOARD		AC/24/WOP73
	W2 • 16mm TYPE 'X' GYPSUM BOARD		
	 38x89 or 140 WOOD STUD FRAMING @ 400mm o/c c/w FULL DEPTH INSULATION 16mm TYPE 'X' GYPSUM BOARD 		Acri
	TOMM TYPE X GYPSOM BOARD 1 HOUR FRR ACHIEVED THROUGH OBC SB-2.		AC
			proj
	 16mm GYPSUM BOARD 38x89 or 140 WOOD STUD FRAMING @ 400mm o/c 	ISSU	JE RECORD:
	16mm GYPSUM BOARD INTERIOR WALL, ONE-SIDED FINISH	NO.	DESCRIPTION
sc	 100 100 100 100 100 100 100 100 100 100	1	ISSUED FOR PRECO
		2	ISSUED FOR CLIENT
	2 LAYERS 10mm TYPE X GYPSUM BOARD 13mm RESILIENT FURRING CHANNEL @ 600mm o/c	3	ISSUED FOR CONSU
/	140mm WOOD STUDS (REFER TO STRUCTURAL) c/w FULL DEPTH INSULATION	4	ISSUED FOR COORD
	2 LAYERS 16mm TYPE 'X' GYPSUM BOARD	5	ISSUED FOR SITE PL
#	1 HOUR FRR ACHIEVED THROUGH ULC U334 STC RATING: 62	6	ISSUED FOR 50% CC
191	NOTE: 16mm TYPE 'X' GYPSUM BOARD PERMITTED TO BE SUBSTITUTED w/ 13mm TYPE 'X' GYPSUM BOARD UNDER	7	REISSUED FOR SITE
	OBC SB-2, c/w STC RATING: min 55, OBC SB-3, W6d	8	ISSUED FOR PERMIT
91	• 2 LAYERS 16mm TYPE 'X' GYPSUM BOARD • 92mm or 152mm STEEL STUDS @ 400mm o/c, c/w FULL	9	ISSUED FOR COORD
	 DEPTH MINERAL FIBRE INSULATION 2 LAYERS 16mm TYPE 'X' GYPSUM BOARD 	10	ISSUED FOR COORD
	1.5 HOUR FRR ACHIEVED THROUGH ULC W453		
	STC RATING: 59, OBC SB-3, S9a		
	NOTE: 16mm TYPE 'X' GYPSUM BOARD PERMITTED TO BE SUBSTITUTED w/ 13mm TYPE 'X' GYPSUM BOARD UNDER		
\square	OBC SB-2, c/w STC RATING: 57, OBC SB-3, S9b		
	SHAFT WALL • 2 LAYERS 16mm TYPE 'X' GYPSUM BOARD		
	 64mm C-H STUDS @ 600mm o/c c/w 25mm GYPSUM LINER PANEL 		
	2 HOUR FRR ACHIEVED THROUGH ULC W446 SYSTEM F		
-	EXTERIOR WALL ASSEMBLY NOTES & LEGEND:		
-			
	2x LAYER OF 13mm TYPE 'X' GYPSUM BOARD c/w 13mm RESILIENT FURRING CHANNELS @		
	600mm o/c 2x LAYER OF 13mm TYPE 'X' GYPSUM BOARD		
	1 HOUR FRR ACHIEVED THROUGH OBC SB-2.		
	EXTERIOR WALL ASSEMBLIES:		
Ī			
	90mm MASONRY VENEER (REFER TO ELEVATIONS AND SPECIFICATIONS FOR TYPE)		
	 25mm - 41mm AIR SPACE (SEE ASSEMBLY LEGEND) 50mm RIGID INSULATION (Rsi 1.8 / R10ci) 		
	 AIR BARRIER SHEATHING (REFER TO ELEVATIONS + STRUCTURAL FOR SHEAR-WALL OCATIONS & REQUIREMENTS) 		
	 FOR SHEAR-WALL LOCATIONS & REQUIREMENTS) 38x140 WOOD STUDS (REFER TO STRUCTURAL) c/w FULL DEPTH INSULATION (Rsi 3.5 / R20) 		
	 VAPOUR BARRIER 16mm TYPE 'X' GYPSUM BOARD 		
	EXTERIOR WALL (METAL SIDING)		
	• METAL SIDING		
	 75mm Z-BARS (ORIENTED PERPENDICULAR TO SIDING) @ 600mm o/c c/w 50mm RIGID INSULATION (Rsi 		
	 1.8 / R10ci) AIR BARRIER SHEATHING (REFER TO ELEVATIONS + STRUCTURAL 	CLIE	NT
	 SHEATHING (REFER TO ELEVATIONS + STRUCTURAL FOR SHEAR-WALL LOCATIONS & REQUIREMENTS) 38x140 WOOD STUDS (REFER TO STRUCTURAL) c/w 		NDRIC HOM
	 38x140 WOOD STUDS (REFER TO STRUCTURAL) c/w FULL DEPTH INSULATION (Rsi 3.5 / R20) VAPOUR BARRIER 	TEL:	819-593-4805
	 13mm RESILIENT FURRING CHANNEL @ 600mm o/c (WHERE INDICATED ON FLOOR PLANS) 		CYRVILLE RD, SUITE 20 AWA, ON, K1J 7S6
	 13mm TYPE 'X' GYPSUM BOARD (2x LAYER WHERE INDICATED ON FLOOR PLANS) 		
	EW3 BALCONY WING WALL		
	CLADDING* AIR BARRIER		
	 SHEATHING (REFER TO STRUCTURAL FOR SHEAR-WALL LOCATIONS & REQUIREMENTS) 		
	 38x140 WOOD STUDS (REFER TO STRUCTURAL) c/w FULL DEPTH INSULATION 		
	2x16mm ORIENTED STRAND BOARD SHEATHING AIR BARRIER		
		Α	GROUP O
	*NOTE: CLADDING TO BE THE ONE OF THE FOLLOWING (REFER TO PLANS AND ELEVATIONS FOR LOCATIONS:		01-1339 WELLINGTON S
	 90mm MASONRY VENEER (REFER TO ELEVATIONS AND SPECIFICATIONS FOR TYPE) 		
	25mm AIR SPACE OR -		JECT TITLE LPARK APA
	 ALUMINUM COMPOSITE PANEL 19x64 VERTICAL FURRING @ 600mm o/c & TO SUIT 	70 &	80 SILO STREET
	PANEL MOUNTING REQUIREMENTS • 75mm Z-BARS @ 600mm o/c		AWA (ORLEANS), ON
	EXTERIOR WALL (PODIUM, NORTH)	DRAV	
	 VERTICAL METAL SIDING 135mm HORIZONTAL Z-BARS @ 600mm o/c c/w 100mm 		ROOF A WES1
	RIGID INSULATION (Rsi 3.6 / R20ci) AIR / VAPOUR BARRIER	~	
	 16mm EXTERIOR GRADE GYPSUM BOARD SHEATHING 38x184 WOOD STUDS @ 400mm o/c 	001	Г. 2019 IC DR
	16mm TYPE 'X' GYPSUM BOARD		


- INGS; ONLY FIGURED DIMENSIONS ERE DOUBT EXISTS; FILE REQUEST AND REQUEST CLARITY. NSIBILITY OF THE GENERAL
- RIFY DIMENSIONS ON SITE; REPORT HE ARCHITECT PROMPTLY. TOR TO TAKE INTO ACCOUNT
- RANCE; GENERAL CONTRACTOR WORK OF DIFFERENT TRADES TO I INTENT.
- IBED IN THESE DRAWINGS AND TO COMPLY WITH THE CURRENT TARIO BUILDING CODE (2012) OR CODE (2010) INCLUDING MOST
- FICATIONS ARE COMPLEMENTARY TOGETHER.

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ISSUE RECORD:				
NO.	DESCRIPTION	DATE		
1	ISSUED FOR PRECONSULTATION	2020-02-07		
2	ISSUED FOR CLIENT REVIEW	2020-03-17		
3	ISSUED FOR CONSULTANT COORD.	2020-03-30		
4	ISSUED FOR COORDINATION	2020-06-12		
5	ISSUED FOR SITE PLAN APPLICATION	2020-06-29		
6	ISSUED FOR 50% COORDINATION	2020-10-06		
7	REISSUED FOR SITE PLAN APPLICATION	2020-10-15		
8	ISSUED FOR PERMIT	2020-11-06		
9	ISSUED FOR COORDINATION	2020-11-26		
10	ISSUED FOR COORDINATION	2021-01-29		

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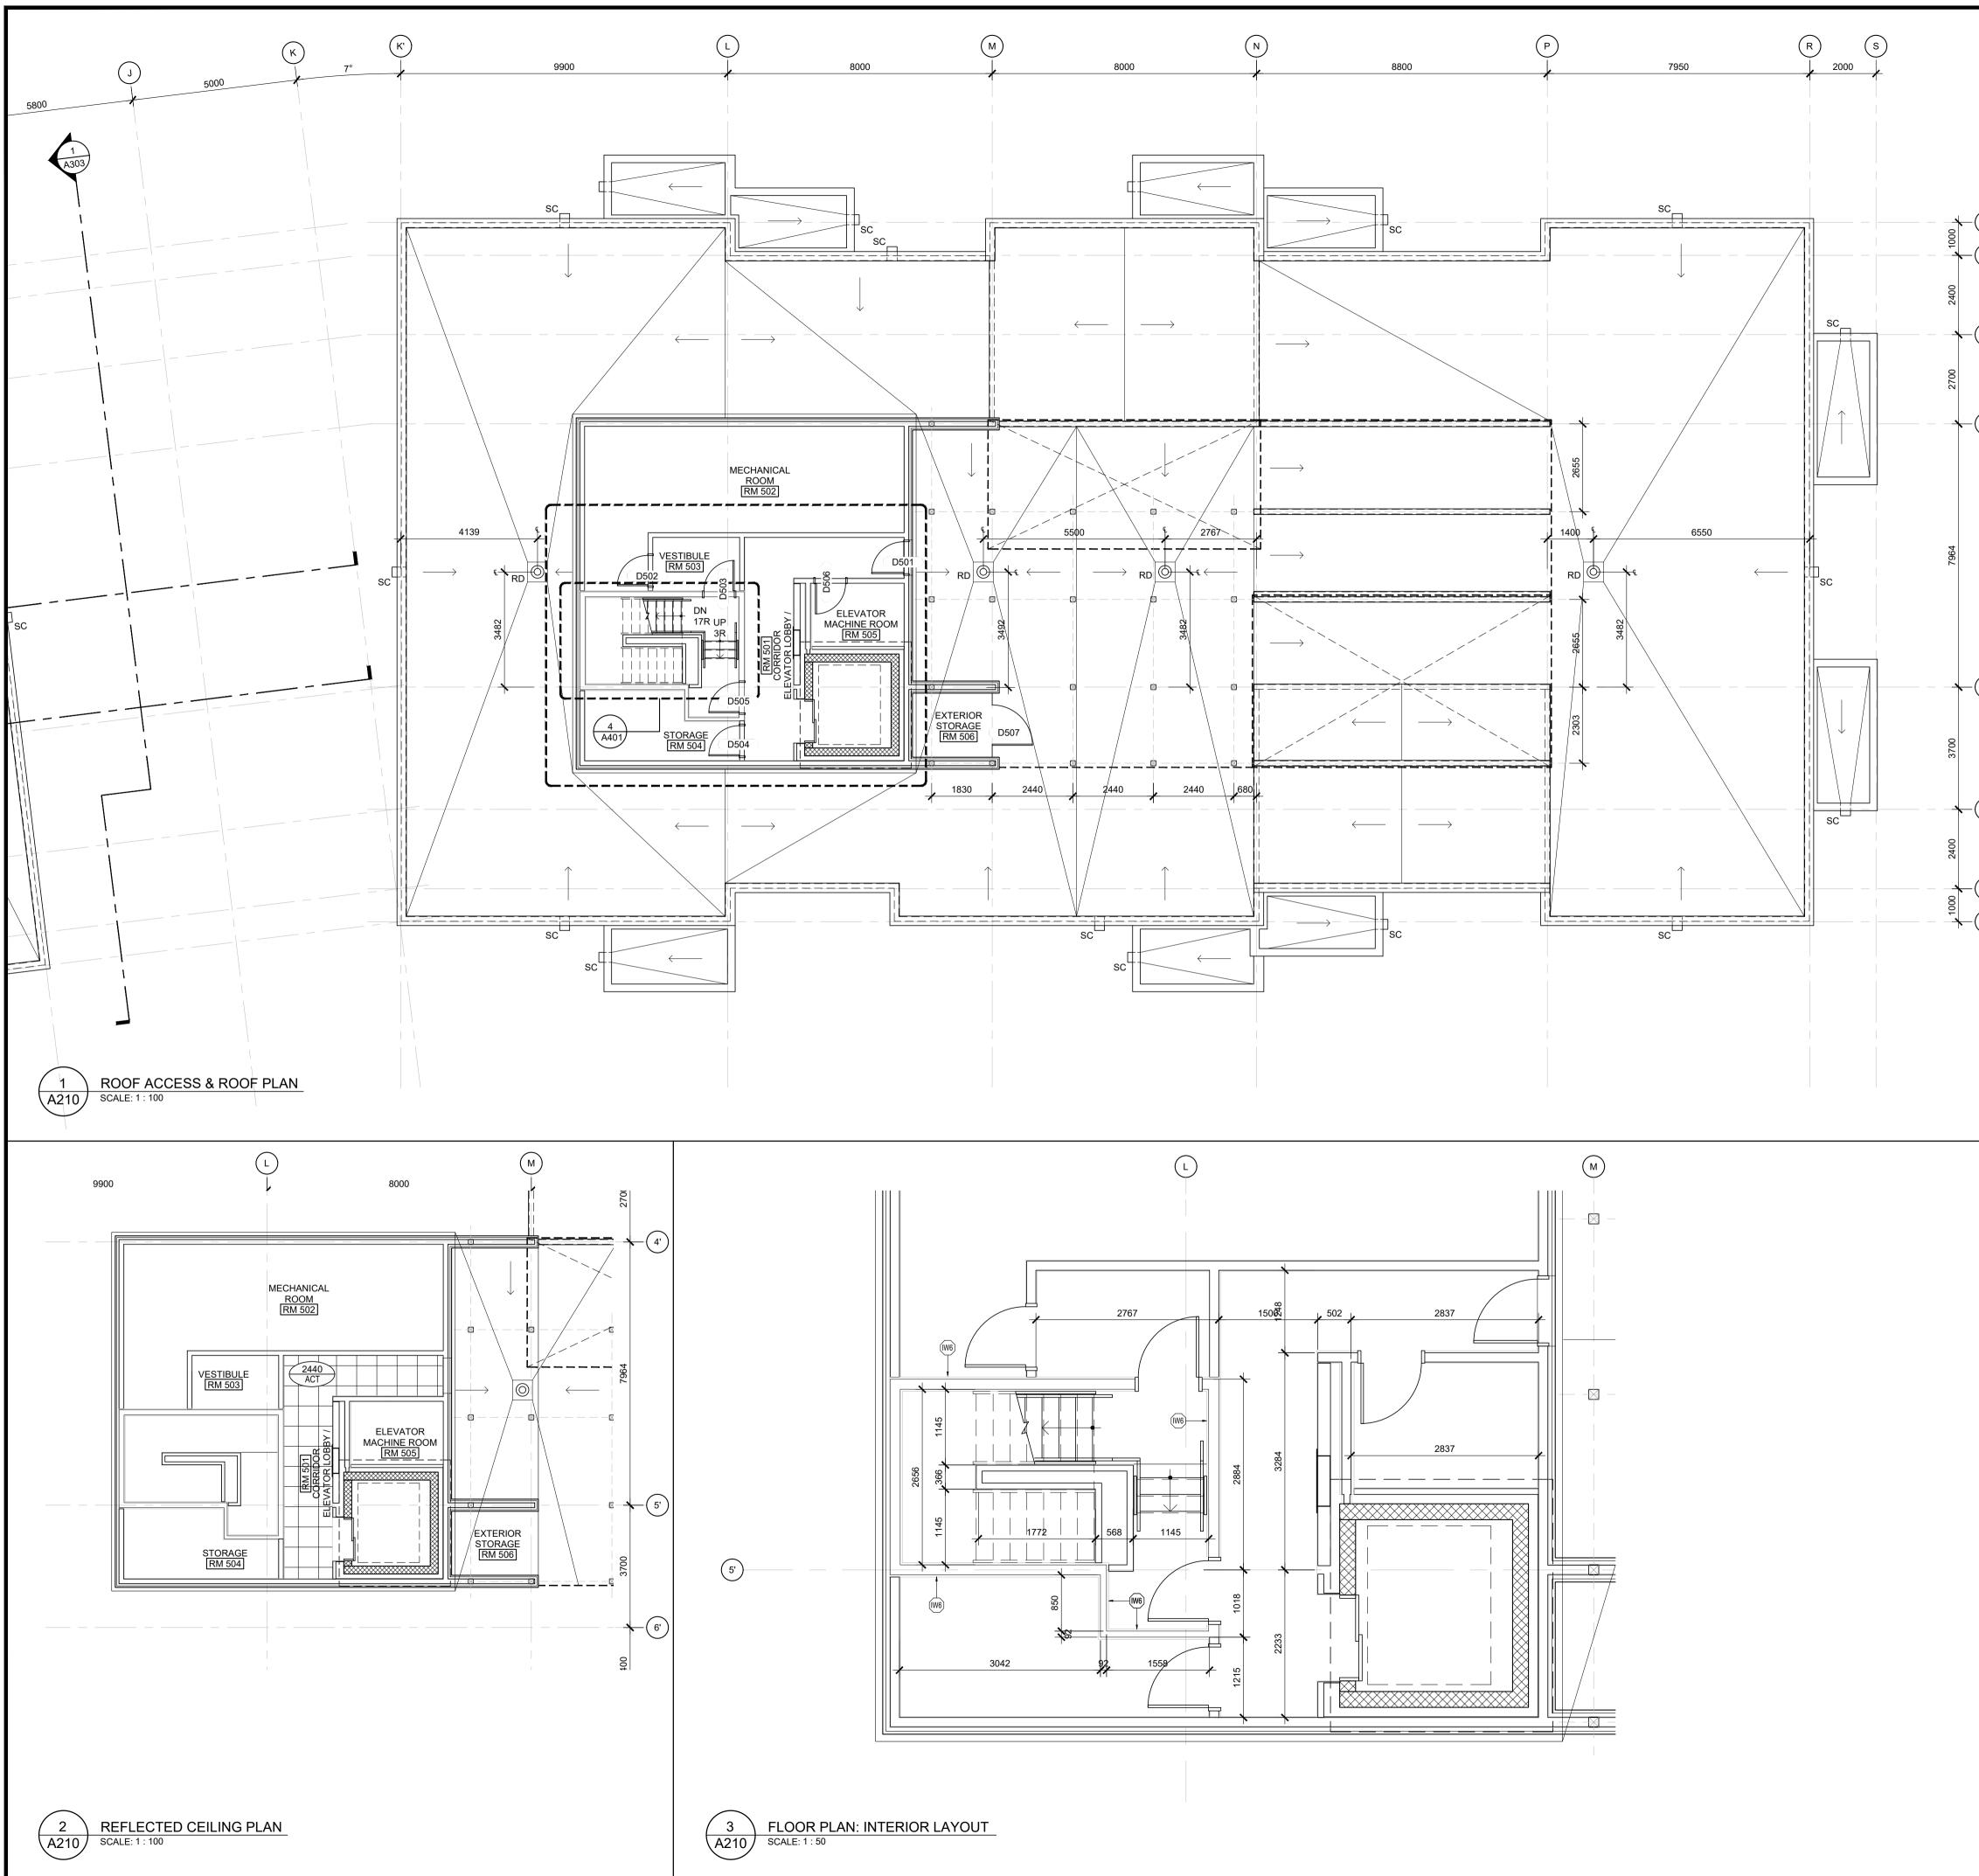


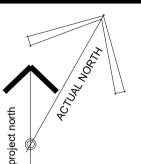

ROOF ACCESS PLAN: WEST BUILDING								
DATE OCT. 2019	DRAWN IC DR	JOB NO.	DRAWING NO.					
SCALE AS NOTED	REVIEWED TD	3206	AZTU					

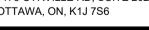D07-12-20-0104

ARCHITECTURAL



	WALL ASSEMBLY FRR LEGEND:	<u>GEN</u>	ERAL NOTES	
-	======= 1.5 HOUR FIRE RESISTANCE RATING, REFER	1. DO NOT SCALE DRAWINGS; ONLY FIGURED DIMENSIO ARE TO BE USED. WHERE DOUBT EXISTS; FILE REQUE FOR INTERPRETATION AND REQUEST CLARITY.		
	TO ASSEMBLY SCHEDULE			TY.
	HOUR FIRE RESISTANCE RATING, REFER TO ASSEMBLY SCHEDULE	 IT IS THE RESPONSIBILITY OF THE GENERAL CONTRACTOR TO VERIFY DIMENSIONS ON SITE; REPOR DISCREPANCIES TO THE ARCHITECT PROMPTLY. GENERAL CONTRACTOR TO TAKE INTO ACCOUNT CONSTRUCTION TOLERANCE; GENERAL CONTRACTOR TO COORDINATE THE WORK OF DIFFERENT TRADES TO 		
	WHERE OBC SB-2 IS REFERENCED TO ACHIEVE THE REQUIRED MINIMUM FRR, THE FOLLOWING COMPONENT			
	RATINGS WERE USED VIA THE ADDITIVE METHOD:			
	2x13mm TYPE 'X' GYPSUM BOARD: 80 min (TABLE 2.3.4 A) 16mm TYPE 'X' GYPSUM BOARD: 40 min (TABLE 2.3.4 A)	4. /	COMPLY WITH DESIGN INTENT. ALL WORK DESCRIBED IN THESE DRA	
	13mm TYPE 'X' GYPSUM BOARD:40 min (TABLE 2.3.4 A)13mm TYPE 'X' GYPSUM BOARD:25 min (TABLE 2.3.4 A)WOOD STUDS:20 min (TABLE 2.3.4 E)	E	SPECIFICATIONS ARE TO COMPLY WITH T EDITION OF THE ONTARIO BUILDING COE	DE (2012) OR
	FULL DEPTH INSULATION:20 min (TABLE 2.3.4 E)15 min (TABLE 2.3.4 G)	F	NATIONAL BUILDING CODE (2010) INCLU RECENT AMENDMENTS.	
1')	INTERIOR WALL ASSEMBLIES:		DRAWINGS AND SPECIFICATIONS ARE COM AND ARE TO BE READ TOGETHER.	PLEMENTARY
\sim	PARTY WALL	COP	YRIGHT	
2')	• 2 LAYERS 13mm TYPE 'X' GYPSUM BOARD		DRAWING IS AN INSTRUMENT OF SER	
	 13mm RESILIENT FURRING CHANNEL 38x140 WOOD STUD FRAMING @ 400mm o/c c/w FULL 	ARC	TECTED BY COPYRIGHT AND IS THE SOLE F HITECTS DCA INC. COPIES, INCLUDING	ELECTRONIC
	DEPTH INSULATION *2 LAYERS 16mm TYPE 'X' GYPSUM BOARD	FOR	ES MAY ONLY BE USED FOR THE PURPOS THE SINGLE PROJECT FOR WHICH THEY	ARE ISSUED
3')	1 HOUR FRR ACHIEVED THROUGH OBC SB-2.	WITH	MAY NOT BE OFFERED FOR SALE OF OUT THE EXPRESS WRITTEN PERMISS	
	STC RATING: 53, OBC SB-3, W6c	ARCI	HITECT.	
	* NOTE: MAKE THE FOLLOWING SUBSTITUTION AT SHEAR-WALLS (REFER TO STRUCTURAL) • 2 LAYERS STRUCTURAL SHEATHING			
	16mm TYPE 'X' GYPSUM BOARD		The second secon	
4')			AC/Liqu NoPrix	
	 16mm TYPE 'X' GYPSUM BOARD 38x89 or 140 WOOD STUD FRAMING @ 400mm o/c c/w 	•		
	 FULL DEPTH INSULATION 16mm TYPE 'X' GYPSUM BOARD 		AC	
	1 HOUR FRR ACHIEVED THROUGH OBC SB-2.			
	INTERIOR WALL • 16mm GYPSUM BOARD		۵.	
	 38x89 or 140 WOOD STUD FRAMING @ 400mm o/c 16mm GYPSUM BOARD 	ISSU	JE RECORD:	
		NO.	DESCRIPTION	DATE
	 16mm GYPSUM BOARD 38x89, 140 or 184 WOOD STUD FRAMING @ 400mm o/c 	1	ISSUED FOR PRECONSULTATION	2020-02-07
		2	ISSUED FOR CLIENT REVIEW	2020-03-17
	2 LAYERS TORM TYPE X GYPSUM BOARD 13mm RESILIENT FURRING CHANNEL @ 600mm o/c	3	ISSUED FOR CONSULTANT COORD.	2020-03-30
	 140mm WOOD STUDS (REFER TO STRUCTURAL) c/w FULL DEPTH INSULATION 	4	ISSUED FOR COORDINATION	2020-06-12
	2 LAYERS 16mm TYPE 'X' GYPSUM BOARD	5	ISSUED FOR SITE PLAN APPLICATION	2020-06-29
5'	1 HOUR FRR ACHIEVED THROUGH ULC U334 STC RATING: 62	6	ISSUED FOR 50% COORDINATION	2020-10-06
<u> </u>	NOTE: 16mm TYPE 'X' GYPSUM BOARD PERMITTED TO BE SUBSTITUTED w/ 13mm TYPE 'X' GYPSUM BOARD UNDER	7	REISSUED FOR SITE PLAN APPLICATION	2020-10-15
	OBC SB-2, c/w STC RATING: min 55, OBC SB-3, W6d	8	ISSUED FOR PERMIT	2020-11-06
	STAIR ENCLOSURE WALL • 2 LAYERS 16mm TYPE 'X' GYPSUM BOARD	9	ISSUED FOR COORDINATION	2020-11-26
	 92mm or 152mm STEEL STUDS @ 400mm o/c, c/w FULL DEPTH MINERAL FIBRE INSULATION 	10	ISSUED FOR COORDINATION	2021-01-29
\frown	2 LAYERS 16mm TYPE 'X' GYPSUM BOARD			
6'	1.5 HOUR FRR ACHIEVED THROUGH ULC W453			
	STC RATING: 59, OBC SB-3, S9a			
	NOTE: 16mm TYPE 'X' GYPSUM BOARD PERMITTED TO BE SUBSTITUTED w/ 13mm TYPE 'X' GYPSUM BOARD UNDER			
7'	OBC SB-2, c/w STC RATING: 57, OBC SB-3, S9b			
\sim	SHAFT WALL • 2 LAYERS 16mm TYPE 'X' GYPSUM BOARD			
8')	 64mm C-H STUDS @ 600mm o/c c/w 25mm GYPSUM LINER PANEL 			
	2 HOUR FRR ACHIEVED THROUGH ULC W446 SYSTEM F			
	EXTERIOR WALL ASSEMBLY NOTES & LEGEND:			
	2x LAYER OF 13mm TYPE 'X' GYPSUM BOARD c/w 13mm RESILIENT FURRING CHANNELS @			
	600mm o/c			
	2x LAYER OF 13mm TYPE 'X' GYPSUM BOARD 1 HOUR FRR ACHIEVED THROUGH OBC SB-2.			
ŀ				
-	EXTERIOR WALL ASSEMBLIES:			
	EXTERIOR WALL (MASONRY) 90mm MASONRY VENEER (REFER TO ELEVATIONS			
	AND SPECIFICATIONS FOR TYPE)			
	 25mm - 41mm AIR SPACE (SEE ASSEMBLY LEGEND) 50mm RIGID INSULATION (Rsi 1.8 / R10ci) AIR BARBIER 			
	 AIR BARRIER SHEATHING (REFER TO ELEVATIONS + STRUCTURAL FOR SHEAR-WALL LOCATIONS & REQUIREMENTS) 			
	 38x140 WOOD STUDS (REFER TO STRUCTURAL) c/w FULL DEPTH INSULATION (Rsi 3.5 / R20) 	1		
	 VAPOUR BARRIER 16mm TYPE 'X' GYPSUM BOARD 			
	EXTERIOR WALL (METAL SIDING)			
	 METAL SIDING 75mm Z-BARS (ORIENTED PERPENDICULAR TO SIDING) @ 600mm o/c c/w 50mm RIGID INSULATION (Rsi 			
	1.8 / R10ci)			
	 AIR BARRIER SHEATHING (REFER TO ELEVATIONS + STRUCTURAL FOR SHEAR-WALL OCATIONS & REQUIREMENTS) 	CLIE		
	 FOR SHEAR-WALL LOCATIONS & REQUIREMENTS) 38x140 WOOD STUDS (REFER TO STRUCTURAL) c/w EULL DEPTH INSULATION (Rei 3.5 / R20) 		NDRIC HOMES	
	 FULL DEPTH INSULATION (Rsi 3.5 / R20) VAPOUR BARRIER 13mm RESULENT EURPING CHANNEL @ 600mm c/o 	1173	819-593-4805 CYRVILLE RD, SUITE 202	
	13mm RESILIENT FURRING CHANNEL @ 600mm o/c (WHERE INDICATED ON FLOOR PLANS) 13mm TVPE 'X' CYPSUM BOARD (2x LAYER WHERE	OTT	AWA, ON, K1J 7S6	
	 13mm TYPE 'X' GYPSUM BOARD (2x LAYER WHERE INDICATED ON FLOOR PLANS) 			
	EW3 BALCONY WING WALL			$\mathbf{\Lambda}$
	CLADDING* AIR BARRIER			
	 SHEATHING (REFER TO STRUCTURAL FOR SHEAR-WALL LOCATIONS & REQUIREMENTS) 			
	 38x140 WOOD STUDS (REFER TO STRUCTURAL) c/w FULL DEPTH INSULATION 			
	 2x16mm ORIENTED STRAND BOARD SHEATHING AIR BARRIER 			
	CLADDING*			TECTS
	*NOTE: CLADDING TO BE THE ONE OF THE FOLLOWING (REFER TO PLANS AND ELEVATIONS FOR LOCATIONS:		01-1339 WELLINGTON ST. WEST OTTAWA O	
	90mm MASONRY VENEER (REFER TO ELEVATIONS	WWW.ARCHITECTSDCA.COM 613.725.2294		
	AND SPECIFICATIONS FOR TYPE) • 25mm AIR SPACE			
	- OR - • ALUMINUM COMPOSITE PANEL		LPARK APARTMENTS	
	 19x64 VERTICAL FURRING @ 600mm o/c & TO SUIT PANEL MOUNTING REQUIREMENTS 		80 SILO STREET AWA (ORLEANS), ON	
	• 75mm Z-BARS @ 600mm o/c		WING TITLE	
		D0mm o/c c/w 100mm ROOF ACCESS PLAN: EAST BUILDING		۷:
	 VERTICAL METAL SIDING 135mm HORIZONTAL Z-BARS @ 600mm o/c c/w 100mm 			
	RIGID INSULATION (Rsi 3.6 / R20ci) AIR / VAPOUR BARRIER AIR / VAPOUR BARRIER	П	ATE DRAWN JOB NO. D	RAWING NO.
	 16mm EXTERIOR GRADE GYPSUM BOARD SHEATHING 38x184 WOOD STUDS @ 400mm o/c 16mm TYPE 'X' GYPSUM BOARD 	OCT	T. 2019 IC DR 3206	A211
	16mm TYPE 'X' GYPSUM BOARD		NOTED TD	

DRAWING NO. A211

ARCHITECTURAL

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