

Scale: 1:500

	PLANT LIST - TREES						PLANT LIST - SHRUBS						
ORIGIN	Ht	ID	NO BOTANICAL NAME		SIZE	REMARKS	ORIGIN	ID	NO BOTANICAL NAME	COMMON NAME	SIZE	REM	EMARKS
		STAN	DARD PLANTING					STAN	IDARD PLANTING				
			57 Large Deciduous Trees						460 Shrubs				
Ntv H	0	ArAS	3 Acer rubrum 'Autumn Spire'	Red Maple	50mm caliper	WB, Staked	Ntv	Cr	8 Cornus racemosa	Gray Dogwood	50 cm ht.	Bar	are root
Ntv	0	As	4 Acer saccharum	Sugar Maple	70mm caliper	WB Staked	Ntv H	HaA	10 Hydrangea arborescens 'Annabelle		2 gallon p	ot Pot	otted
Ntv	0	Со	5 Celtis occidentalis	Common Hackberry	60mm caliper	WB, Staked	Nt∨	Нр	20 Hypericum prolificum	Shrubby St. John's Wort	2 gallon p		otted
Non N	0	GbAG	3 Ginkgo biloba 'Autumn Gold'	Autumn Gold Maidenhair Tree	60mm caliper	WB, Staked	Nt∨ H	JsM	16 Juniperus scopulorum `Medora`	Medora Juniper	125cm ht	Pot	otted
Ntv	0	Qma	6 Quercus macrocarpa	Bur Oak	70mm caliper	WB, Staked	Ntv H	JsMG	i 11 Juniperus scopulorum 'Moonglow'	Moonglow Juniper	125cm ht	Pot	otted
Ntv	0	Qr	4 Quercus rubra	Northern Red Oak	70mm caliper	WB Staked	Nt∨ H	PfGD	51 Potentilla fruticosa 'Gold Drop'	Goldfinger Potentilla	2 gallon p	ot Pot	otted
Ntv H	0	UaVF	3 Ulmus americana 'Valley Forge'	Valley Forge Elm	60mm caliper	WB, Staked	Non N	PmT	3 Pinus mugo 'Big Tuna'	Big Tuna Mugho Pine	75cm ht.		otted
			²⁰ Medium Deciduous Trees				Nt∨ H	PoLD		I' Little Devil Ninebark	2 gallon p	ot Pot	otted
Ntv	0	Ag	4 Aesculus glabra	Ohio Buckeye	50mm caliper	WB, Staked	Nt∨	Rp	12 Rosa palustrus	Swamp Rose	50 cm ht.	Bar	are root
Ntv H	0	GtD	6 Gleditsia triacanthos inermis 'Draves		60mm caliper	WB, Staked		Rr	109 Rosa rugosa	Japanese Rose	3 year		otted
Ntv	0	Sd	6 Sorbus decora	Showy Mountain Ash	45mm caliper	WB, Staked	Nt∨	Rt	4 Rhus typhina	Staghorn Sumac	80cm ht.		otted
Non N	0	UF	4 Ulmus minor x parvifolia 'Frontier'	Frontier Elm	60mm caliper	WB, Staked		SbG	114 Spiraea bumalda 'Goldflame'	Goldflame Spirea	50cm ht		otted
			³⁵ Columnar Deciduous Trees		·			ToF	17 Thuja occidentalis 'Fastigiata'	Pyramidal Arborvitae	175cm ht		otted
Nt∨ H	0	ArRR	18 Acer rubrum 'Red Rocket	Red Rocket Red Maple (Columnar)	70mm caliper	WB, Staked	Ntv H	ТоН	12 Thuja occidentalis 'Holmstrup'	Holmstrup Eastern Arborvitae	150 cm ht	Pot	otted
Ntv H	0	CoPS	2 Celtis occidentalis 'Prairie Sentinel'	Prairie Sentinel Hackberry (Columnar)	60mm caliper	WB, Staked							
Non N	0	GbPS	6 Ginkgo biloba 'Princeton Sentry'	Princeton Sentry Maidenhair Tree (Columnal		WB, Staked	PLAN	IT LIS	ST - PERENNIALS				
Non N	0	QrF	9 Quercus robur 'Fastigiata'	Skyrocket English Oak (Columnar)	50mm caliper	WB, Staked	ID	NO	BOTANICAL NAME	COMMON NAME	S	ZE REM	EMARKS
			4 Small Deciduous Trees			,	STAN		PLANTING				
Ntv	0	AI	3 Amelanchier laevis	Allegheny Serviceberry	45mm caliper	WB, Staked	-		9 Ornamental Grasses and Flowerin	n Perennials			
Ntv	0	Вро	1 Betula populifolia	Grey Birch	60mm caliper	WB, Staked	P∨HM		Panicum virgatum 'Heavy Metal'	Heavy Metal Switch Grass	3	year 1 ga	gallon p
	•		57 Small Ornamental Deciduous T				CaKF		Calamagrostis x acutiflora 'Karl Foerster	,,			gallon p
Nt∨ H	0	AcB	1 Amelanchier canadensis 'Ballerina'	Ballerina Serviceberry (tree form)	45mm caliper	WB, Staked	Juni	100		Beebalm, Black-eyed Susan, Bla		year r g	gailori p
Ntv H	0	AgRH	4 Amelanchier x grandiflora 'Robin Hill		45mm caliper	WB, Staked	Pv	396	Flowering Perennials (75% min Ntv)	Flower, Blazing Star, Coneflower,			
Ntv H	0	BnFV	12 Betula nigra 'Little King'	Fox Valley River Birch	200cm ht.	Potted			3 (, , ,	Evening Primrose, Sea pink, etc.			
Ntv H	0	CcgC		a' Thornless Crusader Cockspur Hawthorn	45mm caliper	WB, Staked							
Ntv	0	Hvi	4 Hamamelis virginiana	Virginia Witch Hazel	45mm caliper	WB, Staked		39	6 Perennials - autocount				
Non N	0	MHG	5 Malus x `Harvest Gold`	Harvest Gold Crabapple	50mm caliper	WB, Staked	Ер	99	Echinacea purpurea	Purple Coneflower		150	5cm pot
Non N	0	MR	10 Malus x `Royalty`	Royalty Crabapple	45mm caliper		He	99		Daylily			5cm pot
Non N	0	SrIP	2 Syringa reticulata 'Ivory Pillar'	Ivory Pillar Tree Lilac	45mm caliper		ls			Siberian Iris			5cm pot
Ntv	0	VlaT	6 Viburnum lantana (t)	Wayfarer Tree	125cm ht.	Potted	RfG		Rudbeckia fulgida 'Goldsturm'	Goldsturm Black Eyed Susan			5cm pot
Ntv	0	VIT	6 Viburnum lentago (t)	Nannyberry Tree	125cm ht.	Potted							[
	-		⁸ Conifers										
Nt∨	0	Рр	2 Picea pungens	Colorado Spruce	200cm ht.	WB, Staked							
Ntv	0	Pr	2 Pinus resinosa	Red Pine	200cm ht.	WB, Staked							
	-	Ps	4 Pinus strobus	Eastern White Pine	200cm ht.	WB, Staked							

L	E	G











GEND

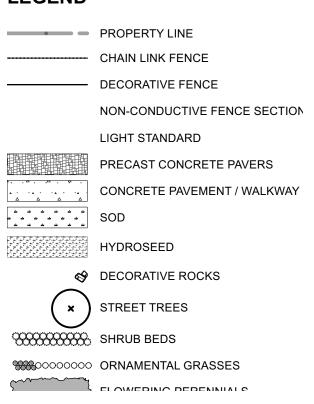


APPROVED By Allison Hamlin at 11:40 am, Jan 17, 2024


Hamlin

ALLISON HAMLIN MANAGER (A), DEVELOPMENT REVIEW WEST PLANNING, REAL ESTATE & ECONOMIC DEVELOPMENT DEPARTMENT, CITY OF OTTAWA

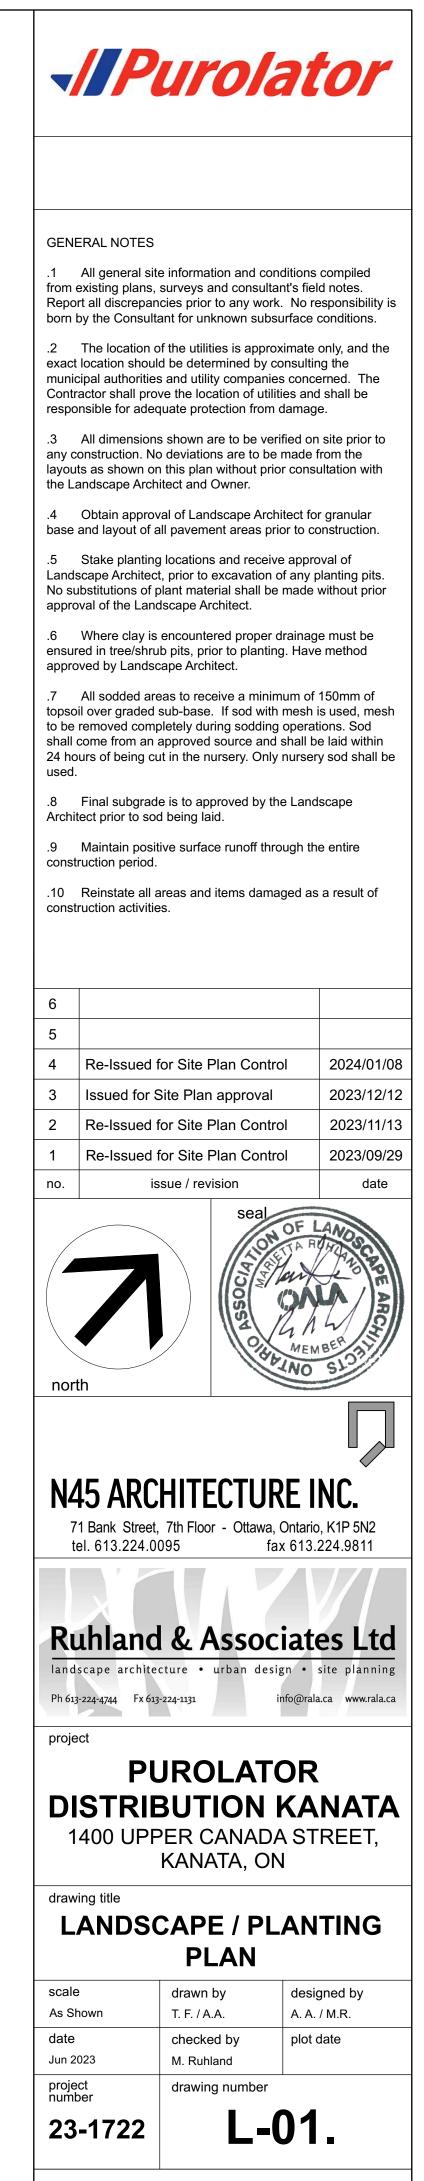

Contractor to check and verify all dimensions on the job

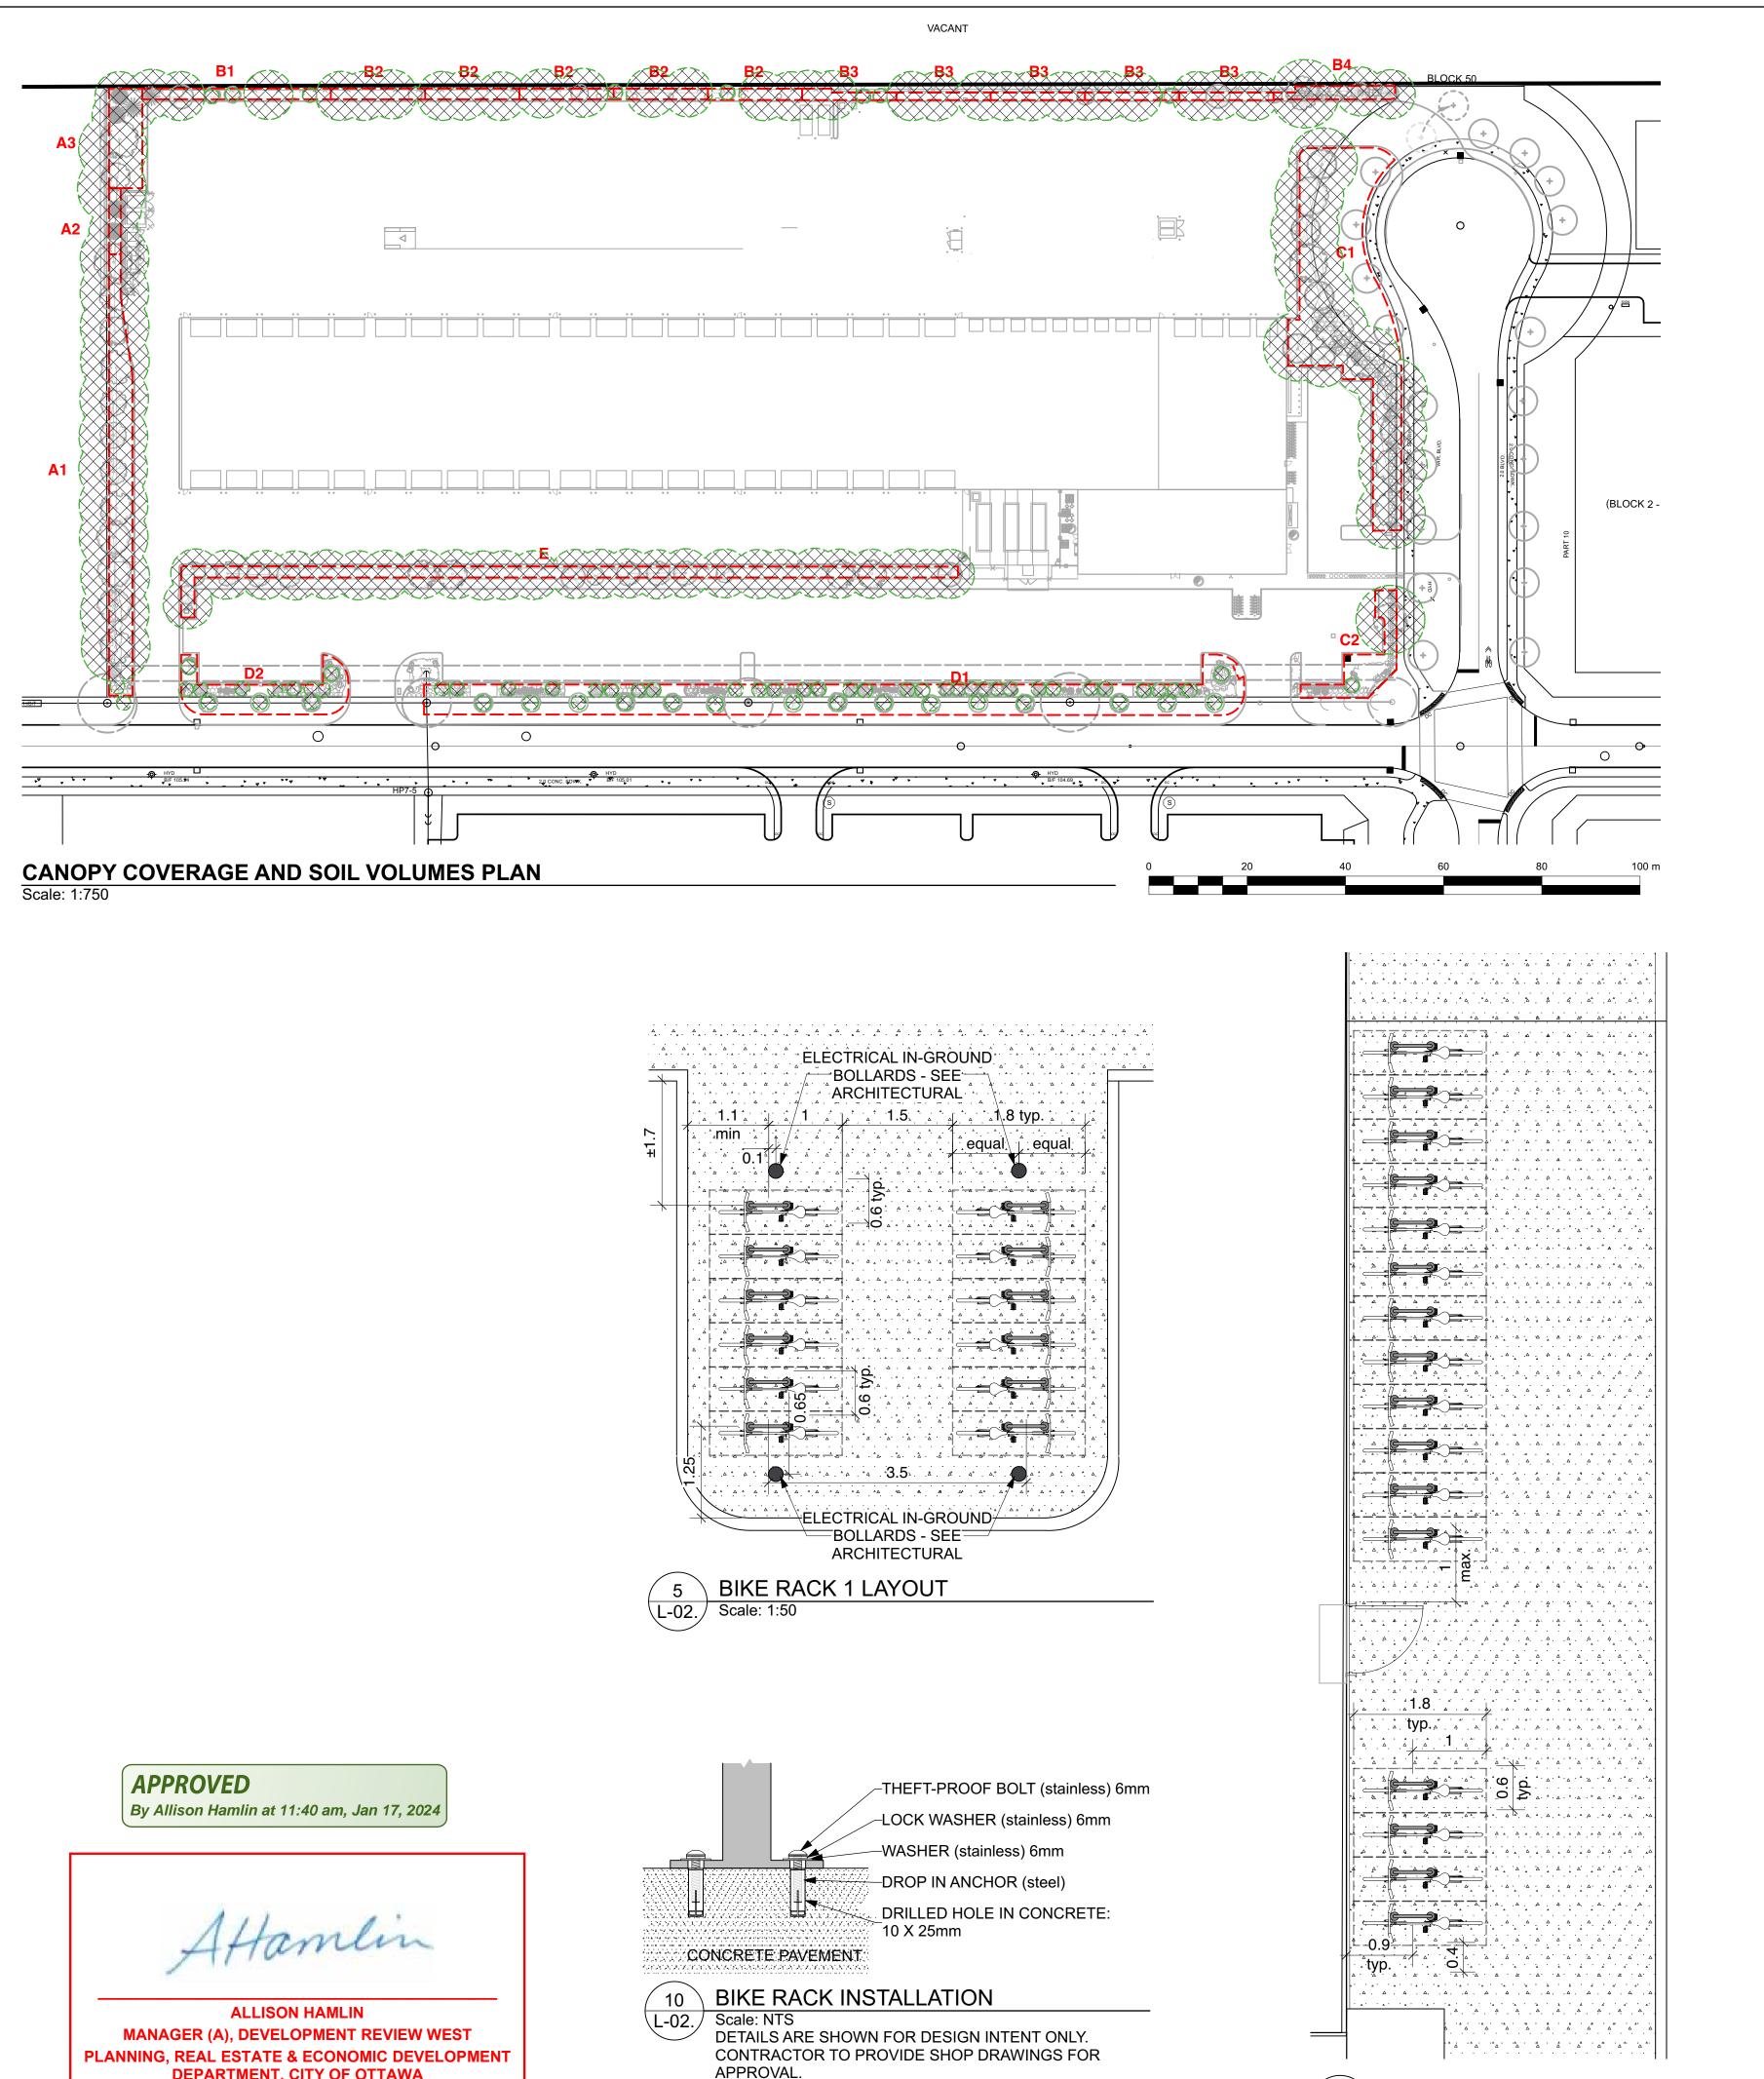

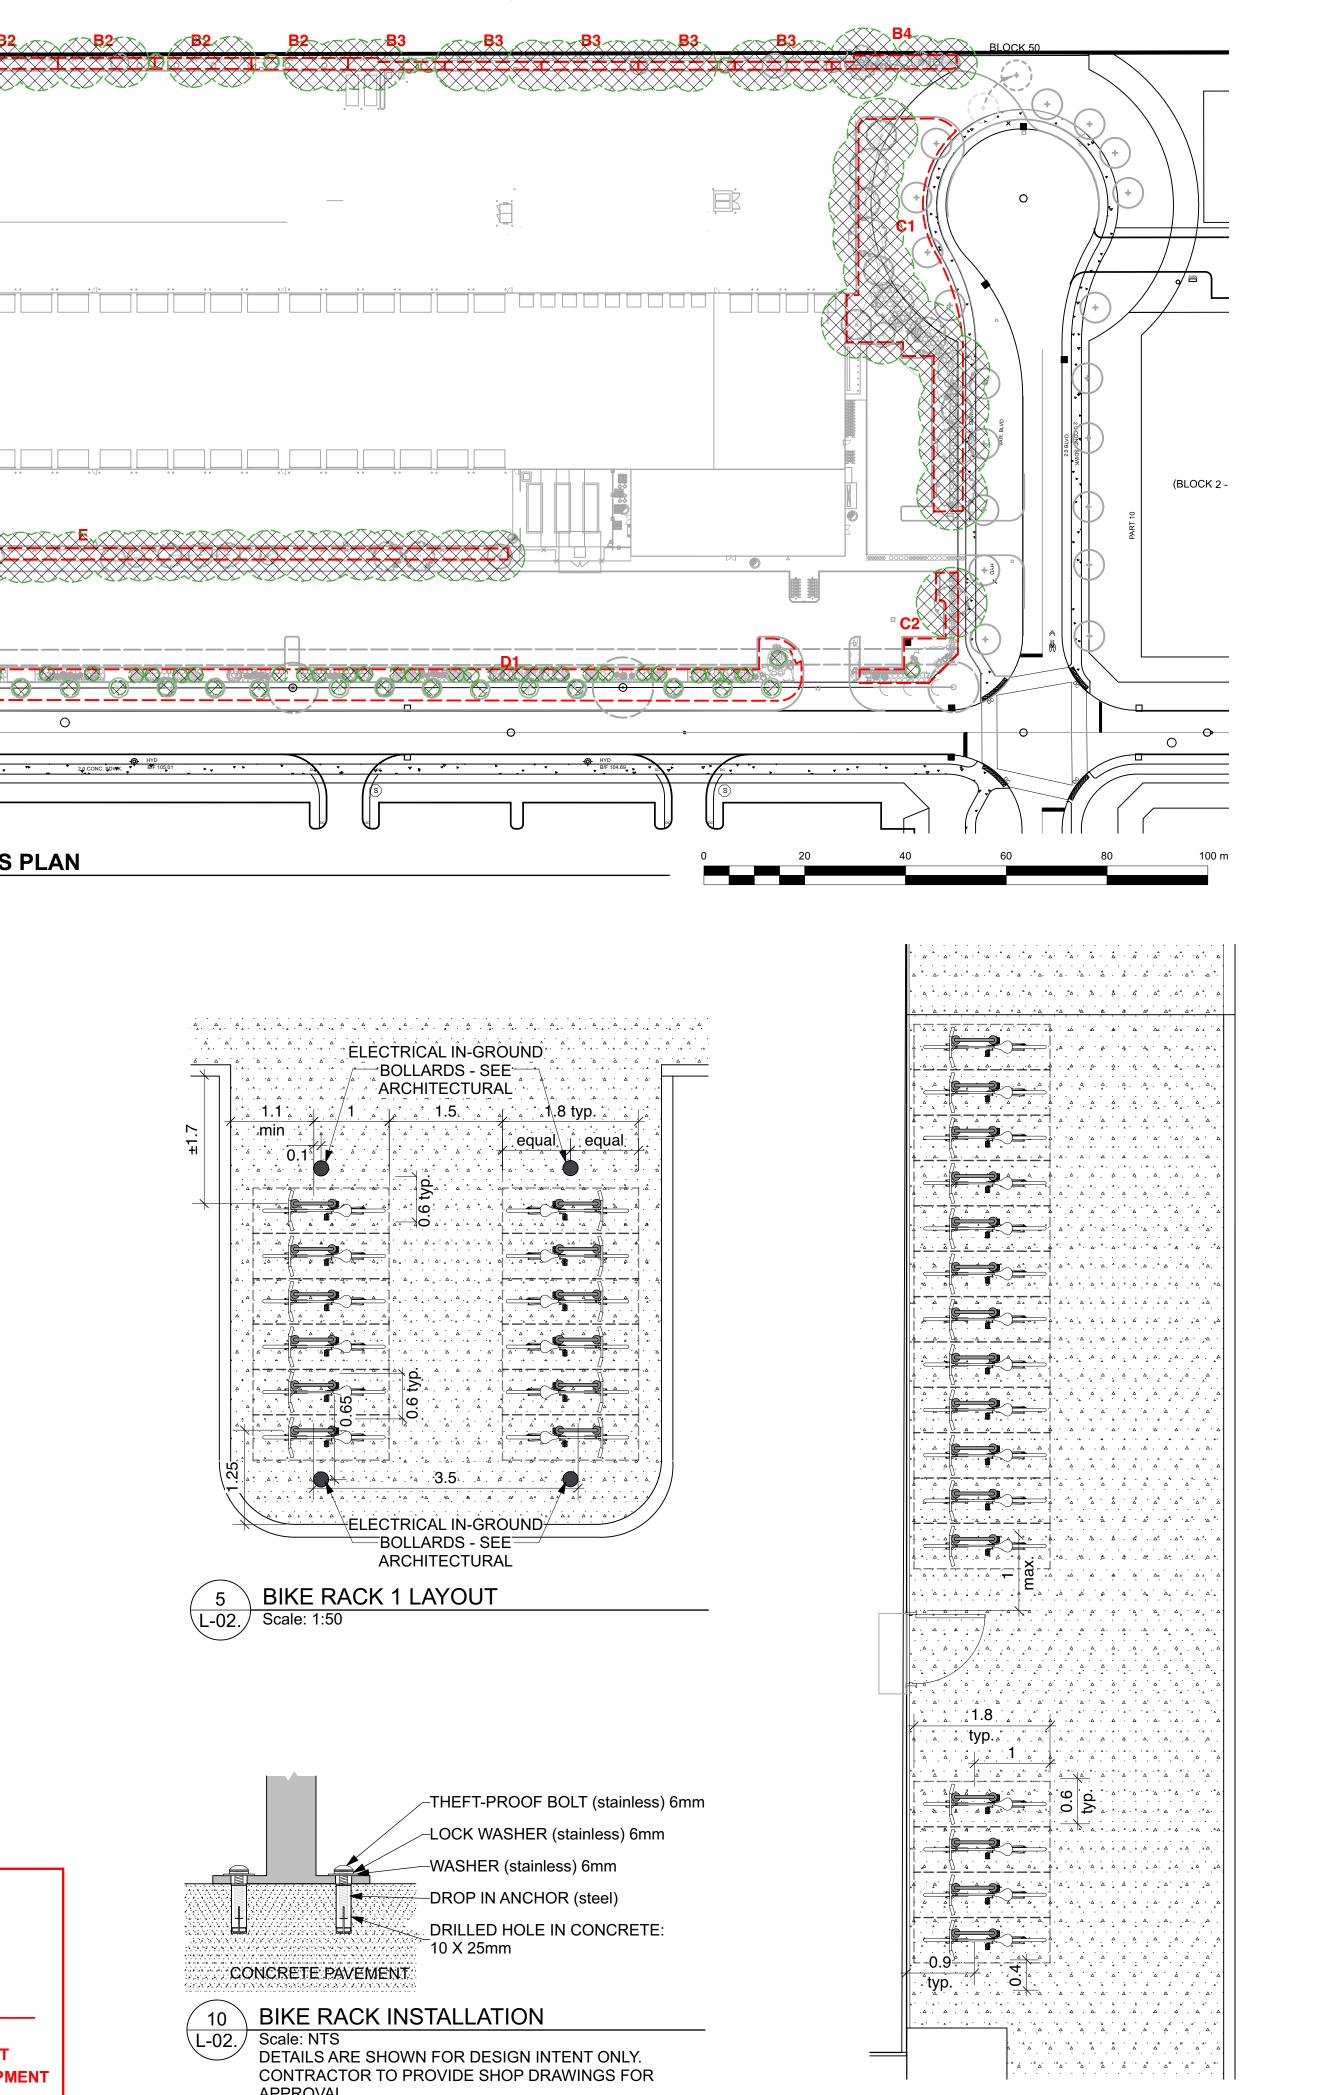


BIKE RACK 2 LAYOUT

11

L-02. Scale: 1:50

DEPARTMENT, CITY OF OTTAWA

	E SOIL VOLUME AREA E CANOPY		TREE CANOPY CON TOTAL CANOPY AREA TOTAL SITE AREA PERCENT COVERAGE		/ERAGE 7115 m2 31953 m2 22.3%	
Soil Volume	e Area, Tree Quantity and Size	Tree Quantity	OTTAWA Target Soil Volume (m ³)	Design Soil Volume	Soil Adequacy percentage	
AREA A1 -	12 large trees, 1 small ornamental tree	e (15cm Ø)*				
plant bed (380	sq m x 0.6 metre deep)	13	221.6	228.0	103%	
AREA A2 -	2 conifers (continuous)					
plant bed (32 s	sq m x 0.8 metre deep)	24	30.0	25.6	85%	
AREA A3 -	2 large trees, 3 conifers					
plant bed (137	sq m x 0.6 metre deep)	5	81.0	82.2	101%	
AREA B1 -	1 conifer, 1 medium tree, 1 columnar t	ree, 4 small orr	namental trees	(10cm Ø)*		
plant bed (80 s	sq m x 0.9 metre deep)	7	53.0	72.0	136%	
AREA B2 -	REA B2 - 3 medium columnar trees*, 2 small ornal		(15cm Ø)* (ma	x)		
plant bed (42 s	sq m x 0.9 metre deep)	5	34.3	37.8	110%	
AREA B3 -	3 medium columnar trees*, 1 small or	namental trees	(15cm Ø)* (ma	x)		
plant bed (29 s	sq m x 0.9 metre deep)	4	28.7	26.1	91%	
AREA B4 -	1 large tree, 2 conifers, 1 ornamental t	ree				
plant bed (61 s	sq m x 0.9 metre deep)	4	57.0	54.9	96%	
AREA C1 -	12 large trees, 1 medium tree					
plant bed (575	sq m x 0.4 metre deep)	14	246.0	230.0	93%	
AREA C2 -	1 large tree, 1 small tree					
plant bed (140	sq m x 0.4 metre deep)	2	30.0	56.0	187%	
AREA D1 -	1 orn tree, 12 small orn trees (15cm Ø)*, 11 small orn	trees (10cm Ø)*, 11 small ori	n trees (8cm Ø)	
plant bed (450	sq m x 0.4 metre deep)	24	166.9	180.0	108%	
AREA D2 -	2 orn trees, 2 small ornamental trees	(150cm Ø)*, 3 s	mall ornamenta	al trees (8cm Ø	ð)*	
plant bed (96 s	sq m x 0.45 metre deep)	7	39.7	43.2	109%	
AREA E -	16 medium trees, 12 columnar trees					
plant bed (415	sq m x 0.9 metre deep)	28	348.0	373.5	107%	
	mnar trees, small ornamental trees with g ng 'How much soil to grow a big tree' by D			rubs, and colun	nnar conifers	

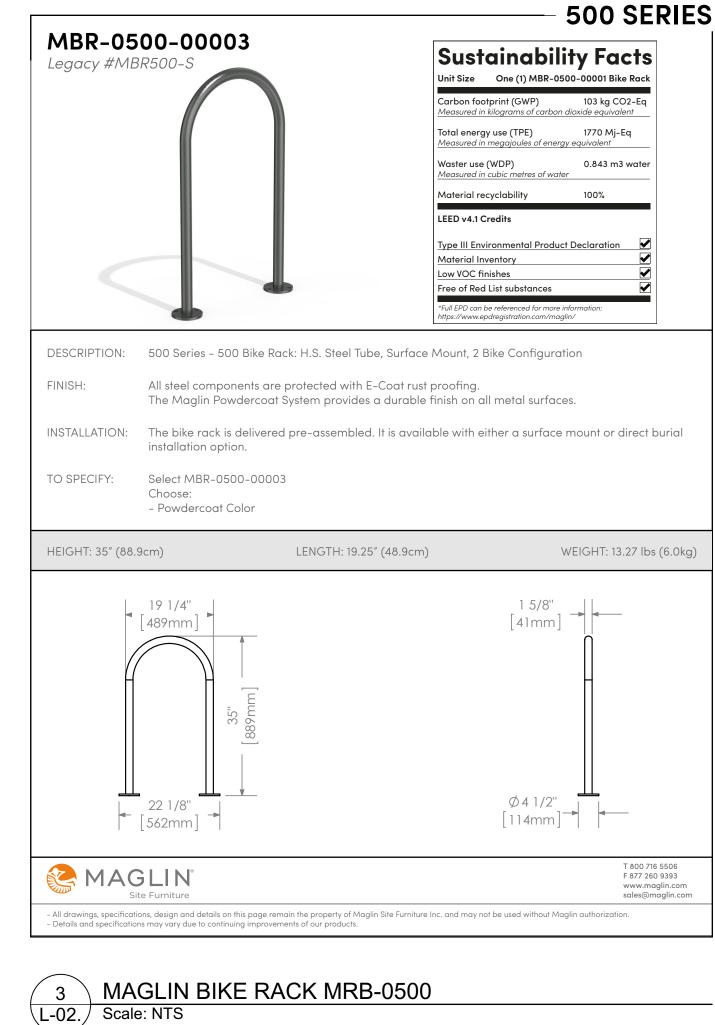

-//Purolator

GENERAL NOTES

.1 All general site information and conditions compiled from existing plans, surveys and consultant's field notes. Report all discrepancies prior to any work. No responsibility is born by the Consultant for unknown subsurface conditions.

.2 The location of the utilities is approximate only, and the exact location should be determined by consulting the municipal authorities and utility companies concerned. The Contractor shall prove the location of utilities and shall be responsible for adequate protection from damage.

.3 All dimensions shown are to be verified on site prior to any construction. No deviations are to be made from the layouts as shown on this plan without prior consultation with the Landscape Architect and Owner.

.4 Obtain approval of Landscape Architect for granular base and layout of all pavement areas prior to construction.

.5 Stake planting locations and receive approval of Landscape Architect, prior to excavation of any planting pits. No substitutions of plant material shall be made without prior approval of the Landscape Architect.

.6 Where clay is encountered proper drainage must be ensured in tree/shrub pits, prior to planting. Have method approved by Landscape Architect.


.7 All sodded areas to receive a minimum of 150mm of topsoil over graded sub-base. If sod with mesh is used, mesh to be removed completely during sodding operations. Sod shall come from an approved source and shall be laid within 24 hours of being cut in the nursery. Only nursery sod shall be used.

.8 Final subgrade is to approved by the Landscape Architect prior to sod being laid.

.9 Maintain positive surface runoff through the entire construction period.

.10 Reinstate all areas and items damaged as a result of construction activities.

6							
5							
4	Re-Issued f	for Site	2024/01/08				
3	Issued for S	Site Plar	approval		2023/12/12		
2	Re-Issued f			bl	2023/11/13		
1	Re-Issued 1			-	2023/09/29		
no.		sue / rev		Л	date		
north							
N45 ARCHITECTURE INC. 71 Bank Street, 7th Floor - Ottawa, Ontario, K1P 5N2 tel, 613.224.0095 fax 613.224.9811							
Ruhland & Associates Ltd Iandscape architecture • urban design • site planning Ph 613-224-4744 Fx 613-224-1131 info@rala.ca www.rala.ca							
PUROLATOR DISTRIBUTION KANATA 1400 UPPER CANADA STREET, KANATA, ON							
drawing title CANOPY COVERAGE, SOIL VOLUME & DETAILS							
scale As SI		drawn T. F. / A	•		gned by / M.R.		
date		check		plot o			
Jun 2023 M. Ru			•				
project drawing number							
	23-1722 L-02 .						
Contr	actor to char		رميت المانية		and on the ich		

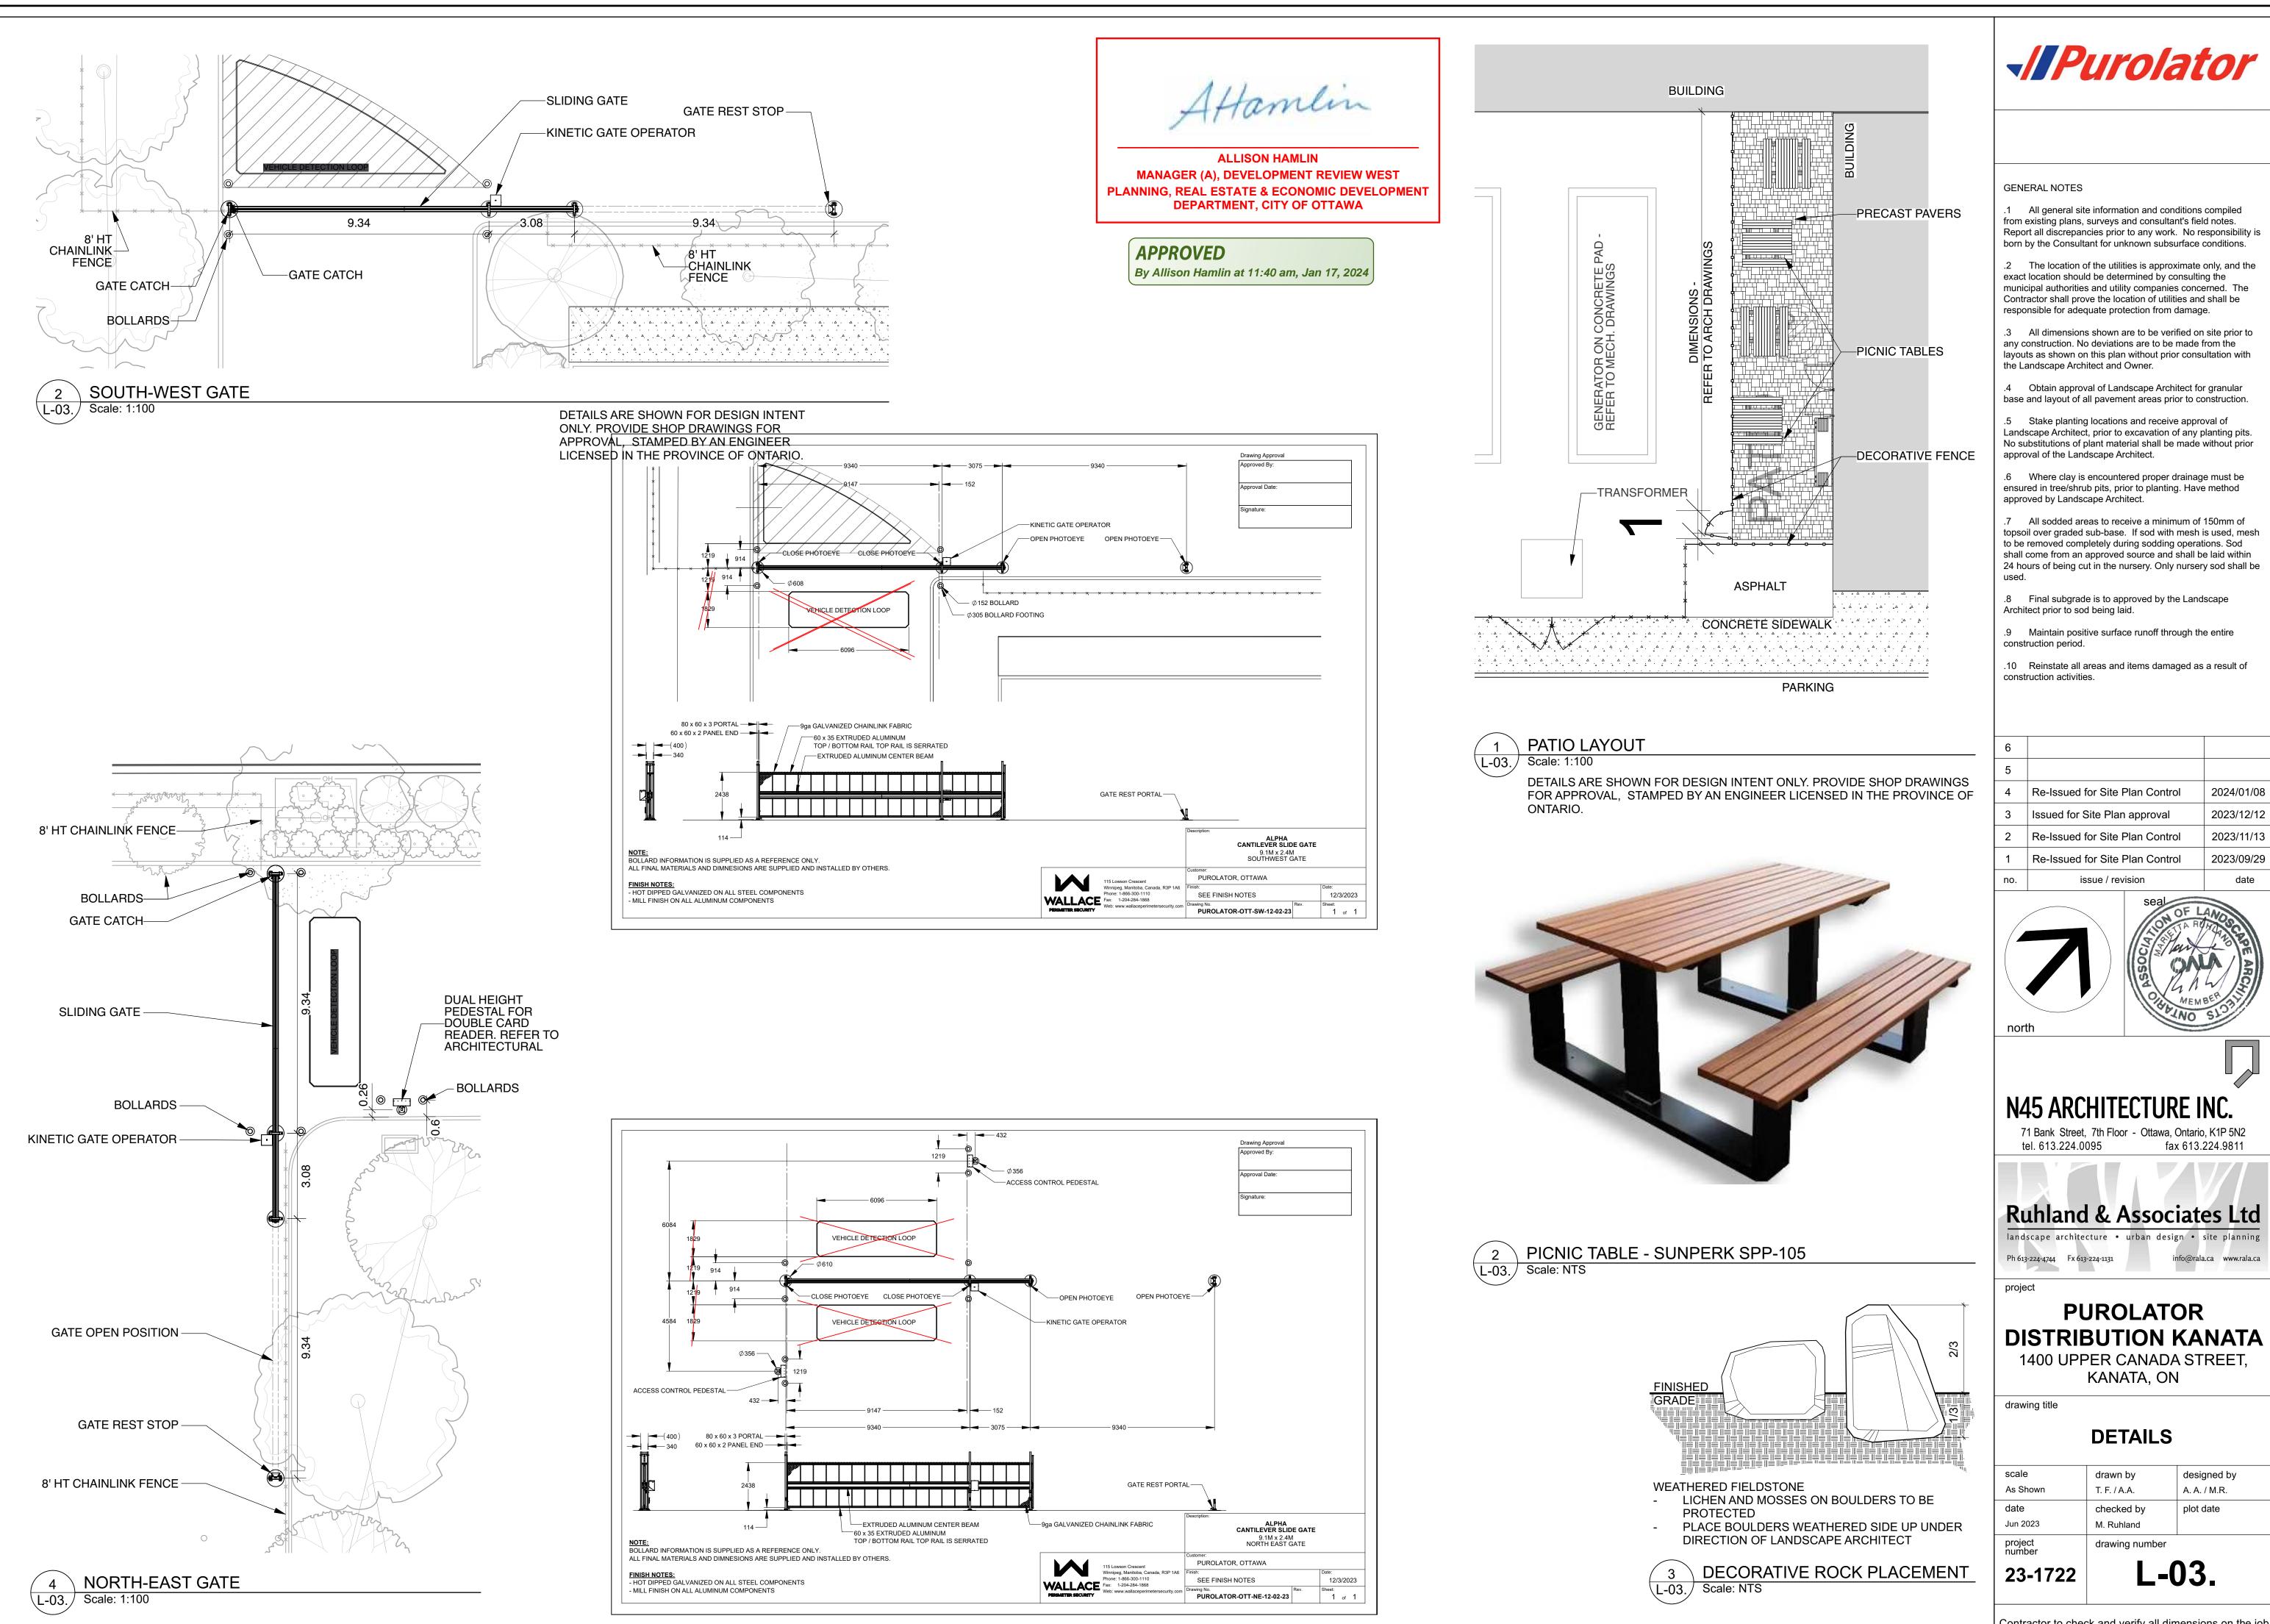

Contractor to check and verify all dimensions on the job

PLAN NO.: 1826

date

amlin


ALLISON HAMLIN MANAGER (A), DEVELOPMENT REVIEW WEST PLANNING, REAL ESTATE & ECONOMIC DEVELOPMENT DEPARTMENT, CITY OF OTTAWA

APPROVED By Allison Hamlin at 11:40 am, Jan 17, 2024

NOTE - TREE SOIL VOLUME REQUIREMENTS:

STANDARD TREE SOIL VOLUMES QUANTITIES INCLUDE THE TOP 900-1000mm OF IMPORTED AND EXISTING SOIL/SUBSOIL LAYER TO CALCULATE TOTAL SOIL VOLUMES REQUIRED BY CITY OF OTTAWA FOR SUSTAINABLE TREE GROWTH. WHERE LARGER SOFT AREAS ARE AVAILABLE WITH APPROVED EXISTING TOPSOIL AND SUBSOIL, IMPORTED TOPSOIL ONLY AS PER DETAIL L-1.

WHERE EXISTING MATERIAL BELOW THE SPECIFIED TOPSOIL IS NOT CONDUCIVE TO TREE GROWTH, AN ADDITIONAL LAYER OF 400mm PLANTING MEDIUM AND APPROVED SUBSOIL IS TO BE INSTALLED BELOW SPECIFIED TOPSOIL DEPTH TO OBTAIN THE SOIL VOLUME DEPTH REQUIRED. REFER TO SOIL VOLUME CHART AND PLANS FOR AREA WHERE TREE SOIL VOLUMES ARE REQUIRED.

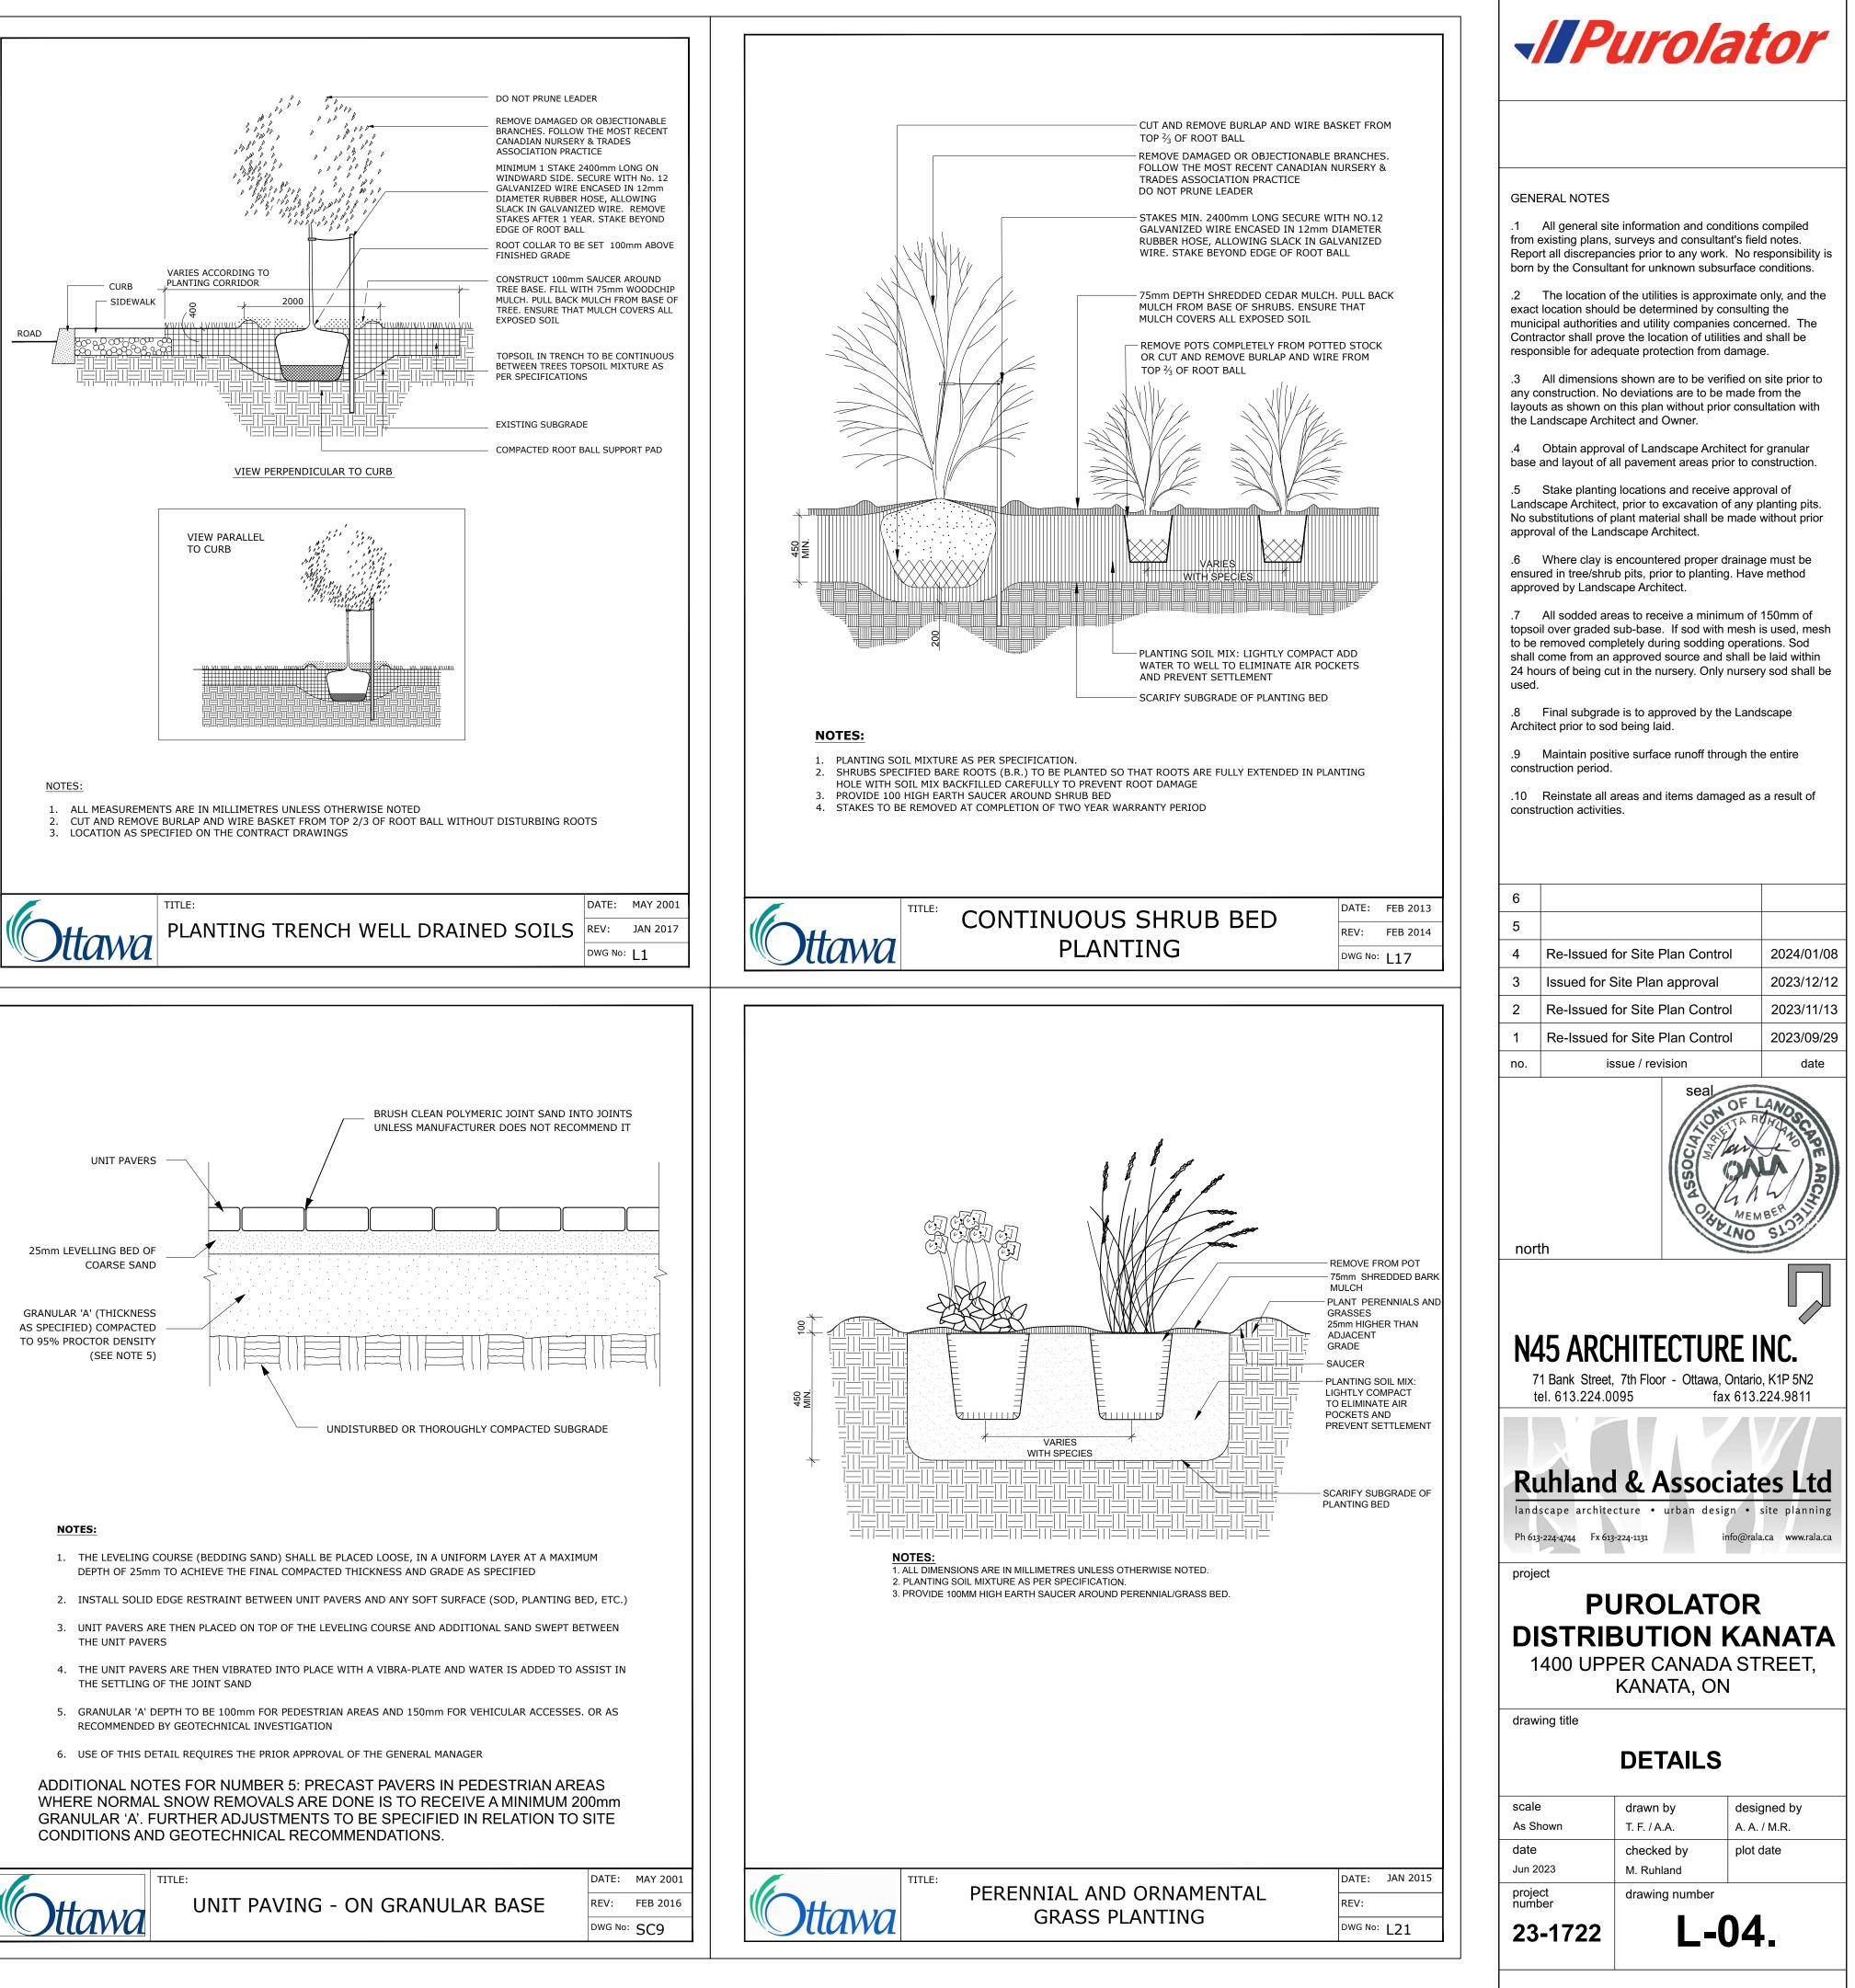

Contractor to check and verify all dimensions on the job

PLAN NO.: 18260