



1 1 1

SITE PLAN PHASE TWO PLANTING DETAILS AMENITIES DETAILS


(C) ttawa

C SITE


NAK


design strategies



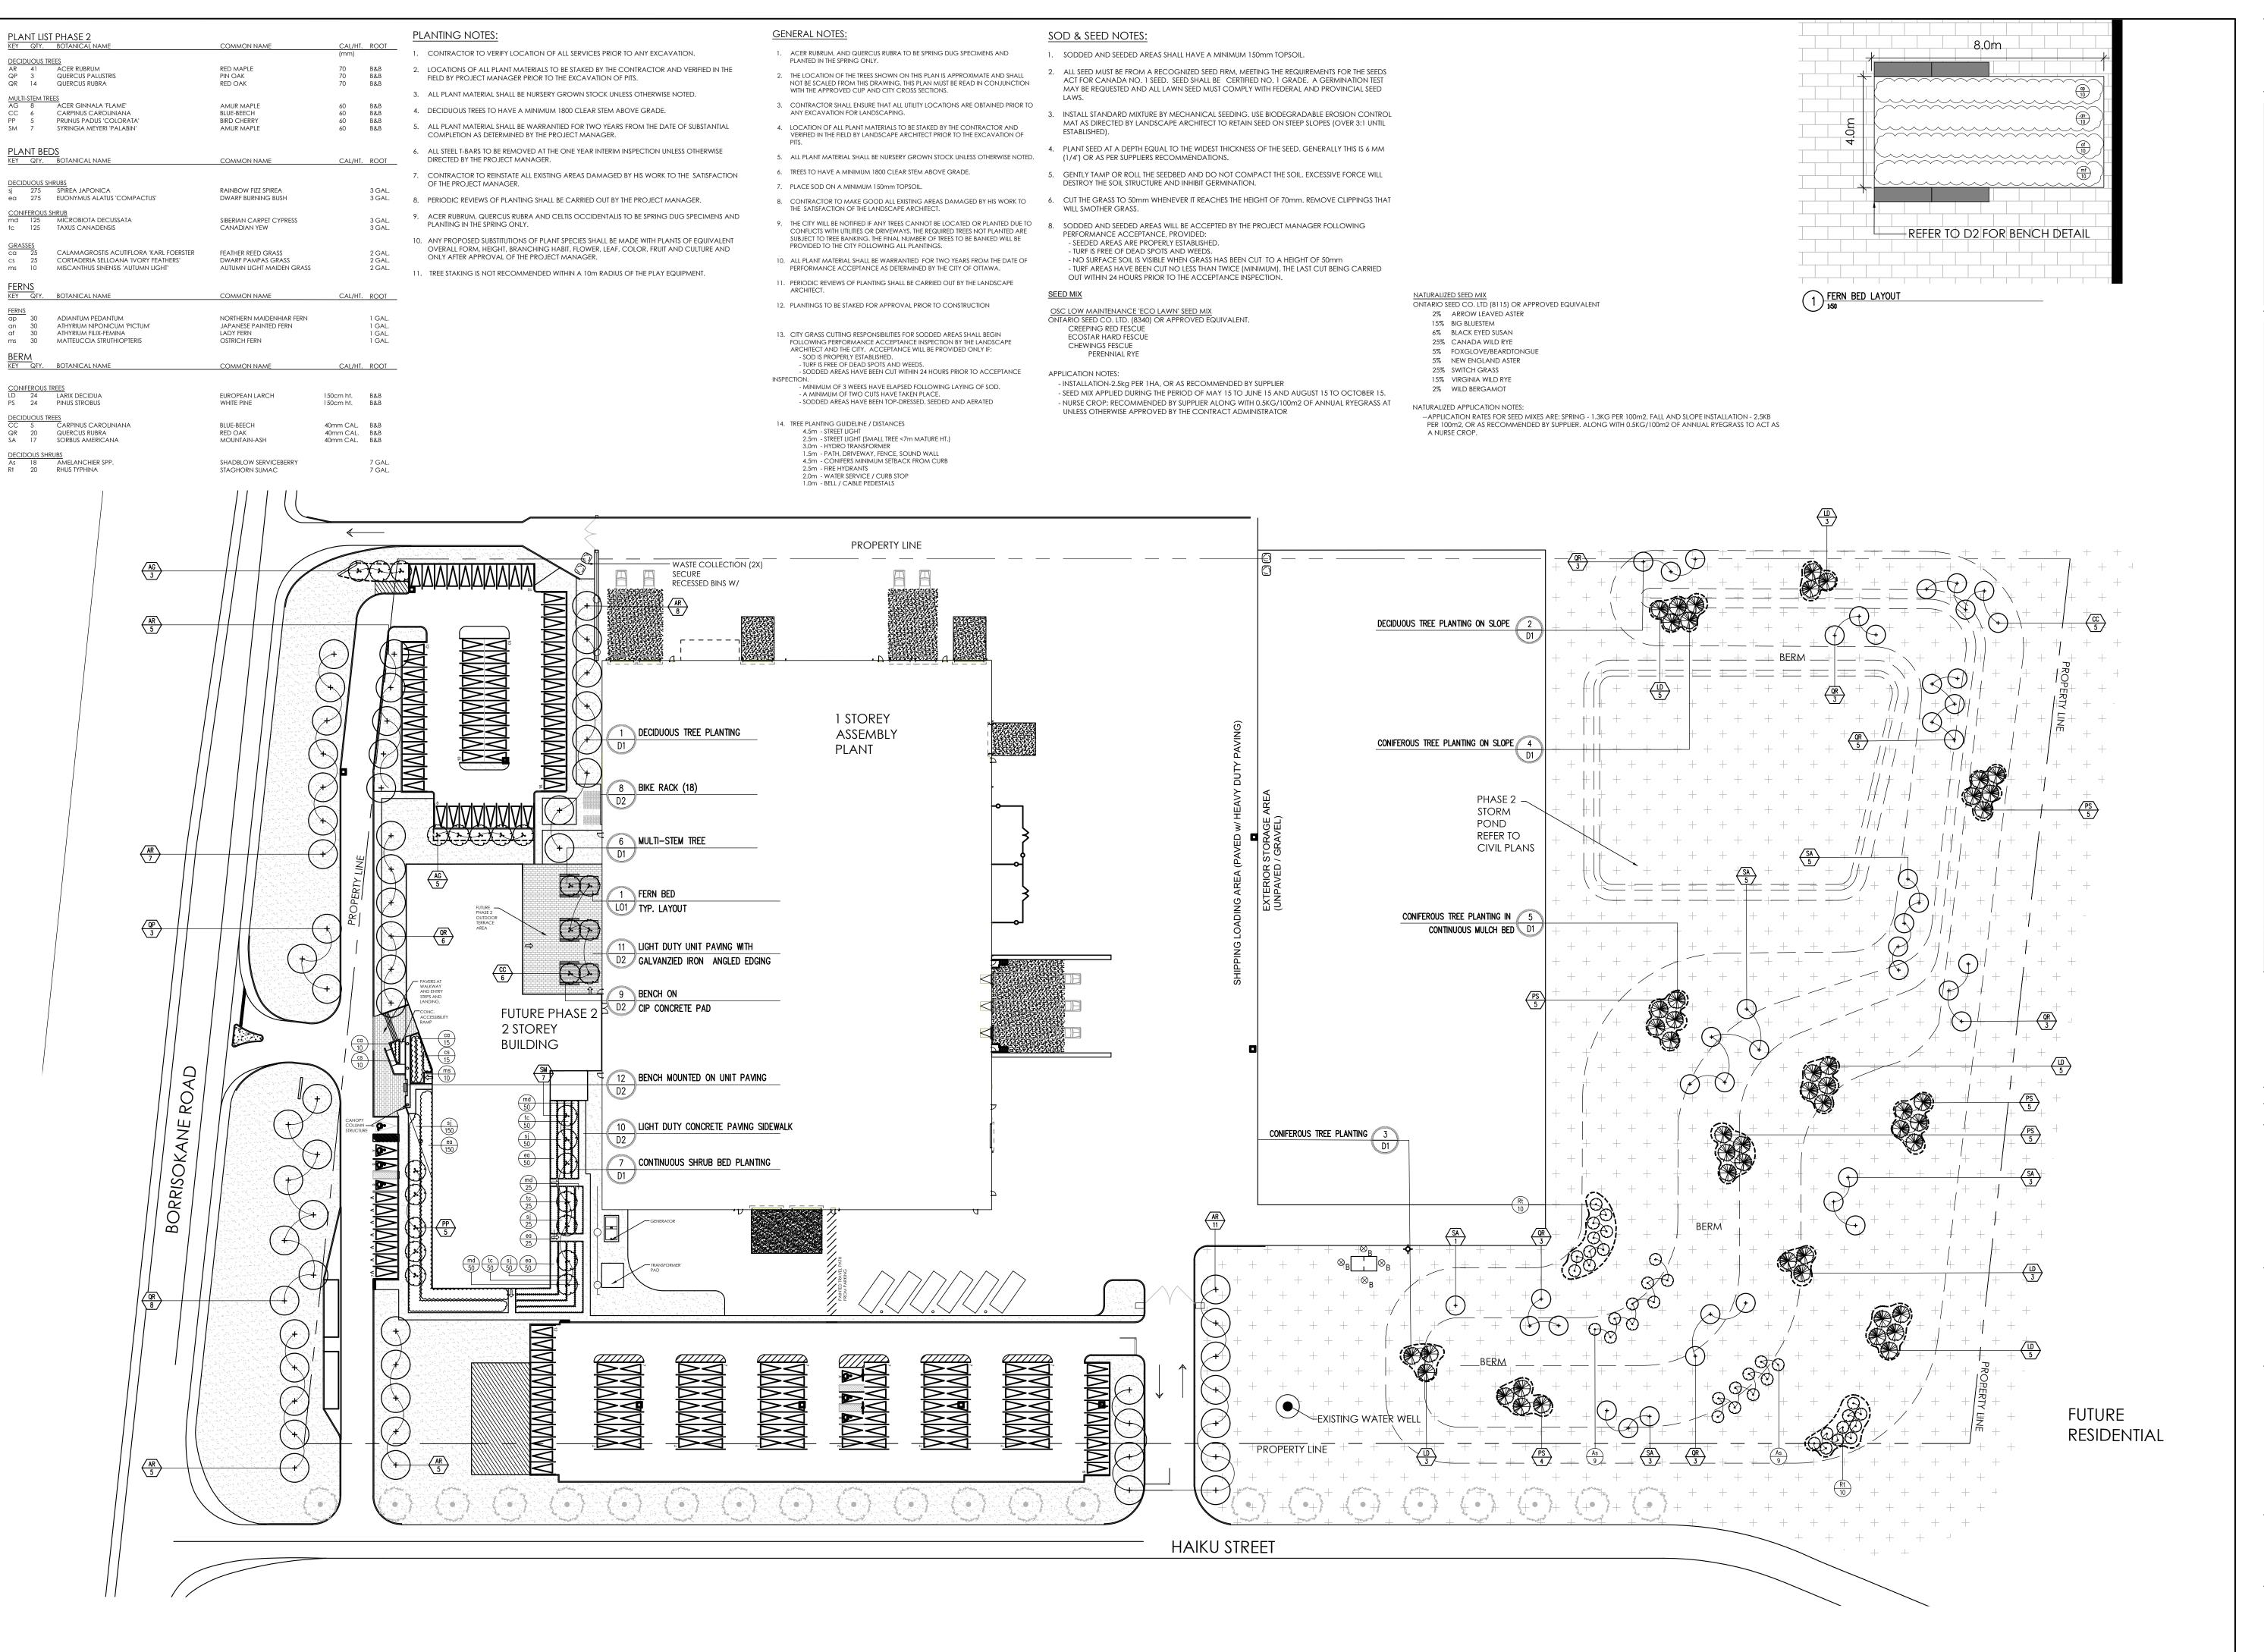

Contractor shall check all dimensions on the work and report any discrepancy to the Landscape Architect before proceeding. All drawings and specifications are the property of the Landscape Architect and must be returned at the completion of the work. This drawing is not to be used for construction until signed by the Landscape Architect.

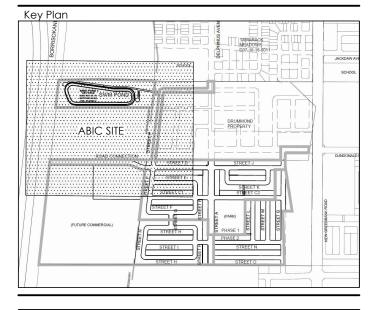


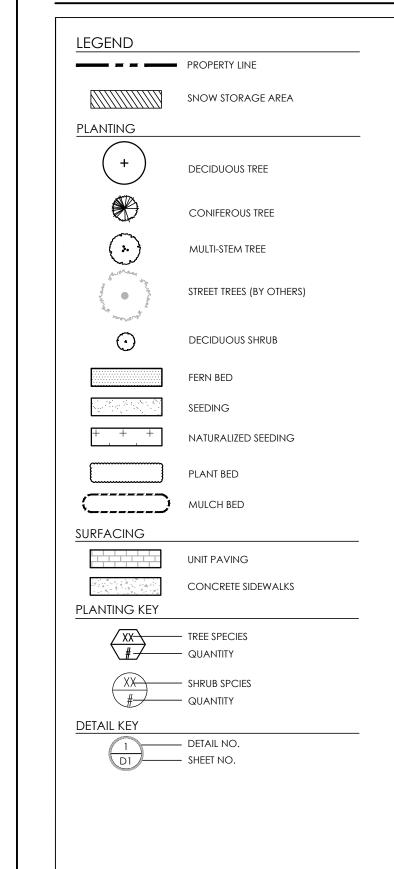

7	Issued for Fourth Submission	Oct. 01/20		
6	Issued for Third Submission	Sep.04/20		
5	Reissued for Second Submission	May.25/20		
4	Issued for Second Submission	Apr. 23/20		
3	Re-design Issued for Client Review	Fev. 26/20		
2	Issued for First Submission	Jan. 15/20		
1	Issued for Client Review	Nov. 15/19		
No.	Description	Date		
Revision				
City Approval Stamp				

City Approval Stamp



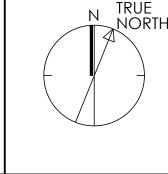




1285 WELLINGTON STREET WEST, OTTAWA, ON K1Y 3A8 CANADA T 613.237.2345 F 613.237.6423 NAKDESIGNSTRATEGIES.COM

ABIC SITE


LANDSCAPE - PHASE TWO

Date: AUG 2020 Scale: 1:600 Drawn: EJ Checked:YL Job #: 19-264

LO1

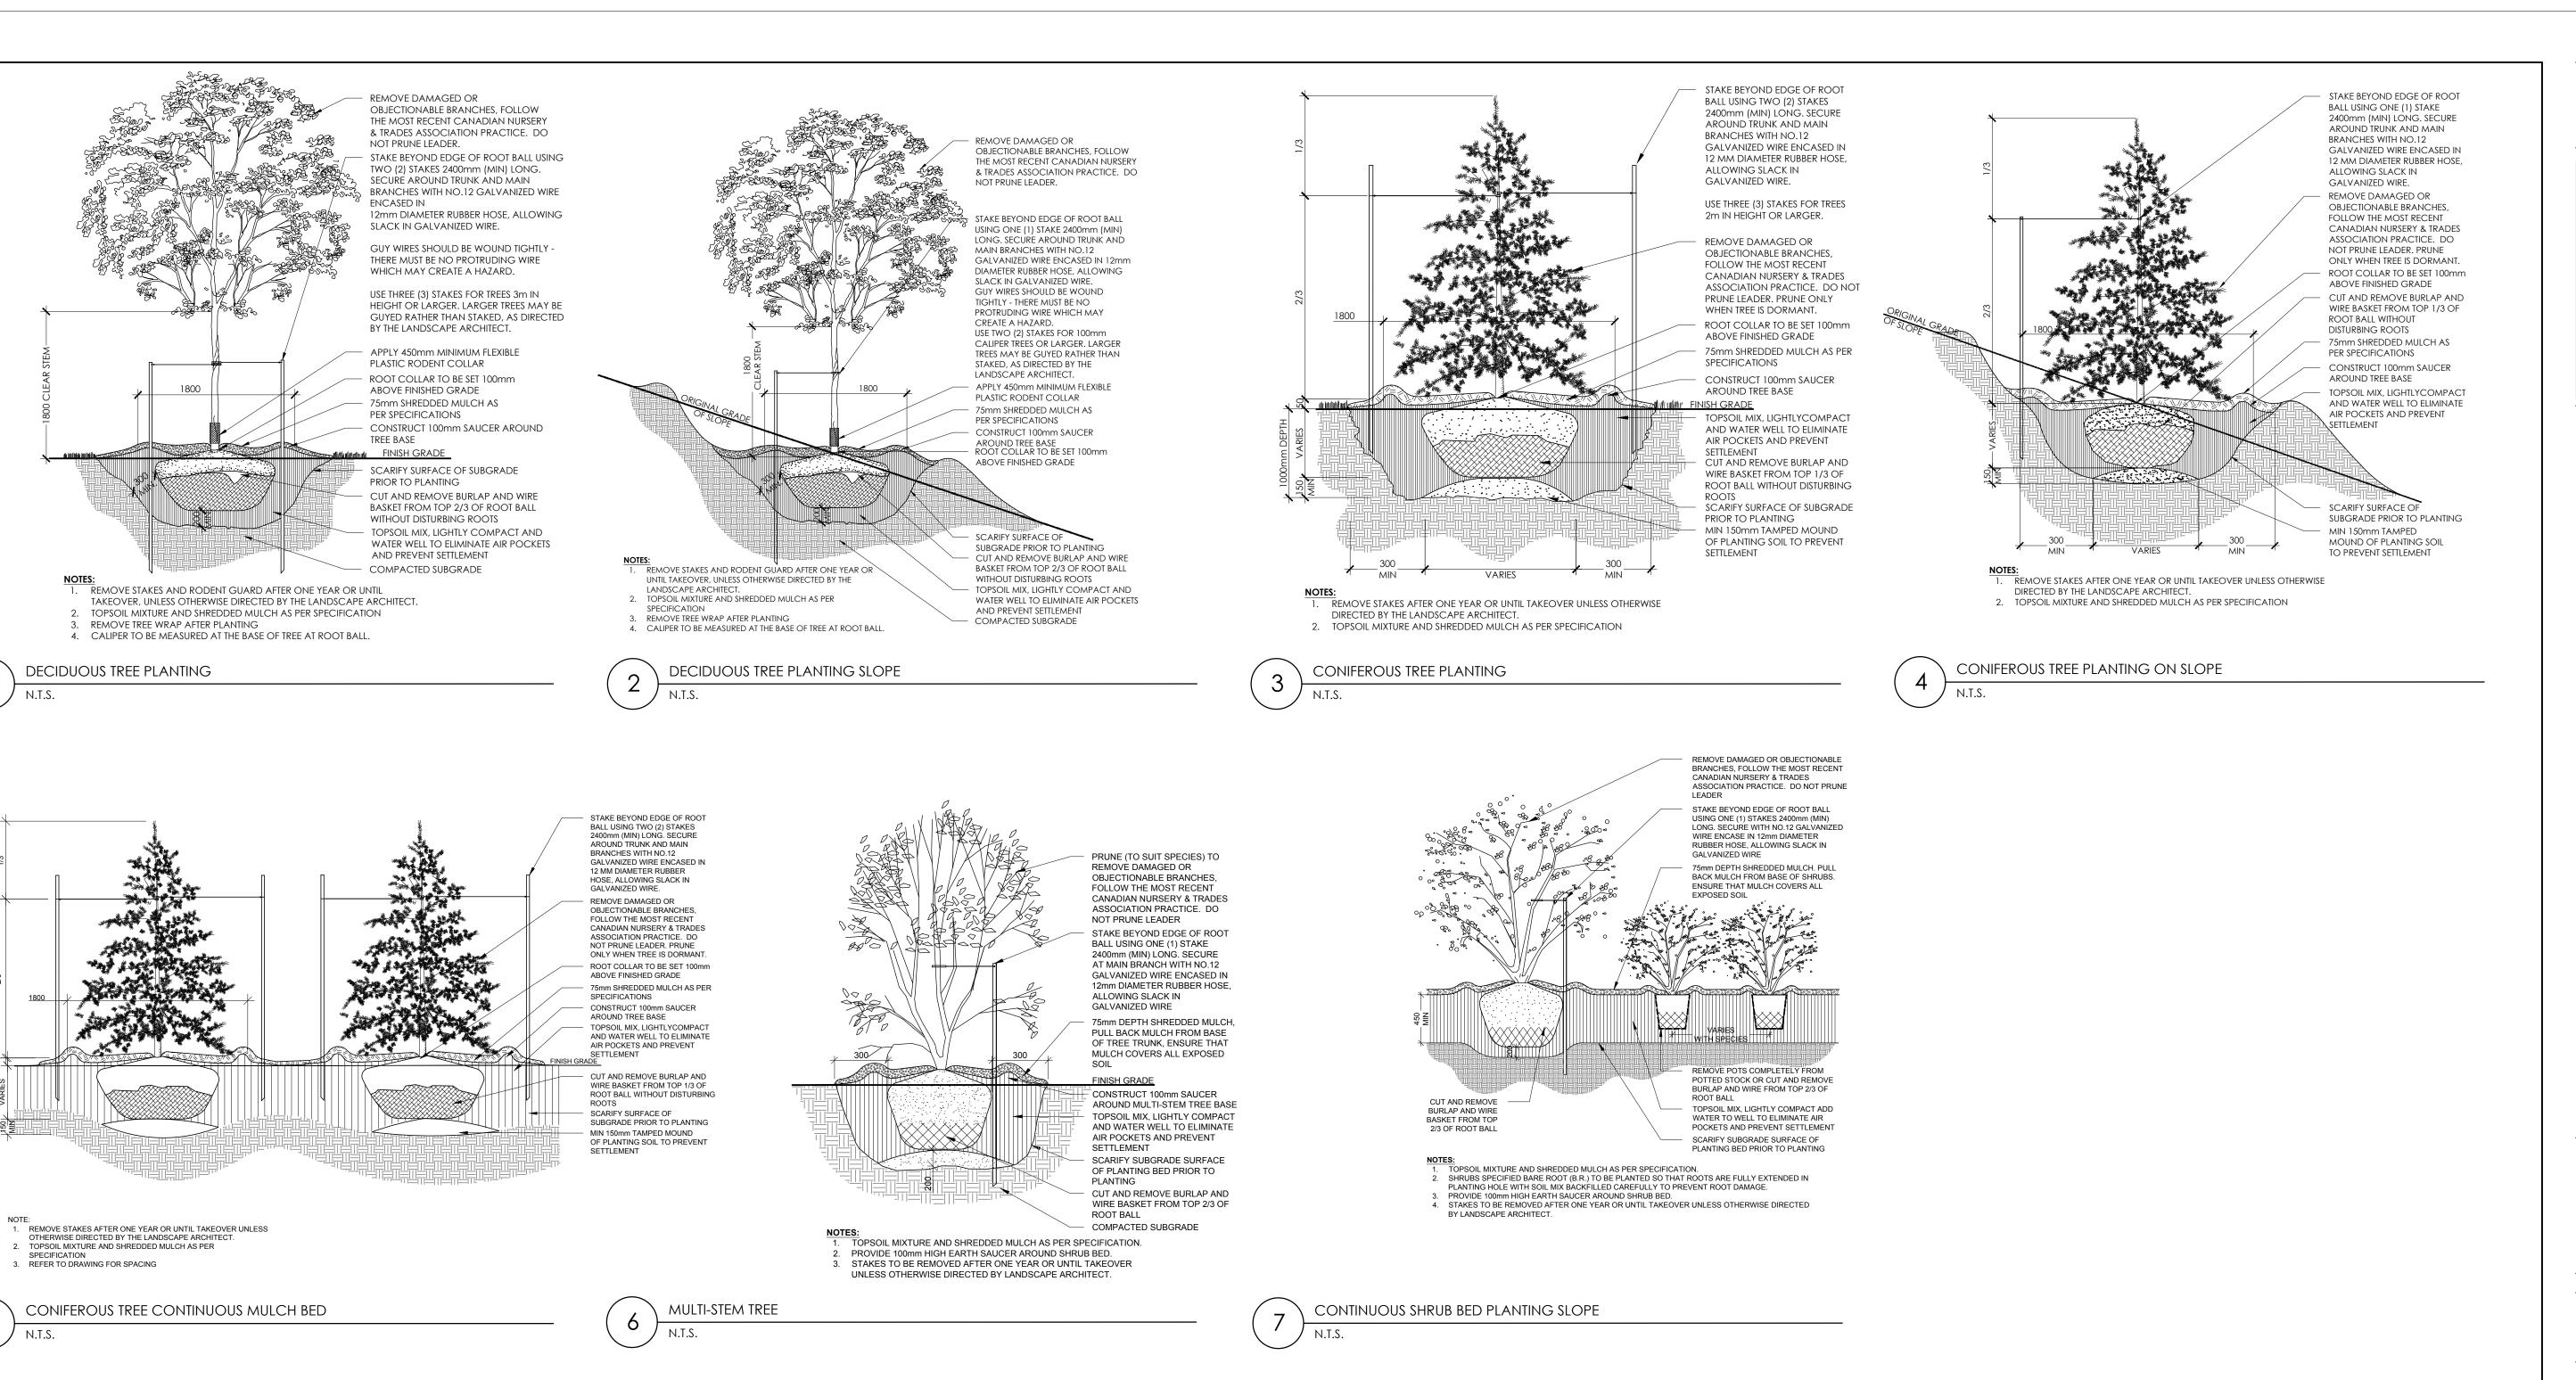


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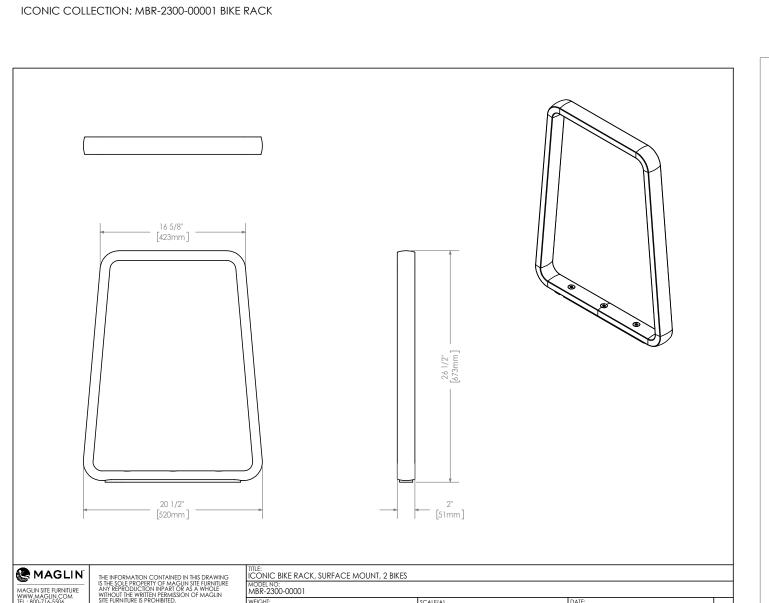
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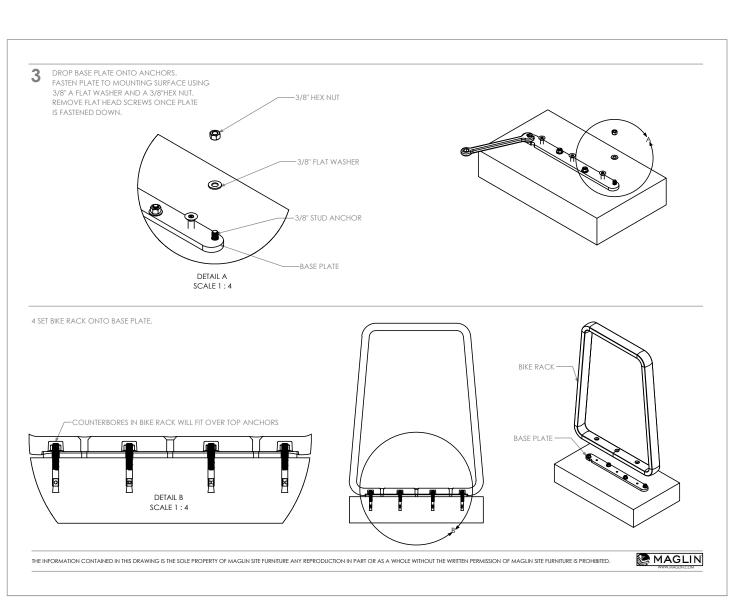
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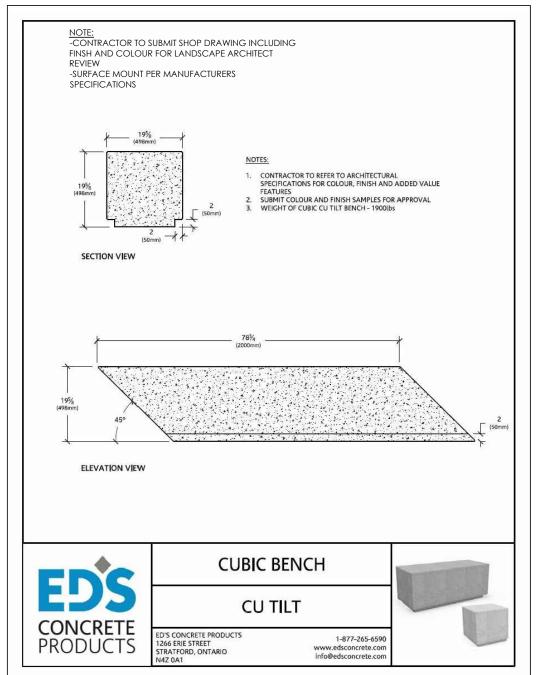
PLANTING DETAILS

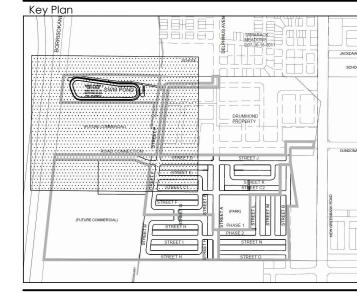
Date:	SEP. 2020			
Scale:	N.T.S.			
Drawn:	EJ			
Checked:YL				
Job #:	19-264			






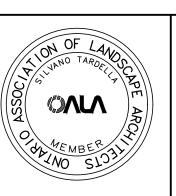




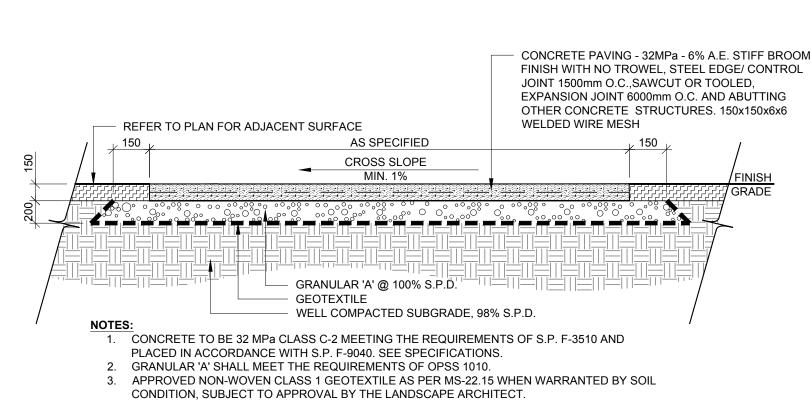

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NOTES: -CONTRACTOR TO SUBMIT SHOP DRAWING INCLUDING FINSH AND COLOUR FOR LANDSCAPE ARCHITECT REVIEW

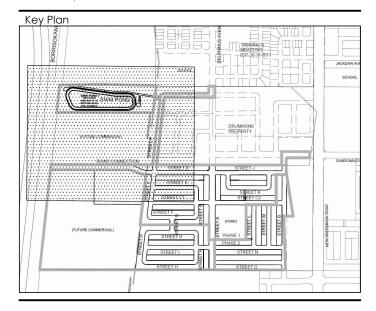

FINISH GRADE

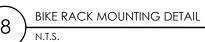MAGLIN

MICRO BEVEL

3mm JOINTS, POLYMERIC SAND PER MANUFACTURERS RECOMMENDATION.

BRUSH SAND INTO JOINTS

60mm PAVER UNIT, FOR

TYPE AND PATTERN


REFER TO PLAN AND


25MM LEVELLING BED


SPECIFICATIONS

OF COARSE SAND



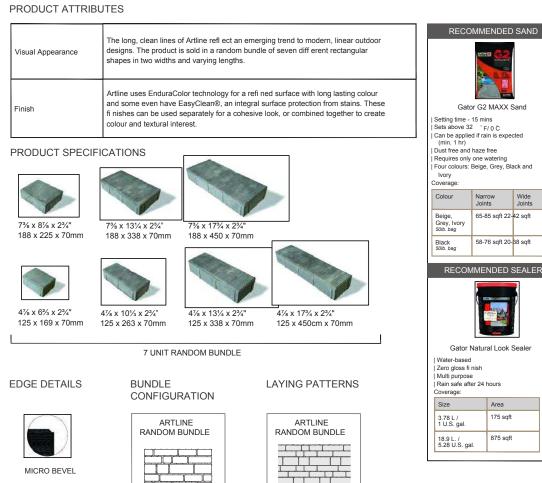

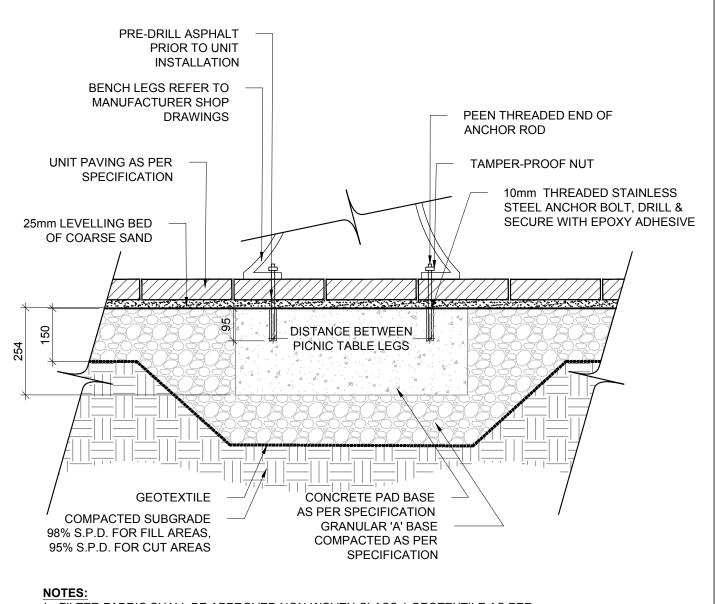

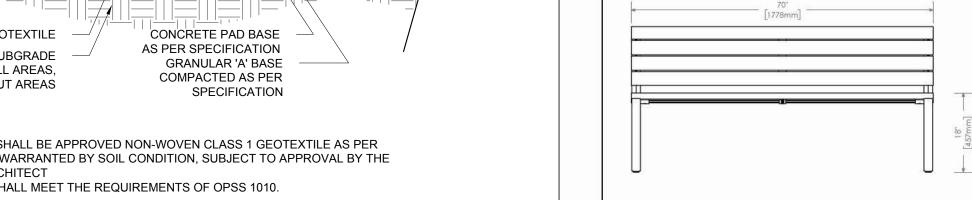

LIGHT DUTY CONCRETE SIDEWALK

MBE-2300-00015

FINISH:

TO SPECIFY:

MATERIALS: The legs are aluminum castings. The boards are made from Ipe wood. All brackets are made of

HEIGHT: 33 1/16" (84cm) LENGTH: 70" (177.8cm) DEPTH: 25 1/2" (64.7cm) WEIGHT: 115 lbs (52.1kg)

INSTALLATION: The bench is delivered pre-assembled. The legs have 7/16' holes for anchoring.

Select MBE-2300-00015

- Powdercoat Color

The Maglin Powdercoat System provides a durable finish on all aluminum castings. The wood


boards are treated with penetrating sealers. The steel brackets are e-coated and powdercoated.



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ICONIC

T 800 716 5506 F 877 260 9393 www.maglin.com sale s@maglin.com

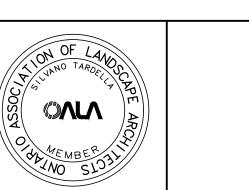

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ABIC SITE

AMENITIES DETAILS

Date: SEP. 2020 Scale: N.T.S. Drawn: EJ Checked:YL Job #: 19-264

D2



REFER TO PLAN FOR ADJACENT

- GALVANIZED IRON ANGLE EDGE

RESTRAINT WITH SPIKE FIRMLY

ANCHORED IN COMPACTED BASE

1. FOR PAVER TYPE REFER TO SPECIFICATIONS. PAVERS SHALL BE INSTALLED IN STRICT

2. ALL DAMAGED OR CHIPPED PAVERS MUST BE REPLACED AT THE CONTRACTOR'S COST.

5. INSTALL PAVING UNITS IN THE PATTERN AS SPECIFIED PER MANUFACTURER'S PATTERN

6. RETAIN EDGING WITH GALVANIZED IRON ANGLE EDGE RESTRAINTS AS PER SPECIFICATIONS.

ACCORDANCE WITH THE MANUFACTURER'S RECOMMENDATIONS WITH TIGHT BUTT JOINTS OF APPROXIMATELY 3mm, ON A SAND BASE. SAW CUT PAVERS AS REQUIRED. USE AN APPROVED

3. EXCAVATE AND REMOVE ALL TOPSOIL AND UNSTABLE MATERIALS OFF SITE. SUBGRADE TO BE

GRADED TO SIMILAR CONTOURS AS FINISH GRADE. COMPACT SUBGRADE TO 95% S.P.D. PLACE

150MM MIN. DEPTH OF GRANULAR 'A'

SUBGRADE COMPACTED TO 95% S.P.D.

COMPACTED TO 100% S.P.D.

GEOTEXTILE FABRIC

SURFACE

VIBRATORY COMPACTOR IN A CIRCULAR PATTERN.

RECOMMENDATION AND SPECIFICATIONS.

150mm LAYER OF GRANULAR 'A' COMPACTED TO 100% S.P.D.

4. PLACE MAXIMUM 25mm UNCOMPACTED SAND FOR LEVELLING COURSE.

UNILOCK.COM | 1-800-UNILOCK

1. FILTER FABRIC SHALL BE APPROVED NON-WOVEN CLASS 1 GEOTEXTILE AS PER MS-22.25 WHEN WARRANTED BY SOIL CONDITION, SUBJECT TO APPROVAL BY THE LANDSCAPE ARCHITECT

BENCH MOUNTED ON UNIT PAVING

CU-TILT CONCRETE BENCH