


**1 TREE CONSERVATION REPORT & LANDSCAPE PLAN**  
SCALE 1:150


KEY	QTY	BOTANICAL NAME	COMMON NAME	SIZE	CONDITION	REMARKS	OWNERSHIP
AN	1	<i>Acer negundo</i>	Manitoba Maple	350mm DBH	GOOD	See plan	5511 Manotick Main Street
AP	1	<i>Pinus nigra</i>	Austrian Pine	350mm DBH	GOOD	To remain	5495 & 5511 Manotick Main Street
AS	7	<i>Acer saccharum</i>	Sugar Maple	200-740mm DBH	GOOD	To remain	5497 Manotick Main Street
AR	1	<i>Acer rubrum</i>	Red Maple	420mm DBH	GOOD	To remain	5497 Manotick Main Street
BC	1	<i>Prunus serotina</i>	Black Cherry	500mm DBH	GOOD	To remain	5495 Manotick Main Street
BL	1	<i>Prunus serotina</i>	Black Cherry	300mm DBH	GOOD	To remain	5511 Manotick Main Street
CK	1	<i>Acer platanoides</i> 'Crimson King'	Crimson King Maple	490mm DBH	FAIR	To be removed	City of Ottawa
FA	2	<i>Fraxinus sp.</i>	Ash	100-350mm DBH	DEAD	See plan	5497 Manotick Main Street
FR	3	<i>Fraxinus americana</i>	White Ash	200-250mm DBH	GOOD	To remain	5511 Manotick Main Street
MA	4	<i>Malus sp.</i>	Crabapple	300mm DBH	GOOD	To be removed	5497 Manotick Main Street
MC	1	<i>Prunus maackii</i>	Manchurian Cherry	200mm DBH	GOOD	To remain	5495 Manotick Main Street
NM	1	<i>Acer platanoides</i>	Norway Maple	350mm DBH	GOOD	To remain	5511 Manotick Main Street
PR	4	<i>Prunus serotina</i>	Black Cherry	390-510mm DBH	DEAD-GOOD	To remain	5497 Manotick Main Street
SA	1	<i>Sorbus aucuparia</i>	Mountain Ash	150mm DBH	DEAD	To remain	5511 Manotick Main Street
SC	3	<i>Pinus sylvestris</i>	Scots Pine	300-360mm DBH	GOOD	To remain	5511 Manotick Main Street
SI	1	<i>Acer saccharum</i>	Silver Maple	710mm DBH	FAIR	To remain	5511 Manotick Main & City of Ottawa
SM	4	<i>Acer saccharum</i>	Sugar Maple	150-400mm DBH	GOOD	To remain	5511 Manotick Main & City of Ottawa
SP	6	<i>Pinus sylvestris</i>	Scots Pine	240-400mm DBH	DEAD-GOOD	To remain	5495 Manotick Main Street
SU	2	<i>Acer saccharum</i>	Sugar Maple	350-480mm DBH	GOOD	To remain	5495 Manotick Main Street
TO	2	<i>Thuja occidentalis</i>	White Cedar	150-200mm DBH	GOOD	To remain	5497 Manotick Main Street
UA	2	<i>Ulmus americana</i>	American Elm	100-200mm DBH	GOOD	To be removed	5497 Manotick Main Street
UL	1	<i>Ulmus americana</i>	American Elm	150mm DBH	GOOD	To remain	5511 Manotick Main & City of Ottawa

KEY	QTY	BOTANICAL NAME	COMMON NAME	SIZE	CONDITION	REMARKS
<b>TREES</b>						
BW	1	<i>Tilia americana</i>	Basswood	60mm cal.	B&B	
FM	1	<i>Acer x freemanii</i>	Freeman's Maple	60mm cal.	B&B	
HB	1	<i>Celtis occidentalis</i>	Hackberry	60mm cal.	B&B	
SB	1	<i>Amelanchier canadensis</i>	Serviceberry	60mm cal.	B&B	
SF	2	<i>Amelanchier laevis</i> 'JFS-ARB'	Spring Flurry Serviceberry	60mm cal.	B&B	
SM	1	<i>Acer saccharum</i>	Sugar Maple	60mm cal.	B&B	
<b>SHRUBS</b>						
DW	13	<i>Cornus sericea</i>	Red Osier Dogwood	800mm ht.	Potted	1200 mm o.c.
EB	7	<i>Sambucus canadensis</i>	Elderberry	800mm ht.	Potted	1200 mm o.c.
<b>ORNAMENTAL GRASSES</b>						
SG	32	<i>Panicum virgatum</i> 'Shenandoah'	Shenandoah Switch Grass	250mm pot	Potted	800 mm o.c.


- GENERAL NOTES:**
- It is the responsibility of the appropriate contractor or official to report any errors, omissions or discrepancies on this plan with actual site conditions to the Landscape Architect before proceeding with construction.
  - The contractor is to notify all utility companies and authorities prior to any excavation and ascertain locations of underground services.
  - The contractor is to reinstall all areas and items damaged as a result of construction activity.
  - The contractor is to comply with all pertinent codes and by-laws.
  - The contractor is to maintain a positive surface run-off throughout the entire construction period.
  - The Landscape Architect is not responsible for subsurface conditions.
  - The contractor is to identify all existing trees to remain on site with the Landscape Architect prior to construction.
  - The contractor is to stake the proposed location of all plant material in conjunction with the Landscape Architect prior to excavation.
  - Minimum distances for selected deciduous trees are as follows:
    - Sidewalks 1.5m
    - Public Streets 2.5m
    - Underground Infrastructure 2.0m
  - All trees within 1m of underground utility trenches are to be excavated by hand.
  - Remove all protective wrapping from tree trunks after installation.
  - Staking of trees shall only be performed if necessary.
  - Ensure that mulch is pulled back a min. distance of 75mm from base of tree trunk.

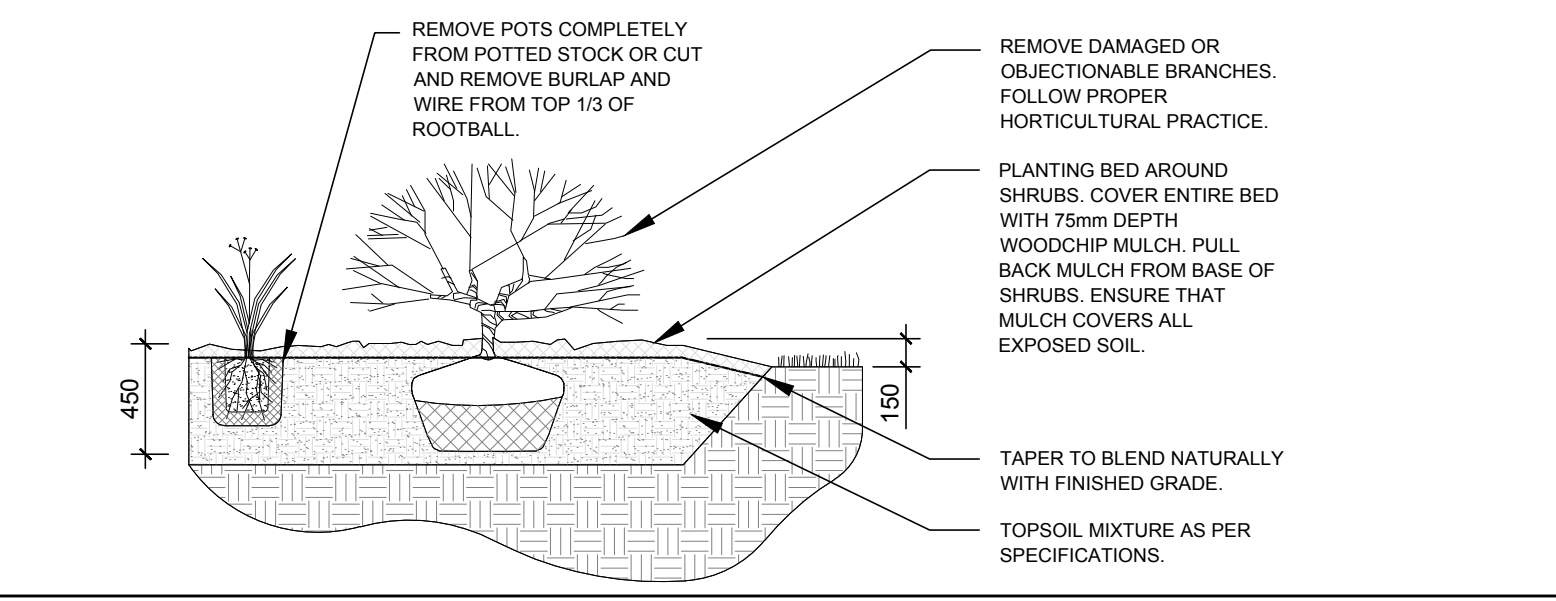

**2 SHRUB / ORNAMENTAL GRASS PLANTING**  
SCALE: NTS

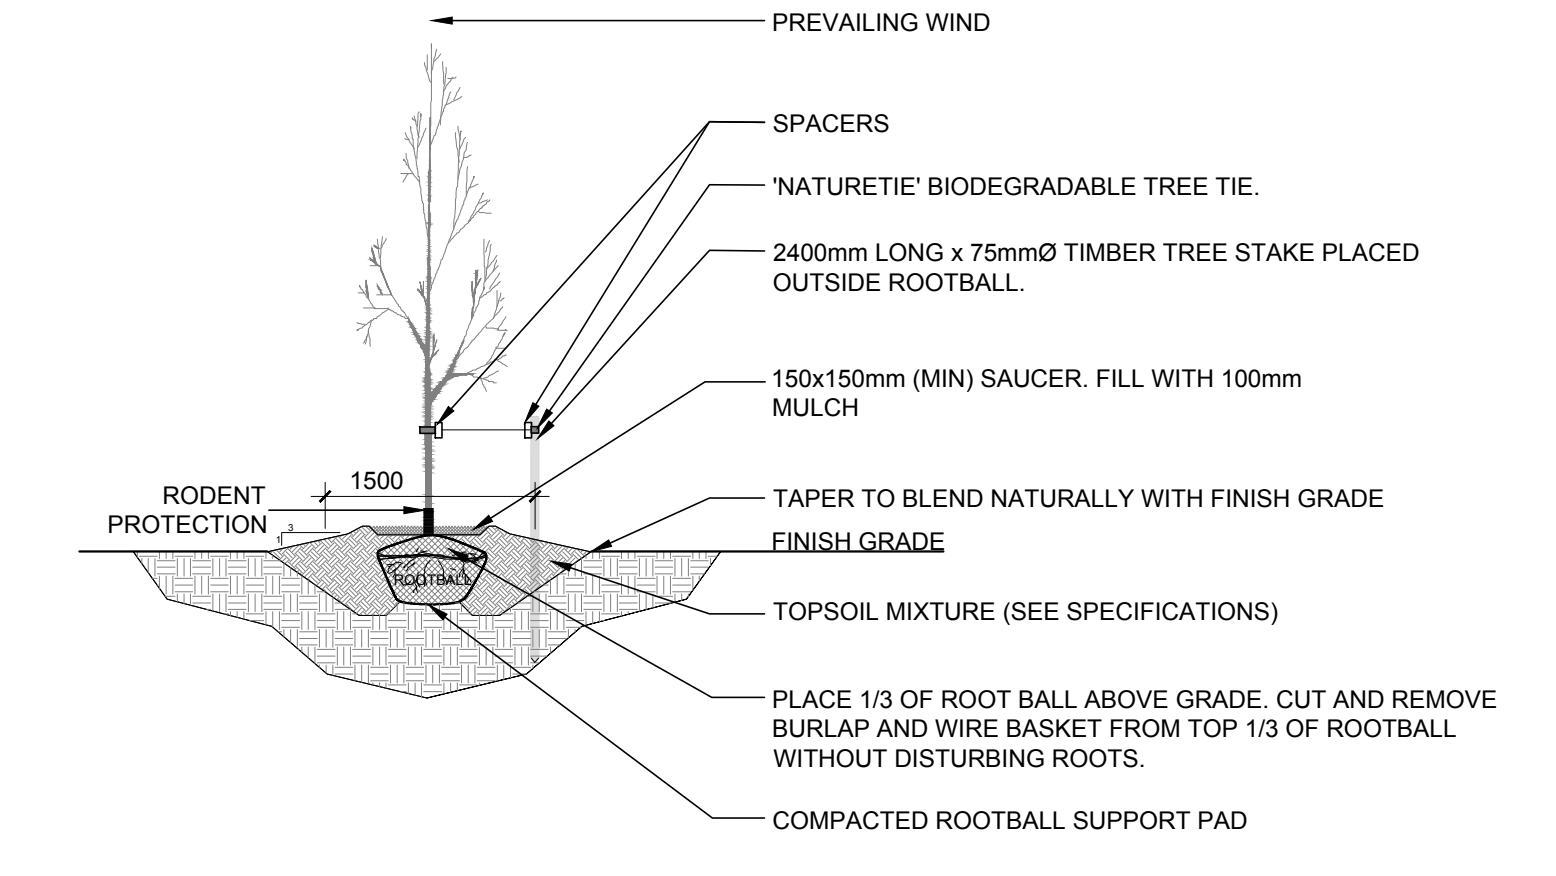

**3 DECIDUOUS TREE PLANTING**  
SCALE: NTS

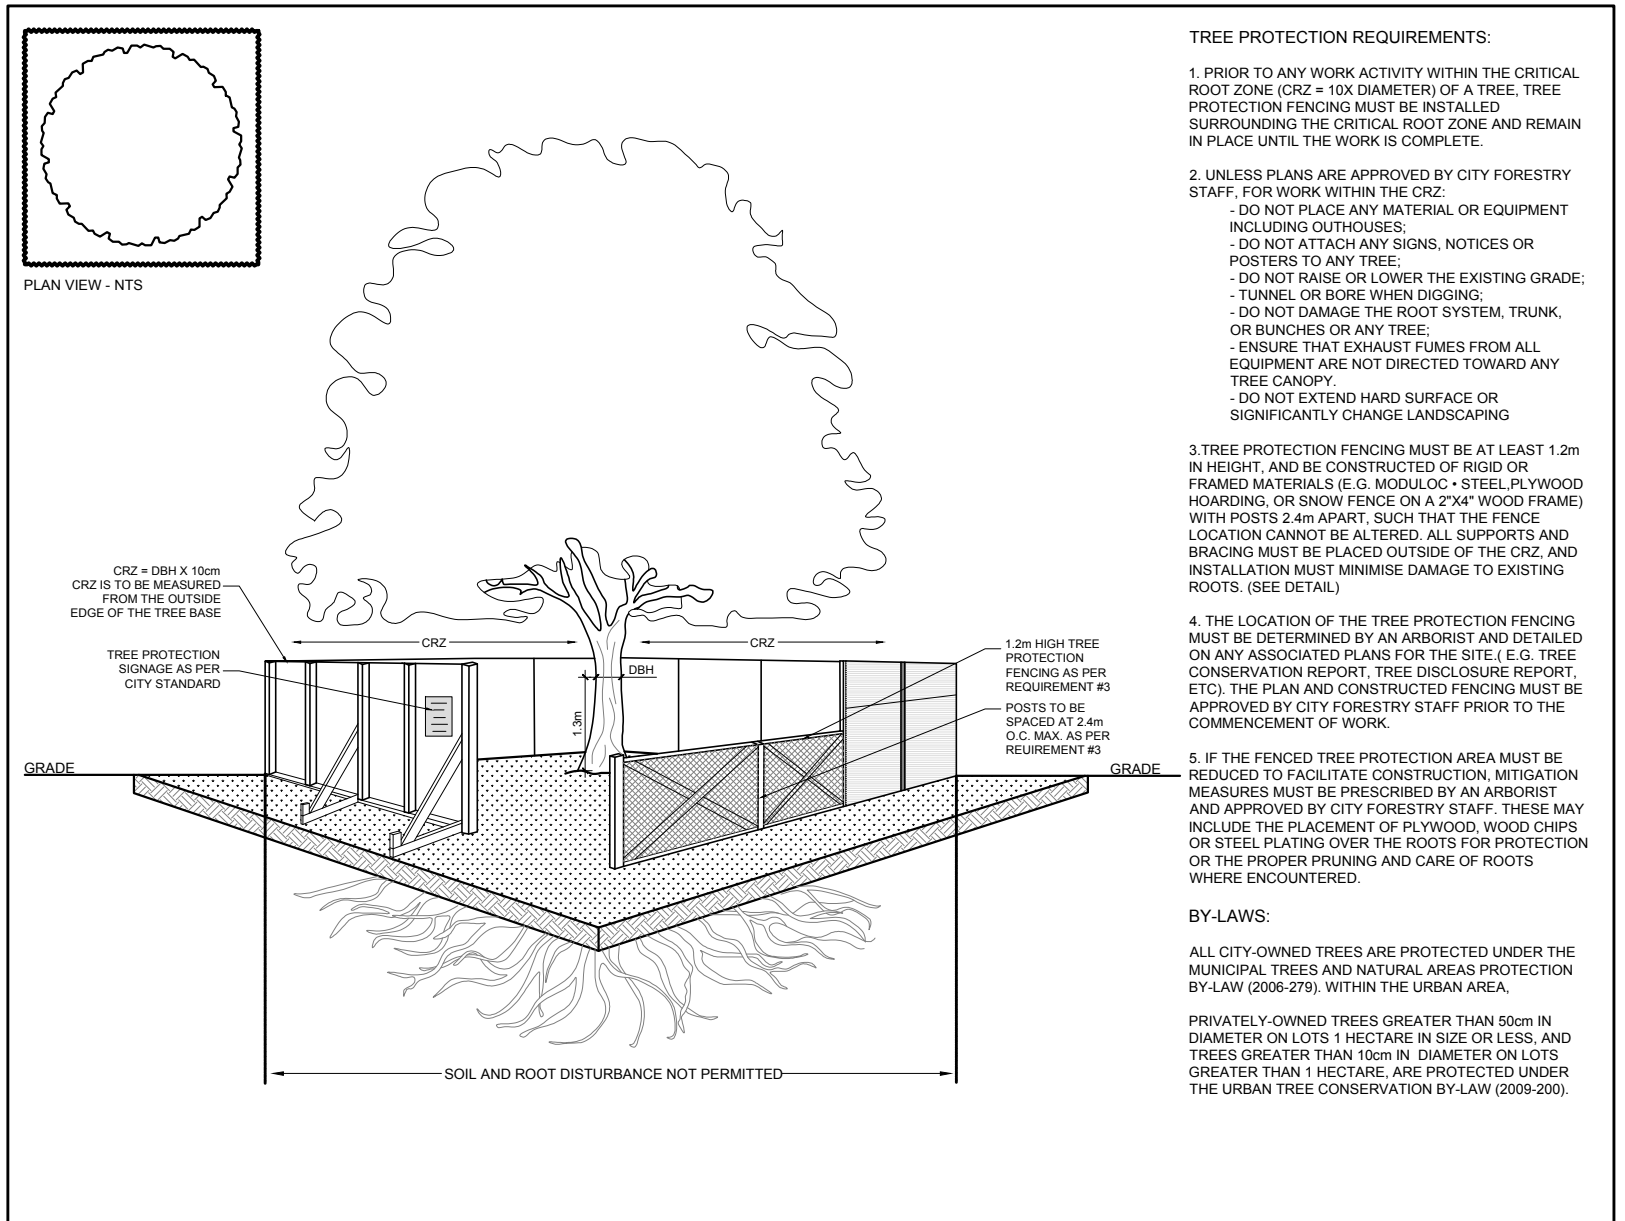

**4 TREE PROTECTION FENCE**  
SCALE: NTS

CLIENT:  
**12213559**  
Canada Inc  
996-B St. Augustin Rd, Embury ON K0A 1W0  
613-443-3575

CONSULTANTS  
ARCHITECTS:  
**P2 concepts**  
739 RIDGEWOOD AVE., UNIT 201  
OTTAWA, ONTARIO, K1V 6M6

SURVEYORS  
**ANNIS, O'SULLIVAN, VOLLEBECK LTD.**  
14 Concourse Gate, Suite 500  
Newport, Ont. K2E 7S6  
Phone: (613) 727-0850 / Fax: (613) 727-1079  
Email: noone@annis.com

CIVIL ENGINEERS:  
**BLANCHARD LETENDRE**  
ENGINEERING

**LEGEND**

- EXISTING TREE TO REMAIN
- EXISTING TREE TO BE REMOVED
- PROPOSED CONCRETE WALKWAY
- PROPOSED DECIDUOUS TREE
- PROPOSED SHRUBS / ORNAMENTAL GRASSES
- PROPOSED SOD
- PROPOSED TREE PROTECTION FENCE

No.	Issue	Date	DR	CK
7	PAVERS CHANGED TO CONCRETE	11/22/2022	ML	JL
6	REVISED PER NEW SITE PLAN	11/16/2022	ML	JL
5	REVISED PER NEW SITE PLAN	10/07/2022	ML	JL
4	ISSUED FOR DISCUSSION AND REVIEW	08/11/2022	ML	JL
3	REVISED PER NEW SITE PLAN	10/14/2021	ML	JL
2	ISSUED FOR DISCUSSION AND REVIEW	09/14/2021	ML	JL
1	ISSUED FOR SITE PLAN CONTROL	03/10/2021	ML	JL

**JAMES B. LENNOX & ASSOCIATES INC.**  
LANDSCAPE ARCHITECTS  
3332 CARLING AVE. OTTAWA, ONTARIO K2H 5A8  
Tel: (613) 722-5168 Fax: (1866) 343-3942

PROJECT  
**PROPOSED RESIDENTIAL BUILDING**  
5497 MANOTICK MAIN STREET, MANOTICK ON

DRAWING  
**TREE CONSERVATION REPORT & LANDSCAPE PLAN**

STAMP  
**ASSOCIATION OF LANDSCAPE ARCHITECTS OF ONTARIO**  
MEMBER  
**JBL**

SCALE  
AS SHOWN

START DATE  
NOVEMBER 2020

PROJECT NO.  
21MIS2107

PROJECT NORTH

DRAWING NO.  
**L.1**

PLOT SIZE ARCH-D