
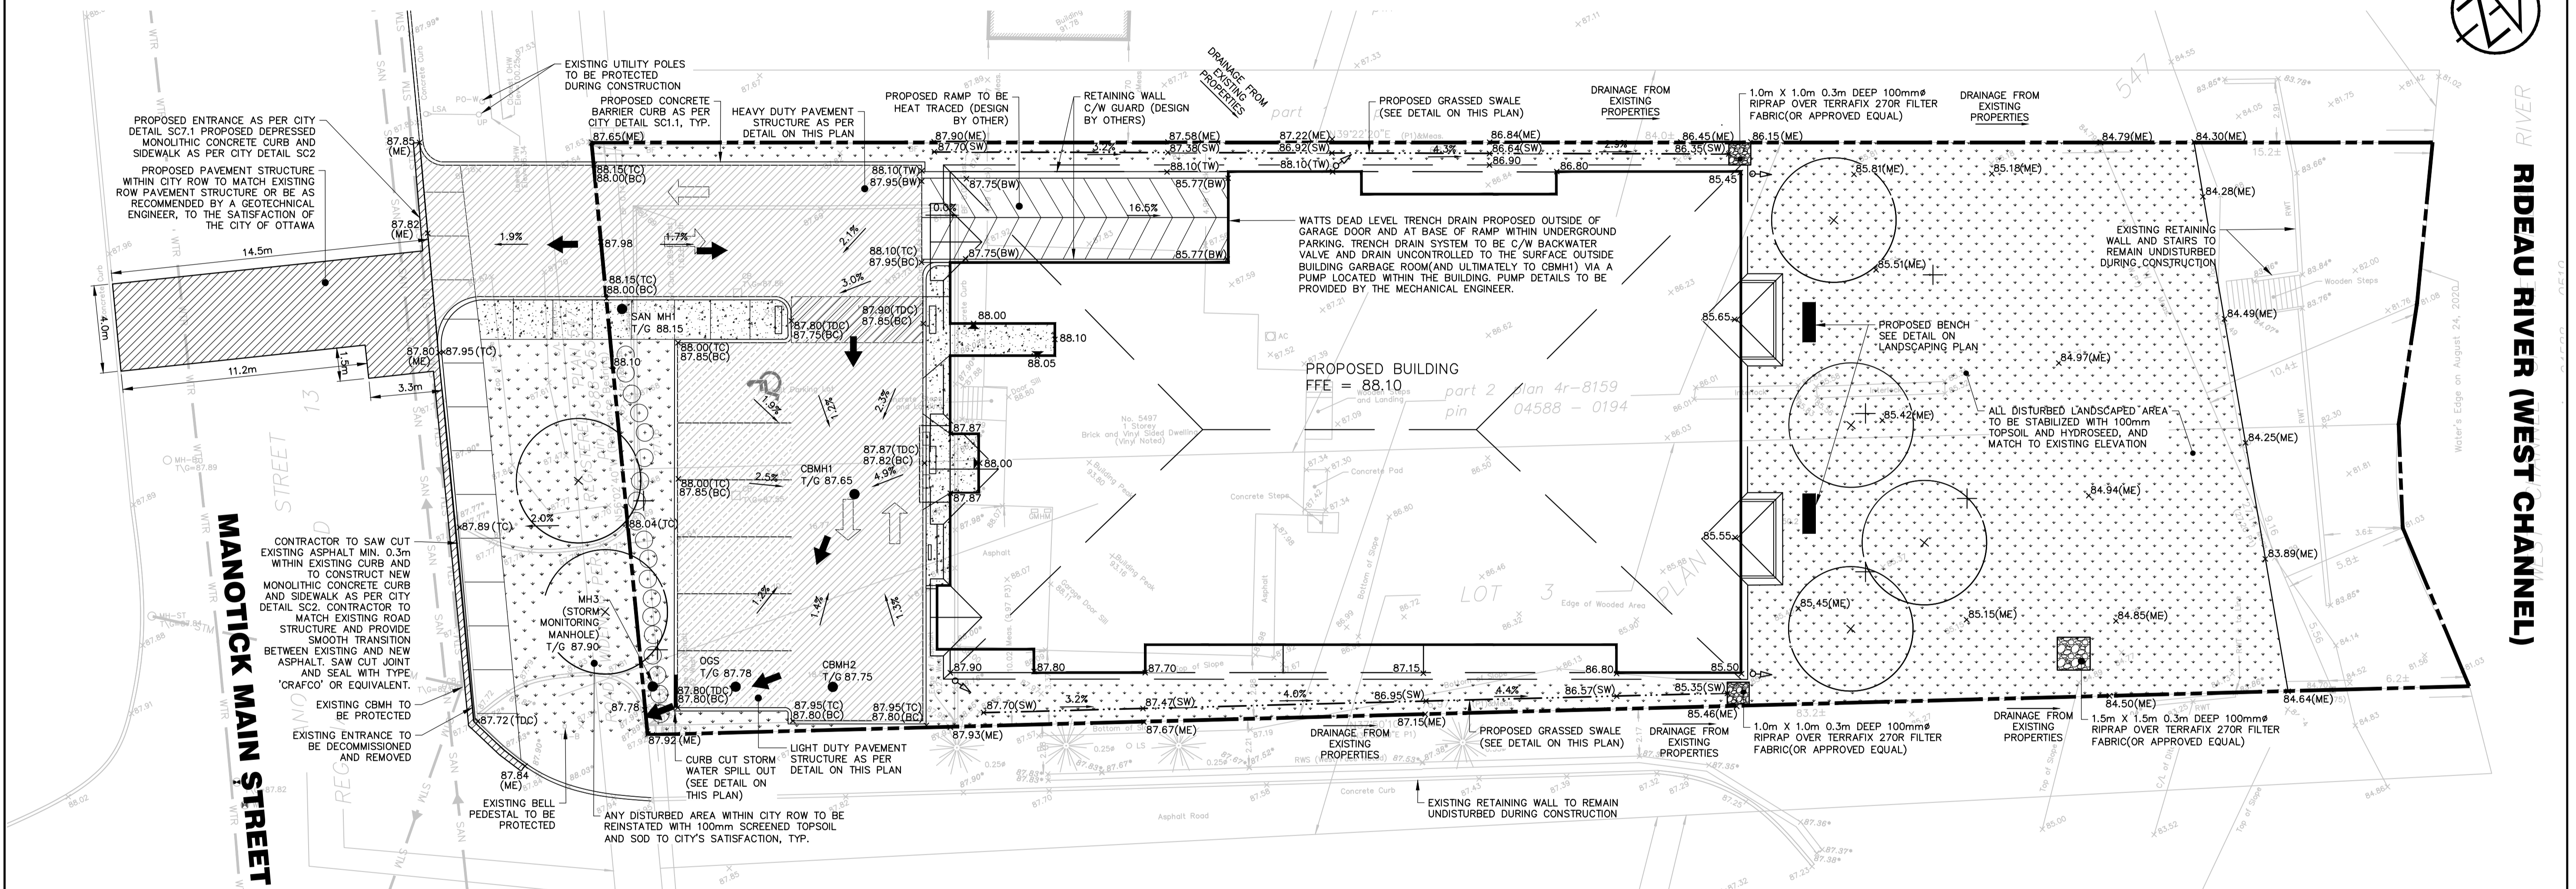
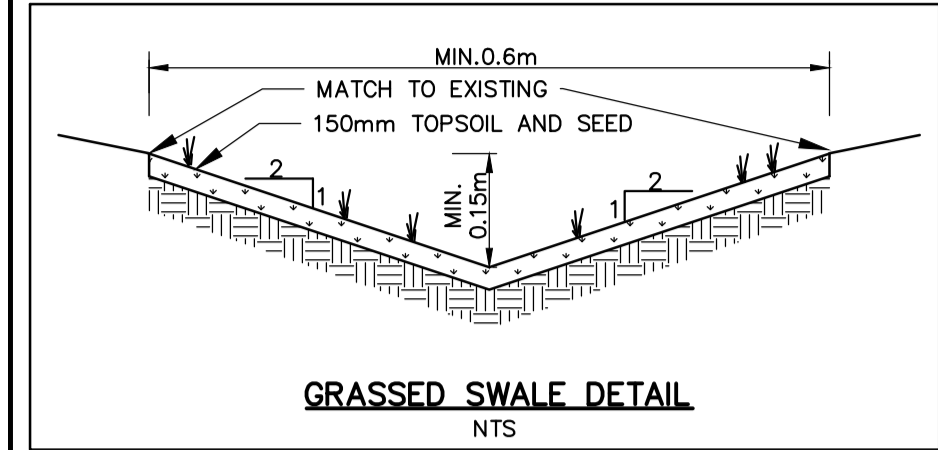
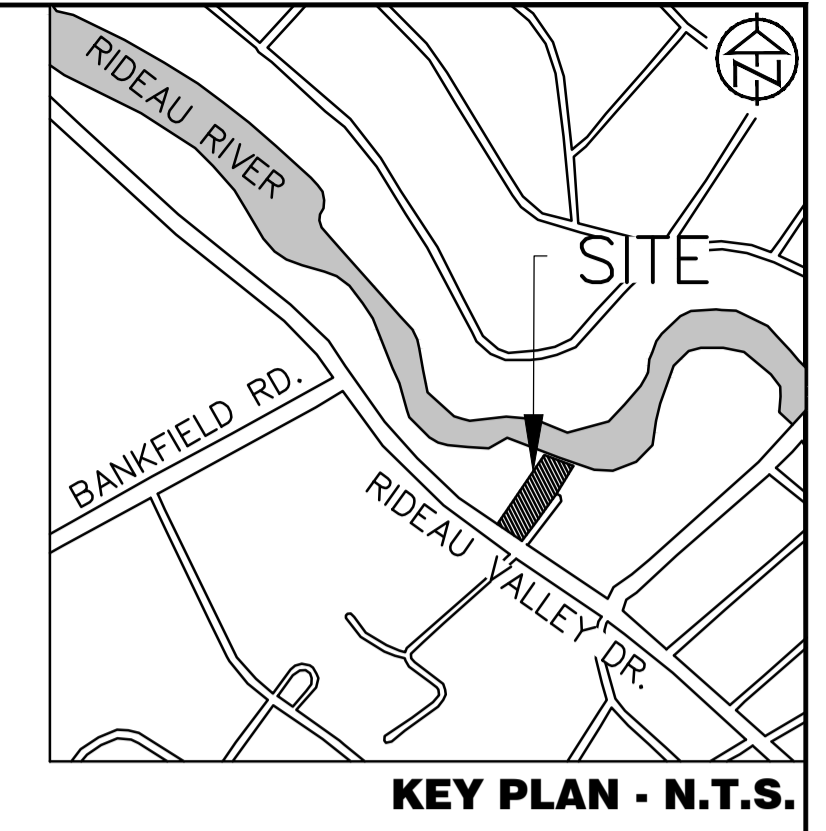


ONSITE PAVEMENT STRUCTURE			
Course	Compaction Requirement	Light Duty	Heavy Duty
Surface Course Asphalt	OPSS 310	50mm HL3	40mm HL3
Binder Course Asphalt	OPSS 310	50mm HL8	50mm HL8
Granular Base	100% SPMD(ASM-D698)	150mm OPSS 1010 Granular A	150mm OPSS 1010 Granular A
Granular Subbase	100% SPMD(ASM-D698)	300mm OPSS 1010 Granular B Type II	450mm OPSS 1010 Granular B Type II

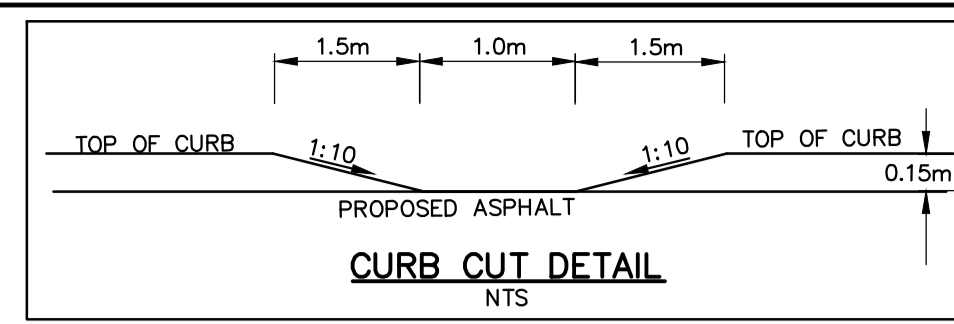

LEGEND

	x 262.25	PROPOSED ELEVATION
	x 262.25(ME)	MATCH EXISTING ELEVATION
	x 262.25(TC)	PROPOSED TOP OF CURB
	x 262.25(BC)	PROPOSED BOTTOM OF CURB
	x 262.25(BL)	PROPOSED BOTTOM OF LANDING
	x 262.25(DTC)	PROPOSED DEPRESSED TOP OF CURB
	x 262.25(TL)	PROPOSED TOP OF LANDING
	x 262.25(BL)	PROPOSED BOTTOM OF LANDING
	-89.20-	EXISTING COUNTER
	- - -	PROPERTY BOUNDARY

DISCLAIMER AND COPYRIGHT
 CONTRACTOR MUST VERIFY ALL DIMENSIONS AND BE RESPONSIBLE FOR SAME. ANY DISCREPANCIES MUST BE REPORTED TO THE ENGINEER BEFORE COMMENCING WORK. DRAWINGS ARE NOT TO BE SCALED.
 TATHAM ENGINEERING LIMITED CLAIMS COPYRIGHT TO THIS DRAWING WHICH MAY NOT BE USED FOR ANY PURPOSE OTHER THAN THAT PROVIDED IN THE CONTRACT BETWEEN THE OWNER/CLIENT AND THE ENGINEER WITHOUT THE EXPRESS CONSENT OF TATHAM ENGINEERING LIMITED.

SURVEY
 TOPOGRAPHIC SURVEY WAS COMPLETED BY ANNIS, O'SULLIVAN, VOLLEBECK LTD. ONTARIO LAND SURVEYORS, DATED JULY 26, 2022. ELEVATIONS SHOWN ARE GEODETIC AND ARE REFER TO THE CGVD28 GEODETIC DATUM.
IBM: TOP OF CB GRATE LOCATED ON SOUTH SIDE OF SITE ENTRANCE, ELEVATION 87.69.

No.	REVISION DESCRIPTION	DATE	ENGINEER STAMP
1.	ISSUED FOR SPA	JULY, 2023	
2.	RE-ISSUED FOR SPA	MAY, 2024	
3.	RE-ISSUED FOR SPA	OCT, 2024	
4.	RE-ISSUED FOR SPA	NOV, 2024	

5497 MANOTICK MAIN ST.
CITY OF OTTAWA

SITE GRADING PLAN

DESIGN: HY	FILE: 522679	DWG: C200
DRAWN: HY	DATE: JULY 2023	
CHECK: GC	SCALE: 1:150	