

FINISH MATERIAL LEGEND:

- AC1 ALUMINUM CORNER CAP
- AC2 ALUMINUM CURTAIN HALL FRAMING (PRE FINISHED)
- AC3 ALUMINUM CAP FLASHING (PRE FINISHED)
- AC4 ALUMINUM 4 GLASS PRIVACY SCREEN
- AC5 ALUMINUM 4 GLASS GUARD C/W ALUMINUM RAILING
- AL ALUMINUM LOUVER (PREFINISHED)
- AD ALUMINUM DOOR
- AP1 ALUMINUM SIDING (PRE FINISHED) (COLOUR 1)
- AP2 ALUMINUM SIDING (PRE FINISHED) (COLOUR 2)
- AP3 ALUMINUM SIDING (PRE FINISHED) (COLOUR 3)
- AS ALUMINUM WINDOW FRAMING - FLACED
- AS2 WINDOW SYSTEM (PRE FINISHED)
- BR1 BRICK MASONRY - TYPE 1
- BR2 BRICK MASONRY - TYPE 2
- EC EXPOSED CONCRETE (BALCONIES, CANOPES)
- ECA EXPOSED ARCHITECTURAL FINISHED CONCRETE (SMOOTH FINISH)
- HD HOLLOW METAL DOOR (INSULATED)
- HT METAL TRUSSES
- OD OVERHEAD DOOR - PRE FINISHED
- PC PRECAST CONCRETE
- PF1 PRE-FINISH METAL CAP FLASHING
- PF2 PAINTED STEEL POST
- PF3 PRE-FINISH METAL FLASHING
- RF RETAINING WALL (SEE LANDSCAPING)
- ST1 STONE VENEER - TYPE 1
- ST2 STEEL CANOPY
- SP1 SPANDREL GLASS COLOUR 1
- SP2 WOOD FENCE (SEE LANDSCAPING)

- W WINDOW TYPE, FLACED WINDOW SYSTEM, REFER TO WINDOW SCHEDULE
- WH WINDOW HALL TYPE, REFER TO WINDOW SCHEDULE
- DN DOOR NUMBER, REFER TO DOOR SCHEDULE
- SA MASONRY SHELF ANGLE
- SAA SUSPENDED MASONRY SHELF ANGLE
- C.J MASONRY CONTROL JOINT
- LF EXTERIOR LIGHT FIXTURE, REFER TO ELEC. DWGS.
- AL ALUMINUM LOUVER
- SP SPANDREL GLASS PANEL
- ALM ALUMINUM LOUVER
- ASP ALUMINUM SPANDREL PANEL
- OS OPERABLE WINDOW SASH - OUT SWINDING

no.	date	revision
2	MAY /2024	ISSUED FOR SITE PLAN
1	DEC /2023	ISSUED FOR CLASS 'D' ESTIMATE

It is the responsibility of the appropriate contractor to check and verify all dimensions on site and report all errors and/or omissions to the architect.

All contractors must comply with all pertinent codes and by-laws.

Do not scale drawings.

This drawing may not be used for construction until signed.

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PROJECT/LOCATION:
GLADSTONE & LORETTA RESIDENTIAL TOWER
 145 LORETTA AVE. NORTH

DRAWING TITLE:
EAST ELEVATION

DRAWN BY: TD / JC	DATE: OCT.2023	SCALE: 1:200
PROJECT: 1726		DRAWING NO.:
REVISION NO.:		A3.02

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18526



FINISH MATERIAL LEGEND:

- [ACG] ALUMINUM CORNER CAP
- [ACF] ALUMINUM CURTAIN WALL FINISHING (PRE FINISHED)
- [AFL] ALUMINUM CAP FLASHING (PRE FINISHED)
- [ASP] ALUMINUM 4 GLASS PRIVACY SCREEN
- [ASR] ALUMINUM 4 GLASS GUARD C/W ALUMINUM RAILING
- [AL] ALUMINUM LOUVER (PREFINISHED)
- [AD] ALUMINUM DOOR
- [ALP] ALUMINUM SIDING (PRE FINISHED) (COLOUR 1)
- [AL2] ALUMINUM SIDING (PRE FINISHED) (COLOUR 2)
- [AL3] ALUMINUM SIDING (PRE FINISHED) (COLOUR 3)
- [AFR] ALUMINUM WINDOW FRAMING - FINISHED
- [KFS] WINDOW SYSTEM (PRE FINISHED)
- [B1] BRICK MASONRY - TYPE 1
- [B2] BRICK MASONRY - TYPE 2
- [EC] EXPOSED CONCRETE (BALCONIES, CANOPES)
- [ECAF] EXPOSED ARCHITECTURAL FINISHED CONCRETE (SMOOTH FINISH)
- [HMD] HOLLOW METAL DOOR (INSULATED)
- [MS] METAL SIDING - TYPE 1 (PRE FINISHED)
- [MT] METAL TRELLIS
- [OSD] OVERHEAD DOOR - PRE FINISHED
- [PC] PRECAST CONCRETE
- [PFC] PRE-FINISH METAL CAP FLASHING
- [PSP] PAINTED STEEL POST
- [PFM] PRE-FINISH METAL FLASHING
- [RML] RETAINING WALL (SEE LANDSCAPING)
- [ST1] STONE VENEER - TYPE 1
- [SC] STEEL CANOPY
- [SPC] SPANDREL GLASS COLOUR 1
- [SP] SPANDREL GLASS (PREFINISHED)
- [WPF] WOOD FENCE (SEE LANDSCAPING)

WINDOW TYPE:

- [W] WINDOW TYPE FINISHED WINDOW SYSTEM REFER TO WINDOW SCHEDULE
- [CW] CURTAIN WALL TYPE REFER TO WINDOW SCHEDULE
- [DNR] DOOR NUMBER REFER TO DOOR SCHEDULE
- [SA] MASONRY SHELF ANGLE
- [SAA] SUSPENDED MASONRY SHELF ANGLE
- [CJ] MASONRY CONTROL JOINT
- [LF] EXTERIOR LIGHT FIXTURE REFER TO ELEC DWGS THROUGH WALL

GLASS:

- [PFL] PRE FINISHED ALUMINUM LOUVERS
- [SPN] SPANDREL GLASS PANEL
- [AL] ALUMINUM LOUVER
- [ASPAN] ALUMINUM SPANDREL PANEL
- [SOT] SHIMMED OFFSHORE (WINDOW SASH - OUT SWINDING)

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 GLADSTONE & LORETTA
 RESIDENTIAL TOWER
 145 LORETTA AVE. NORTH

DRAWING TITLE:
 NORTH ELEVATION

DRAWN BY:	DATE:	SCALE:
TD / JC	OCT.2023	1:200

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FINISH MATERIAL LEGEND:

- AC1 ALUMINUM CORNER CAP
- AC2 ALUMINUM CURTAIN HALL FRAMING (PRE FINISHED)
- AL1 ALUMINUM CAP FLASHING (PRE FINISHED)
- AS1 ALUMINUM 4 GLASS PRIVACY SCREEN
- AS2 ALUMINUM 4 GLASS GUARD C/W ALUMINUM RAILING
- AL3 ALUMINUM LOUVER (PREFINISHED)
- AD1 ALUMINUM DOOR
- AL4 ALUMINUM SIDING (PRE FINISHED) (COLOUR 1)
- AL5 ALUMINUM SIDING (PRE FINISHED) (COLOUR 2)
- AL6 ALUMINUM SIDING (PRE FINISHED) (COLOUR 3)
- AL7 ALUMINUM WINDOW FRAMING - FLACED
- AL8 WINDOW SYSTEM (PRE FINISHED)
- BR1 BRICK MASONRY - TYPE 1
- BR2 BRICK MASONRY - TYPE 2
- EC1 EXPOSED CONCRETE (BALCONIES, CANOPES)
- EA1 EXPOSED ARCHITECTURAL FINISHED CONCRETE (SMOOTH FINISH)
- HE1 HOLLOW METAL DOOR (INSULATED)
- ME1 METAL SIDING - TYPE 1 (PRE FINISHED)
- MT1 METAL TRELLIS
- OS1 OVERHEAD DOOR - PRE FINISHED
- PC1 PRECAST CONCRETE
- PF1 PRE-FINISH METAL CAP FLASHING
- PP1 PAINTED STEEL POST
- PR1 PRE-FINISH METAL FLASHING
- RE1 RETAINING WALL (SEE LANDSCAPING)
- ST1 STONE VENEER - TYPE 1
- SC1 STEEL CANOPY
- SP1 SPANDREL GLASS COLOUR 1
- XP1 WOOD FENCE (SEE LANDSCAPING)

WINDOW TYPE: WINDOW SYSTEM REFER TO WINDOW SCHEDULE

CURTAIN HALL TYPE: REFER TO WINDOW SCHEDULE

DOOR NUMBER: REFER TO DOOR SCHEDULE

MASONRY SHELF ANGLE: SA

SUSPENDED MASONRY SHELF ANGLE: SA.A

MASONRY CONTROL JOINT: C.J

EXTERIOR LIGHT FIXTURE: REFER TO ELEC. DWGS. THROUGH WALL

PRE FINISHED ALUMINUM LOUVERS: [Symbol]

SPANDREL GLASS PANEL: [Symbol]

ALUMINUM LOUVER: [Symbol]

ALUMINUM SPANDREL PANEL: [Symbol]

SPRITES (OFFSHADE WINDOW SASH - OUT STANDING): [Symbol]

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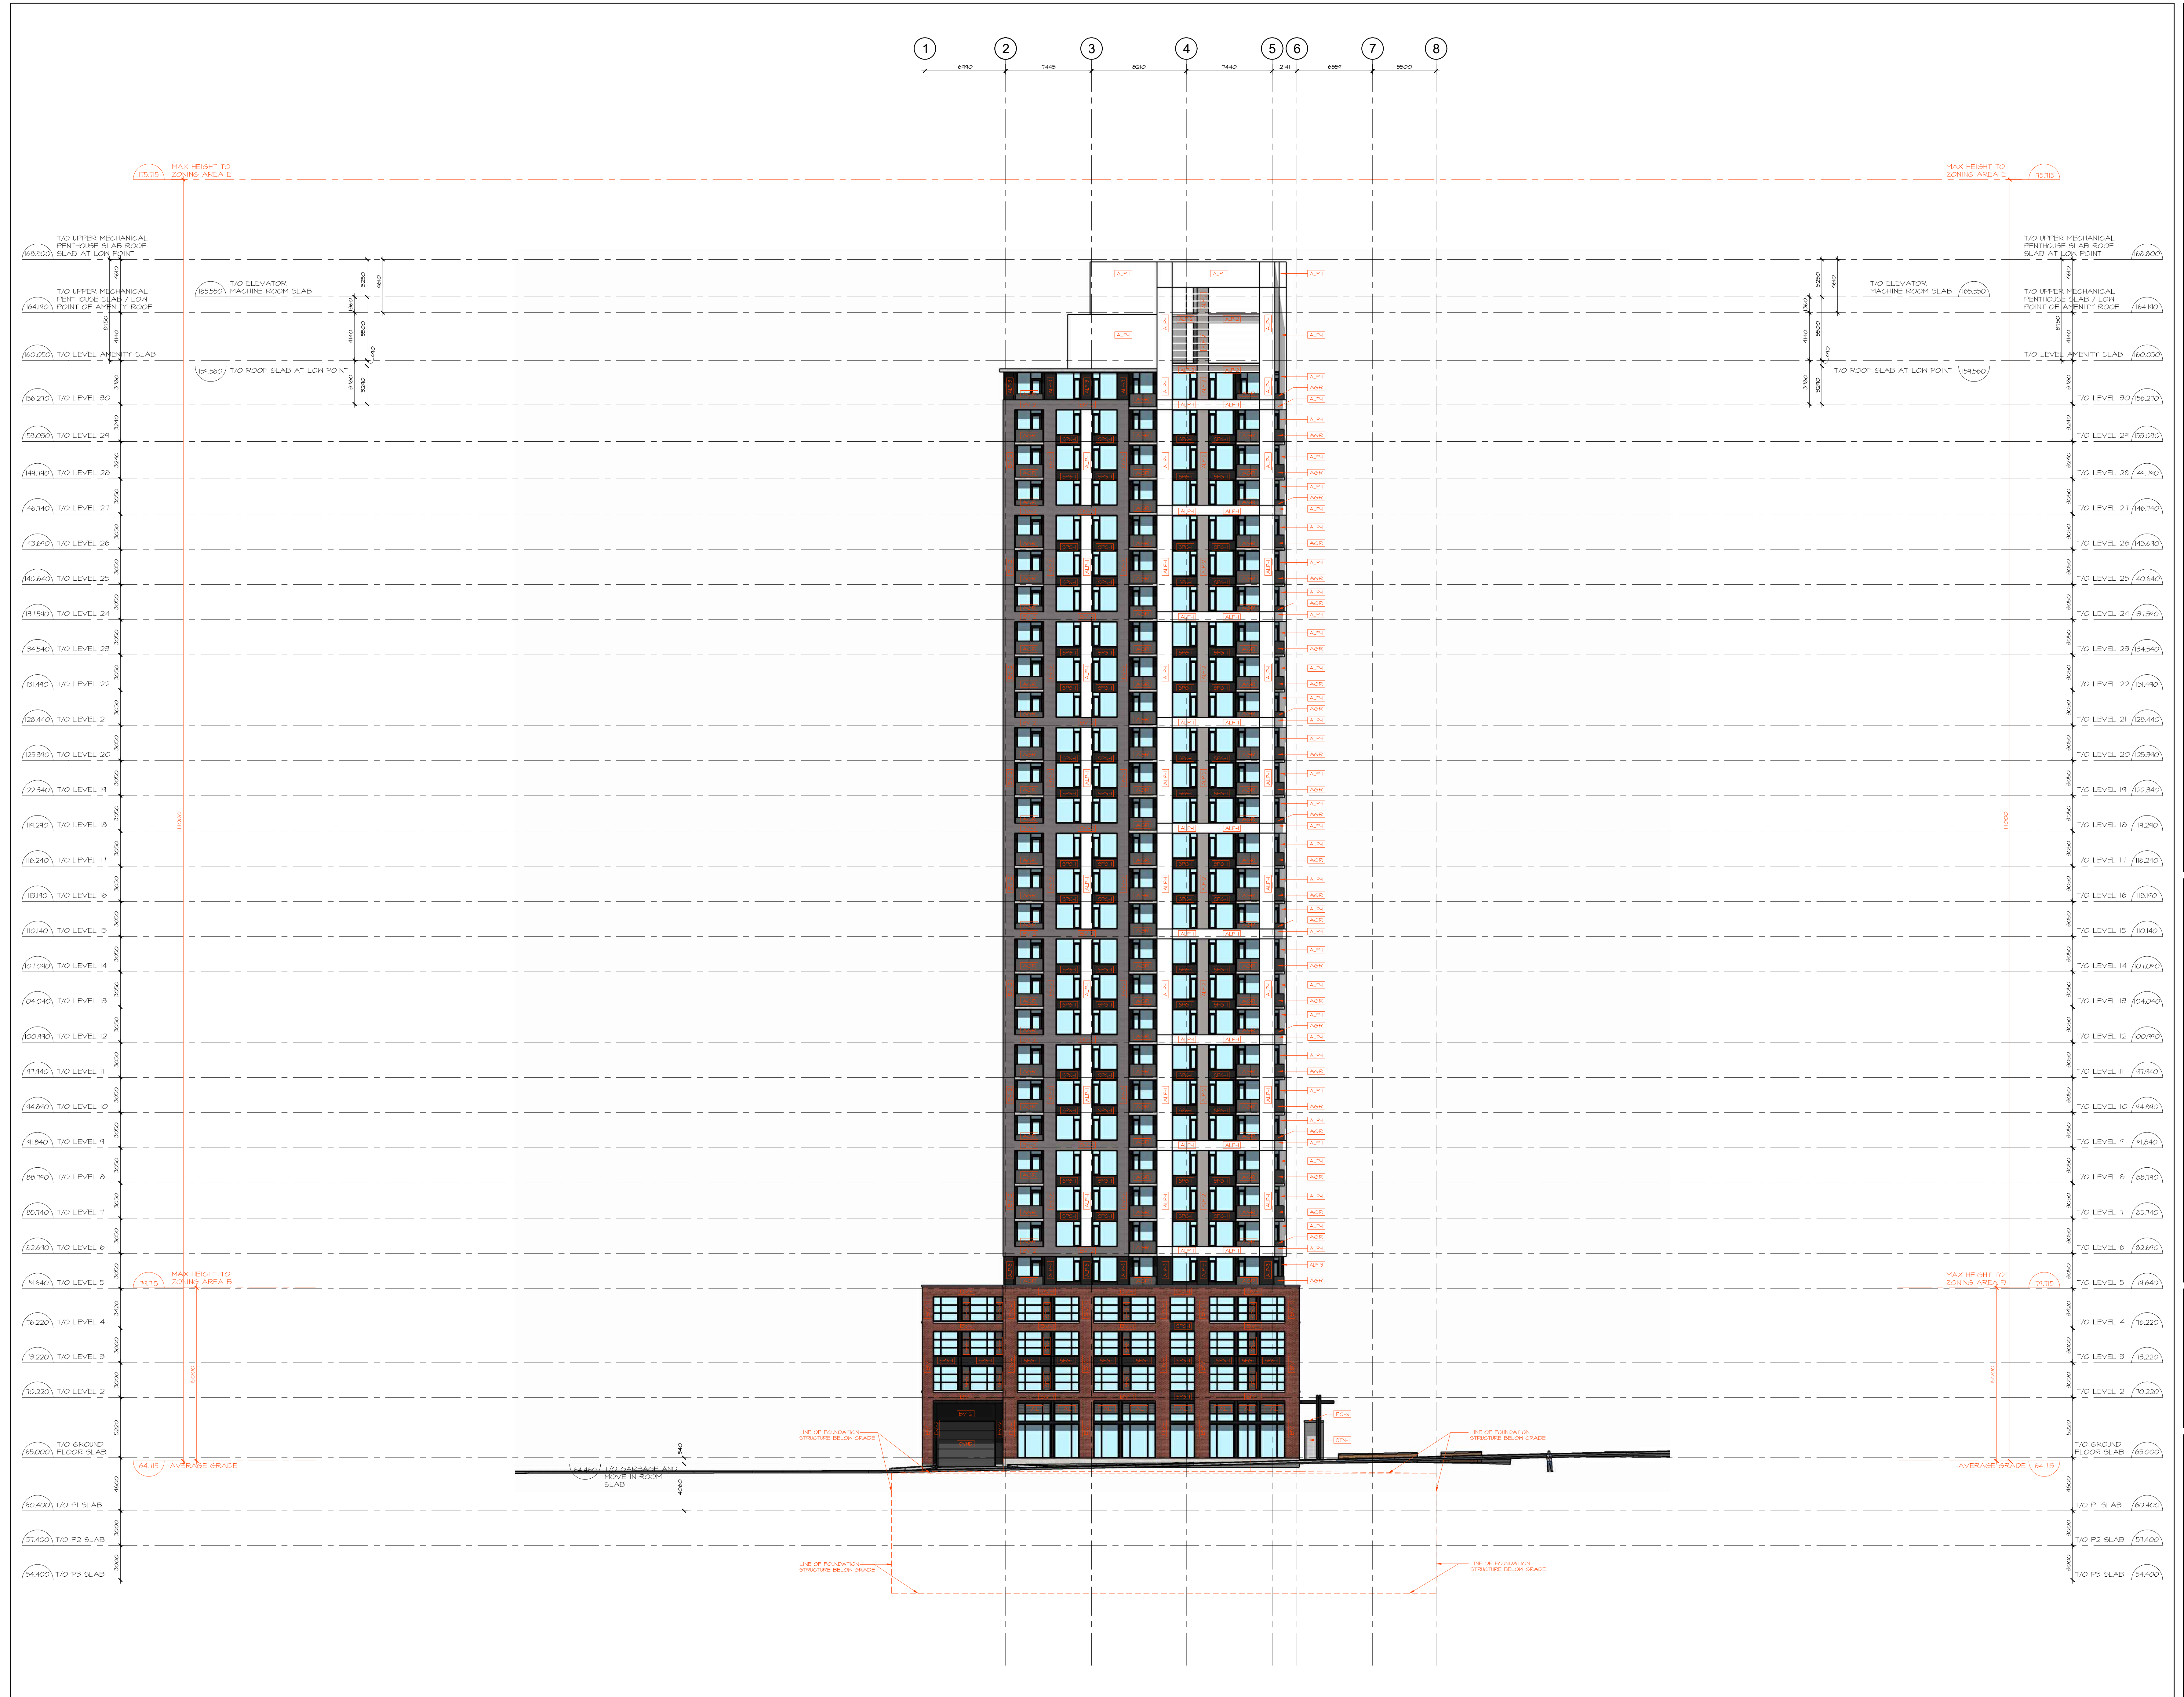
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PROJECT/LOCATION:
GLADSTONE & LORETTA RESIDENTIAL TOWER
 145 LORETTA AVE. NORTH

DRAWING TITLE:
SOUTH ELEVATION

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FINISH MATERIAL LEGEND:

AC1	ALUMINUM CORNER CAP
AC2	ALUMINUM CURTAIN HALL FINISHING (PRE FINISHED)
AC3	ALUMINUM CAP FLASHING (PRE FINISHED)
AC4	ALUMINUM # 4 GLASS PRIVACY SCREEN
AC5	ALUMINUM # 4 GLASS GUARD CAY ALUMINUM RAILING
AL	ALUMINUM LOUVER (PREFINISHED)
AD	ALUMINUM DOOR
ALP1	ALUMINUM SIDING (PRE FINISHED) (COLOUR 1)
ALP2	ALUMINUM SIDING (PRE FINISHED) (COLOUR 2)
ALP3	ALUMINUM SIDING (PRE FINISHED) (COLOUR 3)
ALP4	ALUMINUM WINDOW FRAMING - FLASHER
ALP5	WINDOW SYSTEM (PRE FINISHED)
BR1	BRICK MASONRY - TYPE 1
BR2	BRICK MASONRY - TYPE 2
CC	EXPOSED CONCRETE (BALCONIES, CANOPES)
CA	EXPOSED ARCHITECTURAL FINISHED CONCRETE (SMOOTH FINISH)
HD	HOLLOW METAL DOOR (INSULATED)
MT1	METAL SIDING - TYPE 1 (PRE FINISHED)
MT2	METAL SIDING - TYPE 2 (PRE FINISHED)
OTD	OVERHEAD DOOR - PRE FINISHED
PC	PRECAST CONCRETE
PF1	PRE-FINISH METAL CAP FLASHING
PSF	PAINTED STEEL POST
PRF	PRE-FINISH METAL FLASHING
RTN	RETAINING WALL (SEE LANDSCAPING)
ST1	STONE VENEER - TYPE 1
SC	STEEL CANOPY
SP1	SPANDREL GLASS COLOUR 1
SP2	WOOD FENCE (SEE LANDSCAPING)

Window and Door Symbols:

- W: WINDOW TYPE, FLASHER WINDOW SYSTEM, REFER TO WINDOW SCHEDULE
- WV: WINDOW TYPE, REFER TO WINDOW SCHEDULE
- DN: CURTAIN HALL TYPE, REFER TO WINDOW SCHEDULE
- AD: DOOR NUMBER, REFER TO DOOR SCHEDULE
- SA: MASONRY SHELF ANGLE
- SSA: SUSPENDED MASONRY SHELF ANGLE
- C.J: MASONRY CONTROL JOINT
- LF: EXTERIOR LIGHT FIXTURE, REFER TO ELEC. DWGS. THROUGH WALL
- ALP: ALUMINUM LOUVER
- SP: SPANDREL GLASS PANEL
- AL: ALUMINUM LOUVER
- ASP: ALUMINUM SPANDREL PANEL
- OTD: OPERABLE WINDOW SASH - OUT SWINGING

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