



File Location: Z:\Projects\1987-01 Gladstone And Loretta\Drawing\SPA Tower A\1987-01 Gladstone & Loretta (Landscape-PH2)R2.dwg

LEGENE	)
+	DECIDUOUS TREE
	CONIFEROUS TREE
0.300	EXISTING CONIFEROUS TREE
	CONCRETE PAVING
	CONCRETE PAVING WITH SNOWMELT SYSTEM
	UNIT PAVING TYPE 1
	UNIT PAVING TYPE 2
	UNIT PAVING TYPE 3
	RETAINING WALL
	PRECAST CONCRETE SEATING/ PLANTER WALL
	PLANTING BED
	GRASS - SEED + 100 MM TOPSOIL
111	BIKE RACKS
	BENCH
	TWSI
	SIGHT LINES 3.0M-5.0M

File Location: Z:\Projects\1987-01 Gladstone And Loretta\Drawing\SPA Tower A\1987-01 Gladstone & Loretta (Landscape-PH2)B2.

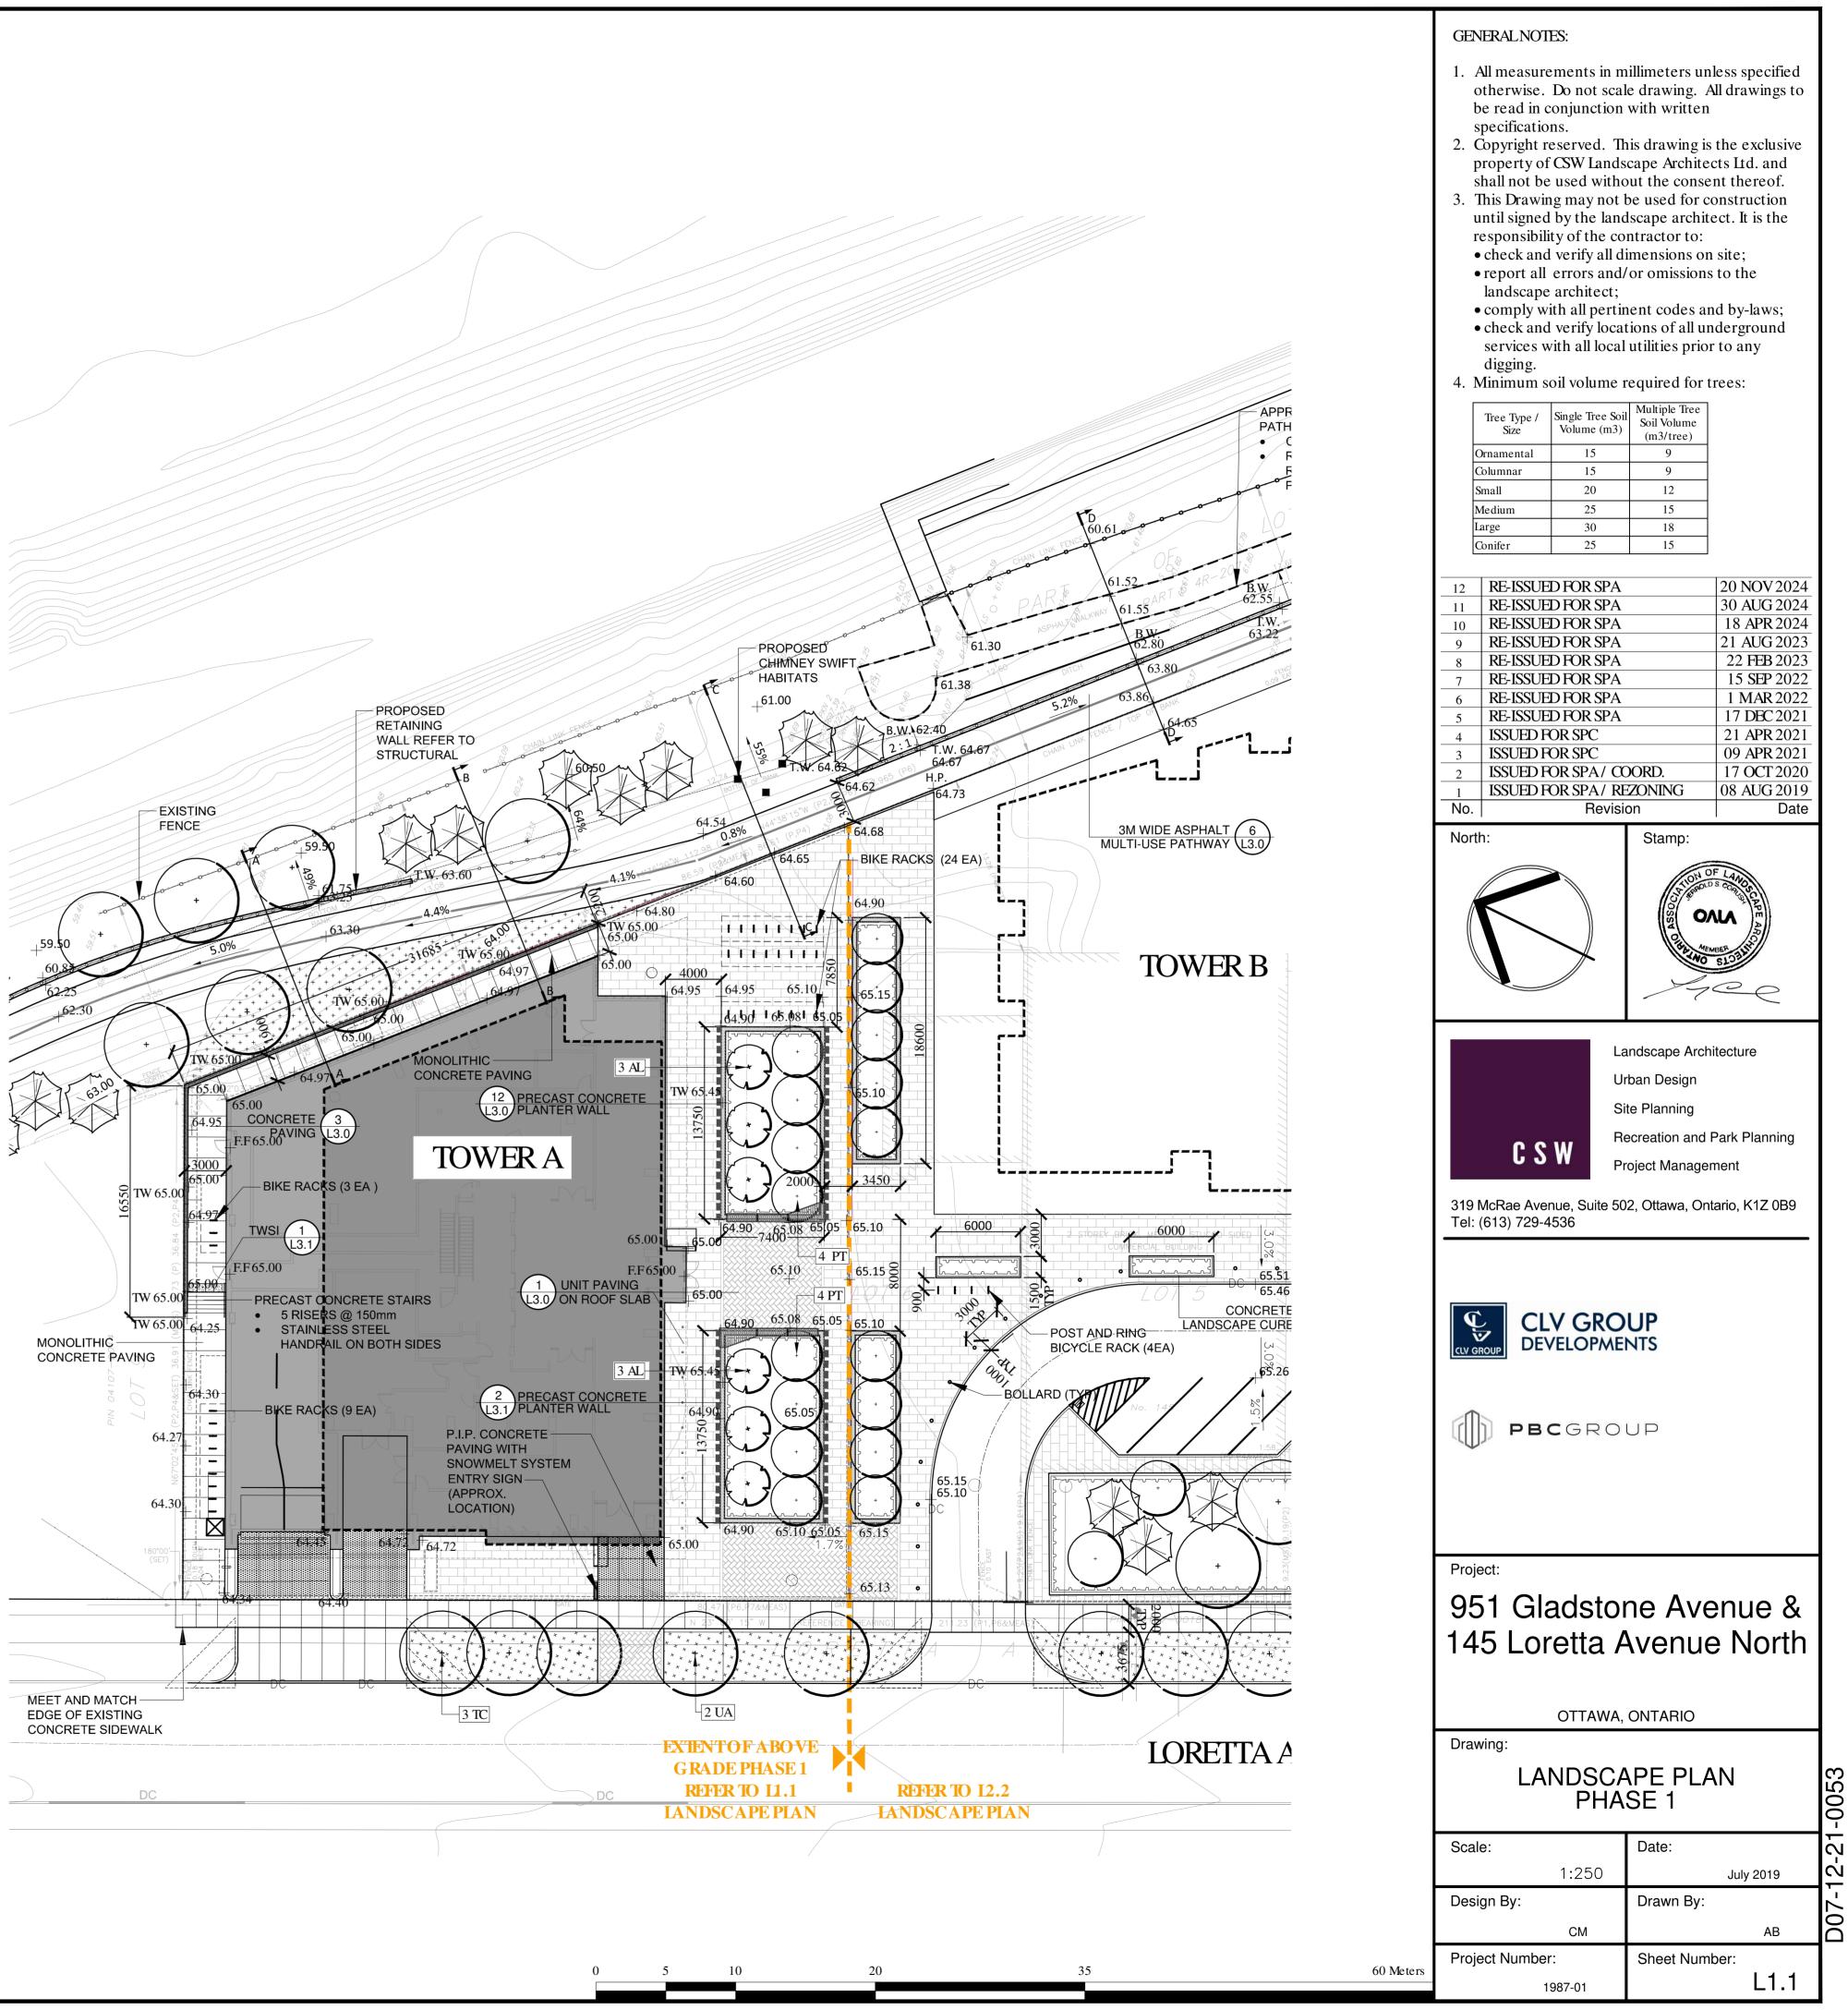

18526

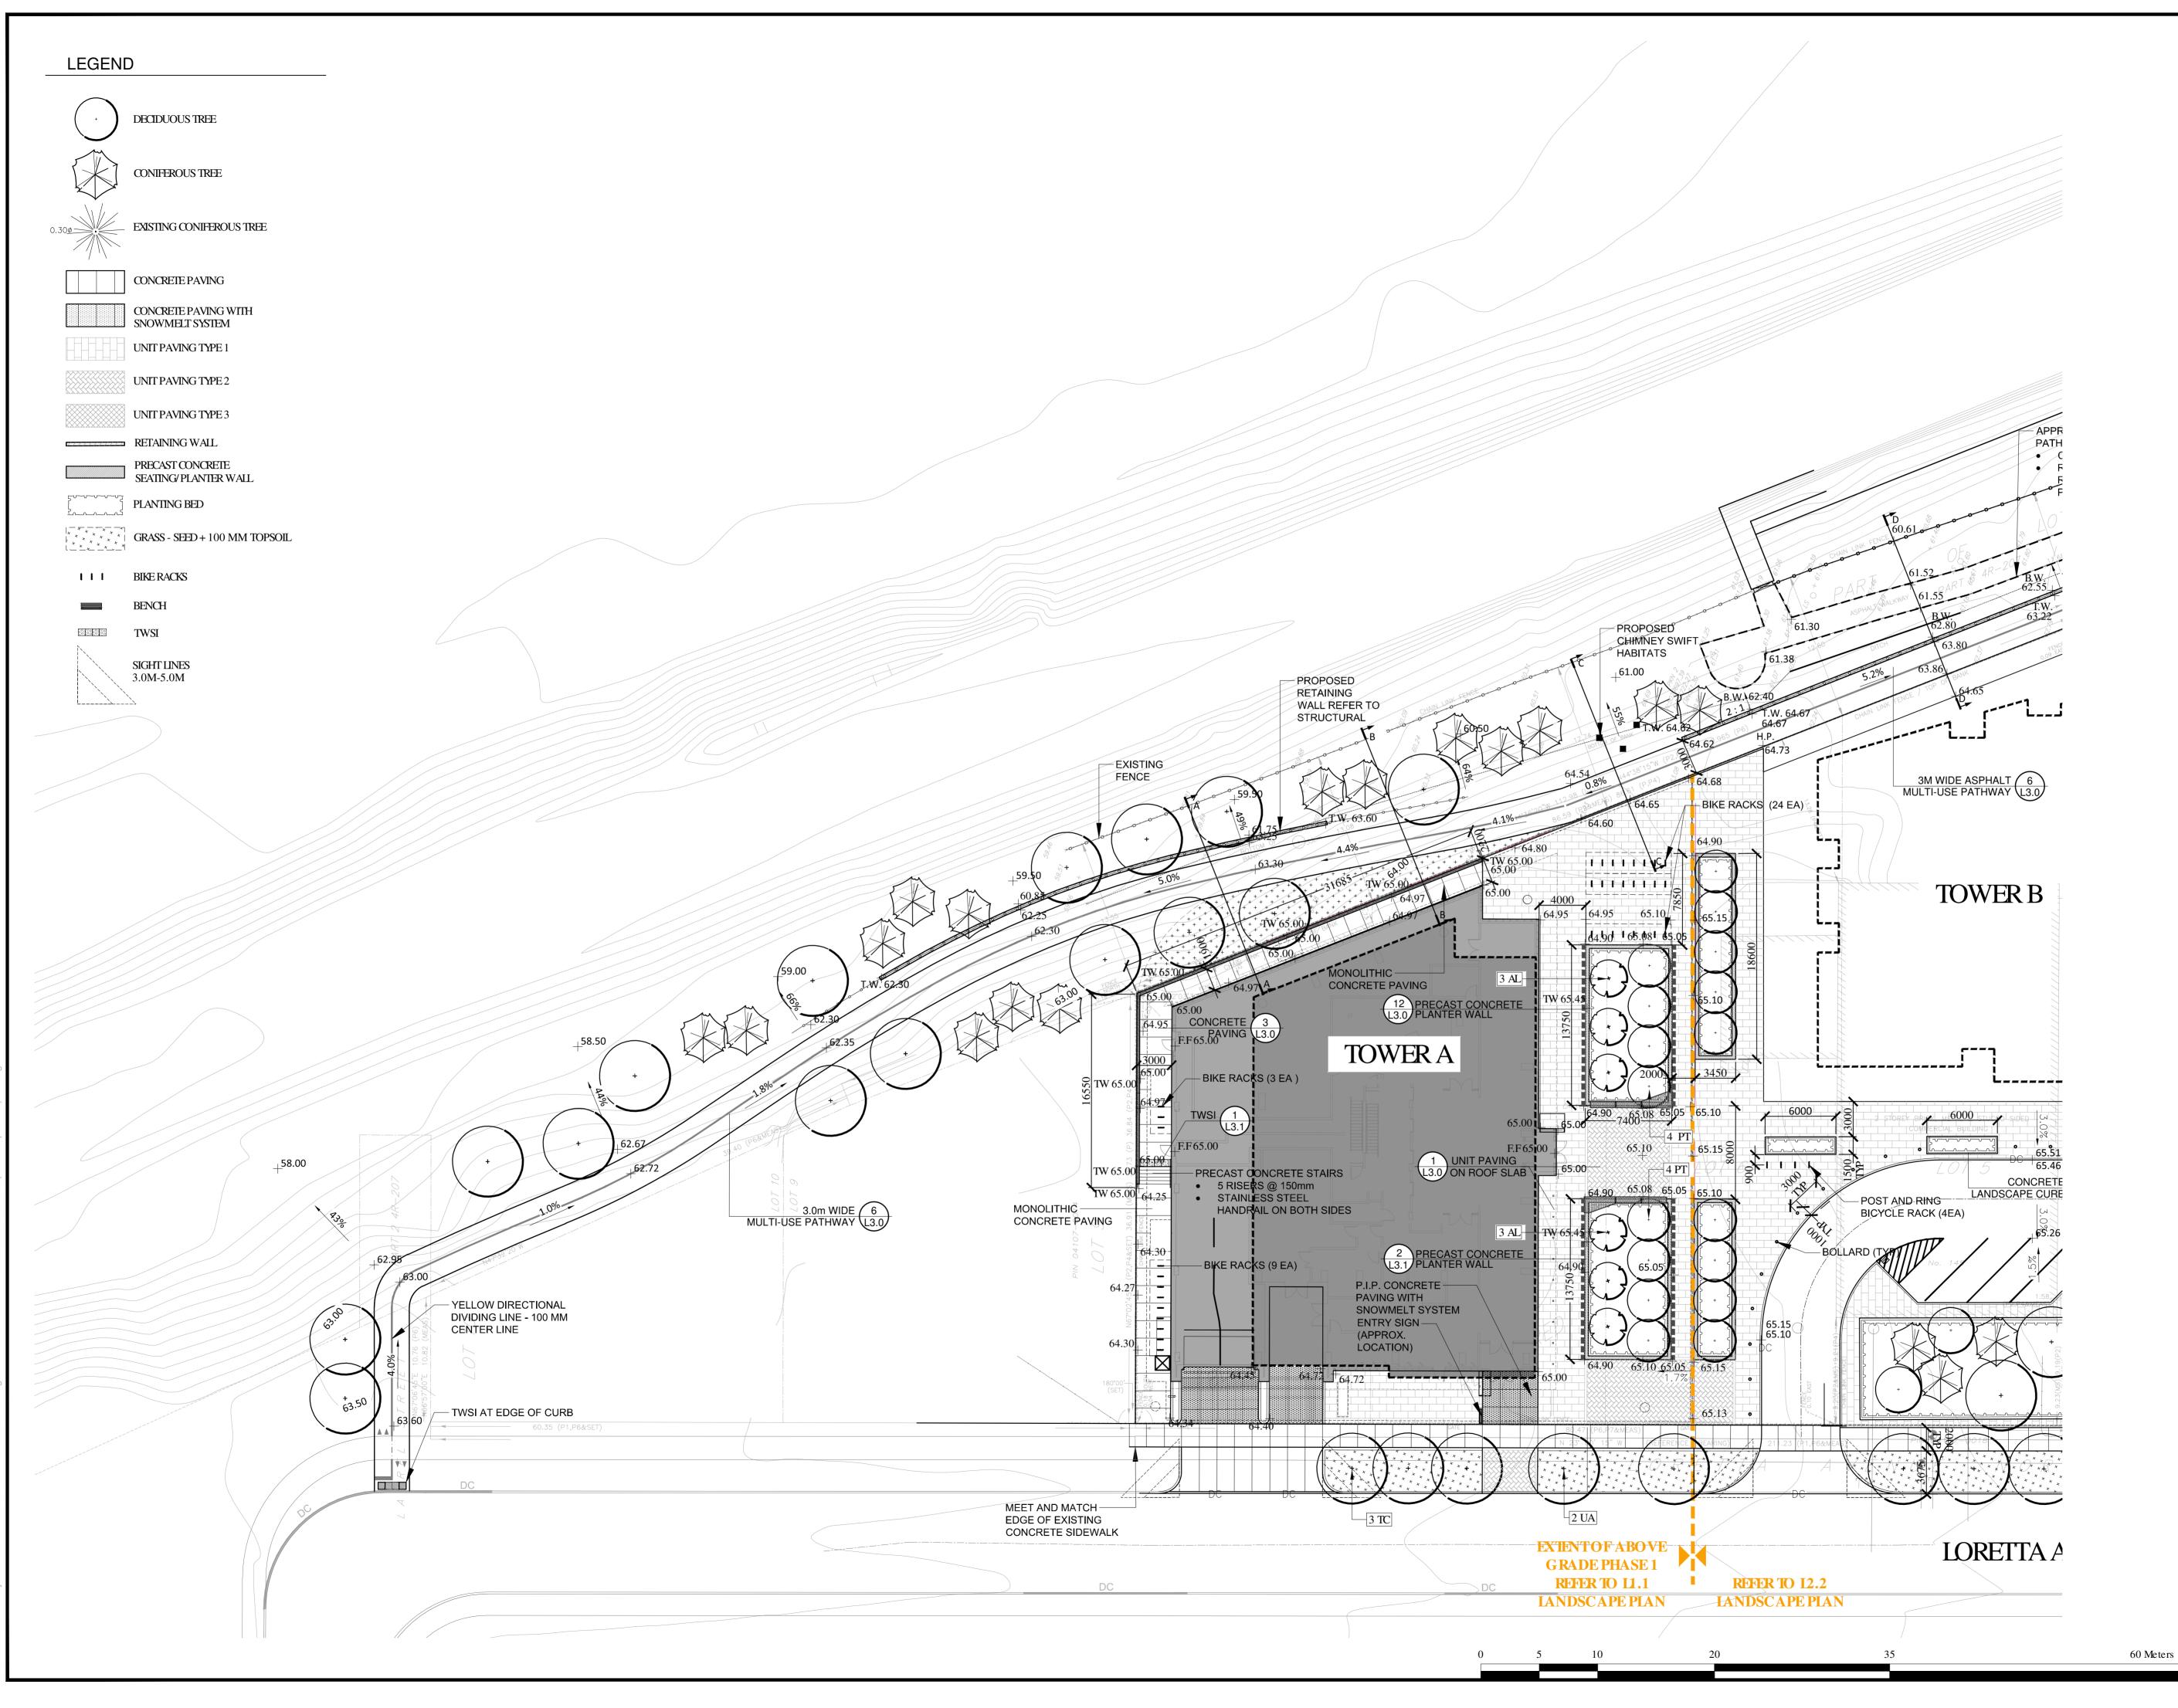



## GENERAL NOTES:

- 1. All measurements in millimeters unless specified otherwise. Do not scale drawing. All drawings to be read in conjunction with written specifications.
- Copyright reserved. This drawing is the exclusive property of CSW Landscape Architects Ltd. and shall not be used without the consent thereof.
- 3. This Drawing may not be used for construction until signed by the landscape architect. It is the responsibility of the contractor to:
- check and verify all dimensions on site; • report all errors and/or omissions to the landscape architect;
- comply with all pertinent codes and by-laws;
  check and verify locations of all underground services with all local utilities prior to any digging.
- 4. Minimum soil volume required for trees:

Tree Type / Size	Single Tree Soil Volume (m3)	Multiple Tree Soil Volume (m3/tree)
Ornamental	15	9
Columnar	15	9
Small	20	12
Medium	25	15
Large	30	18
Conifer	25	15

12	RE-ISSUED FOR SPA	20 NOV 2024
11	RE-ISSUED FOR SPA	30 AUG 2024
10	RE-ISSUED FOR SPA	18 APR 2024
9	RE-ISSUED FOR SPA	21 AUG 2023
8	RE-ISSUED FOR SPA	22 FEB 2023
7	RE-ISSUED FOR SPA	15 SEP 2022
6	RE-ISSUED FOR SPA	1 MAR 2022
5	RE-ISSUED FOR SPA	17 DEC 2021
4	ISSUED FOR SPC	21 APR 2021
3	ISSUED FOR SPC	09 APR 2021
2	ISSUED FOR SPA/ COORD.	17 OCT 2020
1	ISSUED FOR SPA/ REZONING	08 AUG 2019
No.	Revision	Date

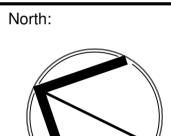

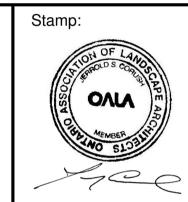



Site Planning Recreation and Park Planning Project Management

319 McRae Avenue, Suite 502, Ottawa, Ontario, K1Z 0B9 Tel: (613) 729-4536




**PBC**GROUP

Project:

# 951 Gladstone Avenue & 145 Loretta Avenue North

OTTAWA,	ONTARIO	
Drawing:		
	APE PLAN RPLAN	2-21-0053
Scale:	Date:	5
1:250	July 2019	
Design By:	Drawn By:	D07-1
СМ	AB	
Project Number:	Sheet Number:	
1987-01	L2.1	
	18526	)

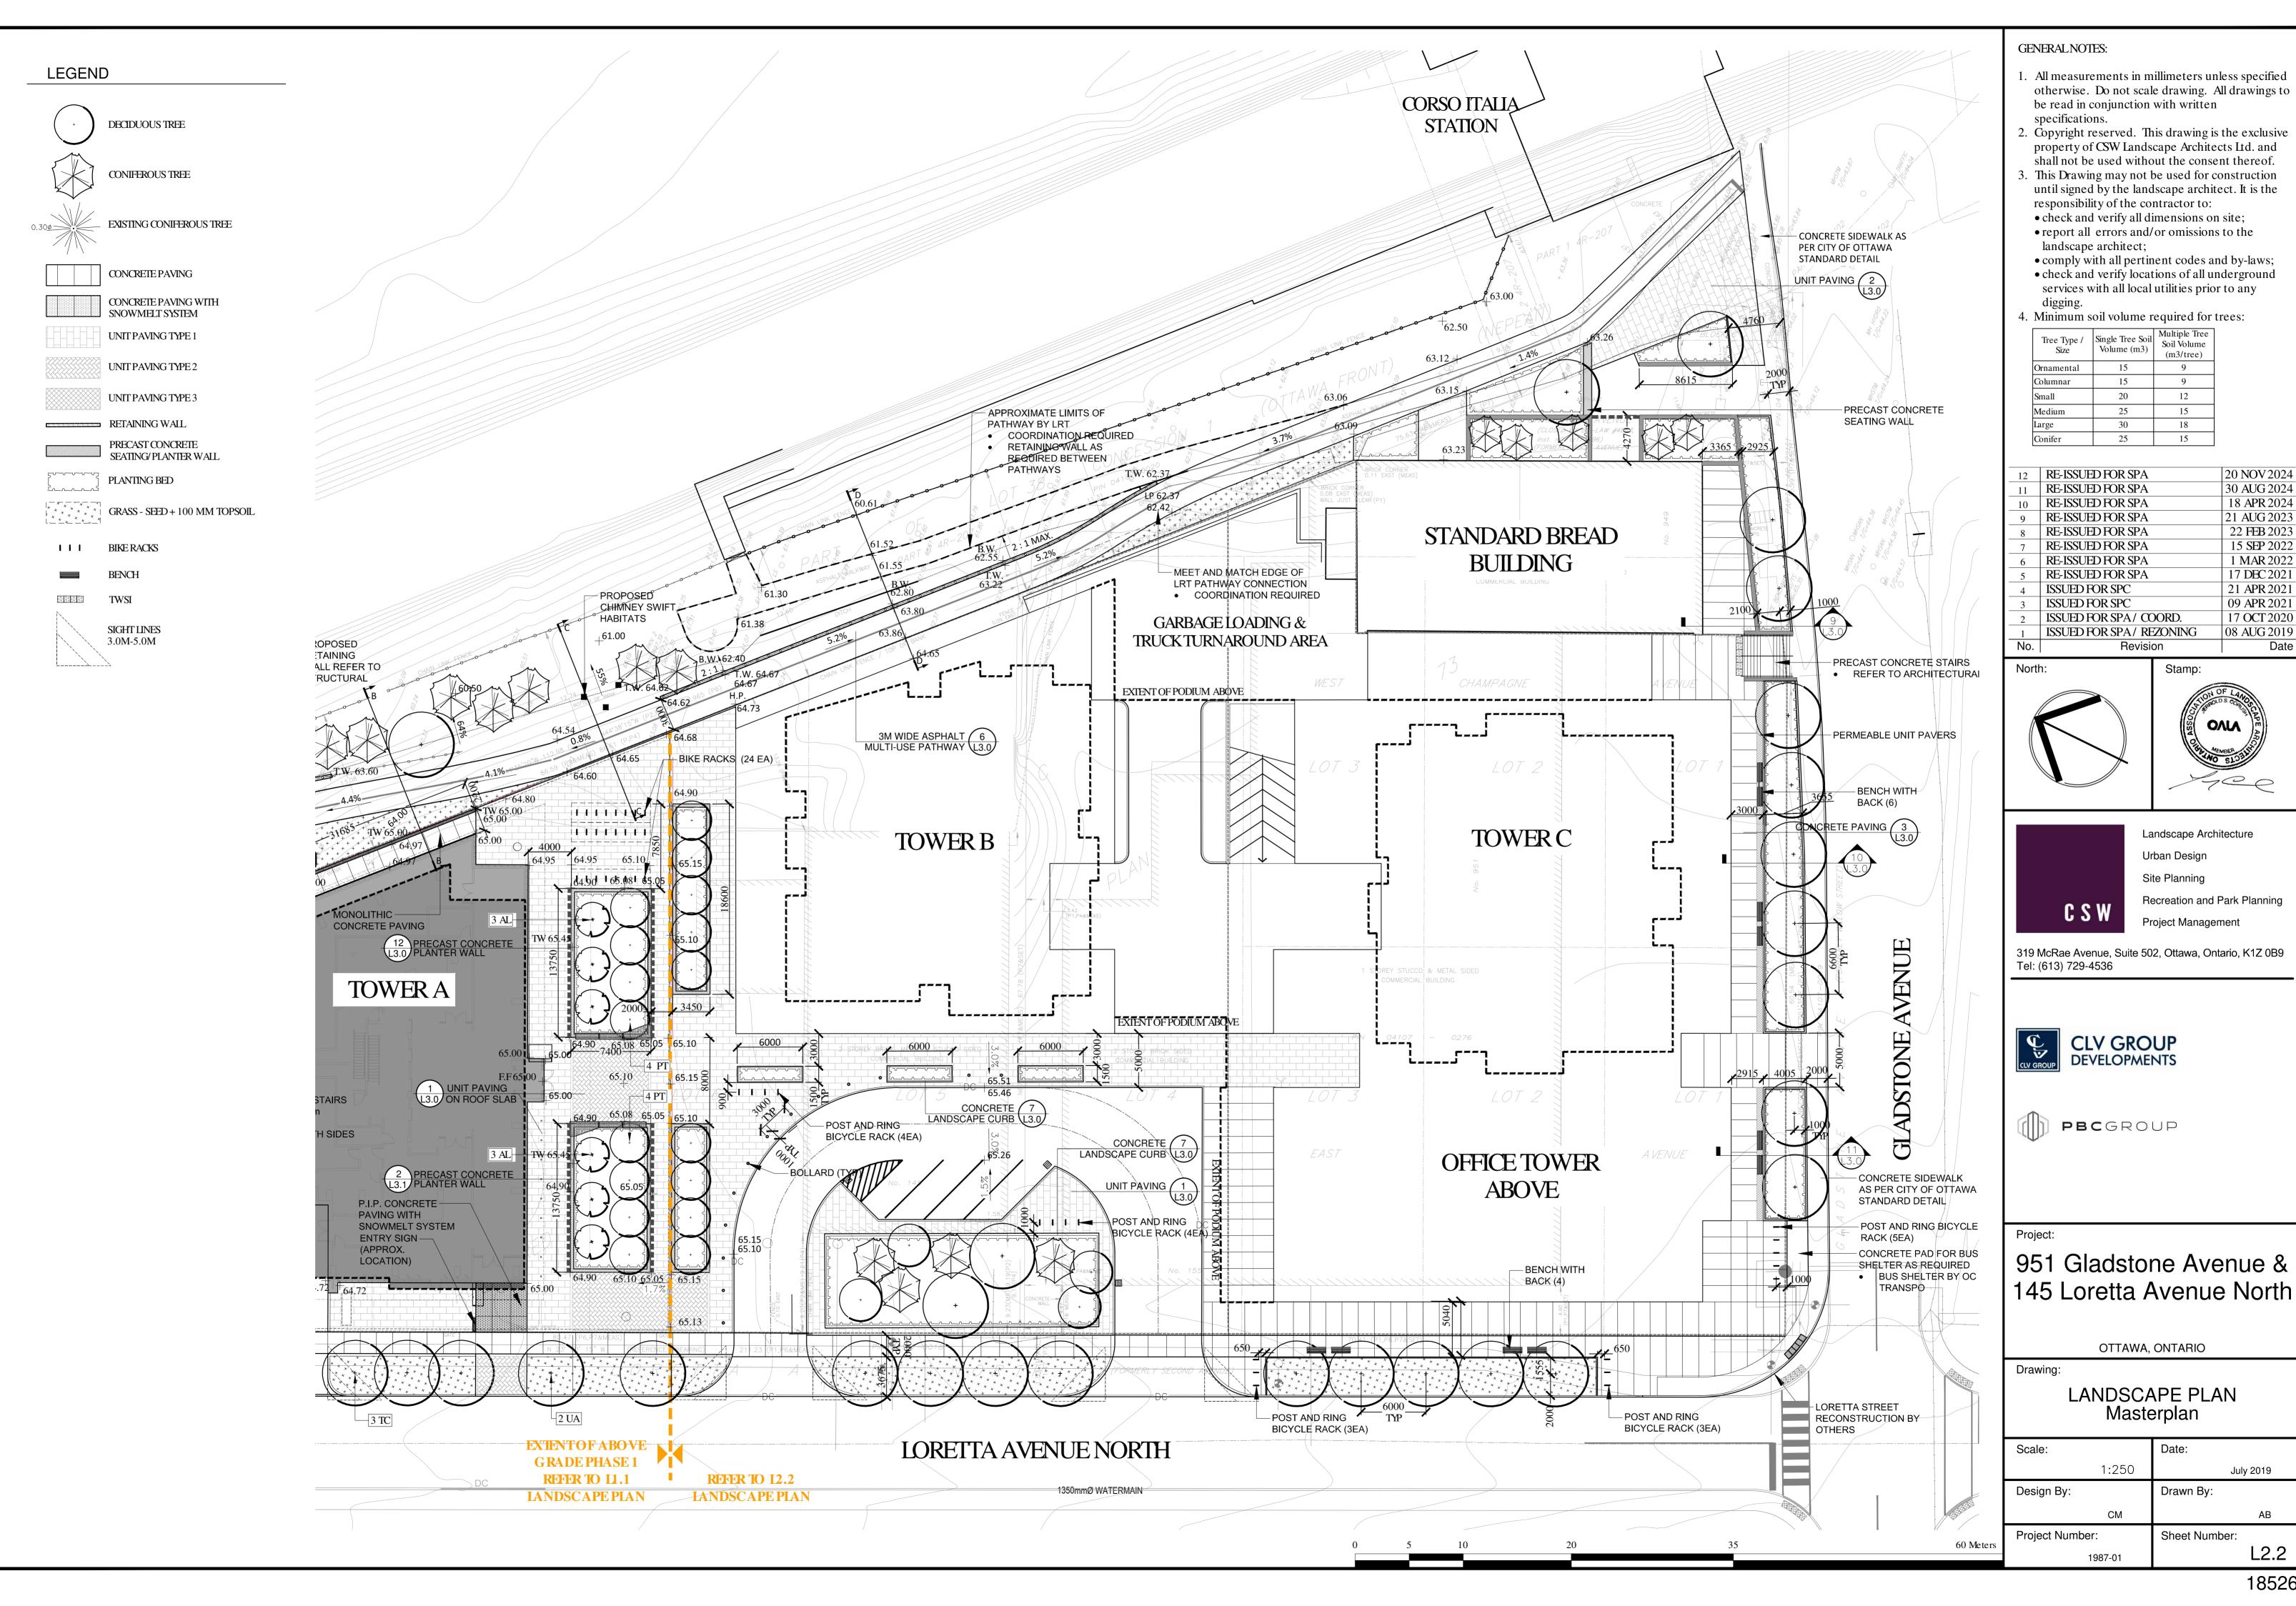


-0053

AB

Date

DECIDUOUS AR AC AL AN FG FA QM QU PD PC PT PC PT PC TC TII UA UL CONIFEROU PN PI PN PI PN PI PN PI SHRUBS SHRUBS SHRUBS	S TREES CER RUBRUM MELANCHIER LAEVIS 'SPRING JJRRY' AGUS GRANDIFOLIA UERCUS MACROCARPA DPULUS DELTOIDES DPULUS TREMULOIDES DPULUS TREMULOIDES IIA CORDATA LMUS AMERICANA 'PIONEER' JS TREES NUS STROBUS CEA PUNGENS SUGA CANADENSIS JNIPERUS HORIZONTALIS 'PLUMOSA OMPACTA' JNIPERUS COMMUNIS DEPRESSA UREA'	COMMON NAME  RED MAPLE  SPRING FLURRY SERVICEBERRY  AMERICAN BEECH  BURR OAK  EASTERN COTTONWOOD  TREMBLING ASPEN  LITTLE LEAF LINDEN  PIONEER ELM  EASTERN WHITE PINE COLORADO SPRUCE EASTERN HEMLOCK  COMPACT ANDORA JUNIPER	QTY           4           6           2           3           8           3           4           2           9	SIZE         70mm CAL         50mm CAL         70mm CAL         70mm CAL         50mm CAL         60mm CAL         60mm CAL         70mm CAL         20mm CAL         20mm CAL         20mm CAL         2.0M HT.         2.0M HT	REMARKS         B&B / W.B MUP         B&B / W.B         B&B / W.B		
AR AC AL AN FU FG FA QM QU PD PC PT PC TC TII UA UL CONIFER-UU PN PIC TS TS SHRUBS SHRUBS SHRUBS	CER RUBRUM MELANCHIER LAEVIS 'SPRING JJRRY' AGUS GRANDIFOLIA UERCUS MACROCARPA DPULUS DELTOIDES DPULUS TREMULOIDES ILIA CORDATA LMUS AMERICANA 'PIONEER' JS TREES NUS STROBUS CEA PUNGENS SUGA CANADENSIS JNIPERUS HORIZONTALIS 'PLUMOSA OMPACTA' JNIPERUS COMMUNIS DEPRESSA UREA'	SPRING FLURRY SERVICEBERRY AMERICAN BEECH BURR OAK EASTERN COTTONWOOD TREMBLING ASPEN LITTLE LEAF LINDEN PIONEER ELM EASTERN WHITE PINE COLORADO SPRUCE EASTERN HEMLOCK	6 6 2 3 8 3 4 4 4 2	50mm CAL 70mm CAL 50mm CAL 50mm CAL 60mm CAL 70mm CAL 70mm CAL 2.0M HT.	B&B / W.B         B&B / W.B MUP         B&B / W.B MUP         POTTED MUP         B&B / W.B         B&B / W.B         B&B / W.B		
AL AN FG FA QM QU PD PC PT PC TC TI UA UL CONIFEROU PN PIT PP PIC TS TS SHRUBS SHRUBS SHRUBS SHRUBS	MELANCHIER LAEVIS 'SPRING JJRRY' AGUS GRANDIFOLIA UERCUS MACROCARPA DPULUS DELTOIDES DPULUS TREMULOIDES DPULUS TREMULOIDES ILIA CORDATA LMUS AMERICANA 'PIONEER' JS TREES NUS STROBUS CEA PUNGENS SUGA CANADENSIS JNIPERUS HORIZONTALIS 'PILJMOSA OMPACTA' JNIPERUS COMMUNIS DEPRESSA UREA'	SPRING FLURRY SERVICEBERRY AMERICAN BEECH BURR OAK EASTERN COTTONWOOD TREMBLING ASPEN LITTLE LEAF LINDEN PIONEER ELM EASTERN WHITE PINE COLORADO SPRUCE EASTERN HEMLOCK	6 6 2 3 8 3 4 4 4 2	50mm CAL 70mm CAL 50mm CAL 50mm CAL 60mm CAL 70mm CAL 70mm CAL 2.0M HT.	B&B / W.B         B&B / W.B MUP         B&B / W.B MUP         POTTED MUP         B&B / W.B         B&B / W.B         B&B / W.B		
AL FI FG FA QM QU PD PC PT PC TC TI UA UL CONIFEROU PN PI PN PI PN PI SHRUBS SHRUBS SHRUBS SHRUBS SHRUBS	URRY AGUS GRANDIFOLIA UERCUS MACROCARPA DPULUS DELTOIDES DPULUS DELTOIDES DPULUS TREMULOIDES IIA CORDATA IMUS AMERICANA 'PIONEER' JS TREES NUS STROBUS CEA PUNGENS SUGA CANADENSIS JNIPERUS HORIZONTALIS 'PLUMOSA DMPACTA' JNIPERUS COMMUNIS DEPRESSA UREA'	AMERICAN BEECH BURR OAK EASTERN COTTONWOOD TREMBLING ASPEN LITTLE LEAF LINDEN PIONEER ELM EASTERN WHITE PINE COLORADO SPRUCE EASTERN HEMLOCK	6 2 3 8 3 4 4 4 2	70mm CAL         70mm CAL         50mm CAL         60mm CAL         70mm CAL         70mm CAL         200mm CAL	B&B/ W.B MUP         B&B/ W.B MUP         POTTED MUP         B&B/ W.B         B&B/ W.B         B&B/ W.B         B&B/ W.B		
QM     QU       PD     PC       PT     PC       PT     PC       PT     PC       IC     TII       JA     UL       CONIFEROU     PI       PN     PI       PP     PIC       SHRUBS     JU       SHRUBS     JU       QC     JU       QL     JU       QL     JU       QL     SC       PR     RH       PERENNULIS     RH	UERCUS MACROCARPA DPULUS DELTOIDES DPULUS TREMULOIDES LIA CORDATA LMUS AMERICANA 'PIONEER' JS TREES NUS STROBUS CEA PUNGENS SUGA CANADENSIS JNIPERUS HORIZONTALIS 'PLUMOSA DMPACTA' JNIPERUS COMMUNIS DEPRESSA UREA'	BURR OAK EASTERN COTTONWOOD TREMBLING ASPEN LITTLE LEAF LINDEN PIONEER ELM EASTERN WHITE PINE COLORADO SPRUCE EASTERN HEMLOCK	2 3 8 3 4 4 4 2	70mm CAL         50mm CAL         60mm CAL         70mm CAL         70mm CAL         2.0M HT.	B&B/W.BMUP POTTED MUP B&B/W.B B&B/W.B B&B/W.B	-	
PD PC PT PC IC III UA UI CONIFEROU PN PI PP PIC IS IS SHRUBS SHRUBS U CC III III III III III III III III II	DPULUS DELTOIDES DPULUS TREMULOIDES LIA CORDATA LMUS AMERICANA 'PIONEER' JS TREES NUS STROBUS CEA PUNGENS SUGA CANADENSIS JNIPERUS HORIZONTALIS 'PLUMOSA OMPACTA' JNIPERUS COMMUNIS DEPRESSA UREA'	EASTERN COTTONWOOD TREMBLING ASPEN LITTLE LEAF LINDEN PIONEER ELM EASTERN WHITE PINE COLORADO SPRUCE EASTERN HEMLOCK	3 8 3 4 4 2	50mm CAL 60mm CAL 70mm CAL 70mm CAL 2.0M HT.	POTTED MUP B&B/W.B B&B/W.B B&B/W.B	-	
IC III UA UL CONIFEROU PN PI PP PI IS TS SHRUBS SHRUBS U U CC IS SHRUBS IU CC IS SHRUBS	LIA CORDATA LMUS AMERICANA 'PIONEER' JS TREES NUS STROBUS CEA PUNGENS SUGA CANADENSIS JNIPERUS HORIZONTALIS 'PLUMOSA OMPACTA' JNIPERUS COMMUNIS DEPRESSA UREA'	LITTLE LEAF LINDEN PIONEER ELM EASTERN WHITE PINE COLORADO SPRUCE EASTERN HEMLOCK	3 4 4 2	70mm CAL 70mm CAL 2.0M HT.	B&B / W.B B&B / W.B	-	
UA UL CONIFEROU PN PI PP PIC IS IS SHRUBS SHRUBS U U U U U U U U U U U U U U U U U U	LMUS AMERICANA 'PIONEER' JS TREES NUS STROBUS CEA PUNGENS SUGA CANADENSIS JNIPERUS HORIZONTALIS 'PLUMOSA OMPACTA' JNIPERUS COMMUNIS DEPRESSA UREA'	PIONEER ELM EASTERN WHITE PINE COLORADO SPRUCE EASTERN HEMLOCK	4	70mm CAL 2.0M HT.	B&B/W.B	-	
CONIFEROU PN PI PP PK IS TS SHRUBS SHRUBS JU CC JU 'AI SC SHRUBS	JS TREES NUS STROBUS CEA PUNGENS SUGA CANADENSIS JNIPERUS HORIZONTALIS 'PLUMOSA OMPACTA' JNIPERUS COMMUNIS DEPRESSA UREA'	EASTERN WHITE PINE COLORADO SPRUCE EASTERN HEMLOCK	4	2.0M HT.		-	
PN PI PP PIC IS TS SHRUBS SHRUBS JU CC JU 'AI SC SHRUBS PERENNIALS	NUS STROBUS CEA PUNGENS SUGA CANADENSIS JNIPERUS HORIZONTALIS 'PLUMOSA OMPACTA' JNIPERUS COMMUNIS DEPRESSA UREA'	COLORADO SPRUCE EASTERN HEMLOCK	2		B&B/W.B MUP	-	
TS TS SHRUBS SHRUBS U CC JU CC I I I I I I I I I I I I I I I I I I	SUGA CANADENSIS JNIPERUS HORIZONTALIS 'PLUMOSA OMPACTA' JNIPERUS COMMUNIS DEPRESSA UREA'	EASTERN HEMLOCK		2.0M HT			
SHRUBS JU CC JU AU SC SC SC RH PERENNIALS	JNIPERUS HORIZONTALIS 'PLUMOSA OMPACTA' JNIPERUS COMMUNIS DEPRESSA UREA'		9		B&B/W.B MUP	-	
JU CC JU 'AI SC RH PERENNIALS	OMPACTA' JNIPERUS COMMUNIS DEPRESSA UREA'	COMPACT ANDORA JUNIPER		2.0M HT	B&B/W.B MUP	1	
CC JU 'AI SC RH PERENNIALS	OMPACTA' JNIPERUS COMMUNIS DEPRESSA UREA'	COMPACT ANDORA JUNIPER		1	1	-	
'AI SC RH PERENNIALS	UREA'		<u> </u>	3 GAL POT	POT. 750mm O.C.	-	
RH PERENNIALS	ORBARIA SORBIFOLIA 'SEM'	CANADIAN GOLDEN JUNIPER	<u> </u>	3 GAL POT	POT. 900mm O.C.	-	
	HUS AROMATICA 'GRO-LOW'	FALSE SPIREA GRO-LOW FRAGRANT SUMAC		500mm HT. 1 GAL POT	POT. 900mm O.C. POT. 600mm O.C.	-	
	S AND GRASSES AREX MUSKINGUMENSIS	PALM SEDGE GRASS		1 GAL POT	POT. 600mm O.C.	-	
DE		TUFIED HAIR GRASS	1	1 GAL POT	POT. 600mm O.C.	1	
		WILD GERANIUM	1	1 GAL POT	POT. 600mm O.C.	]	
		FALSE SUNFLOWER	<u> </u>	1 GAL POT	POT. 600mm O.C.	- /	
		BLACK-EYED SUSAN PRAIRIE DROPSEED	+	1 GAL POT 1 GAL POT	POT. 600mm O.C. POT. 600mm O.C.		
		LITTLE BLUESTEM	+	1 GAL POT	POT. 600mm O.C.	-	
	UP PLANTING NOT INCLUDED IN A						
× * *	PLANTING BED GRASS - SEED + 100 MM T SIGHT LINES 3.0M-5.0M	TOPSOIL				3 PD	
<u> </u>						I SPD	
/				$\bigcap$			0 (P6&MC49)
				+			01 6
							107
		4					
				P32 2	20 W		
				N°			
			A				
				$O_{\lambda}$			
			2 QM				
			"E 10. 'E 10.	$\bigcirc$ $\neg$			
			5,46				
			N67°01	< <u> </u>	- 60 35 (D1 DC0.005)		
			N67*01	«	- 60.35 (P1,P6&SET) -		
			N67*01	۹	60.35 (P1,P6&SET)		
				DC	- 60.35 (P1,P6&SET)		
				<	- 60.35 (P1,P6&SET) -		
				« « DC	- 60.35 (P1,P6&SET) -		
				<	- 60.35 (P1,P6&SET)		
				<	- 60.35 (P1,P6&SET)		
				<	- 60.35 (P1,P6&SET) -		

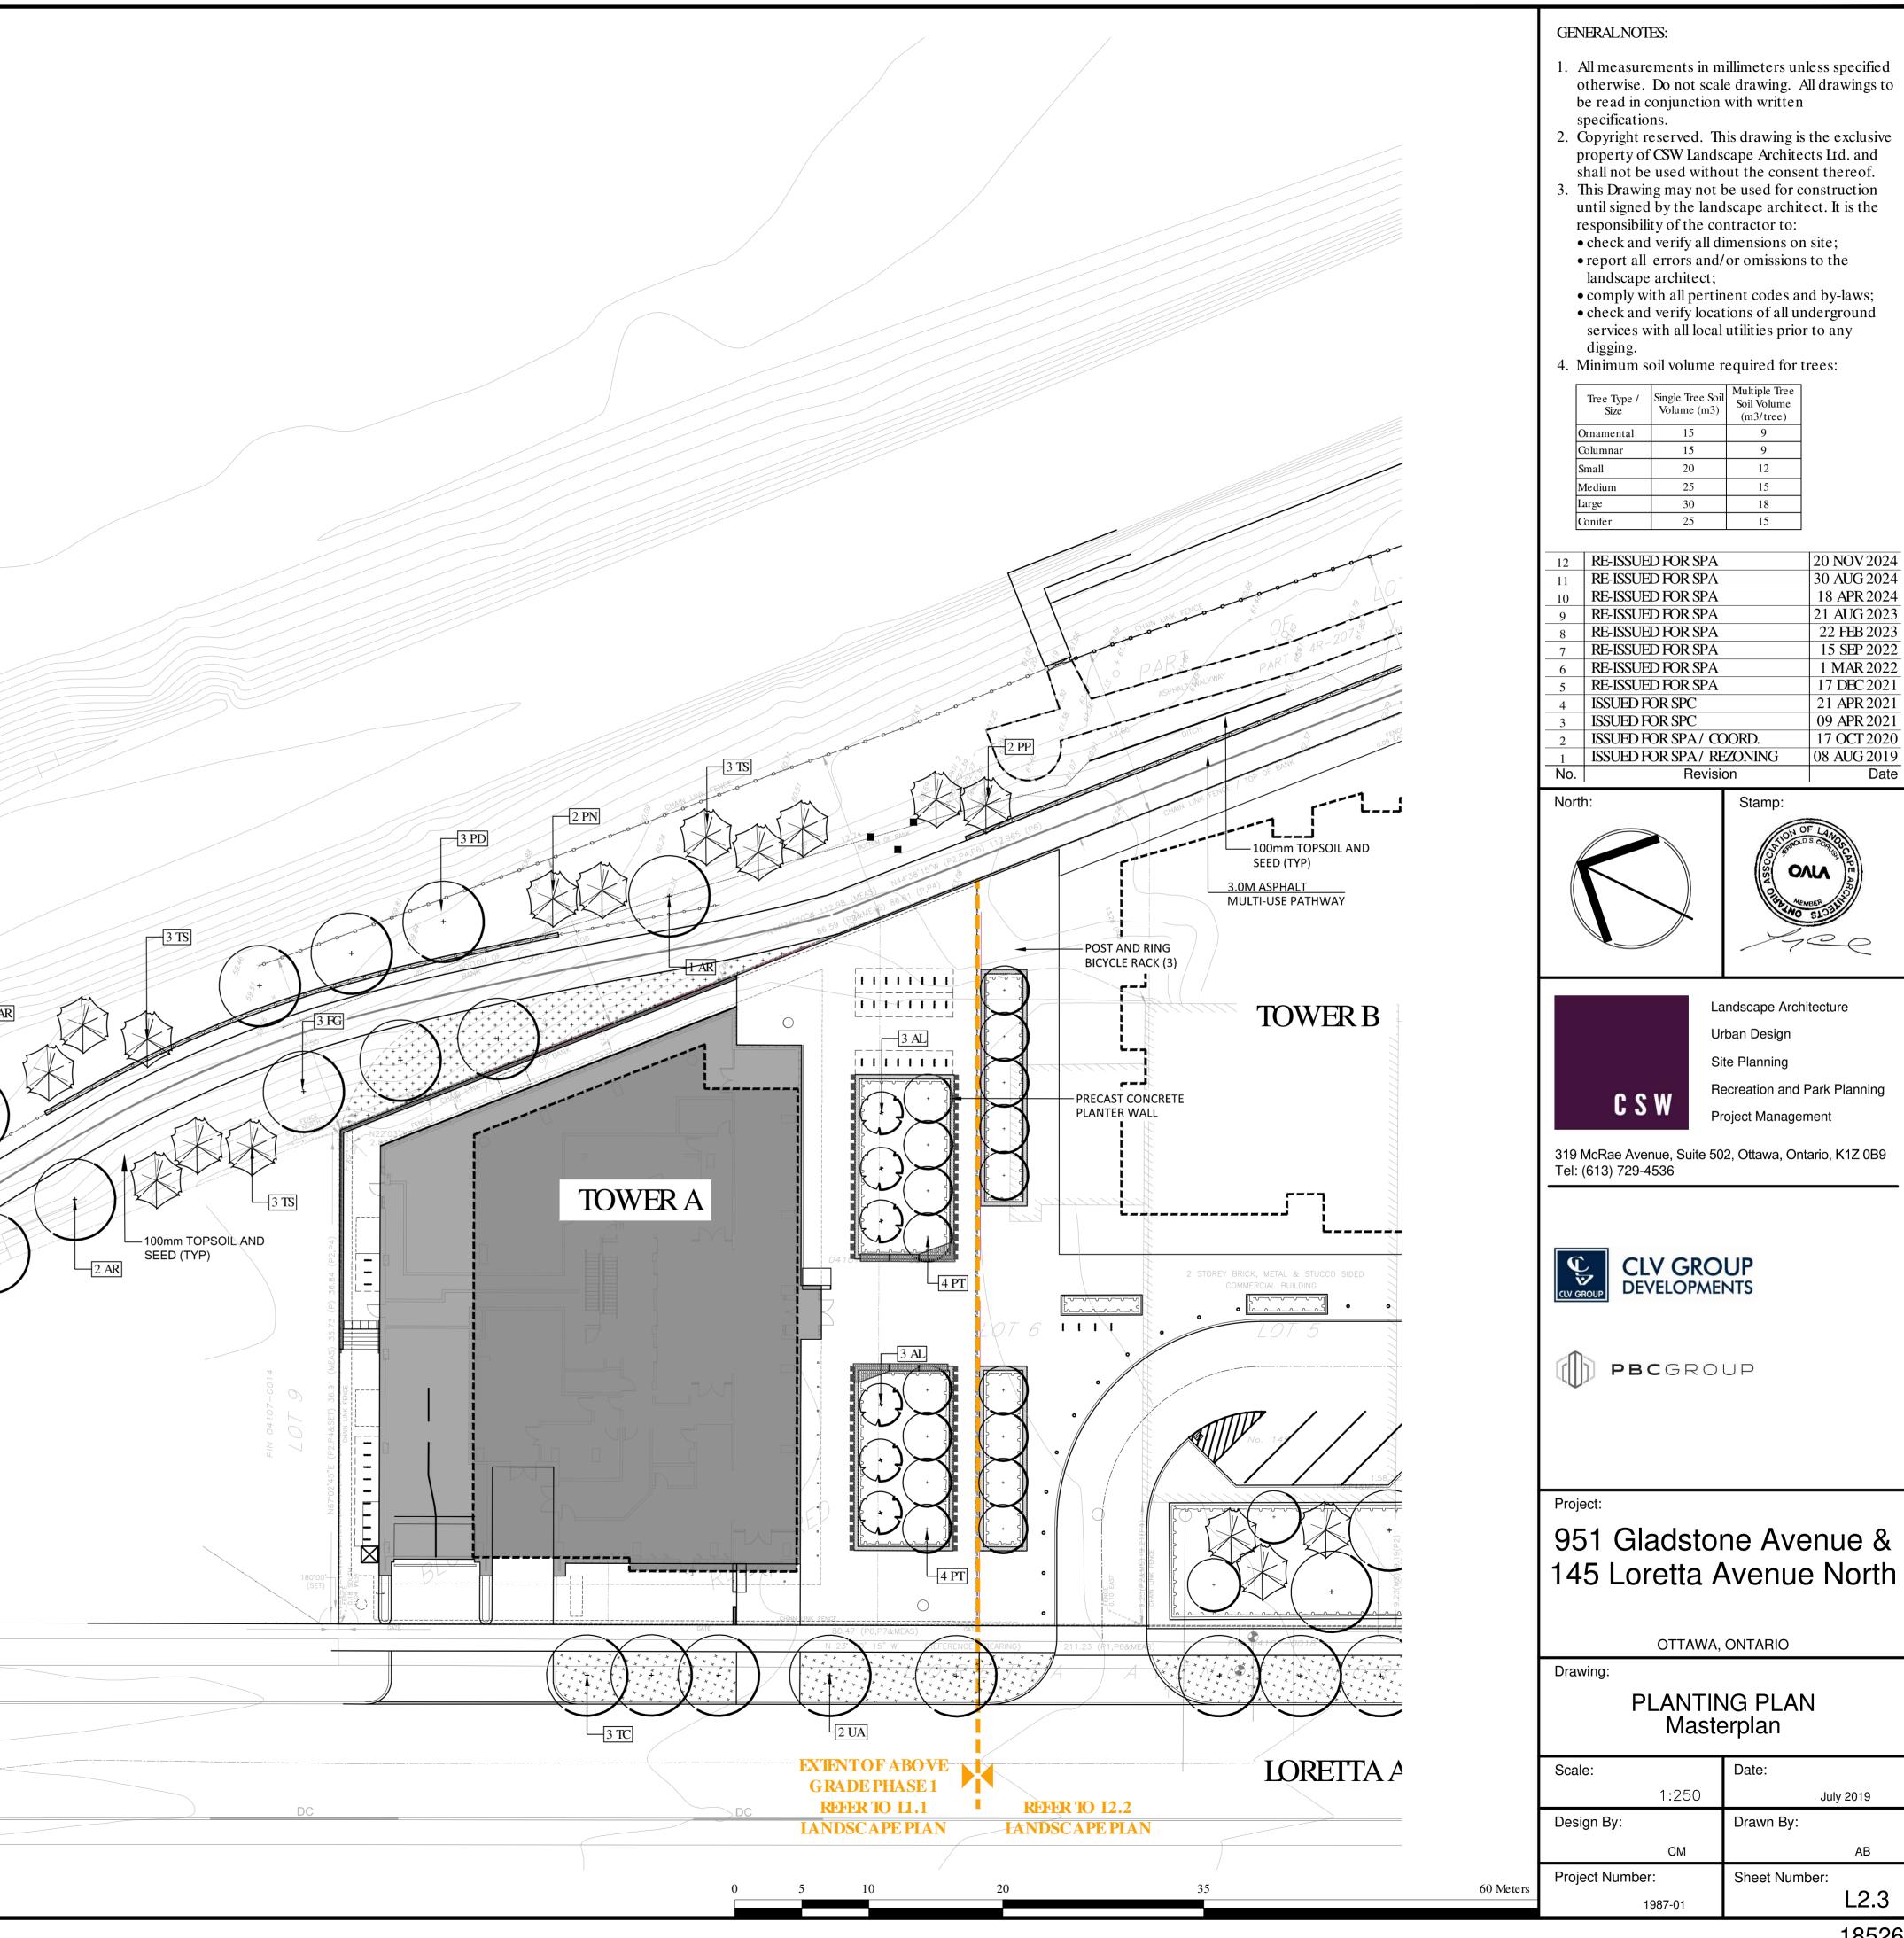

18526

-0053


5

N

D07

	TUST	1			
KEY	BOTANICALNAME	COMMON NAME	QTY	SIZE	REMARKS
DECID	UOUS TREES				
AR	ACER RUBRUM	RED MAPLE	4	70mm CAL	B&B/W.B
AL	AMELANCHIER LAEVIS 'SPRING FLURRY	SPRING FLURRY SERVICEBERRY	4	50mm CAL	B&B/ W.B
co	CELTIS OCCIDENTALIS	COMMON HACKBERRY	4	70mm CAL	B&B/W.B
РТ	POPULUS TREMULOIDES	TREMBLING ASPEN	9	70mm CAL	B&B/W.B
QM	QUERCUS MACROCARPA	BURR OAK	5	70mm CAL	B&B/W.B
TC	TILIA CORDATA	LITTLE LEAF LINDEN	4	70mm CAL	B&B/W.B
UA	ULMUS AMERICANA 'PIONEER'	PIONEER ELM	5	70mm CAL	B&B/W.B
CONIF	EROUS TREES				
PS	PINUS SYLVESTRIS	SCOTS PINE	4	3.0M HT	B&B/W.B
PP	PICEA PUNGENS	COLORADO SPRUCE	5	2.0M HT	B&B/W.B
SHRUE	35				
	JUNIPERUS HORIZONTALIS 'PLUMOSA COMPACTA'	COMPACT ANDORA JUNIPER		3 GAL POT	POT. 750mm O.C.
	JUNIPERUS COMMUNIS DEPRESSA 'AUREA'	CANADIAN GOLDEN JUNIPER		3 GAL POT	POT. 900mm O.C.
	SORBARIA SORBIFOLIA 'SEM'	FALSE SPIREA		500mm HT.	POT. 900mm O.C.
	RHUS AROMATICA 'GRO-LOW'	GRO-LOW FRAGRANT SUMAC		1 GAL POT	POT. 600mm O.C.
PEREN	INIALS AND GRASSES		-	1	1
	CAREX MUSKINGUMENSIS	PALM SEDGE GRASS		1 GAL POT	POT. 600mm O.C.
	DESCHAMPSIA CESPITOSA	TUFTED HAIR GRASS		1 GAL POT	POT. 600mm O.C.
	ERANIUM MACULATUM	WILD GERANIUM		1 GAL POT	POT. 600mm O.C.
	HELIOSIS HELIANTHOIDES	FALSE SUNFLOWER		1 GAL POT	POT. 600mm O.C.
	RUDBEKIA HIRTA	BLACK-EYED SUSAN		1 GAL POT	POT. 600mm O.C.
	SPOROBOLUS HETEROLEPIAS	PRAIRIE DROPSEED	1	1 GAL POT	POT. 600mm O.C.
	SCHIZACHYRIUM SCOPARIUM	LITTLE BLUESTEM		1 GAL POT	POT. 600mm O.C.

## LEGEND

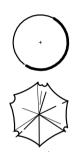

·/ `\

0.300


CONIFEROUS TREE

DECIDUOUS TREE

EXISTING CONIFEROUS TREE

PLANTING BED




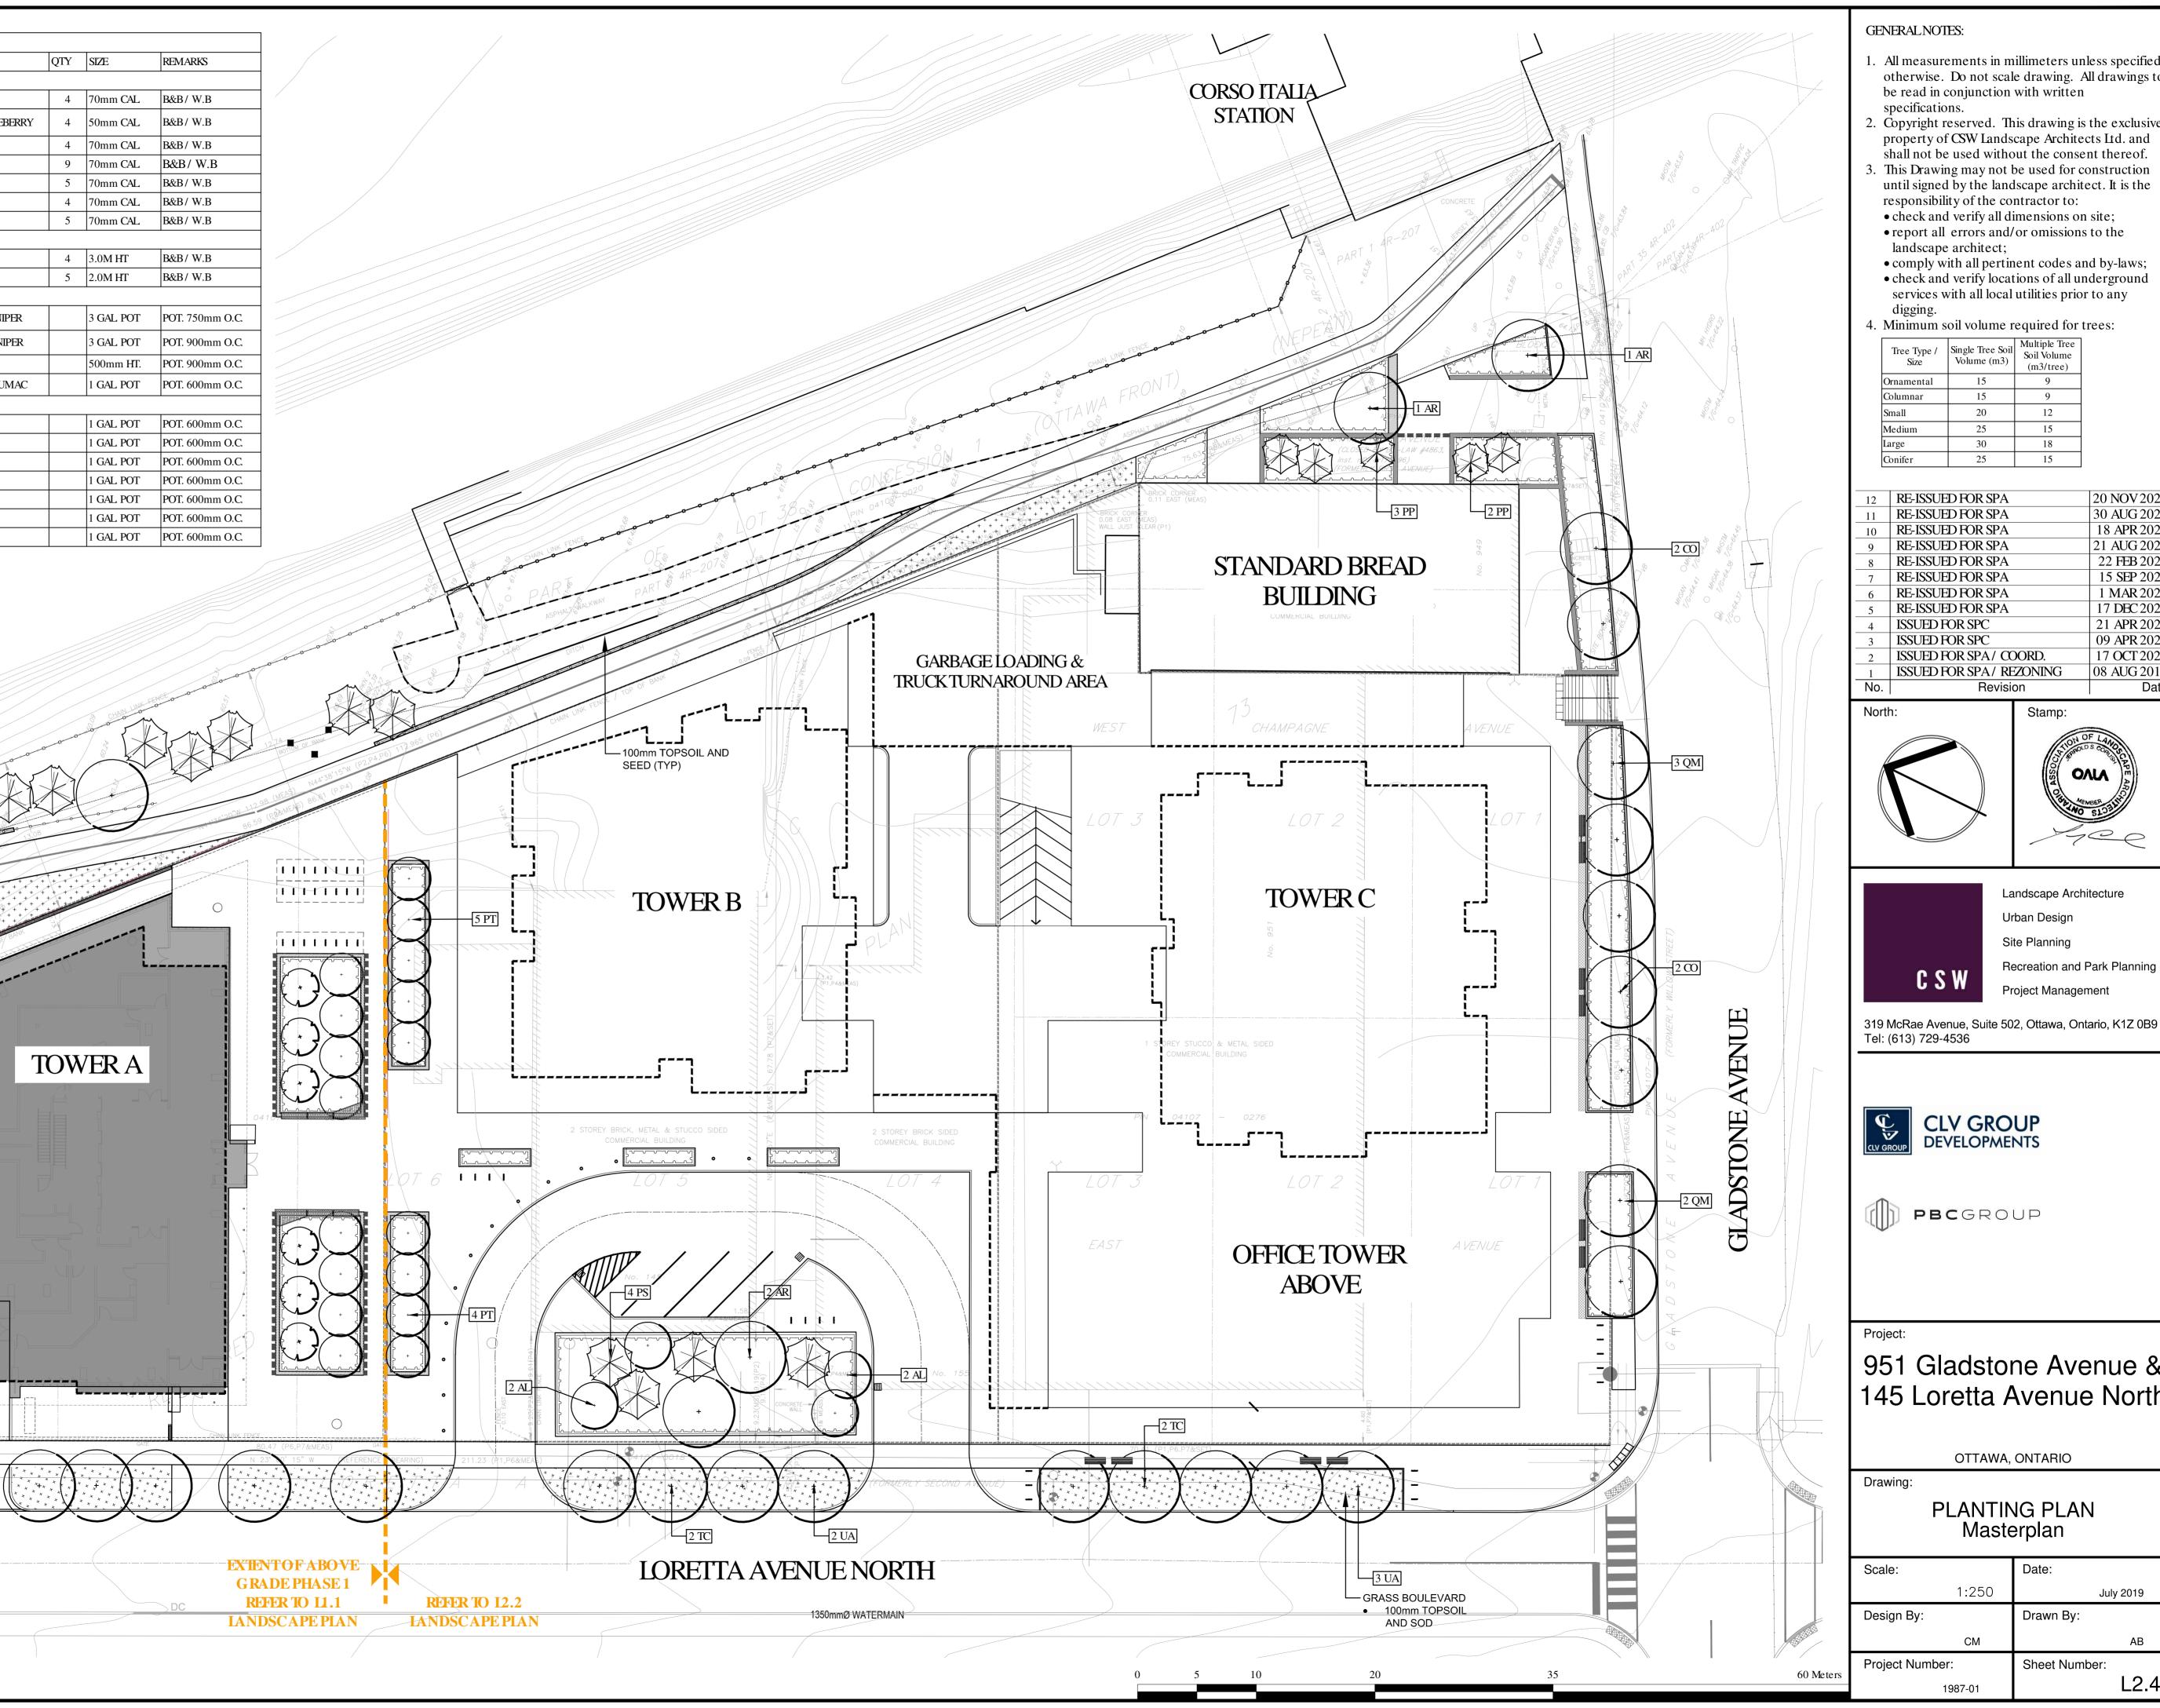

- 1. All measurements in millimeters unless specified otherwise. Do not scale drawing. All drawings to be read in conjunction with written
- Copyright reserved. This drawing is the exclusive property of CSW Landscape Architects Ltd. and shall not be used without the consent thereof.
- 3. This Drawing may not be used for construction until signed by the landscape architect. It is the responsibility of the contractor to:
- check and verify all dimensions on site; • report all errors and/or omissions to the
- comply with all pertinent codes and by-laws;
  check and verify locations of all underground services with all local utilities prior to any
- 4. Minimum soil volume required for trees:

Tree Type / Size	Single Tree Soil Volume (m3)	Multiple Tree Soil Volume (m3/tree)
Ornamental	15	9
Columnar	15	9
Small	20	12
Medium	25	15
Large	30	18
Conifer	25	15


12	RE-ISSUED FOR SPA	20 NOV 2024
11	RE-ISSUED FOR SPA	30 AUG 2024
10	RE-ISSUED FOR SPA	18 APR 2024
9	RE-ISSUED FOR SPA	21 AUG 2023
8	RE-ISSUED FOR SPA	22 FEB 2023
7	RE-ISSUED FOR SPA	15 SEP 2022
6	RE-ISSUED FOR SPA	1 MAR 2022
5	RE-ISSUED FOR SPA	17 DEC 2021
4	ISSUED FOR SPC	21 APR 2021
3	ISSUED FOR SPC	09 APR 2021
2	ISSUED FOR SPA/ COORD.	17 OCT 2020
1	ISSUED FOR SPA/ REZONING	08 AUG 2019
No.	Revision	Date

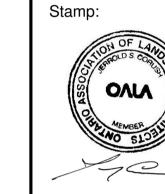

319 McRae Avenue, Suite 502, Ottawa, Ontario, K1Z 0B9

# 951 Gladstone Avenue & 145 Loretta Avenue North

OTTAWA	ONTARIO	
Drawing:		
	NG PLAN erplan	D07-12-21-0053
Scale:	Date:	5
1:250	July 2019	
Design By:	Drawn By:	-  -
СМ	АВ	B
Project Number:	Sheet Number:	
1987-01	L2.4	
	18526	

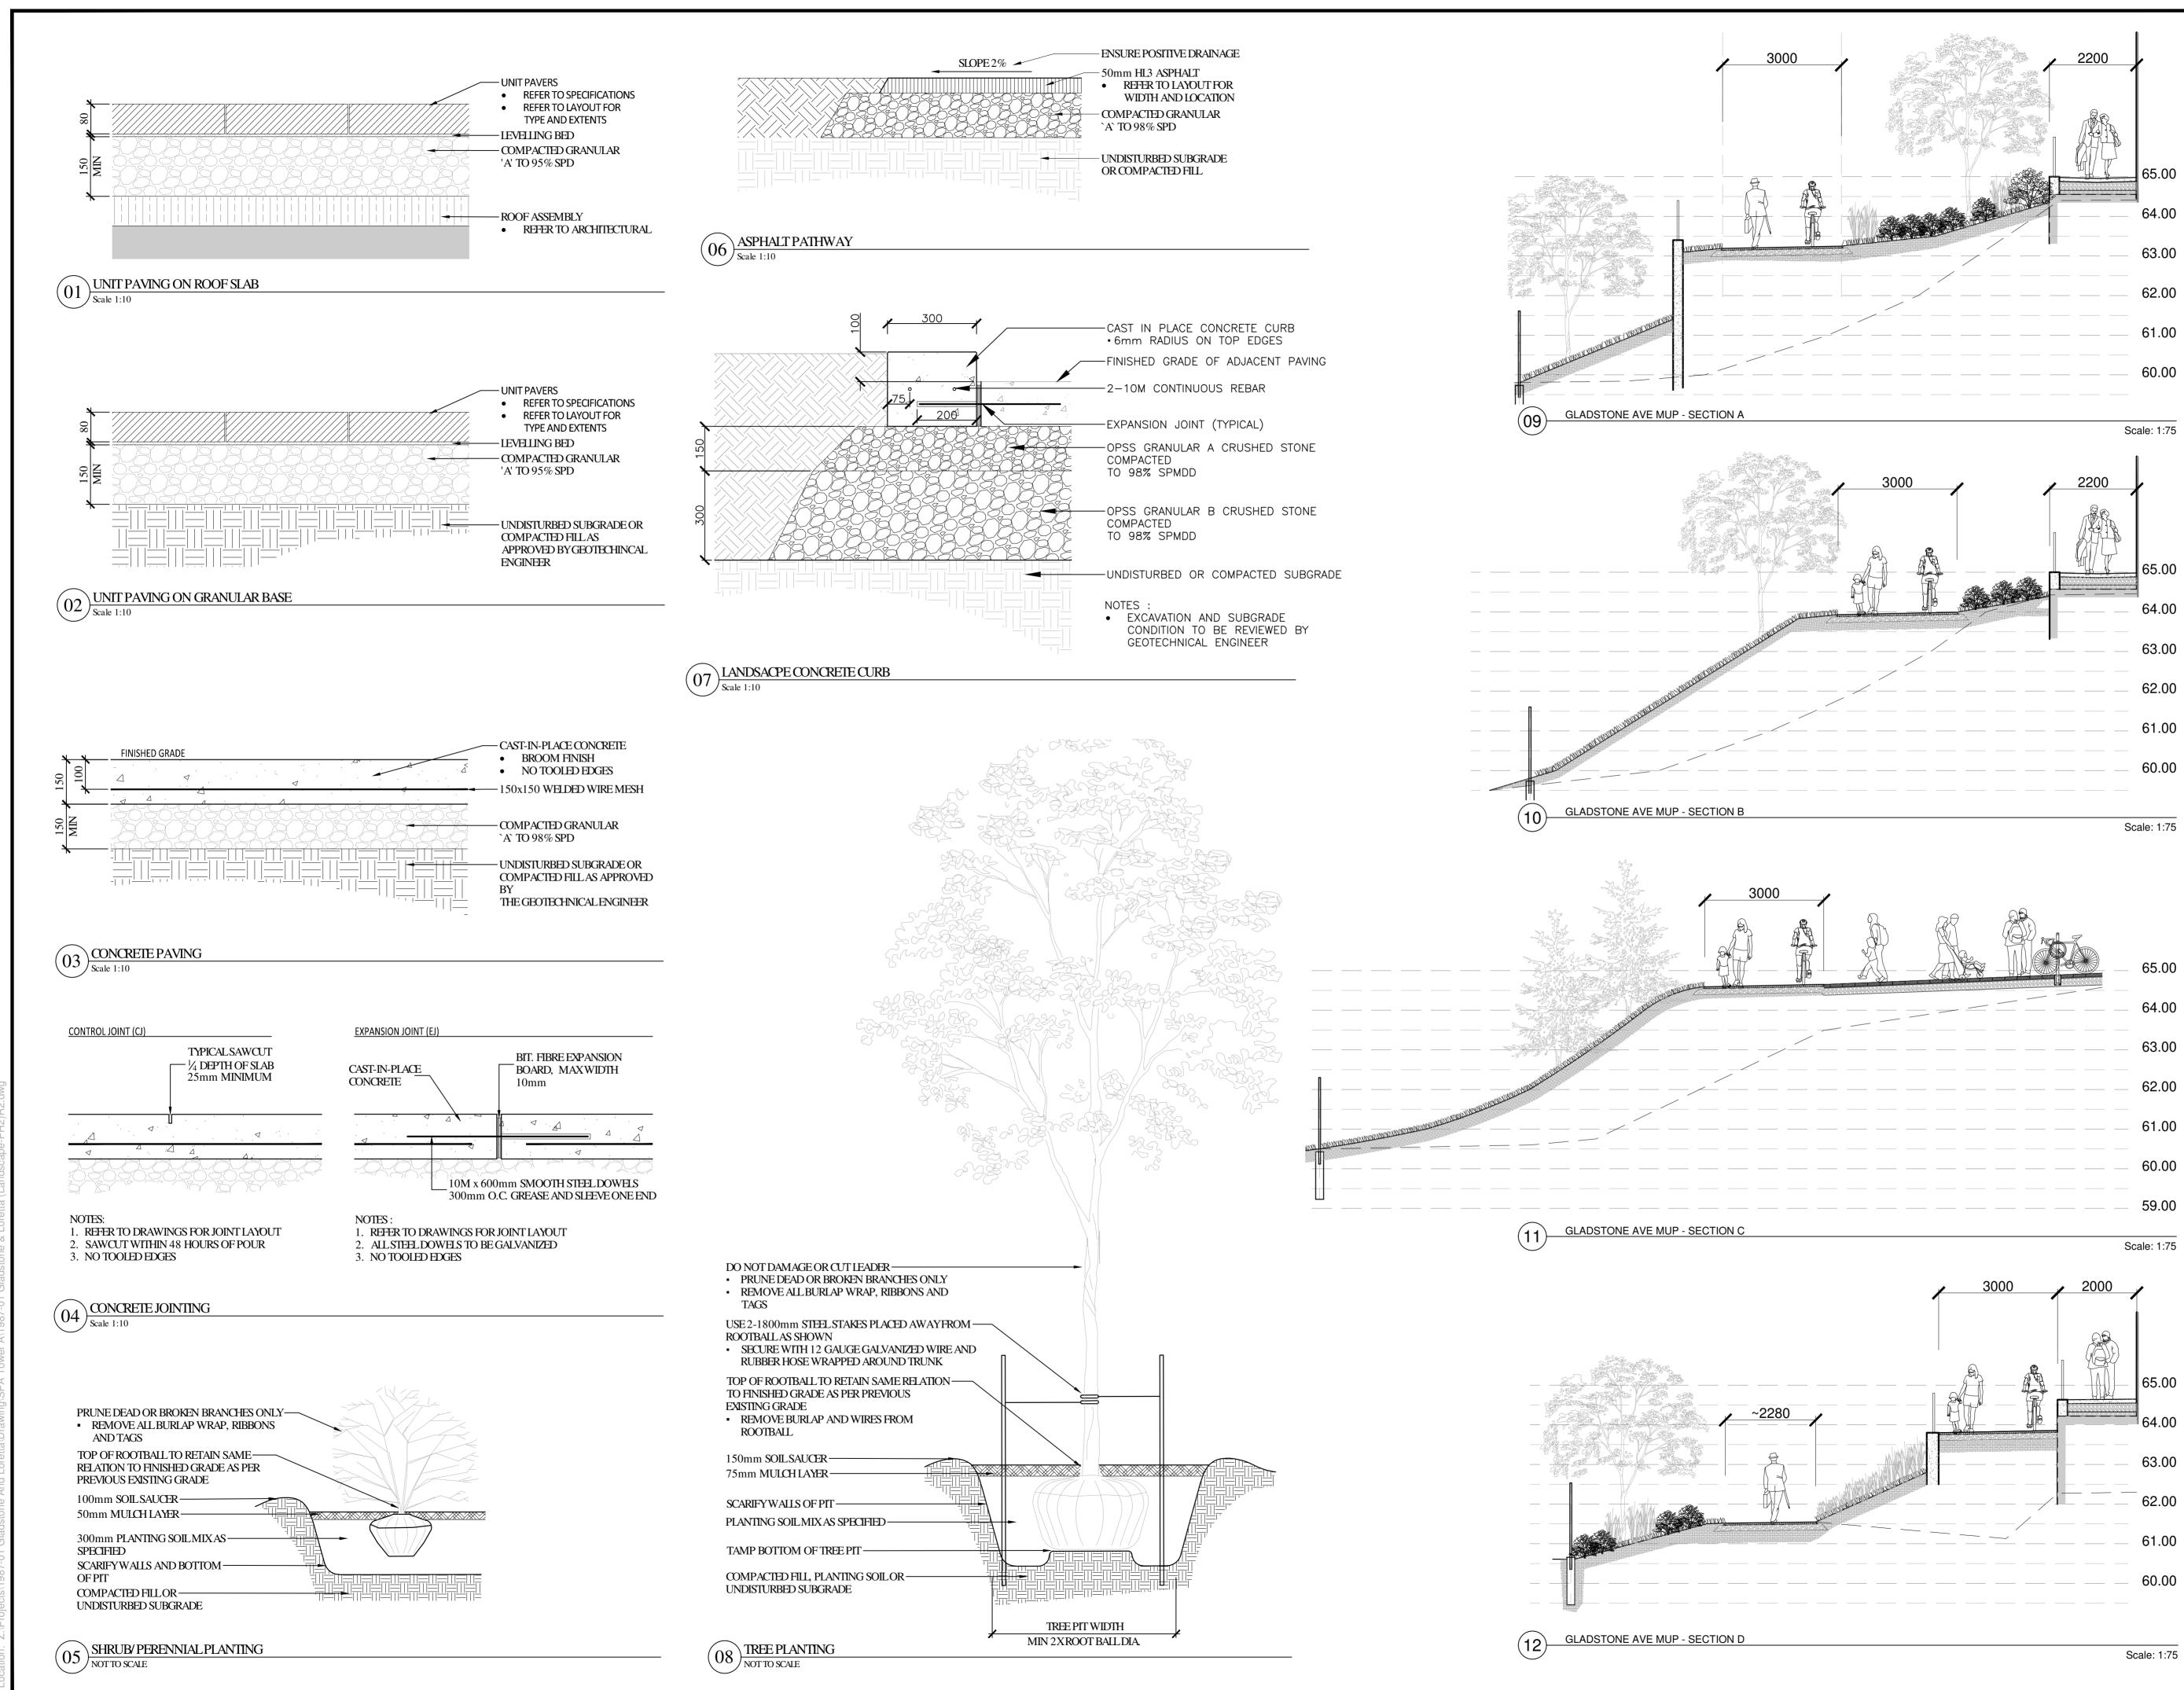


#### GENERAL NOTES:

- 1. All measurements in millimeters unless specified otherwise. Do not scale drawing. All drawings to be read in conjunction with written specifications.
- 2. Copyright reserved. This drawing is the exclusive property of CSW Landscape Architects Ltd. and shall not be used without the consent thereof.
- 3. This Drawing may not be used for construction until signed by the landscape architect. It is the responsibility of the contractor to:
- check and verify all dimensions on site; • report all errors and/or omissions to the landscape architect;
- comply with all pertinent codes and by-laws;
  check and verify locations of all underground services with all local utilities prior to any digging.
- 4. Minimum soil volume required for trees:

Tree Type / Size	Single Tree Soil Volume (m3)	Multiple Tree Soil Volume (m3/tree)
Ornamental	15	9
Columnar	15	9
Small	20	12
Medium	25	15
Large	30	18
Conifer	25	15

RE-ISSUED FOR SPA	20 NOV 2024
RE-ISSUED FOR SPA	30 AUG 2024
RE-ISSUED FOR SPA	18 APR 2024
RE-ISSUED FOR SPA	21 AUG 2023
RE-ISSUED FOR SPA	22 FEB 2023
RE-ISSUED FOR SPA	15 SEP 2022
RE-ISSUED FOR SPA	1 MAR 2022
<b>RE-ISSUED FOR SPA</b>	17 DEC 2021
ISSUED FOR SPC	21 APR 2021
ISSUED FOR SPC	09 APR 2021
ISSUED FOR SPA/ COORD.	17 OCT 2020
ISSUED FOR SPA/ REZONING	08 AUG 2019
Revision	Date
	RE-ISSUED FOR SPA RE-ISSUED FOR SPA RE-ISSUED FOR SPA RE-ISSUED FOR SPA RE-ISSUED FOR SPA RE-ISSUED FOR SPA RE-ISSUED FOR SPA ISSUED FOR SPC ISSUED FOR SPA/ COORD. ISSUED FOR SPA/ REZONING

North:

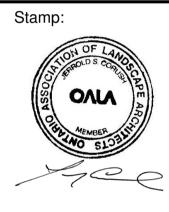



319 McRae Avenue, Suite 502, Ottawa, Ontario, K1Z 0B9 Tel: (613) 729-4536




**pbc**group

## Project:

# 951 Gladstone Avenue & 145 Loretta Avenue North

OTTAWA, ONTARIO			
Drawing:			
DET	AILS	2-21-0053	
Scale:	Date:	2	
	July 2019	$\sim$	
Design By:	Drawn By:	D07-1	
СМ	AB		
Project Number:	Sheet Number:		
1987-01	L3.0		

18526

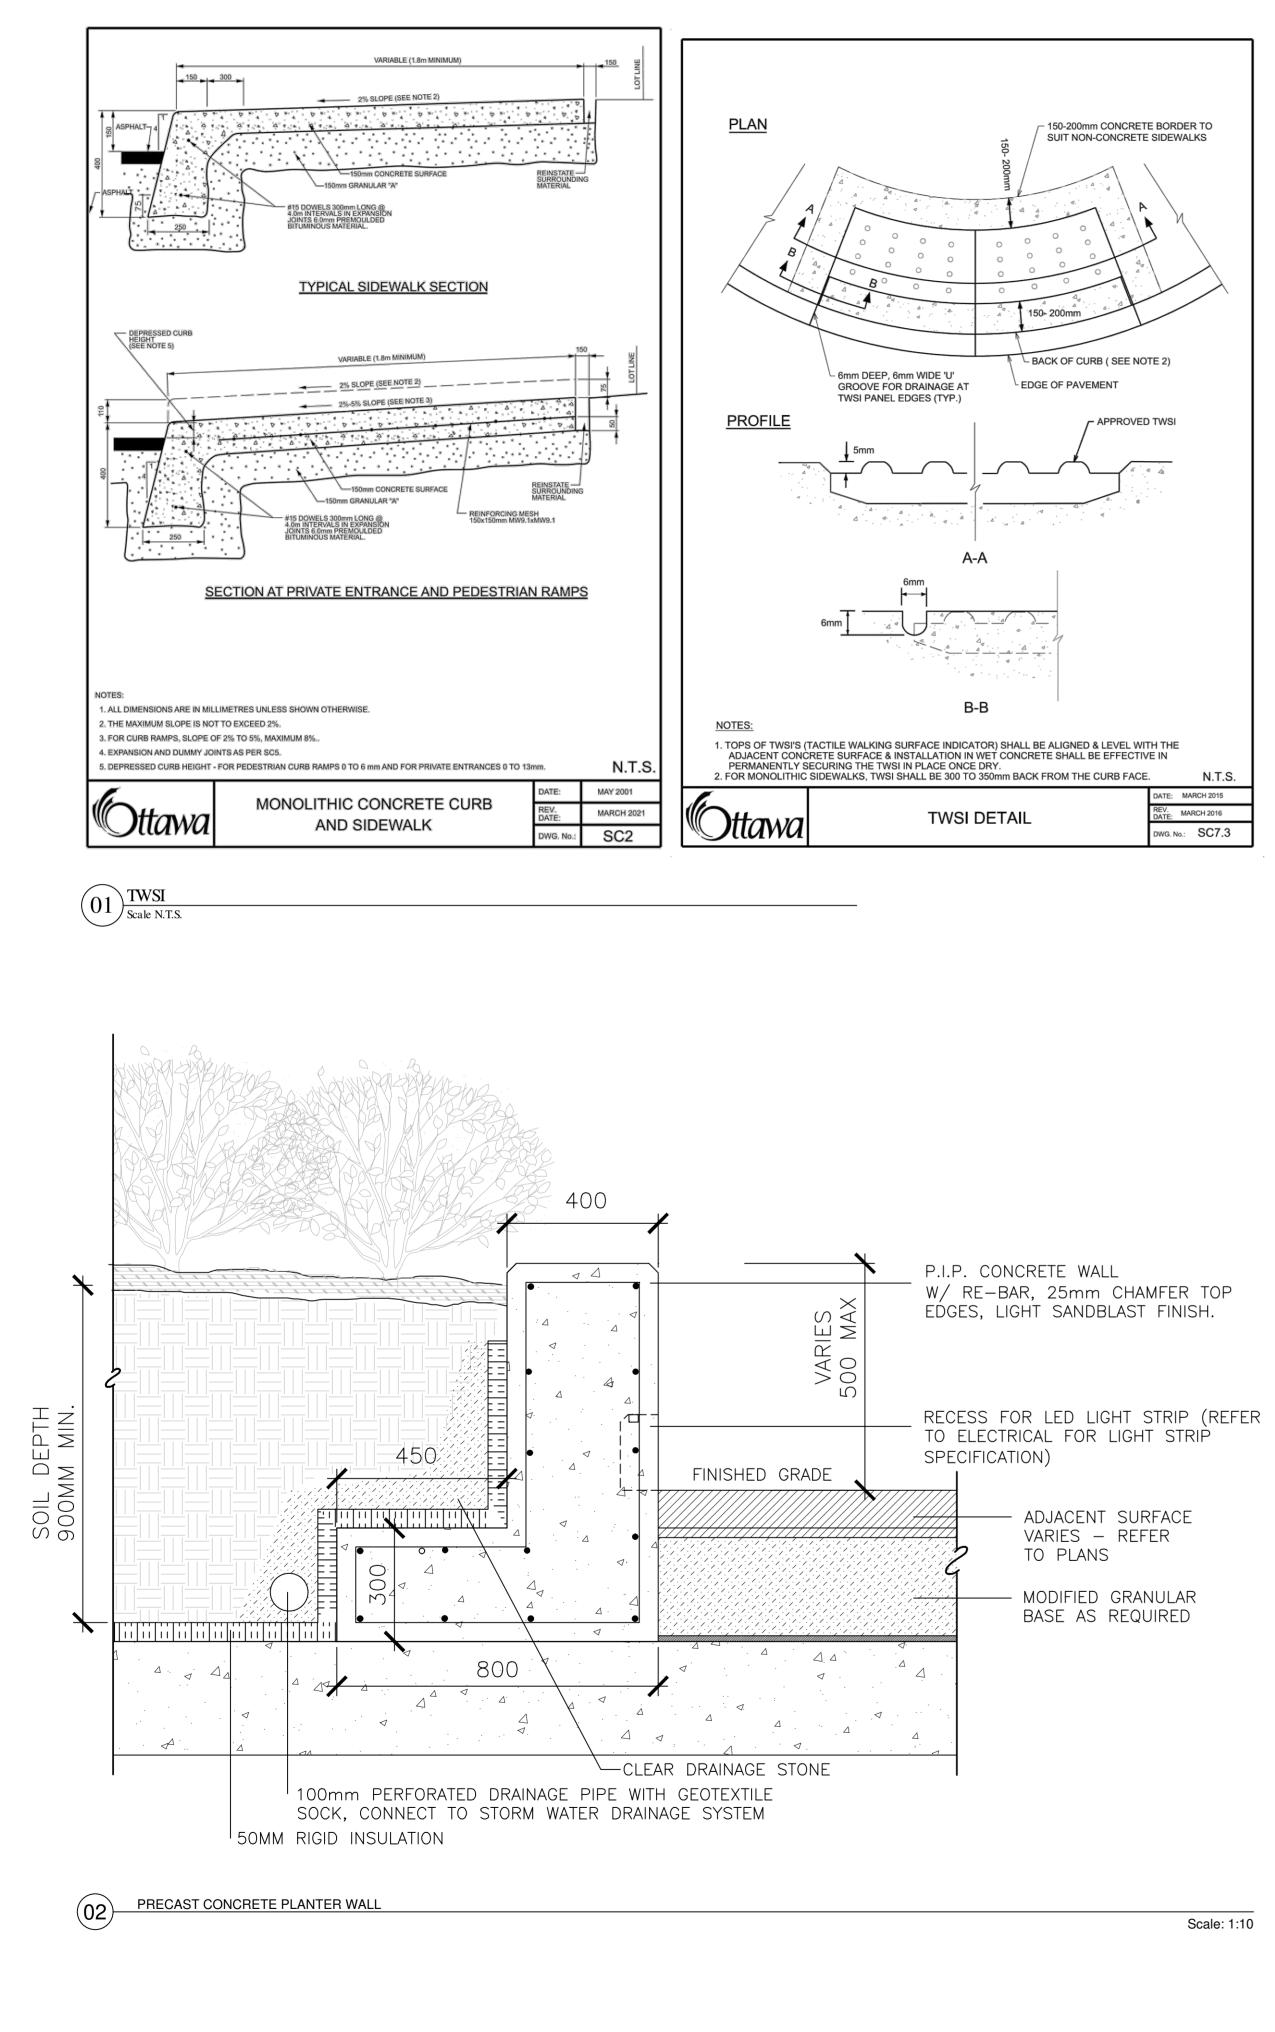

Scale: 1:10

### GENERAL NOTES:


1. All measurements in millimeters unless specified	
otherwise. Do not scale drawing. All drawings t	0
be read in conjunction with written	
specifications.	
2. Copyright reserved. This drawing is the exclusive	e
property of CSW Landscape Architects Ltd. and	
shall not be used without the consent thereof.	
2 This Drawing a maximate have a d fan aan struction	

- 3. This Drawing may not be used for construction until signed by the landscape architect. It is the responsibility of the contractor to:
- check and verify all dimensions on site; • report all errors and/or omissions to the landscape architect;
- comply with all pertinent codes and by-laws;
  check and verify locations of all underground services with all local utilities prior to any digging.
- 4. Minimum soil volume required for trees:

Tree Type / Size	Single Tree Soil Volume (m3)	Multiple Tree Soil Volume (m3/tree)
Ornamental	15	9
Columnar	15	9
Small	20	12
Medium	25	15
Large	30	18
Conifer	25	15

12	RE-ISSUED FOR SPA	20 NOV 2024
11	RE-ISSUED FOR SPA	30 AUG 2024
10	RE-ISSUED FOR SPA	18 APR 2024
9	RE-ISSUED FOR SPA	21 AUG 2023
8	RE-ISSUED FOR SPA	22 FEB 2023
7	RE-ISSUED FOR SPA	15 SEP 2022
6	RE-ISSUED FOR SPA	1 MAR 2022
5	RE-ISSUED FOR SPA	17 DEC 2021
4	ISSUED FOR SPC	21 APR 2021
3	ISSUED FOR SPC	09 APR 2021
2	ISSUED FOR SPA/ COORD.	17 OCT 2020
1	ISSUED FOR SPA/ REZONING	08 AUG 2019
No.	Revision	Date

North:

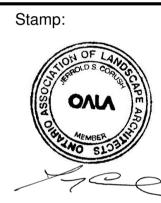



319 McRae Avenue, Suite 502, Ottawa, Ontario, K1Z 0B9 Tel: (613) 729-4536



**PBC**GROUP

Project:

951 Gladstone Avenue & 145 Loretta Avenue North

OTTAWA, ONTARIO			
Drawing:			
DETAILS			
Scale:	Date:	D07-12-21-0053	
	July 2019	$\sim$	
Design By:	Drawn By:	<u>/</u>	
СМ	AB	DO	
Project Number:	Sheet Number:		
1987-01	L3.1		

PLA	NT LIST				
KEY	BOTANICAL NAME	COMMON NAME	QTY	SIZE	REMARKS
DECI	DECIDUOUS TREE				
AC	AMELANCHIER CANADENSIS	SERVICEBERRY	2	40mm CAL.	MULTI-STEM
DECIDUOUS SHRUB					
SH	SYRINGA X HYACINTHIFLORA 'ANABEL'	ANABEL LILAC	6	1.2M HT.	

GREEN ROOF 8" : PLAN	T LIST		
BOTANICAL NAME	COMMON NAME	NATIVE	HEIGHT / COLOUR
PRE-CULTIVATED MODULES 12 X 12"			
GRASSES	GRASS		
ELYMUS CANADENSIS	CANADA WILD RYE	YES	1.5 M /GREEN- BEIGE
ELYMUS HYSTRIX	BOTTLEBRUSH GRASS	YES	1.5 M / GREEN- YELLO
KOELERIA MACRANTHA	PRAIRIE JUNE GRASS	YES	0.6 M / GREEN-YELLOV
SPOROBOLUS HETEROLEPIS	PRAIRIE DROPSEED	YES	0.9 M / GREEN-BEIGE
WHITE PERENNIALS	WHITE PERENNIALS		
ECHINACEA PURPUREA POW-WOW	POW-WOW WHITE ECHINACEA	NO	0.4 M/ WHITE
BOLTONIA ASTEROIDS 'SNOWBANK'	FALSE CHAMOMILE	YES	1 M / WHITE
MITELLA DIPHYLLA	MITERWORT	YES	0.6 M / WHITE
YELLOW PERENNIALS	YELLOW PERENNIALS		
COREOPSIS LANCEOLATA	LANCELEAF COREOPSIS	YES	0.6 M / YELLOW
SEDUM AIZOON 'EUPHORBIOIDES'	EUPHORBIA LEAVED SEDUM	NO	0.3 M / YELLOW
PURPLE PERENNIALS	PURPLE PERENNIALS		
ALLIUM CERNUUM	NODDING ONION	YES	0.45 M / VIOLET
EPIMEDIUM SELECTION	EPIMEDIUM	NO	0.3 M / VIOLET

# GREEN ROOF SEDUM GREEN TABLE

SEDUM AIZOON 'EUPHORIOIDES' SEDUM HYBRIDUM 'IMMERGRUNCHEN'

SEDUM HYBRIDUM 'SIBERIAN GOLD'

#### LEGEND:

UNIT PAVERS TYPE 1: 200MM X 400MM UNIT PAVERS TYPE 2: 600MM X 600MM

WOOD DECKING

+++++ +\_++++ GREEN ROOF PLANTING

SHRUB PLANTING

CRUSHED STONE PAVING

➡ 5'−0" HIGH GLASS GUARDRAIL (REFER TO ARCHITECTURAL)

$\begin{pmatrix} 6 \\ 1 \\ \hline \end{array}$	MAINTENANCE EDGE	
L5.0		

5 RAISED AI UMINUM 5.0 PLANTER

GAZ FIRE PIT-

5'-0" HIGH GLASS GUARD-(REFER TO ARCHITECTURAL)

UNIT PAVING ON PEDESTALS

(7) OUTDOOR KITCHEN

5 RAISED ALUMINUM 15.0 PLANTER

LOUNGE FURNITURE-

1 AC-

2 CRUSHED STONE PAVING 4 GREEN ROOF PLANTING

SURFACE MOUNTED PODIUM SITTING OVERHANG CANOPY ABOVE 1 AC-----

