


DRAWING INFORMATION

① SURFACE REFLECTANCES:
BUILDING: 0.5
GROUND: 0.2

② LUMINAIRES MOUNTING HEIGHT:
INDICATED IN THE DRAWINGS BY MH

③ CALCULATION POINTS INSERTED AT
FLOOR PLANE

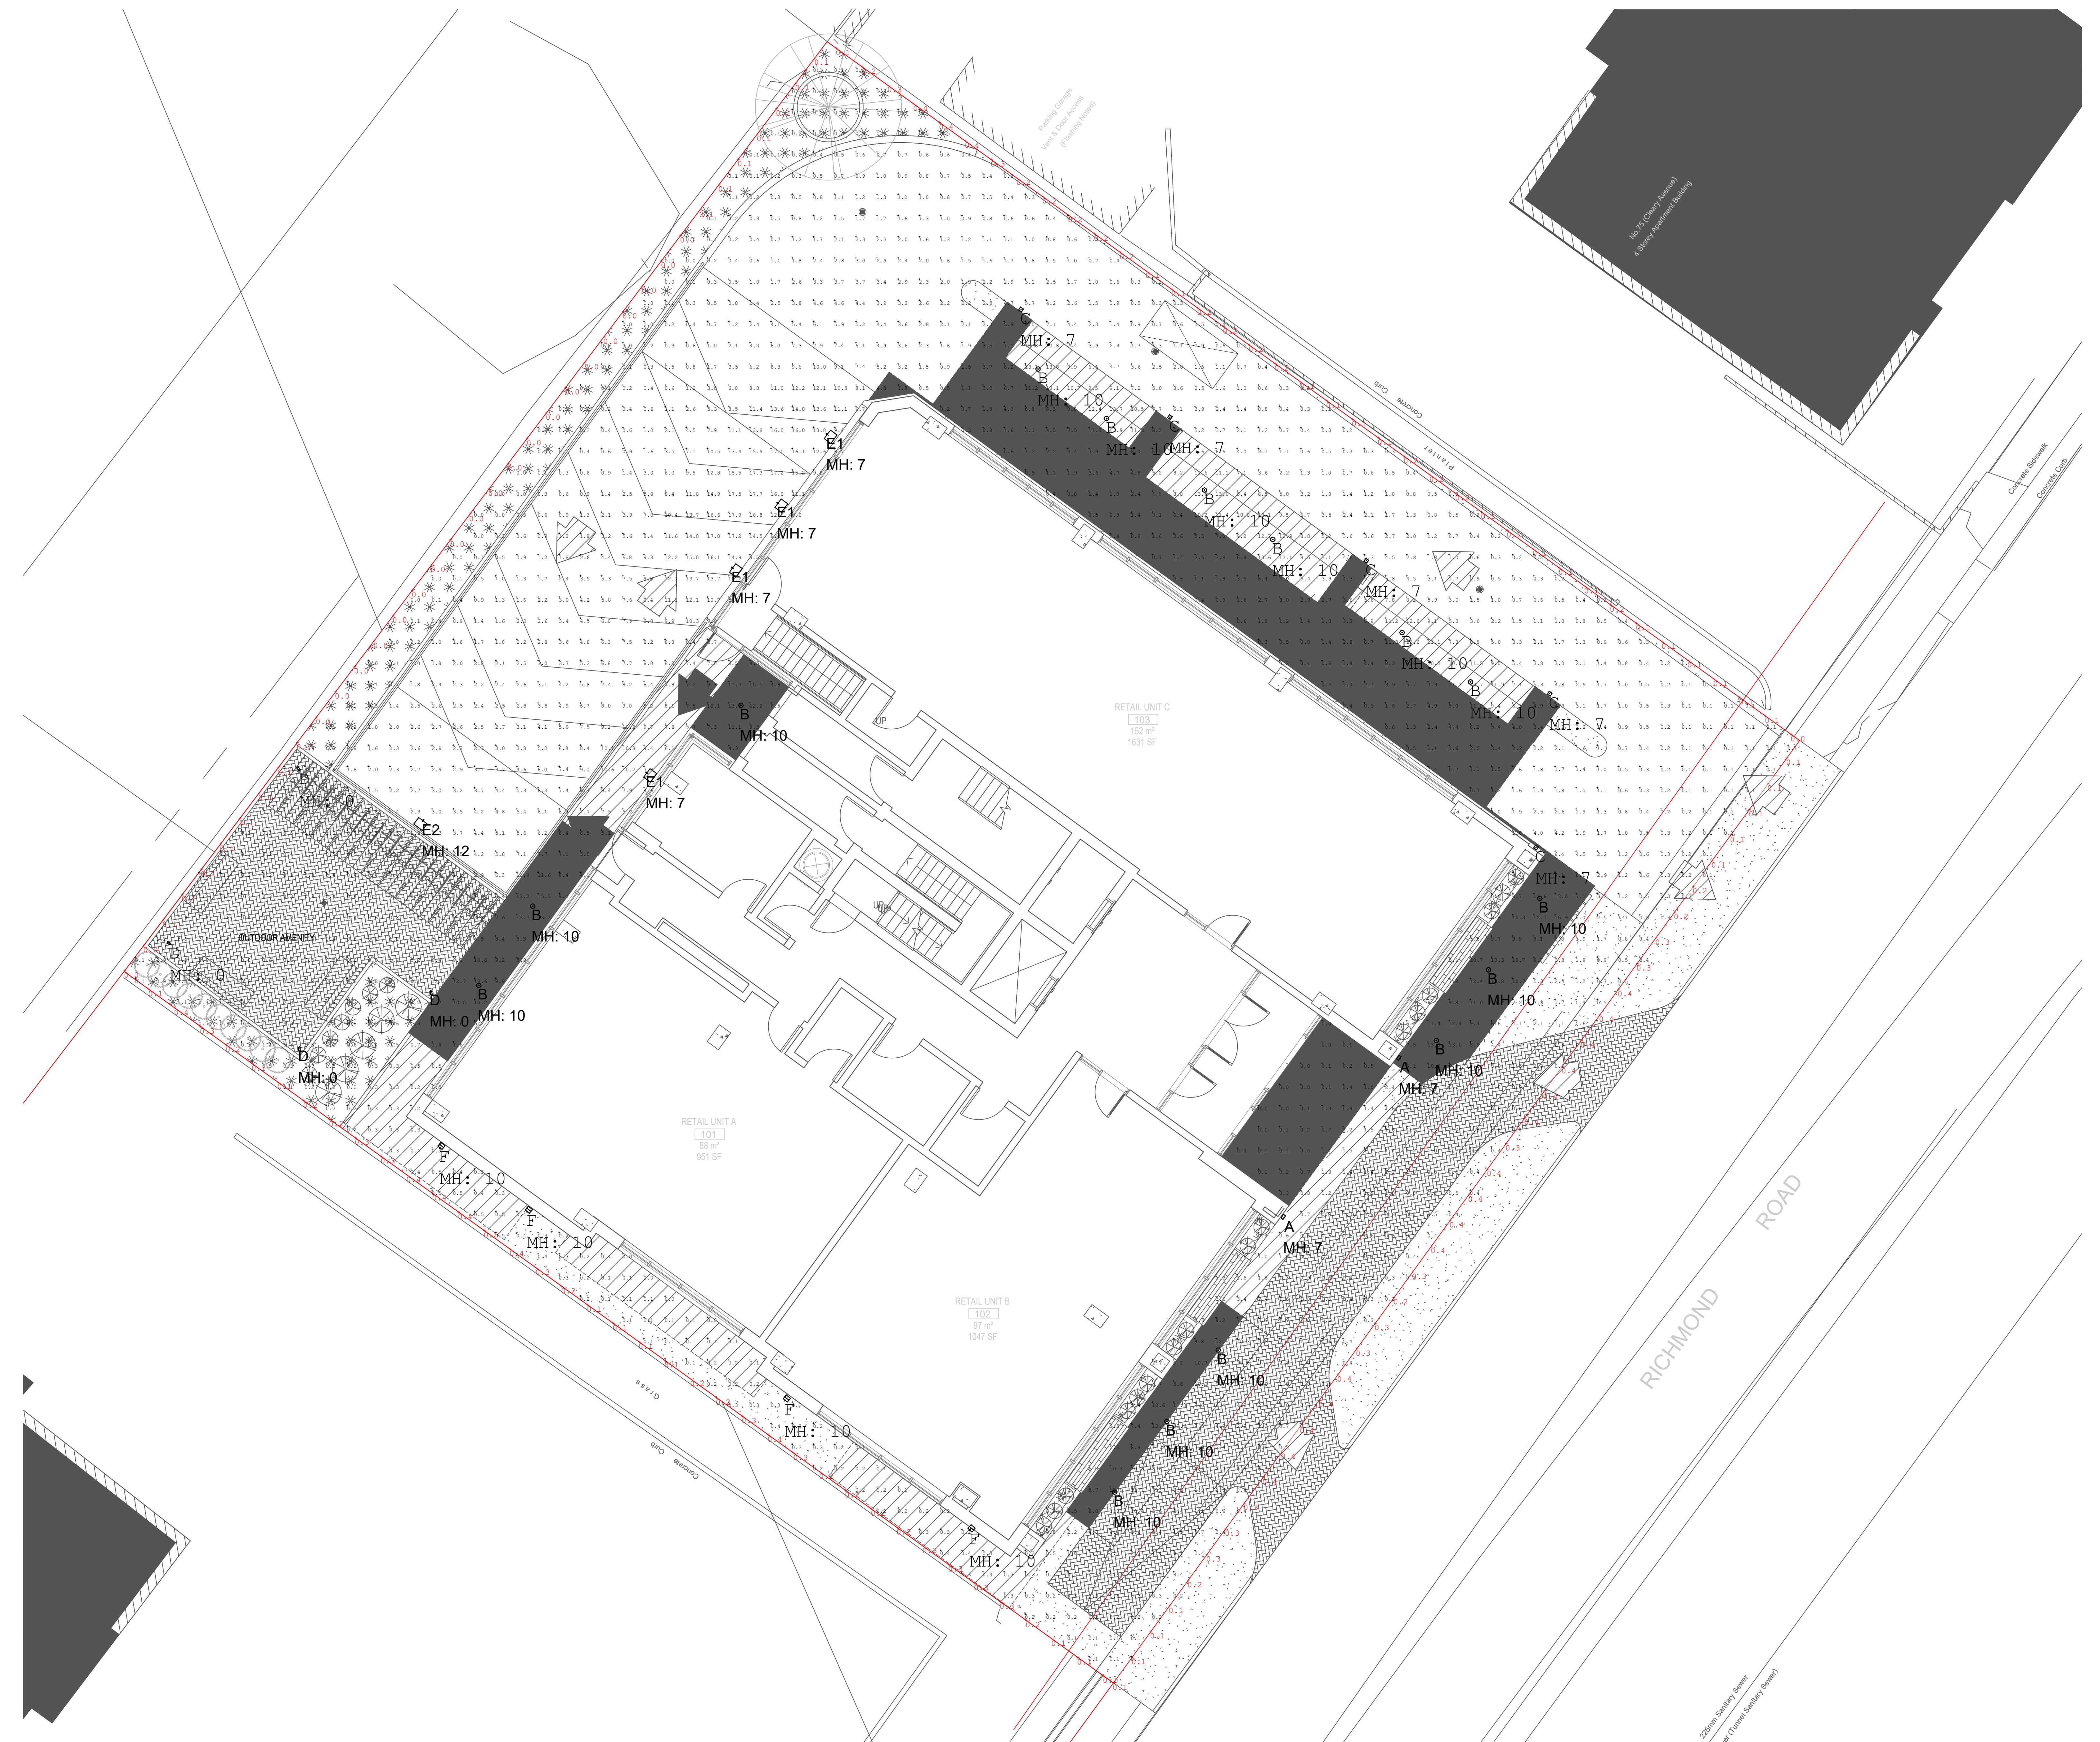

1 POINT BY POINT PHOTOMETRIC CALCULATION
L-01 SCALE: 1:70

Calculation Summary								
Label	CalcType	Units	Avg	Max	Min	Avg/Min		
PROPERTY LINE	Illuminance	Fc	0.18	0.5	0.0	N.A.		
SITE_Planar	Illuminance	Fc	3.25	17.9	0.0	N.A.		
Luminaire Schedule								
Symbol	Qty	Label	Manufacturer	Description	No. Lamps	Lum. Watts	Lumens/Lamp	LLF
□	2	A	TECH LIGHTING	7000WASP93026DUNVS	1	37.8	N.A.	0.900
○	15	B	LITELINE	RAA-12G-35K-90WH	1	11.56	865	0.900
□	5	C	KUZZO	EW33104-BK	1	8.4	N.A.	0.900
□	4	D	KUZZO	EB39824-BK	1	6.9	N.A.	0.900
□	4	E1	CREE	XSPW-B-MW-2ME-2L-40K-UL-XX	1	19	N.A.	0.900
□	1	E2	CREE	XSPW-B-MW-4ME-2L-40K-UL-XX	1	19	N.A.	0.900
□	4	F	KUZZO	AT6606-BK	1	14.2	N.A.	0.900

2 SCHEDULE AND CALCULATION SUMMARY
L-01 SCALE: NTS

Project name	797 RICHMOND APARTMENTS		
Drawing name	PHOTOMETRIC SUMMARY		
Scale	1:70	Drawn by	M. AL-SOLEH
Date	AS SHOWN	Checked by	
Stamp	2021.06.14		
Stamp	Drawing number		
Stamp	21372 L-01		

Lighting • Controls • Shades

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