

LEGEND

| | | | |
|--------|--|-------|---------------------------------|
| ○ M/H# | CONCRETE BARRIER CURB | — | LIMIT OF CONSTRUCTION |
| ○ T/G | STORM SEWER MANHOLE | — | DRAINAGE SWALE |
| ○ CB# | LANDSCAPE CATCHBASIN PER CITY S30 & S31 | — | DRAINAGE DITCH |
| ○ T/G | CATCHBASIN PER OPSD 701.010 | — | SLOPING AT 3:1 UNLESS SPECIFIED |
| □ AD# | AREA DRAIN TO BE SPECIFIED BY MECHANICAL | 95.50 | SURFACE ELEVATION |
| ○ M/H# | SANITARY SEWER MANHOLE | 95.50 | SWALE ELEVATION |
| ○ HYD | FIRE HYDRANT | 95.50 | TOP OF WALL ELEVATION |
| ○ W/V | WATER VALVE | 95.50 | BOTTOM OF WALL ELEVATION |
| ○ M | WATER METER | 95.50 | OVERLAND FLOW ROUTE |
| ○ RM | REMOTE WATER METER | 95.50 | SILT FENCE BARRIER |
| ○ RD | ROOF DRAIN | 95.50 | PROPOSED WALL |
| ○ S | SIAMESE CONNECTION | 95.50 | |
| — | SUBDRAIN | 95.50 | |

FOR REVIEW ONLY
NOT FOR CONSTRUCTION

| No. | Revisions | Date |
|-----|-------------------|---------------|
| 9 | ISSUED FOR REVIEW | AUG 30, 2022 |
| 8 | ISSUED FOR REVIEW | AUG 08, 2022 |
| 7 | ISSUED FOR REVIEW | JULY 21, 2022 |
| 6 | ISSUED FOR REVIEW | MAY 06, 2022 |
| 5 | ISSUED FOR REVIEW | MAR 10, 2022 |
| 4 | ISSUED FOR REVIEW | DEC 10, 2021 |
| 3 | ISSUED FOR REVIEW | NOV 29, 2021 |
| 2 | ISSUED FOR TENDER | NOV 10, 2021 |
| 1 | ISSUED FOR REVIEW | JUNE 30, 2021 |

Check and verify all dimensions before proceeding with the work. Do not scale drawings.

SCALE 1:300

McINTOSH PERRY
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Client: **KANATA WOODS INC**
205 - 1600 LAPERRIERE AVE
OTTAWA, ON K1Z 8P5


Project: **THE WOODS**
180 KANATA AVE

Drawing Title: **LOT GRADING AND DRAINAGE PLAN**

| | | | |
|--------------|--------|-----------------|-------------|
| Scale: | 1:300 | Project Number: | CCO-21-3764 |
| Drawn By: | R.R.R. | Checked By: | C.J.M. |
| Designed By: | C.J.M. | Drawing Number: | C101 |

GENERAL NOTES

- THE ORIGINAL TOPOGRAPHY, GROUND ELEVATION AND SURVEY DATA SHOWN ARE SUPPLIED FOR INFORMATION PURPOSES ONLY, AND IMPLY NO GUARANTEE OF ACCURACY. IT SHALL BE THE RESPONSIBILITY OF THE CONTRACTOR TO VERIFY ALL INFORMATION SHOWN.
- THIS PLAN IS NOT A CADASTRAL SURVEY SHOWING LEGAL PROPERTY BOUNDARIES AND EASEMENTS. THE PROPERTY BOUNDARIES SHOWN HEREON HAVE BEEN DERIVED FROM INFORMATION SUPPLIED BY (OR SHOWN ON) FARLEY SMITH & DENNIS SURVEYING LTD. FILE # 139-21. AND CANNOT BE RELIED UPON TO BE ACCURATE OR COMPLETE. THE PRECISE LOCATION OF THE CURRENT PROPERTY BOUNDARIES AND EASEMENTS CAN ONLY BE DETERMINED BY AN UP-TO-DATE LAND TITLES SEARCH AND A SUBSEQUENT CADASTRAL SURVEY PERFORMED AND CERTIFIED BY AN ONTARIO LAND SURVEYOR.
- THE CONTRACTOR IS TO OBTAIN AND PAY FOR ALL NECESSARY PERMITS AND APPROVALS FROM THE CITY BEFORE COMMENCING CONSTRUCTION.
- THE CONTRACTOR IS RESPONSIBLE FOR ALL LAYOUT.
- THE CONTRACTOR IS TO DETERMINE THE EXACT LOCATION, SIZE, MATERIAL AND ELEVATION OF ALL EXISTING UTILITIES PRIOR TO COMMENCING CONSTRUCTION. PROTECT AND ASSUME ALL RESPONSIBILITY FOR EXISTING UTILITIES WHETHER OR NOT SHOWN ON THESE DRAWINGS. IF THERE IS ANY DISCREPANCY THE CONTRACTOR IS TO NOTIFY THE ENGINEER PROMPTLY.
- RESTORE ALL TRENCHES AND SURFACES OF PUBLIC ROAD ALLOWANCES TO CONDITION EQUAL OR BETTER THAN ORIGINAL CONDITION AND TO THE SATISFACTION OF THE CITY AUTHORITIES.
- EXCAVATE AND DISPOSE OF ALL EXCESS EXCAVATED MATERIAL, SUCH AS ASPHALT, CURBING AND DEBRIS, OFF SITE AS DIRECTED BY THE ENGINEER AND THE CITY.
- TOPSOIL TO BE STRIPPED AND STOCKPILED FOR REHABILITATION. CLEAN FILL TO BE PLACED IN FILL AREAS AND COMPACTED TO 95% STANDARD PROCTOR DENSITY.
- ALL DISTURBED AREAS TO BE RESTORED TO ORIGINAL CONDITION OR BETTER UNLESS OTHERWISE SPECIFIED.
- THE CONTRACTOR SHALL BE RESPONSIBLE FOR ALL TRAFFIC CONTROL AND SAFETY MEASURES DURING THE CONSTRUCTION PERIOD, INCLUDING THE SUPPLY, INSTALLATION, AND REMOVAL OF ALL NECESSARY SIGNAGE, DELINEATORS, MARKERS AND BARRIERS.
- DO NOT ALTER GRADING OF THE SITE WITHOUT PRIOR APPROVAL OF THE ENGINEER/CITY.
- ALL ROADWAY, PARKING LOT, AND GRADING WORKS TO BE UNDERTAKEN IN ACCORDANCE WITH CITY STANDARDS AND SPECIFICATIONS. THE CONTRACTOR IS TO PROVIDE POSITIVE DRAINAGE AWAY FROM THE BUILDING.
- CONTACT THE CITY FOR INSPECTION OF ROUGH GRADING OF PARKING LOTS, ROADWAYS AND LANDSCAPED AREAS PRIOR TO PLACEMENT OF ASPHALT AND TOPSOIL. ALL DEFICIENCIES NOTED SHALL BE RECTIFIED TO THE CITY'S SATISFACTION PRIOR TO PLACEMENT OF ANY ASPHALT, TOPSOIL, SEED & MULCH AND/OR SOIL.
- ALL DIMENSIONS AND INVERTS MUST BE VERIFIED PRIOR TO CONSTRUCTION, IF THERE IS ANY DISCREPANCY THE CONTRACTOR IS TO NOTIFY THE ENGINEER PROMPTLY.
- ELECTRICAL, GAS, TELEPHONE AND TELEVISION SERVICE LOCATIONS ARE SUBJECT TO THE INDIVIDUAL AGENCY:
 - ELECTRICAL SERVICE - HYDRO ONE,
 - GAS SERVICE - ENBRIDGE,
 - TELEPHONE SERVICE - BELL CANADA,
 - TELEVISION SERVICE - ROGERS.
- INSTALLATION TO BE IN ACCORDANCE WITH CURRENT CODES AND STANDARDS OF APPROVAL AGENCIES HYDRO ONE, BELL AND THE CITY.
- CONTRACTOR TO ENSURE ALL APPLICABLE OPS SPECIFICATIONS ARE FOLLOWED DURING CONSTRUCTION.
- ALL PROPOSED CURB TO BE CONCRETE BARRIER CURB UNLESS OTHERWISE SPECIFIED.
- THIS PLAN MUST BE READ IN CONJUNCTION WITH THE GEOTECHNICAL INVESTIGATION COMPLETED BY PATERSON GROUP DATED APRIL 21, 2021.

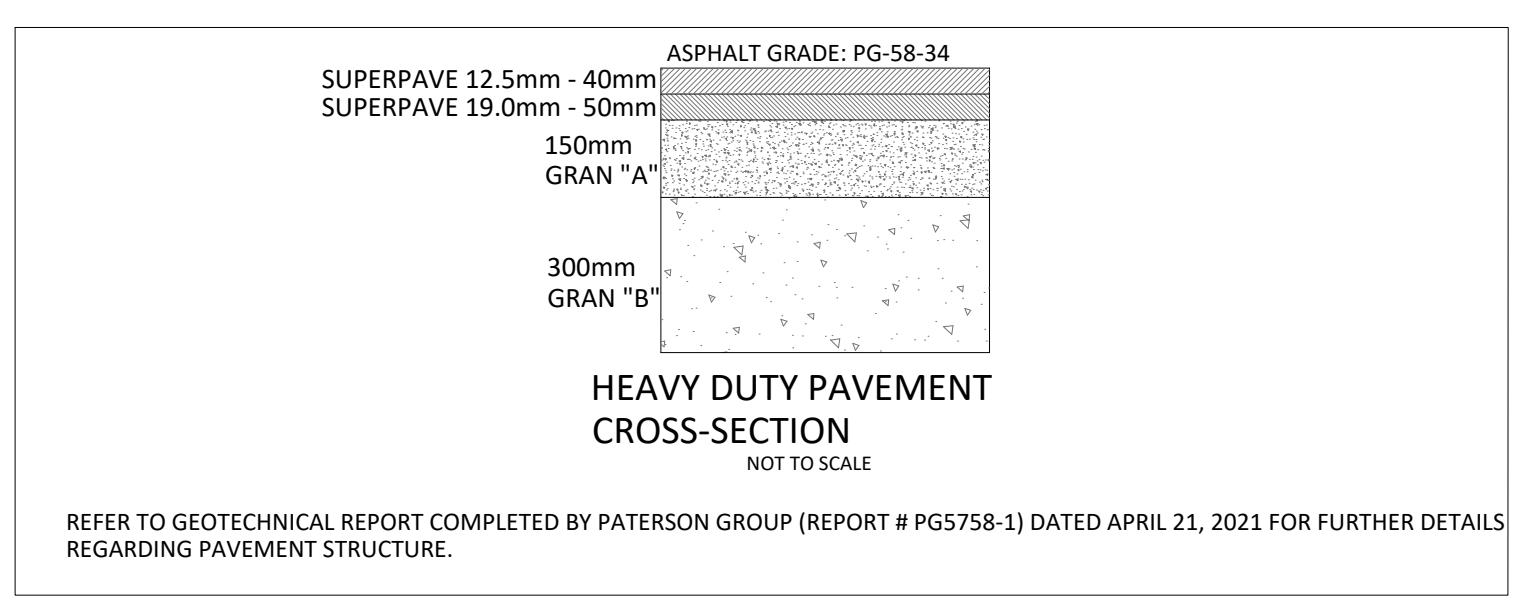

ROOF DRAINS (B3)

| TYPE OF CONTROL DEVICE | WATTS DRAINAGE RD-100-A-ADJ (CLOSED) | | |
|--------------------------------|--------------------------------------|--------|--------|
| NUMBER OF ROOF DRAINS | 23 | | |
| SCENARIO | 2-YEAR | 5-YEAR | 100-YR |
| AVAILABLE ROOFTOP STORAGE (m³) | 94.71 | 132.60 | 303.08 |
| DEPTH OF FLOW (m) | 0.025 | 0.035 | 0.080 |
| FLOW PER ROOF DRAIN (L/s) | 0.32 | 0.32 | 0.32 |
| TOTAL RESTRICTED FLOW | 7.25 | 7.25 | 7.25 |

ICD TABLE

| STRUCTURE ID | ICD SIZE (mm) | STYLE | 5-YEAR DESIGN HEAD (m) | 100-YEAR DESIGN HEAD (m) | 5-YEAR DESIGN FLOW (L/s) | 100-YEAR DESIGN FLOW (L/s) |
|--------------|---------------|-------|------------------------|--------------------------|--------------------------|----------------------------|
| AD1* | 82mm | PLUG | - | 0.67 | - | 11.09 |
| AD2* | 75mm | PLUG | - | 0.55 | - | 9.19 |
| AD3* | 90mm | PLUG | 0.55 | 0.62 | 12.60 | 13.37 |

*ICD TO BE PERMANENTLY AFFIXED TO OUTLET PIPE

Allison Hamlin

ALLISON HAMLIN
MANAGER (A), DEVELOPMENT REVIEW WEST
PLANNING, REAL ESTATE & ECONOMIC DEVELOPMENT
DEPARTMENT, CITY OF OTTAWA

APPROVED
By Allison Hamlin at 9:16 am, Nov 18, 2022

FILENAME: C:\ottdraw\01 Project - Proposed\2021\06\16\CCO-21-3764\The Woods - B095 Compas.dwg; The Woods - B095 Compas.dwg; C:\ottdraw\01 Project - Proposed\2021\06\16\CCO-21-3764\The Woods - B095 Compas.dwg
 DATE PLOTTED: Tuesday, August 30, 2022 1:45:54 PM
 PLOTTED BY: C:\ottdraw\01 Project - Proposed\2021\06\16\CCO-21-3764\The Woods - B095 Compas.dwg
 PLOT DEVICE: Plotter

D07-12-21-0098