
NOTES:

THIS PLAN IS ISSUED FOR SITE PLAN CONTROL SUBMISSION ONLY.
ADDITIONAL DETAILING AND SPECIFICATIONS ARE REQUIRED PRIOR TO
TENDERING OR CONSTRUCTION.

SERVICING INFORMATION SHOWN AS REFERENCE ONLY. REFER TO CIVIL DRAWINGS.

DRAWING TO BE READ IN CONJUNCTION WITH TREE CONSERVATION REPORT. REFER TO TREE CONSERVATION REPORT PREPRARED BY RUHLAND & ASSOCIATES LTD. DATED AUG 09, 2024 FOR TREE PROTECTION MEASURES AND DETAILS.

ALL TREES TO BE PLANTED A MINIMUM OF 1m FROM EDGE OF SIDEWALK

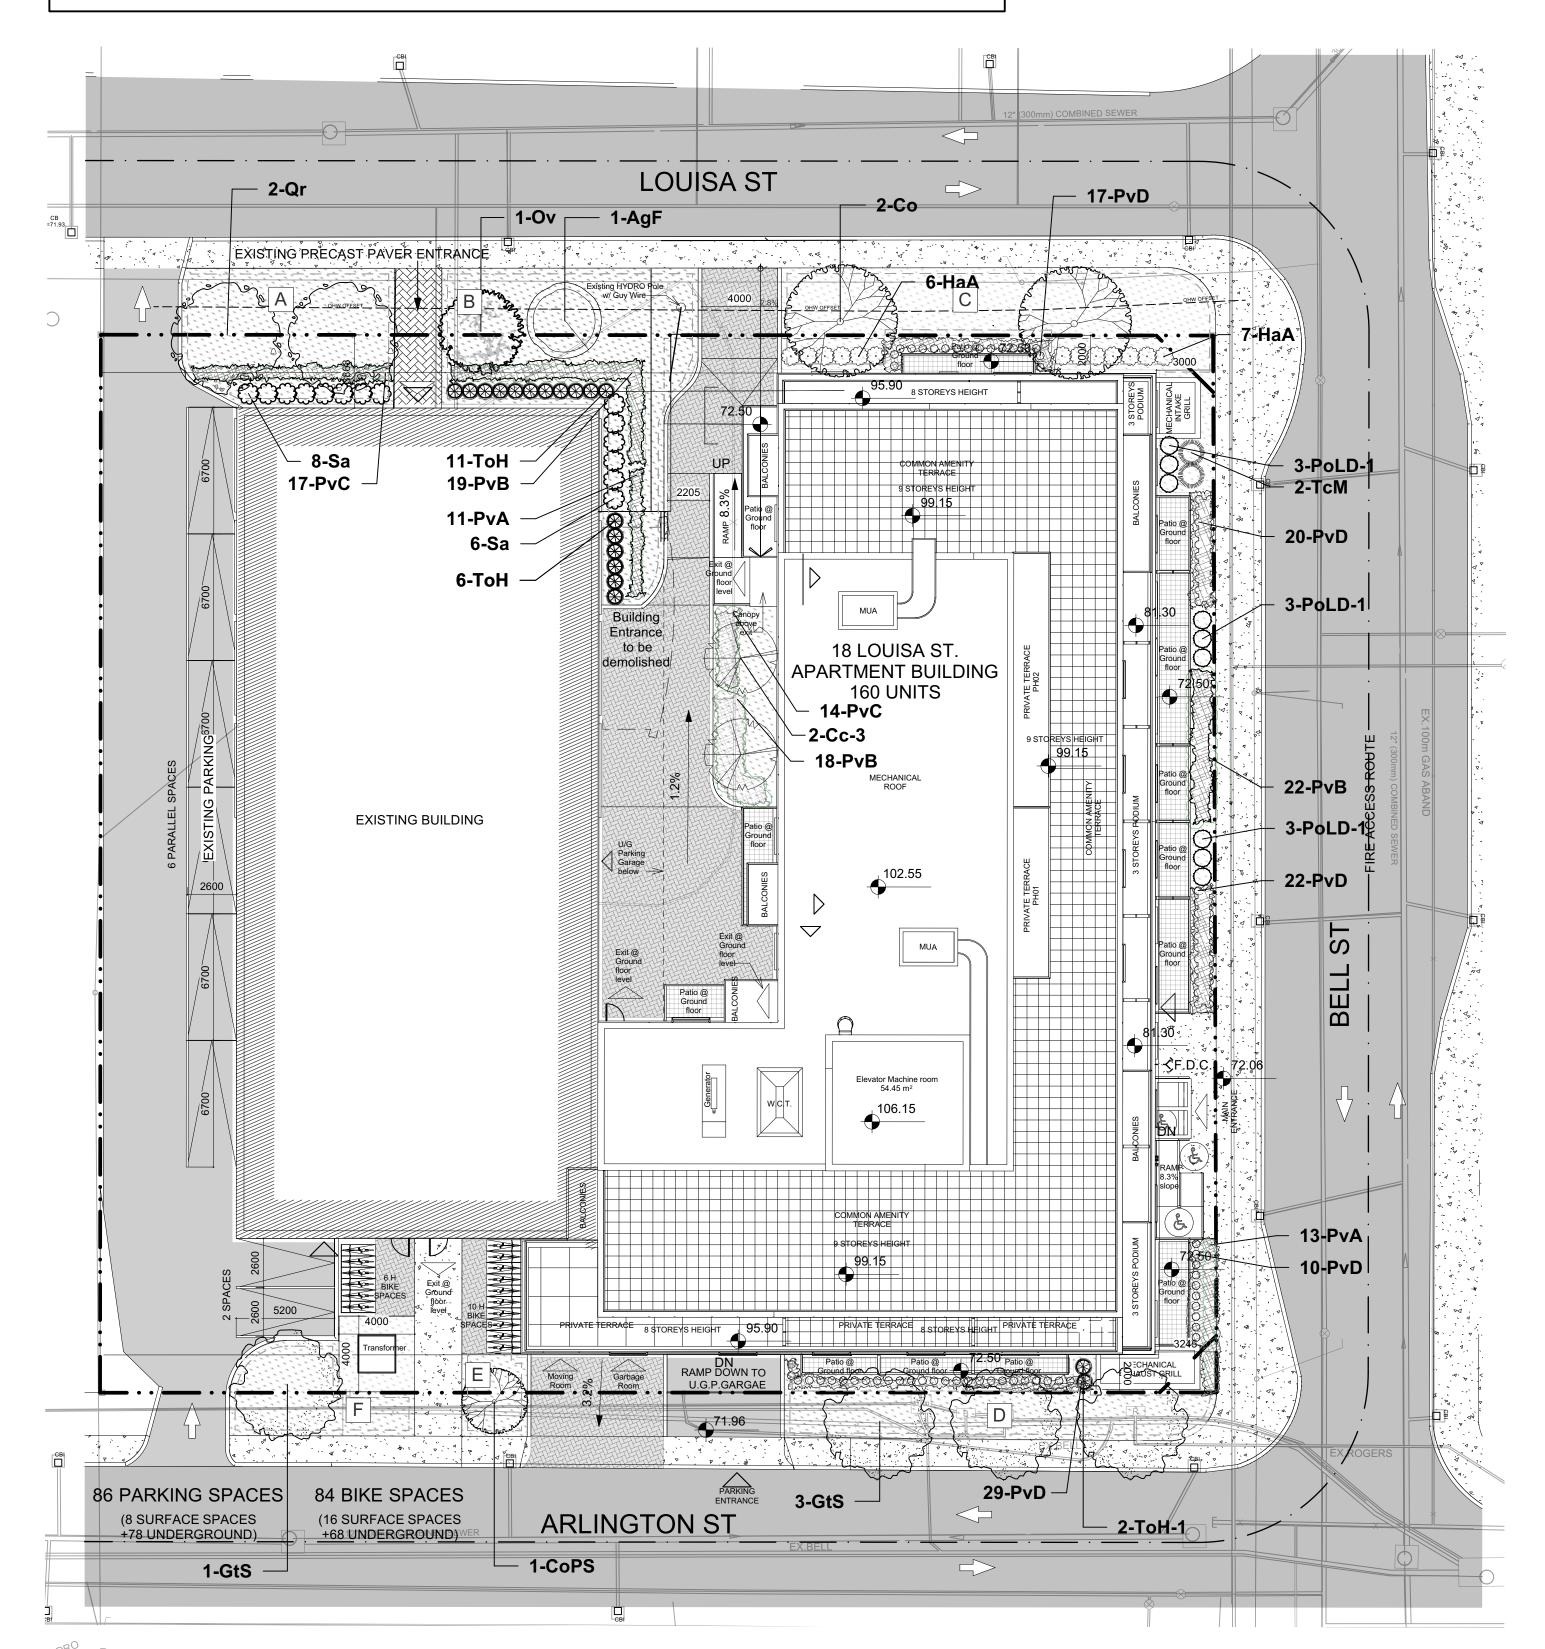

PROPOSED PERENNIALS AND ORNAMENTAL GRASSES

ID	Qty	Botanical Name	Common Name	Scheduled Size	Remarks
		TREES			
AgF	1	Acer ginnala 'Flame'	Flame Amur Maple	45mm caliper	WB, Staked
Cc-3	2	Carpinus caroliniana	Bluebeech, Musclewood	50mm caliper	WB, Staked
Со	2	Celtis occidentalis	Common Hackberry	60mm caliper	WB Staked
CoPS	1	Celtis occidentalis 'Prairie Sentinel' Prairie Sentinel Hackberry		60mm dia.	WB Staked
GtS	4 Gleditsia triacanthos 'Shademaster' Shademaster H		Shademaster Honey Locust	60mm caliper	WB Staked
Ov	1	Ostrya virginiana	Ironwood	50mm dia.	WB Staked
Qr	2	Quercus rubra	Northern Red Oak	60mm caliper	WB Staked
		SHRUBS			
НаА	13	Hydrangea arborescens 'Annabelle'	Annabelle Hydrangea	2 gallon pot	0.9m o.c.
PoLD-	9	Physocarpus opulifolius 'Little Devil'	Little Devil Ninebark	50cm ht.	Potted
Sa	14	Symphocarpus albus	Common Snowberry	50 cm ht.	Potted
ТсМ	2	Taxus cuspidata 'Monloo'	Emerald Spreader Japanese Yew	60cm spd	0.5m o.c.
ТоН	23	Thuja occidentalis ssp.	Dwarf Cedar ssp.	100 cm ht.	Potted
ToH-1	2	Thuja occidentalis ssp.	Dwarf Cedar ssp.	100 cm ht.	Potted
		PERENNIALS			
PvA	24	Perennial Mix A - Sun-Shade	Coral Bells, Sedge, Hostas	150mm pot	
PvB	59	Perennial Mix B - Sun-Shade	Ornamental Grasses-Shade	150mm pot	
PvC	31	Perennial Mix C - Shade	Ferns, Hostas, Daylilies, Solomon's Seal	150mm pot	
PvD	98	Sun Grasses Mix D	Sedges, Feather Reed Grasses	150mm pot	

18 Louisa Street				
Soil Volume Area, Tree Quantity and Size	Tree Quantity	OTTAWA TARGET SOIL VOLUME (m3)	Design Soil Volume	SOIL ADEQUACY percentage
AREA A - 2 Large shade trees				
Plant bed (80 sq m x 0.45 metre deep)	2	36.0	30.6	85.00%
AREA B- 2 Medium shade trees				
plant bed (39 sq m x 0.6 metre deep)	2	50.0	67.2	134.40%
AREA C - 2 Large shade trees				
Plant bed (81.5 sq m x 0.45 metre deep)	2	36.0	41.2	114.38%
AREA D - 3 Medium shade trees				
plant bed (21 sq m x 0.8 metre deep)	3	45.0	39.2	87.11%
AREA E - 1 Small Ornamental tree				
plant bed (13.6 sq m x 0.6 metre deep)	1	8.0	6.6	82.50%
AREA F - 1 Medium shade tree				
plant bed (6 sq m x 0.8 metre deep)	1	25.0	22.4	89.60%

GENERAL NOTES

- .1 All general site information and conditions compiled from existing plans, surveys and consultant's field notes. Report all discrepancies prior to any work. No responsibility is born by the Consultant for unknown subsurface conditions.
- .2 The location of the utilities is approximate only, and the exact location should be determined by consulting the municipal authorities and utility companies concerned. The Contractor shall prove the location of utilities and shall be responsible for adequate protection from damage.
- .3 All dimensions shown are to be verified on site prior to any construction. No deviations are to be made from the layouts as shown on this plan without prior consultation with the Landscape Architect and Owner.
- .4 Obtain approval of Landscape Architect for granular base and layout of all pavement areas prior to construction.
- .5 Stake planting locations and receive approval of Landscape Architect, prior to excavation of any planting pits. No substitutions of plant material shall be made without prior approval of the Landscape Architect.
- .6 Where clay is encountered proper drainage must be ensured in tree/shrub pits, prior to planting. Have method approved by Landscape Architect.
- .7 All sodded areas to receive a minimum of 150mm of topsoil over graded sub-base. If sod with mesh is used, mesh to be removed completely during sodding operations. Sod shall come from an approved source and shall be laid within 24 hours of being cut in the nursery. Only nursery sod shall be
- .8 Final subgrade is to approved by the Landscape Architect prior to sod being laid.
- .9 Maintain positive surface runoff through the entire construction period.
- .10 Reinstate all areas and items damaged as a result of construction activities.
- .11 Street tree species locations and numbers were selected based on soil volume calculations in accordance with the City of Ottawa's requirements for tree planting.

PROJECT TEAM

ARCHITECT
HOBIN ARCHITECTURE
David Anderson
danderson@hobinarc.com
613.238.7200 x122
Patrick Bisson
pbisson@hobinarc.com

613.238.7200 x128

613-668-3459

OWNERSHIP
IRONWOOD FUND LIMITED PARTNERSHIP
Kenneth Jennings
kjennings@jenningsdevelopments.com

PLANING
FOTENN PLANNING + DESIGN
Ghada Zaki
zaki@fotenn.com
613.730.5709 ext. 226
Brian Casagrande
casagrande@fotenn.com

CIVIL
NOVATECH
Francois Thauvette
f.thauvette@novatech-eng.com
613.254.9643 Ext: 219

613-730-5709 ext. 235

LANDSCAPE ARCHITECT
RUHLAND & ASSOCIATES

Marietta Ruhland mruhland@rala.ca 613 224-4744 x 222

TRANSPORTATION
CGH TRANSPORTATION
Andrew Harte

Andrew Harte andrew.harte@cghtransportation.com 343-999-9117


ENVIRONMENTAL
GRADIENT WIND

Justin Ferrarojustin.ferraro@gradientwind.com Vincent Ferrarovincent.ferraro@gradientwind.com 613 836 0934 x112

GEOTHECHNICAL
PATERSONGROUP
Faisal Abou-Seido
FAbou-Seido@Patersongroup.ca
(613) 226-7381 Ext. 210
David Gilbert
dgilbert@patersongroup.ca
(613) 226-7381 Ext. 205

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	5		
	4	Reissued for site plan control	2024/08/13
	3	Reissued for site plan control	2024/07/30
	2	Reissued for site plan control	2021/11/12
	1	Issued for site plan control	2021/06/01
	no.	issue / revision	date



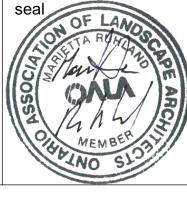

SOIL VOLUME REQUIREMENTS:

AREAS WHERE SITE CONSTRAINTS (such as parking lot islands, adjacent hard surface areas):0.9 TO 1.2 METRE DEPTH IMPORTED TOPSOIL (average depth of 1000mm).

AREAS WITHIN OR ADJACENT TO LARGER SOFT LANDSCAPE AREAS (such as wide boulevards, lawns, etc):

0.4 METRE AVERAGE DEPTH OF IMPORTED TOPSOIL OVER APPROVED EXISTING SUBSOIL. ADDITIONAL IMPORTED TOPSOIL OR APPROVED SUBSOIL TO BE ADDED WHERE SUBGRADE BELOW THE 400mm IMPORTED TOPSOIL IS NOT CONDUSIVE TO PLANT GROWTH TO A MAXIMUM DEPTH OF 1 METRE.

Ruhland & Associates Ltd

landscape architecture • urban design • site planning

project

18 LOUISA STREET

OTTAWA, ON

drawing title

LANDSCAPE PLAN

scale	drawn by	designed by
	J. K. / T.F.	J.K. / M.R.
date	checked by	plot date
JUNE 2021	M. R.	2021 06 01
project number	drawing number	


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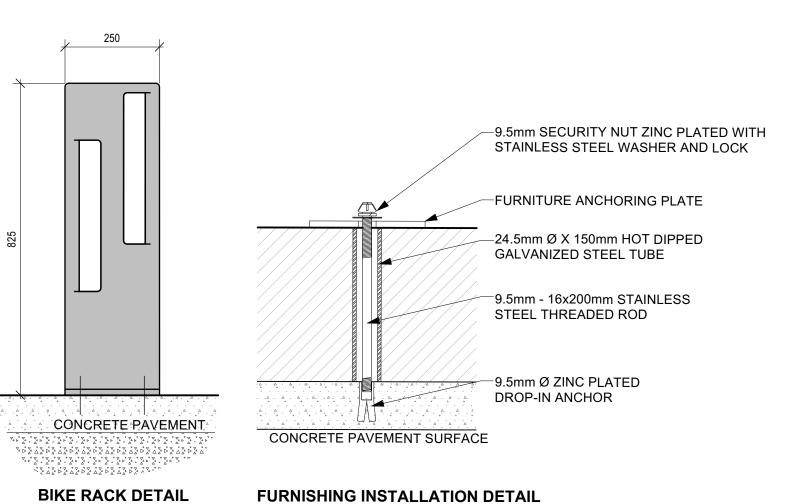
L - 01

Contractor to check and verify all dimensions on the job

LANDSCAPE PLAN AT GRADE
Scale: 1:200


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PROVIDE SHOP DRAWINGS FOR ANCHORS AND CONCRETE PAD

TREE CANOPY COVERAGE TOTAL CANOPY AREA 1200 m2 3307.5 m2 TOTAL SITE AREA PERCENT COVERAGE 36.28%

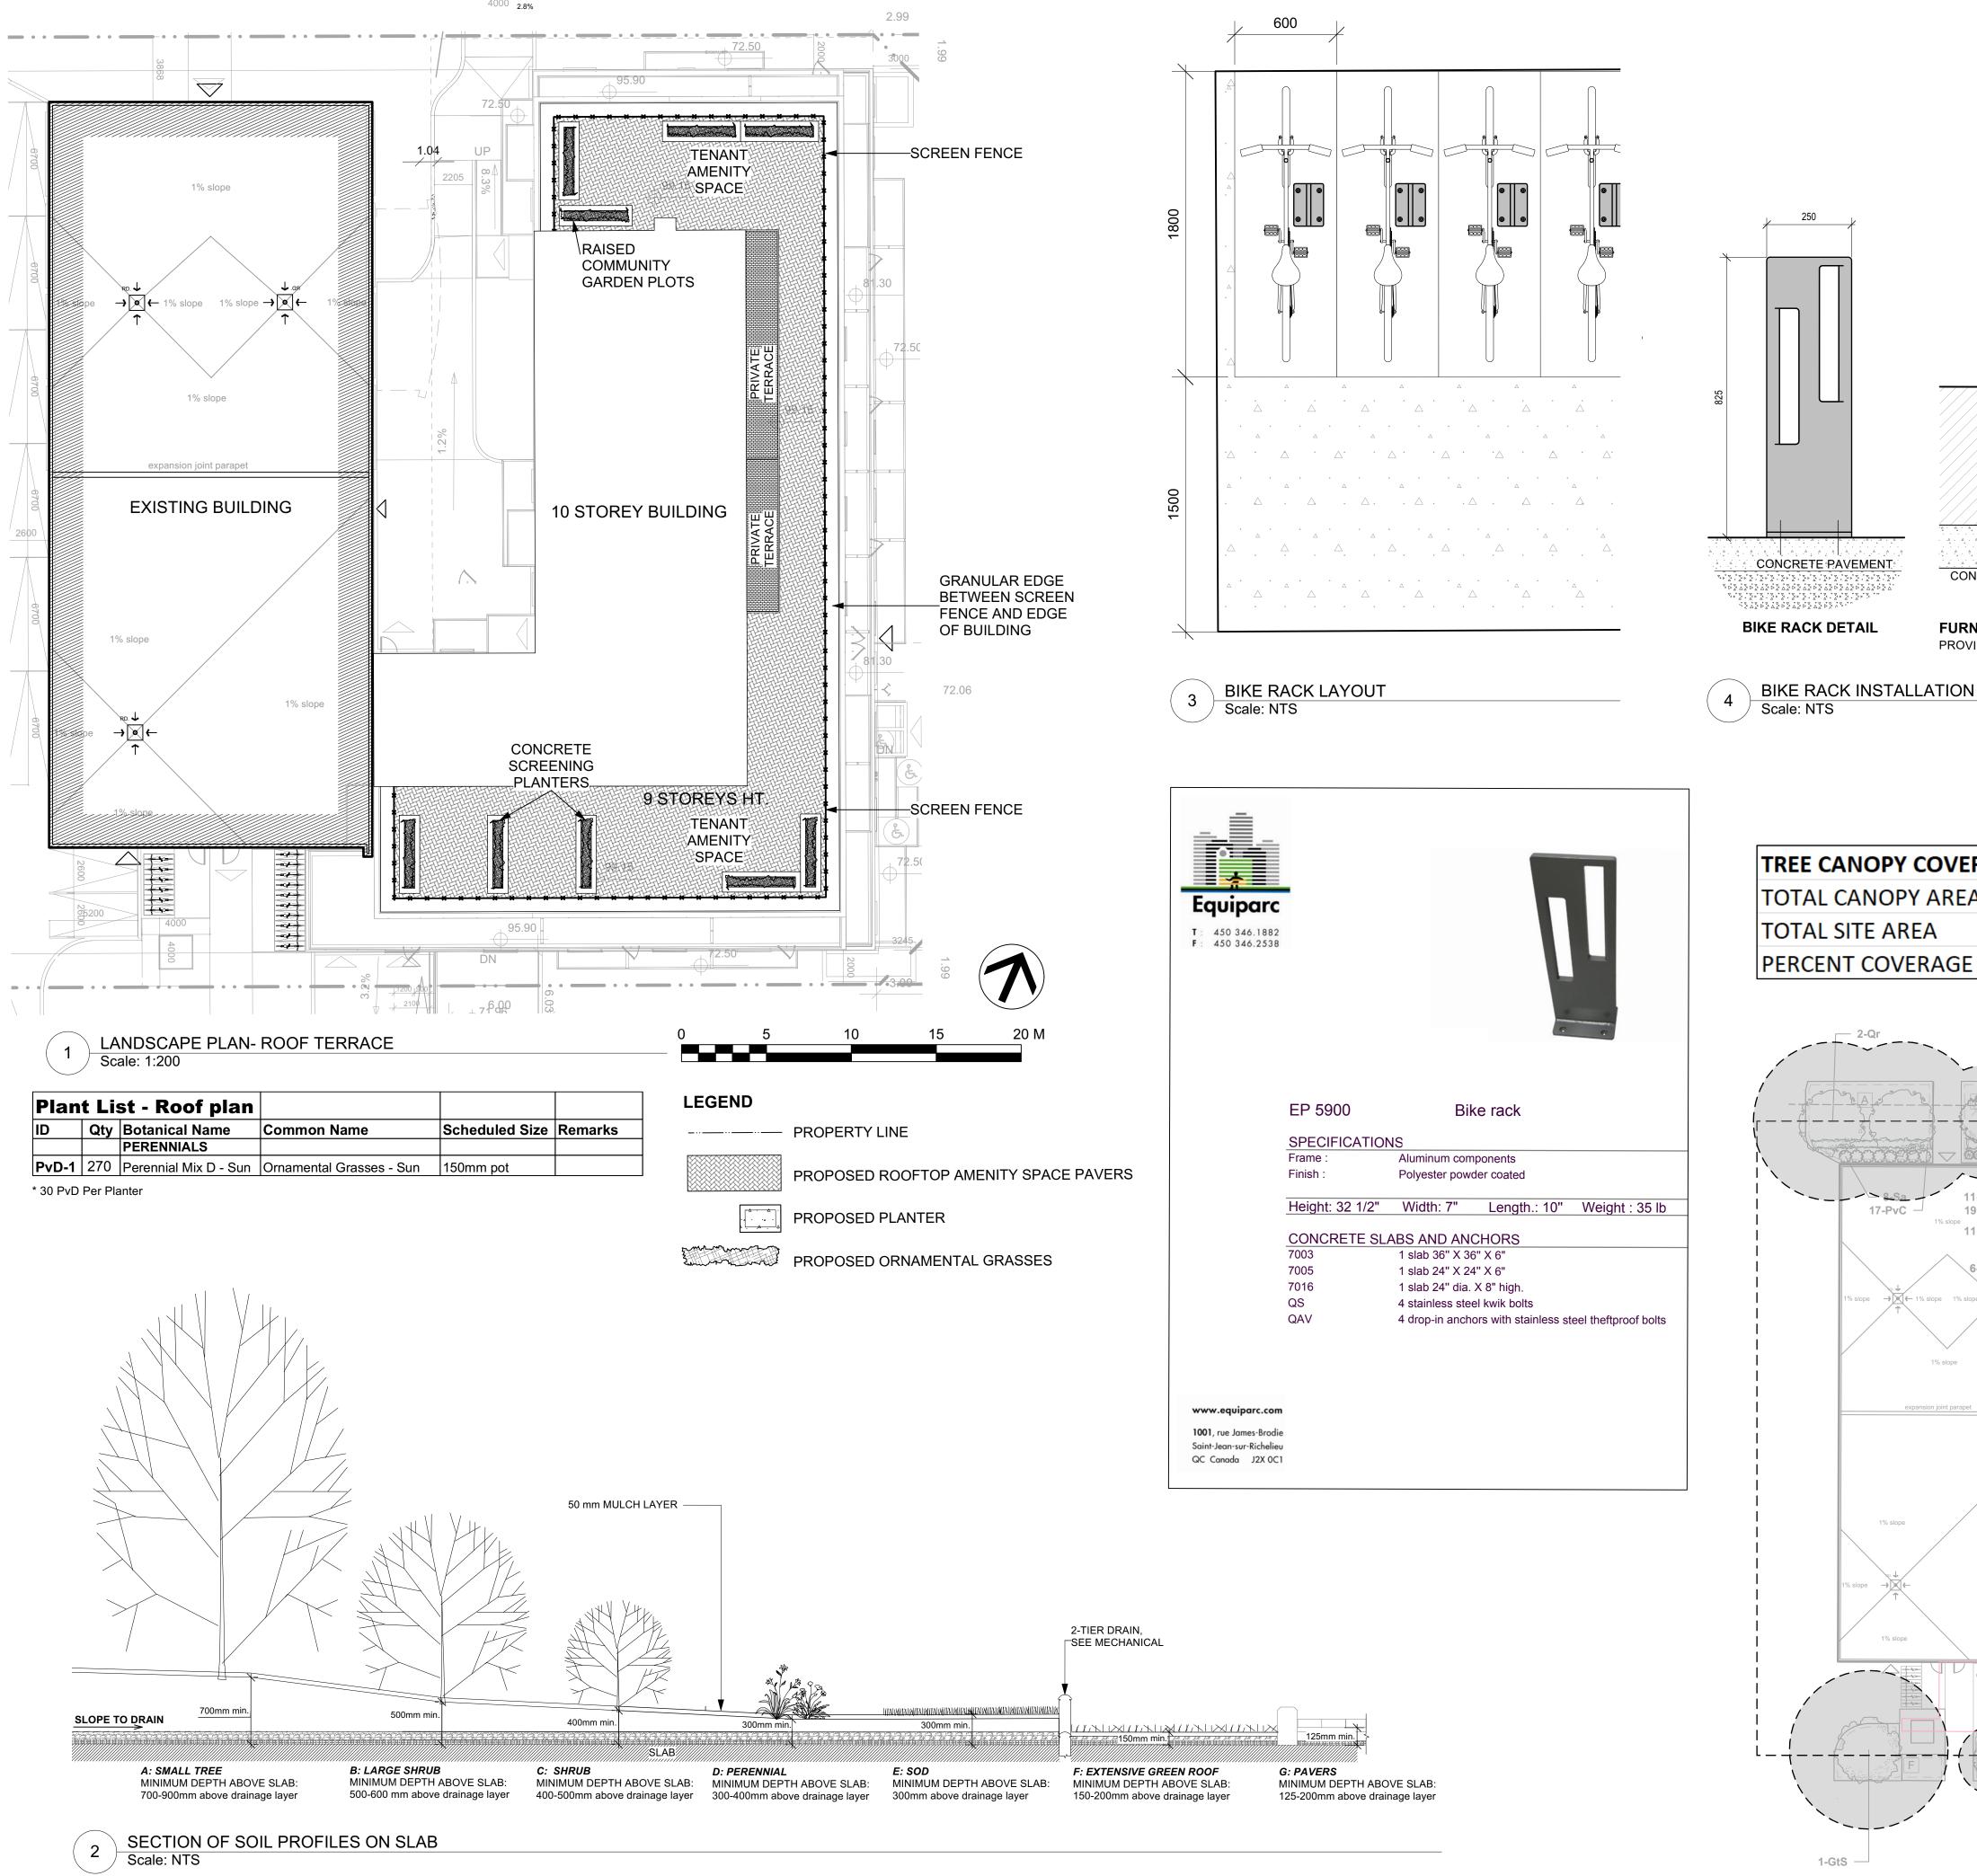

PROJECT TEAM

ARCHITECT HOBIN ARCHITECTURE David Anderson danderson@hobinarc.com 613.238.7200 x122 Patrick Bisson pbisson@hobinarc.com 613.238.7200 x128

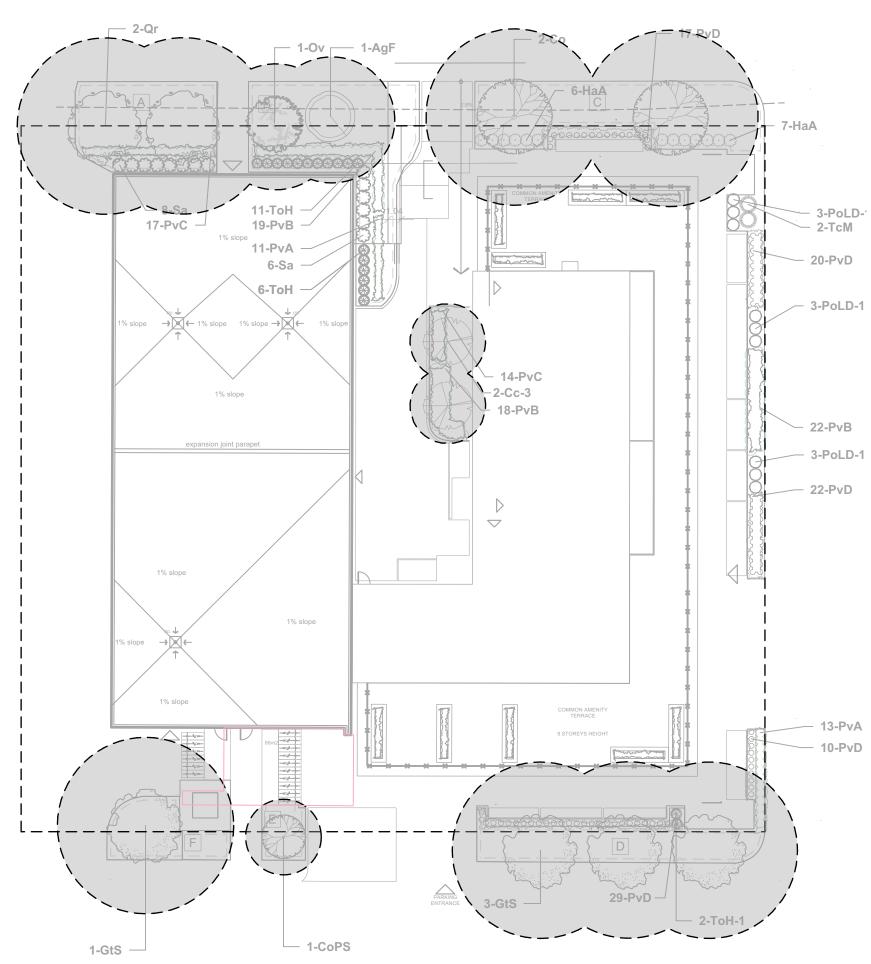OWNERSHIP IRONWOOD FUND LIMITED PARTNERSHIP Kenneth Jennings kjennings@jenningsdevelopments.com 613-668-3459

PLANING FOTENN PLANNING + DESIGN Ghada Zaki zaki@fotenn.com 613.730.5709 ext. 226 Brian Casagrande casagrande@fotenn.com 613-730-5709 ext. 235

NOVATECH Francois Thauvette f.thauvette@novatech-eng.com 613.254.9643 Ext: 219

LANDSCAPE ARCHITECT RUHLAND & ASSOCIATES Marietta Ruhland

mruhland@rala.ca 613 224-4744 x 222 TRANSPORTATION

CGH TRANSPORTATION Andrew Harte andrew.harte@cghtransportation.com 343-999-9117

ENVIRONMENTAL **GRADIENT WIND** Justin Ferrarojustin.ferraro@gradientwind.com Vincent Ferrarovincent.ferraro@gradientwind.com 613 836 0934 x112

GEOTHECHNICAL PATERSONGROUP Faisal Abou-Seido FAbou-Seido@Patersongroup.ca (613) 226-7381 Ext. 210 David Gilbert dgilbert@patersongroup.ca (613) 226-7381 Ext. 205

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no.			date

Ruhland & Associates Ltd

north

18 LOUISA STREET

OTTAWA, ON

drawing title **ROOF PLAN /**


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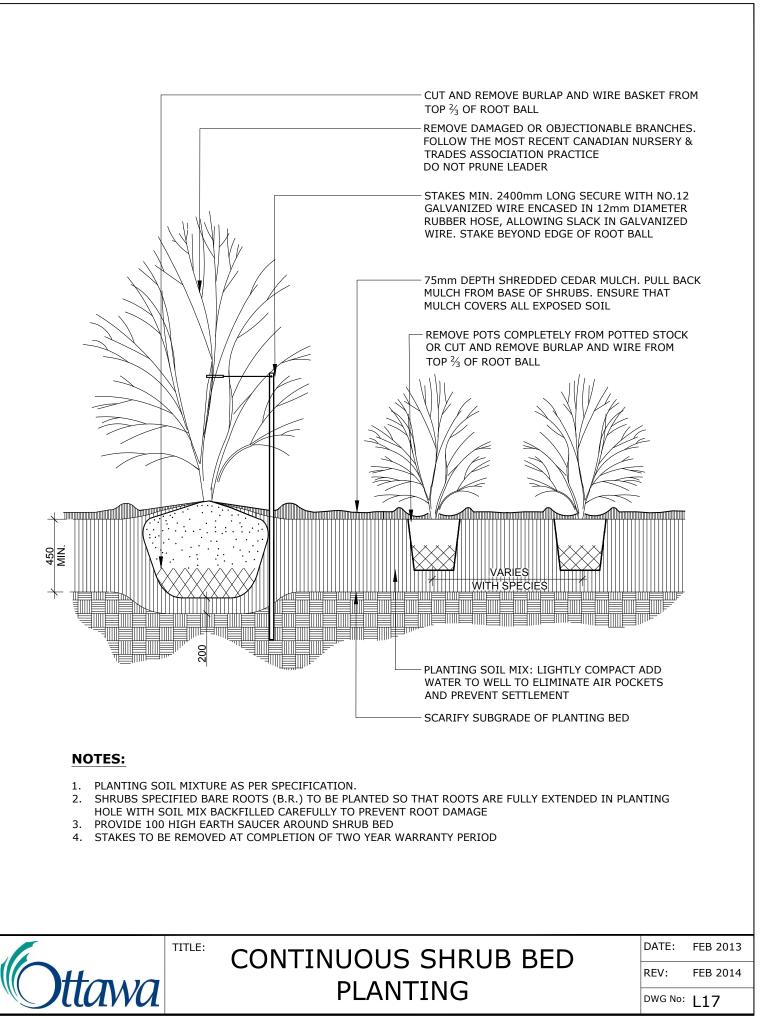
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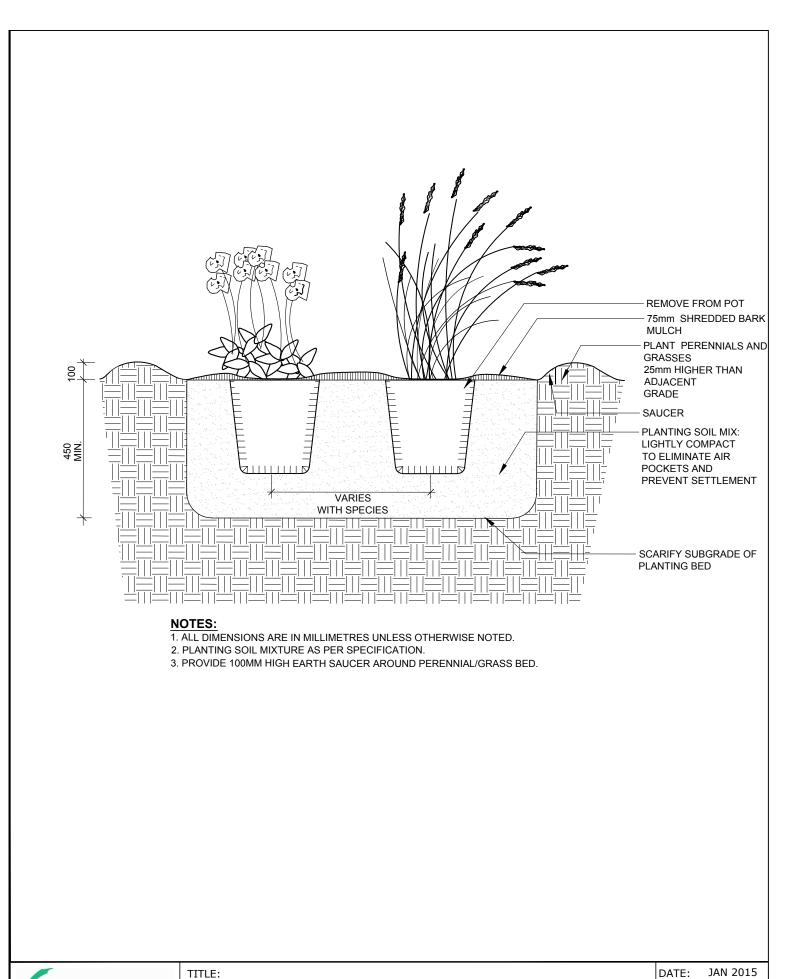
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L - 02

Contractor to check and verify all dimensions on the job





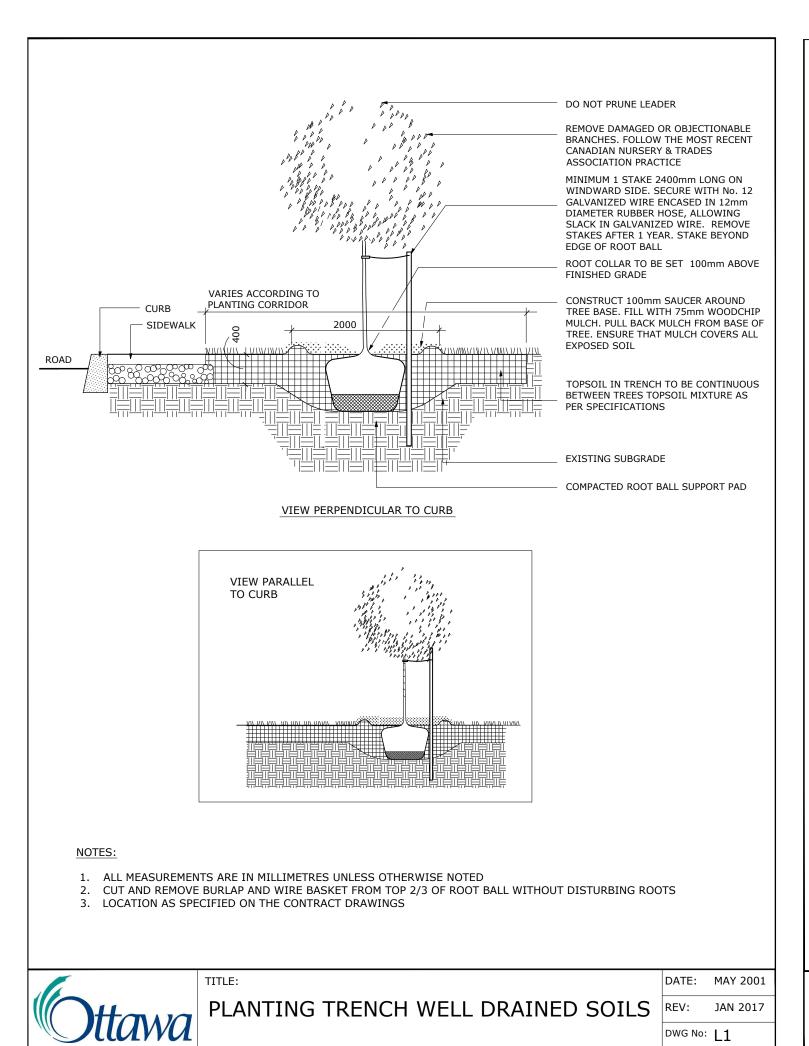

PERENNIAL AND ORNAMENTAL

GRASS PLANTING

DWG No: L21

TREE PLANTING TO CITY OF OTTAWA

PLANTING DETAIL L1/L-03

BACKFILL/ SUBGRADE

PLUS TREE SOIL VOLUME

ROOTBALL

SECTION AT STREET TREE PLANTING

Scale: NTS

NOTES

TREE SOIL VOLUME REQUIREMENTS: STANDARD TREE SOIL VOLUMES QUANTITIES INCLUDE THE TOP 900-1000mm OF SOIL/EXISTING SUBSOIL LAYER TO CALCULATE TOTAL SOIL VOLUMES REQUIRED BY CITY OF OTTAWA FOR SUSTAINABLE TREE GROWTH. WHERE LARGER SOFT AREAS ARE AVAILABLE, THE TOP 400-500mm LAYER IS USED TO CALCULATE SOIL VOLUMES (AS PER CITY DETAL L1).

WHERE EXISTING MATERIAL BELOW THE SPECIFIED IMPORTED TOPSOIL IS NOT CONDUCIVE TO TREE GROWTH, AN ADDITIONAL LAYER OF PLANTING MEDIUM IS TO BE INSTALLED BELOW SPECIFIED TOPSOIL DEPTH TO OBTAIN THE SOIL VOLUME DEPTH REQUIRED.

REFER TO SOIL VOLUME CHART AND PLANS FOR AREA WHERE TREE SOIL VOLUMES ARE REQUIRED.

PROJECT TEAM

ARCHITECT HOBIN ARCHITECTURE David Anderson danderson@hobinarc.com 613.238.7200 x122 Patrick Bisson pbisson@hobinarc.com 613.238.7200 x128

OWNERSHIP IRONWOOD FUND LIMITED PARTNERSHIP Kenneth Jennings kjennings@jenningsdevelopments.com 613-668-3459

PLANING FOTENN PLANNING + DESIGN Ghada Zaki zaki@fotenn.com 613.730.5709 ext. 226 Brian Casagrande casagrande@fotenn.com 613-730-5709 ext. 235

NOVATECH Francois Thauvette f.thauvette@novatech-eng.com 613.254.9643 Ext: 219

LANDSCAPE ARCHITECT RUHLAND & ASSOCIATES Marietta Ruhland

mruhland@rala.ca 613 224-4744 x 222

TRANSPORTATION

CGH TRANSPORTATION Andrew Harte andrew.harte@cghtransportation.com 343-999-9117

ENVIRONMENTAL **GRADIENT WIND** Justin Ferrarojustin.ferraro@gradientwind.com Vincent Ferrarovincent.ferraro@gradientwind.com

613 836 0934 x112 **GEOTHECHNICAL** PATERSONGROUP Faisal Abou-Seido

FAbou-Seido@Patersongroup.ca (613) 226-7381 Ext. 210 David Gilbert dgilbert@patersongroup.ca (613) 226-7381 Ext. 205

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issue / revision

north

Ruhland & Associates Ltd

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OTTAWA, ON


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SECTIONS / DETAILS

drawn by designed by J. K. / T.F. J.K. / M.R. checked by plot date JUNE 2021 2021 06 01 project number drawing number

Contractor to check and verify all dimensions on the job

L - 03

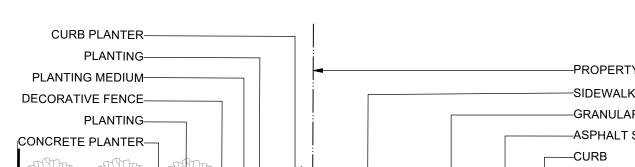

-PROPERTY LINE -SIDEWALK -GRANULAR -ASPHALT STRIP PRIVATE TERRACE SLAB BACKFILL/ SUBGRADE

SECTION EXTERIOR PATIO Scale: NTS

1. THE LEVELING COURSE (BEDDING SAND) SHALL BE PLACED LOOSE, IN A UNIFORM LAYER AT A MAXIMUM DEPTH OF 25mm TO ACHIEVE THE FINAL COMPACTED THICKNESS AND GRADE AS SPECIFIED

BRUSH CLEAN POLYMERIC JOINT SAND INTO JOINTS

UNLESS MANUFACTURER DOES NOT RECOMMEND IT

UNDISTURBED OR THOROUGHLY COMPACTED SUBGRADE

2. INSTALL SOLID EDGE RESTRAINT BETWEEN UNIT PAVERS AND ANY SOFT SURFACE (SOD, PLANTING BED, ETC.)

3. UNIT PAVERS ARE THEN PLACED ON TOP OF THE LEVELING COURSE AND ADDITIONAL SAND SWEPT BETWEEN THE UNIT PAVERS

4. THE UNIT PAVERS ARE THEN VIBRATED INTO PLACE WITH A VIBRA-PLATE AND WATER IS ADDED TO ASSIST IN THE SETTLING OF THE JOINT SAND

5. GRANULAR 'A' DEPTH TO BE 100mm FOR PEDESTRIAN AREAS AND 150mm FOR VEHICULAR ACCESSES. OR AS RECOMMENDED BY GEOTECHNICAL INVESTIGATION

6. USE OF THIS DETAIL REQUIRES THE PRIOR APPROVAL OF THE GENERAL MANAGER

UNIT PAVERS

COARSE SAND

(SEE NOTE 5)


25mm LEVELLING BED OF

GRANULAR 'A' (THICKNESS AS SPECIFIED) COMPACTED

TO 95% PROCTOR DENSITY

DATE: MAY 2001 UNIT PAVING - ON GRANULAR BASE REV: FEB 2016 DWG No: SC9

ADDITIONAL NOTES FOR NUMBER 5: PRECAST PAVERS IN VEHICULAR AREAS TO RECEIVE SAME BASE STRUCTURES FOR GRANULAR 'A' AND 'B' AS GEOTECHNICAL RECOMMENDATIONS FOR HEAVY DUTY PAVEMENT. PEDESTRIAN AREAS ARE TO RECEIVE 200mm COMPACTED GRANULAR 'A' MINIMUM, ADJUSTMENTS TO BE SPECIFIED IN RELATION TO SITE CONDITIONS AND GEOTECHNICAL RECOMMENDATIONS.

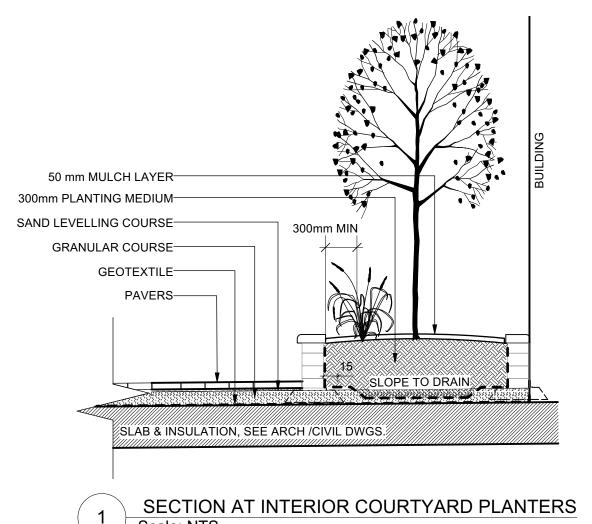

Scale: NTS

