


1 TREE CONSERVATION PLAN
TC1 1:400

4 TREE PROTECTION SPECIFICATION

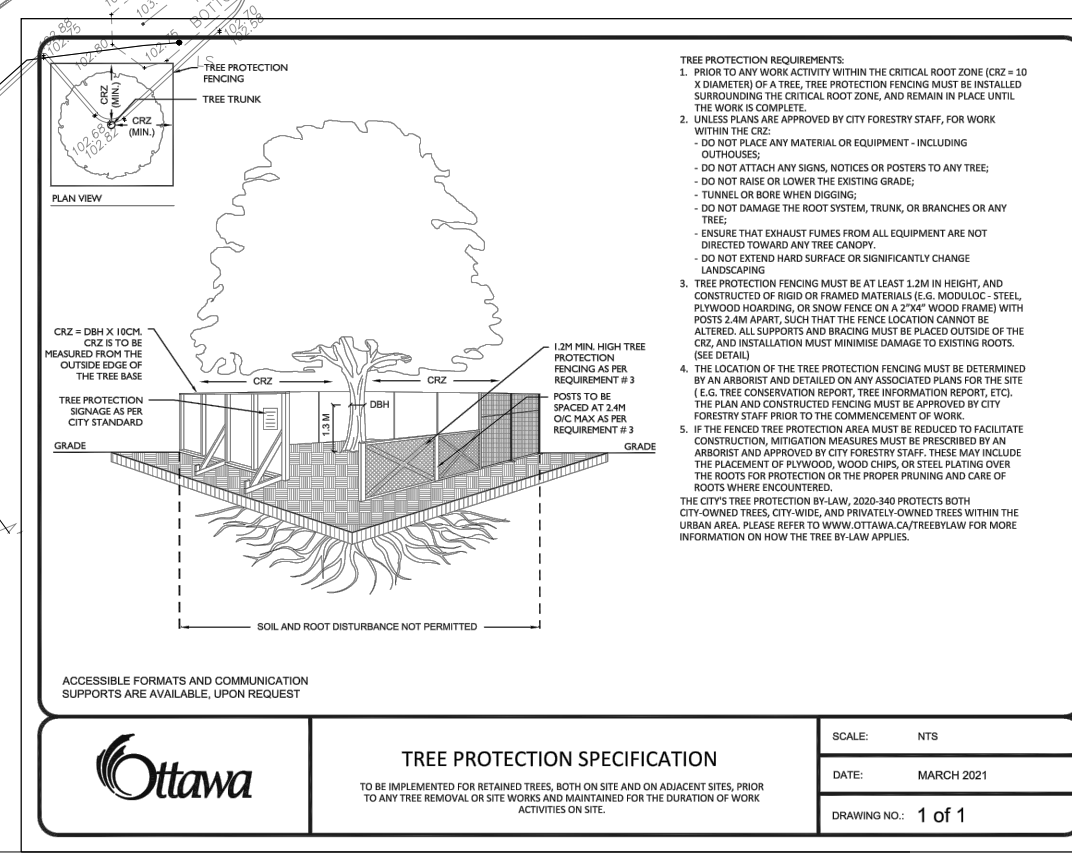


Tree #	Common Name	Scientific Name	Diameter at Breast Height (DBH)	Trunk Integrity	Crown Structure	Crown Vigour	Crown Dieback	Minimum Tree Protection Zone	Action	Ownership	Tree #	Common Name	Scientific Name	Diameter at Breast Height (DBH)	Trunk Integrity	Crown Structure	Crown Vigour	Crown Dieback	Minimum Tree Protection Zone	Action	Ownership
1	Honey Locust	Gleditsia triacanthos	6	P	P	P	95	NA	Preserve	City	21	Honey Locust	Gleditsia triacanthos	50	G	G	G	100	1.8	Preserve	City
2	Honey Locust	Gleditsia triacanthos	6	P	P	P	100	NA	Preserve	City	22	Honey Locust	Gleditsia triacanthos	50	G	G	G	100	1.8	Preserve	City
3	Honey Locust	Gleditsia triacanthos	6	P	P	P	100	NA	Preserve	City	23	Honey Locust	Gleditsia triacanthos	50	P	P	P	80	1.8	Preserve	City
4	Honey Locust	Gleditsia triacanthos	6	P	P	P	100	NA	Preserve	City	24	Small-leaved Linden	Tilia cordata	60	G	G	G	100	1.8	Preserve	City
5	White Spruce	Picea glauca	2.5m Ht	G	G	G	0	1.8	Preserve	Private	25	Small-leaved Linden	Tilia cordata	60	G	G	G	100	1.8	Preserve	City
6	White Spruce	Picea glauca	2.5m Ht	G	G	G	0	1.8	Preserve	Private	26	Small-leaved Linden	Tilia cordata	60	G	G	G	100	1.8	Preserve	City
7	Red Oak	Quercus rubra	70	G	G	G	0	1.8	Preserve	Private	27	Red Oak	Quercus rubra	50	G	G	F	90	1.8	Preserve	City
8	Red Oak	Quercus rubra	70	FG	G	G	0	1.8	Preserve	Private	28	Red Oak	Quercus rubra	60	G	G	G	100	1.8	Preserve	City
9	Red Oak	Quercus rubra	70	G	G	G	0	1.8	Preserve	Private	29	Red Oak	Quercus rubra	60	G	G	G	100	1.8	Preserve	City
10	Common Hackberry	Celtis occidentalis	70	G	G	G	0	1.8	Preserve	Private	30	Red Oak	Quercus rubra	60	G	G	G	100	1.8	Preserve	City
11	Common Hackberry	Celtis occidentalis	70	G	G	G	0	1.8	Preserve	Private	31	Small-leaved Linden	Tilia cordata	50	G	G	G	100	1.8	Preserve	City
12	White Spruce	Picea glauca	2.5m Ht	G	G	G	10	1.8	Preserve	Private	32	Small-leaved Linden	Tilia cordata	50	G	G	F	80	1.8	Preserve	City
13	White Spruce	Picea glauca	2.5m Ht	G	G	G	0	1.8	Preserve	Private	33	Small-leaved Linden	Tilia cordata	50	G	G	F	80	1.8	Preserve	City
14	pine	Pinus	2.5m Ht	G	G	G	0	1.8	Preserve	Private	34	Pine	Pinus	2.5m Ht	G	G	G	100	1.8	Remove	Private
15	Red Oak	Quercus rubra	90	G	G	G	0	1.8	Preserve	Private	35	White Spruce	Picea glauca	2.0m Ht	G	G	G	100	1.8	Preserve	Private
16	Red Oak	Quercus rubra	90	G	G	G	0	1.8	Preserve	Private	36	Balsam fir	Abies balsamea	3.0m Ht	G	G	G	100	1.8	Preserve	Private
17	Red Oak	Quercus rubra	90	G	F	F	0	1.8	Preserve	Private	37	Balsam fir	Abies balsamea	3.0m Ht	G	G	G	100	1.8	Preserve	Private
18	Red Oak	Quercus rubra	90	G	G	G	0	1.8	Preserve	Private	38	Balsam fir	Abies balsamea	2.5m Ht	G	G	G	100	1.8	Preserve	Private
19	Small-leaved Linden	Tilia cordata	70	G	G	G	0	1.8	Preserve	City											

2 EXISTING TREE INVENTORY SCHEDULE



2 EXISTING TREE IMAGES

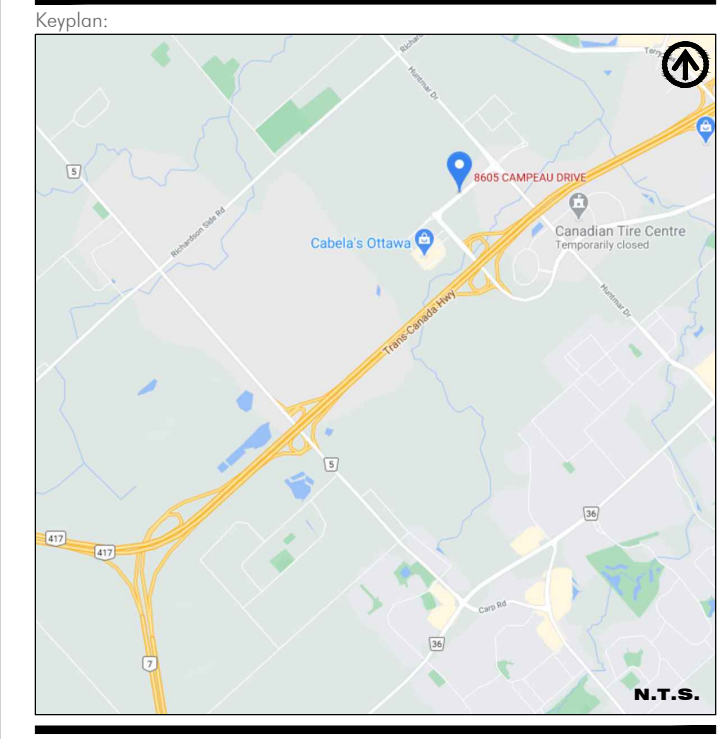

We have relied upon the accuracy and completeness of base & background information provided by the following Consultants in preparing this drawing and performing our professional services.

We are under no obligation or duty to verify the accuracy and/or completeness of this information and have not done so. We shall not be held responsible for any errors or omissions that may arise or be incorporated as a result of erroneous or incomplete information provided by the Client, Consultants and Contractors.

- LEGEND
- XX EXISTING TREE TO BE PRESERVED
 - XX EXISTING TREE TO BE REMOVED
 - PROPOSED TREE HOARDING

3	230330	REVISED PER REV. SERVING PLAN	YY
2	230322	REVISED PER REV. SITE PLAN	YY
1	221215	REVISED PER CITY'S COMMENTS	SX

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Project Info:
SITE DEVELOPMENT
8605 CAMPEAU DRIVE, STITTSVILLE, ON

Client Info:
PETRO CANADA
Suncor Energy Group
OUTLET #10565

Sheet Title:
TREE CONSERVATION PLAN

Project Number: 1504
Drawn By: SX
Checked By: SP
Date: DECEMBER 2020
Scale: AS NOTED

Sheet Number:
TC1

