


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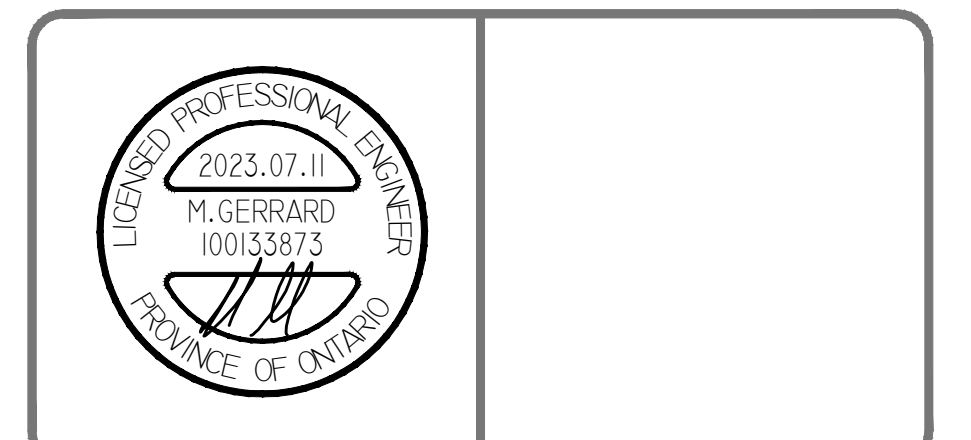
Authorized modifications must be signed and sealed by an engineer and this engineer will be completely responsible for these modifications. J.R.P. Engineering is not and will not be responsible for the consequences of these modifications or for modifications carried out without its consent.

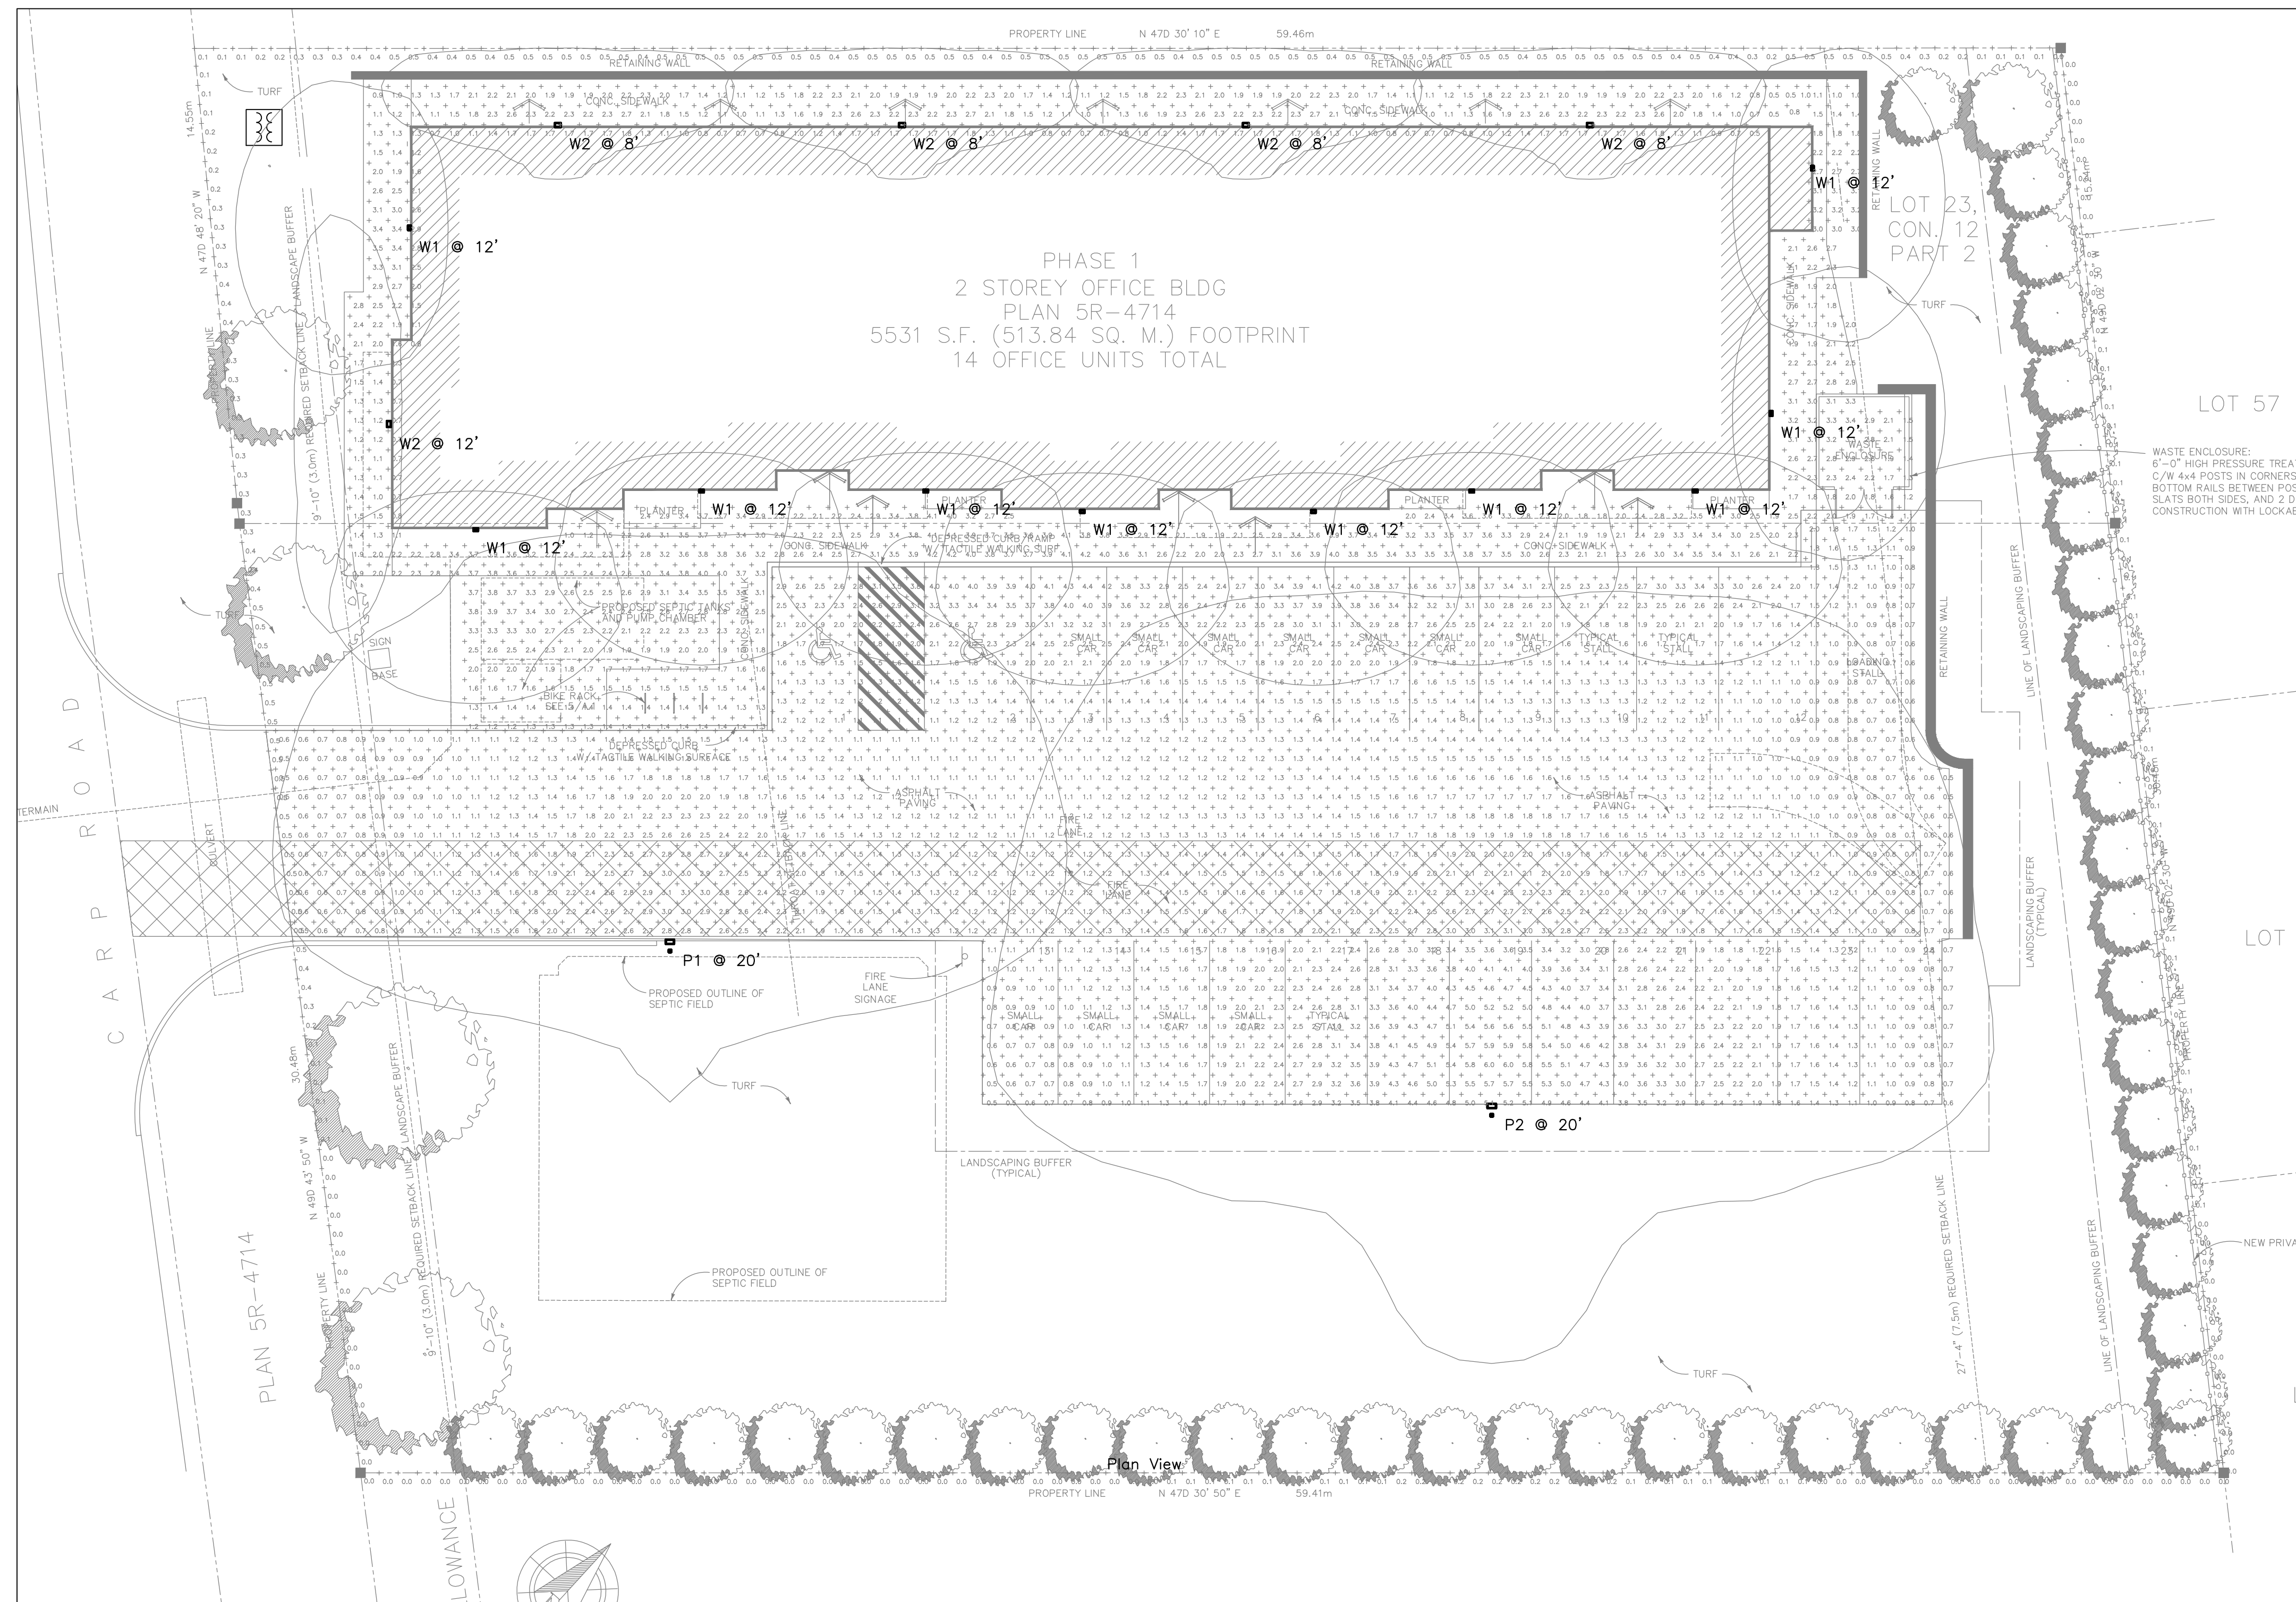

1 SITE LIGHTING PLAN
SP-E1 3/32" = 1' 0"

LIGHTING FIXTURE SCHEDULE						
TYPE	MAKE/MODEL	VOLTAGE	MOUNT	WATTAGE	TEMPERATURE	NOTES
P1	LITHONIA LIGHTING RSX1 LED P1 30K R4	120V	POLE	52	3000K	ALL LIGHTING TO BE TIED INTO COMMON PHOTOCELL
P2	LITHONIA LIGHTING RSX1 LED P3 30K R4	120V	POLE	110	3000K	
W1	LITHONIA LIGHTING WDGE1 LED P1 30K 80CRI VW	120V	WALL PACK	10	3000K	
W2	LITHONIA LIGHTING WDGE2 LED P0 30K 70CRI T1S	120V	WALL PACK	7	3000K	

No	DESCRIPTION	DATE
1	ISSUED FOR SITE PLAN APPLICATION	JULY 11 2023
0	ISSUED FOR REVIEW	DEC 23 2021



client:

project:
TWO STORY OFFICE BUILDING

1037 CARP ROAD
OTTAWA, ONTARIO

drawing title:
ELECTRICAL SITE LIGHTING PLAN

scale:	AS NOTED	drawn by:	C.M.
designed by:	C.M.	reviewed by:	M.G.
approved by:	M.G.	date:	DEC 2022

project no.: 100-2302
drawing no.: SP-E1
of 1