

GENERAL NOTES:


- 1. THE ELECTRICAL CONTRACTOR SHALL MAKE ARRANGEMENTS FOR A SITE MEETING WITH THE GENERAL CONTRACTOR AND HYDRO OTTAWA PRIOR TO INSTALLATION OF BUILDING POWER SUPPLY INFRASTRUCTURE. THE PURPOSE OF THE MEETING IS TO COORDINATE THE WORK, REVIEW THE RESPONSIBILITIES OF HYDRO OTTAWA, THE GENERAL CONTRACTOR AND THE ELECTRICAL CONTRACTOR TO ENSURE THAT THE INSTALLATION OF THE TRANSFORMER AND CABLE DUCTS ADHERE TO HYDRO OTTAWA SPECIFICATIONS.
- COORDINATE UNDERGROUND SERVICES WITH ALL OTHER TRADES PRIOR TO COMMENCEMENT OF WORK.
- 3. GROUNDING FOR PAD MOUNTED TRANSFORMER SHALL BE BY ELECTRICAL CONTRACTOR. GROUNDING SHALL BE AS PER HYDRO OTTAWA STANDARDS, THE ONTARIO ELECTRICAL SAFETY CODE AND SHALL BE APPROVED BY THE ELECTRICAL SAFETY AUTHORITY. ARRANGE GROUNDING TEST WITH HYDRO OTTAWA INSPECTOR. GROUNDING RESISTANCE SHALL BE A MAXIMUM OF 250HMS BEFORE ENERGIZATION OF THE SERVICE SHALL TAKE PLACE.
- 4. CONTRACTOR SHALL CONFIRM EXACT RUN OF ALL SITE SERVICES AND MARK RECORD DRAWINGS WITH DIMENSIONS TO REFLECT AS BUILT CONDITIONS.
- 5. CONTRACTOR IS TO PROVIDE PULL BOXES FOR ALL SITE WIRING TO COMPLY TO ONTARIO ELECTRICAL SAFETY CODE, LATEST EDITION. MARK RECORD DRAWINGS WITH DIMENSIONED LOCATION AND SIZE OF PULL BOXES.
- 6. CONDUCTOR SIZE FOR SITE LIGHTING TO BE MINIMUM #10 AWG. ALL LIGHTING CONDUITS SHALL BE MINIMUM 2" PVC TYPE DB-2.

DRAWING NOTES:


- 1) NEW CUSTOMER OWNED MINISUB SIZE AS SHOWN. PROVIDE 2200mm X 3900mm USI PRECAST BASE AND PAD WITH MANHOLE FOR TRANSFORMER. PROVIDE PRIMARY GROUND AS PER HYDRO OTTAWA DETAIL UGS0002 AND PROTECTIVE BOLLARDS AS PER HYDRO OTTAWA DETAIL UFS0001 AND BOND TO GROUND GRID. COORDINATE WORK WITH HYDRO OTTAWA AND INSPECTION AUTHORITY.
- 2 PROVIDE 19.8m (65'-0") CLASS 1 WOOD POLE AND 200A LOAD BREAK 3-PÓLE GANG OPERATED SWITCH WITH 150A FUSES. PROVIDE GROUNDING AND CABLE GUARDS AS PER SPECIFICATIONS AND AS OESC REQUIREMENTS.
- 3 PROVIDE #2/0 ACSR OVERHEAD 27KV CONDUCTORS FROM HYDRO POLE TO ACROSS BANK STREET TO PRIVATELY OWNED POLE ON PROPERTY AS SHOWN.
- 4 APPROXIMATE LOCATION OF HYDRO OTTAWA HIGH VOLTAGE POWER POLE AND GUY WIRES.
- (5) PROVIDE GUY WIRE ANCHOR AND GUY WIRE, AT LEAST 1/3 OF POLE HEIGHT ABOVE GRADE AS PER OESC REQUIREMENTS.
- 6 PROVIDE 3X(1C, 2/0 COPPER XLPO 27KV, 90°C WITH 33% CONCENTRIC NEUTRAL) IN DUCT BANK, ONE CABLE PER DUCT FROM CUSTOMER OWNED POLE TO TRANSFORMERS AS SHOWN.
- (7) RUN SECONDARY UNDERGROUND FEEDER TO BUILDING 'A' UTILITY ROOM IN LEVEL 1 PARKING GARAGE.
- 8 RUN SECONDARY FEEDER TO BUILDING 'B' UTILITY ROOM IN LEVEL 1 PARKING GARAGE.

DRAWING NOTES (CONT'D):

- (9) RUN SECONDARY UNDERGROUND FEEDER FROM BUILDING 'A' SWITCHBOARD TO EXISTING BUILDING ELECTRICAL
- 10) RUN SECONDARY UNDERGROUND FEEDER TO BUILDING 'C' UTILITY ROOM IN LEVEL 1 PARKING GARAGE.
- (1) TERMINATE AND CAP BELL AND ROGERS UNDERGROUND DUCT BANK AT THE PROPERTY LINE RUNNING FROM MAIN TELECOM ROOM.

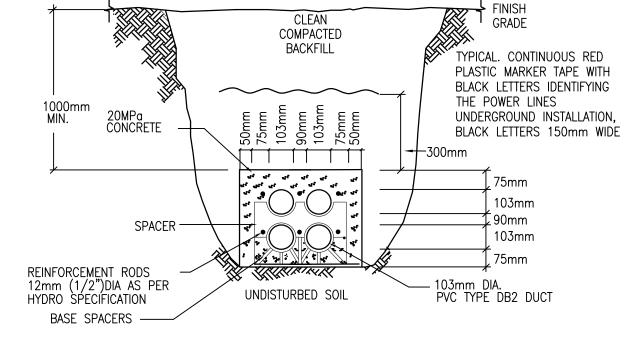

TRENCH DETAIL -\4 CELL CONCRETE ENCASED $\backslash E-010B/$ N.T.S.

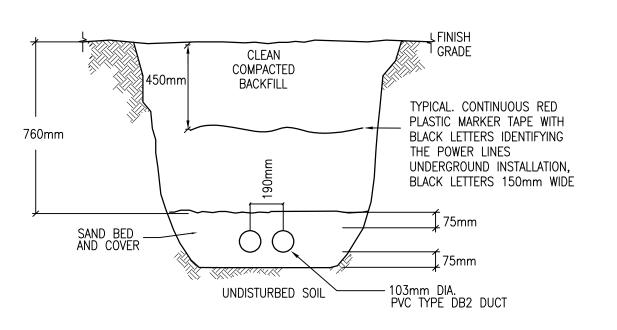

3 TRENCH DETAIL - 2 CELL \E-010B/ N.T.S.

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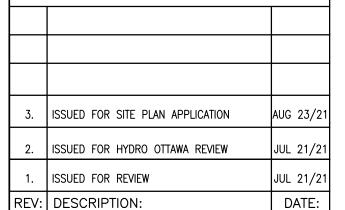
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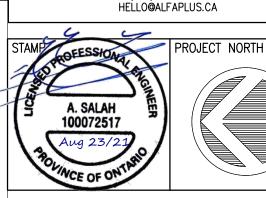
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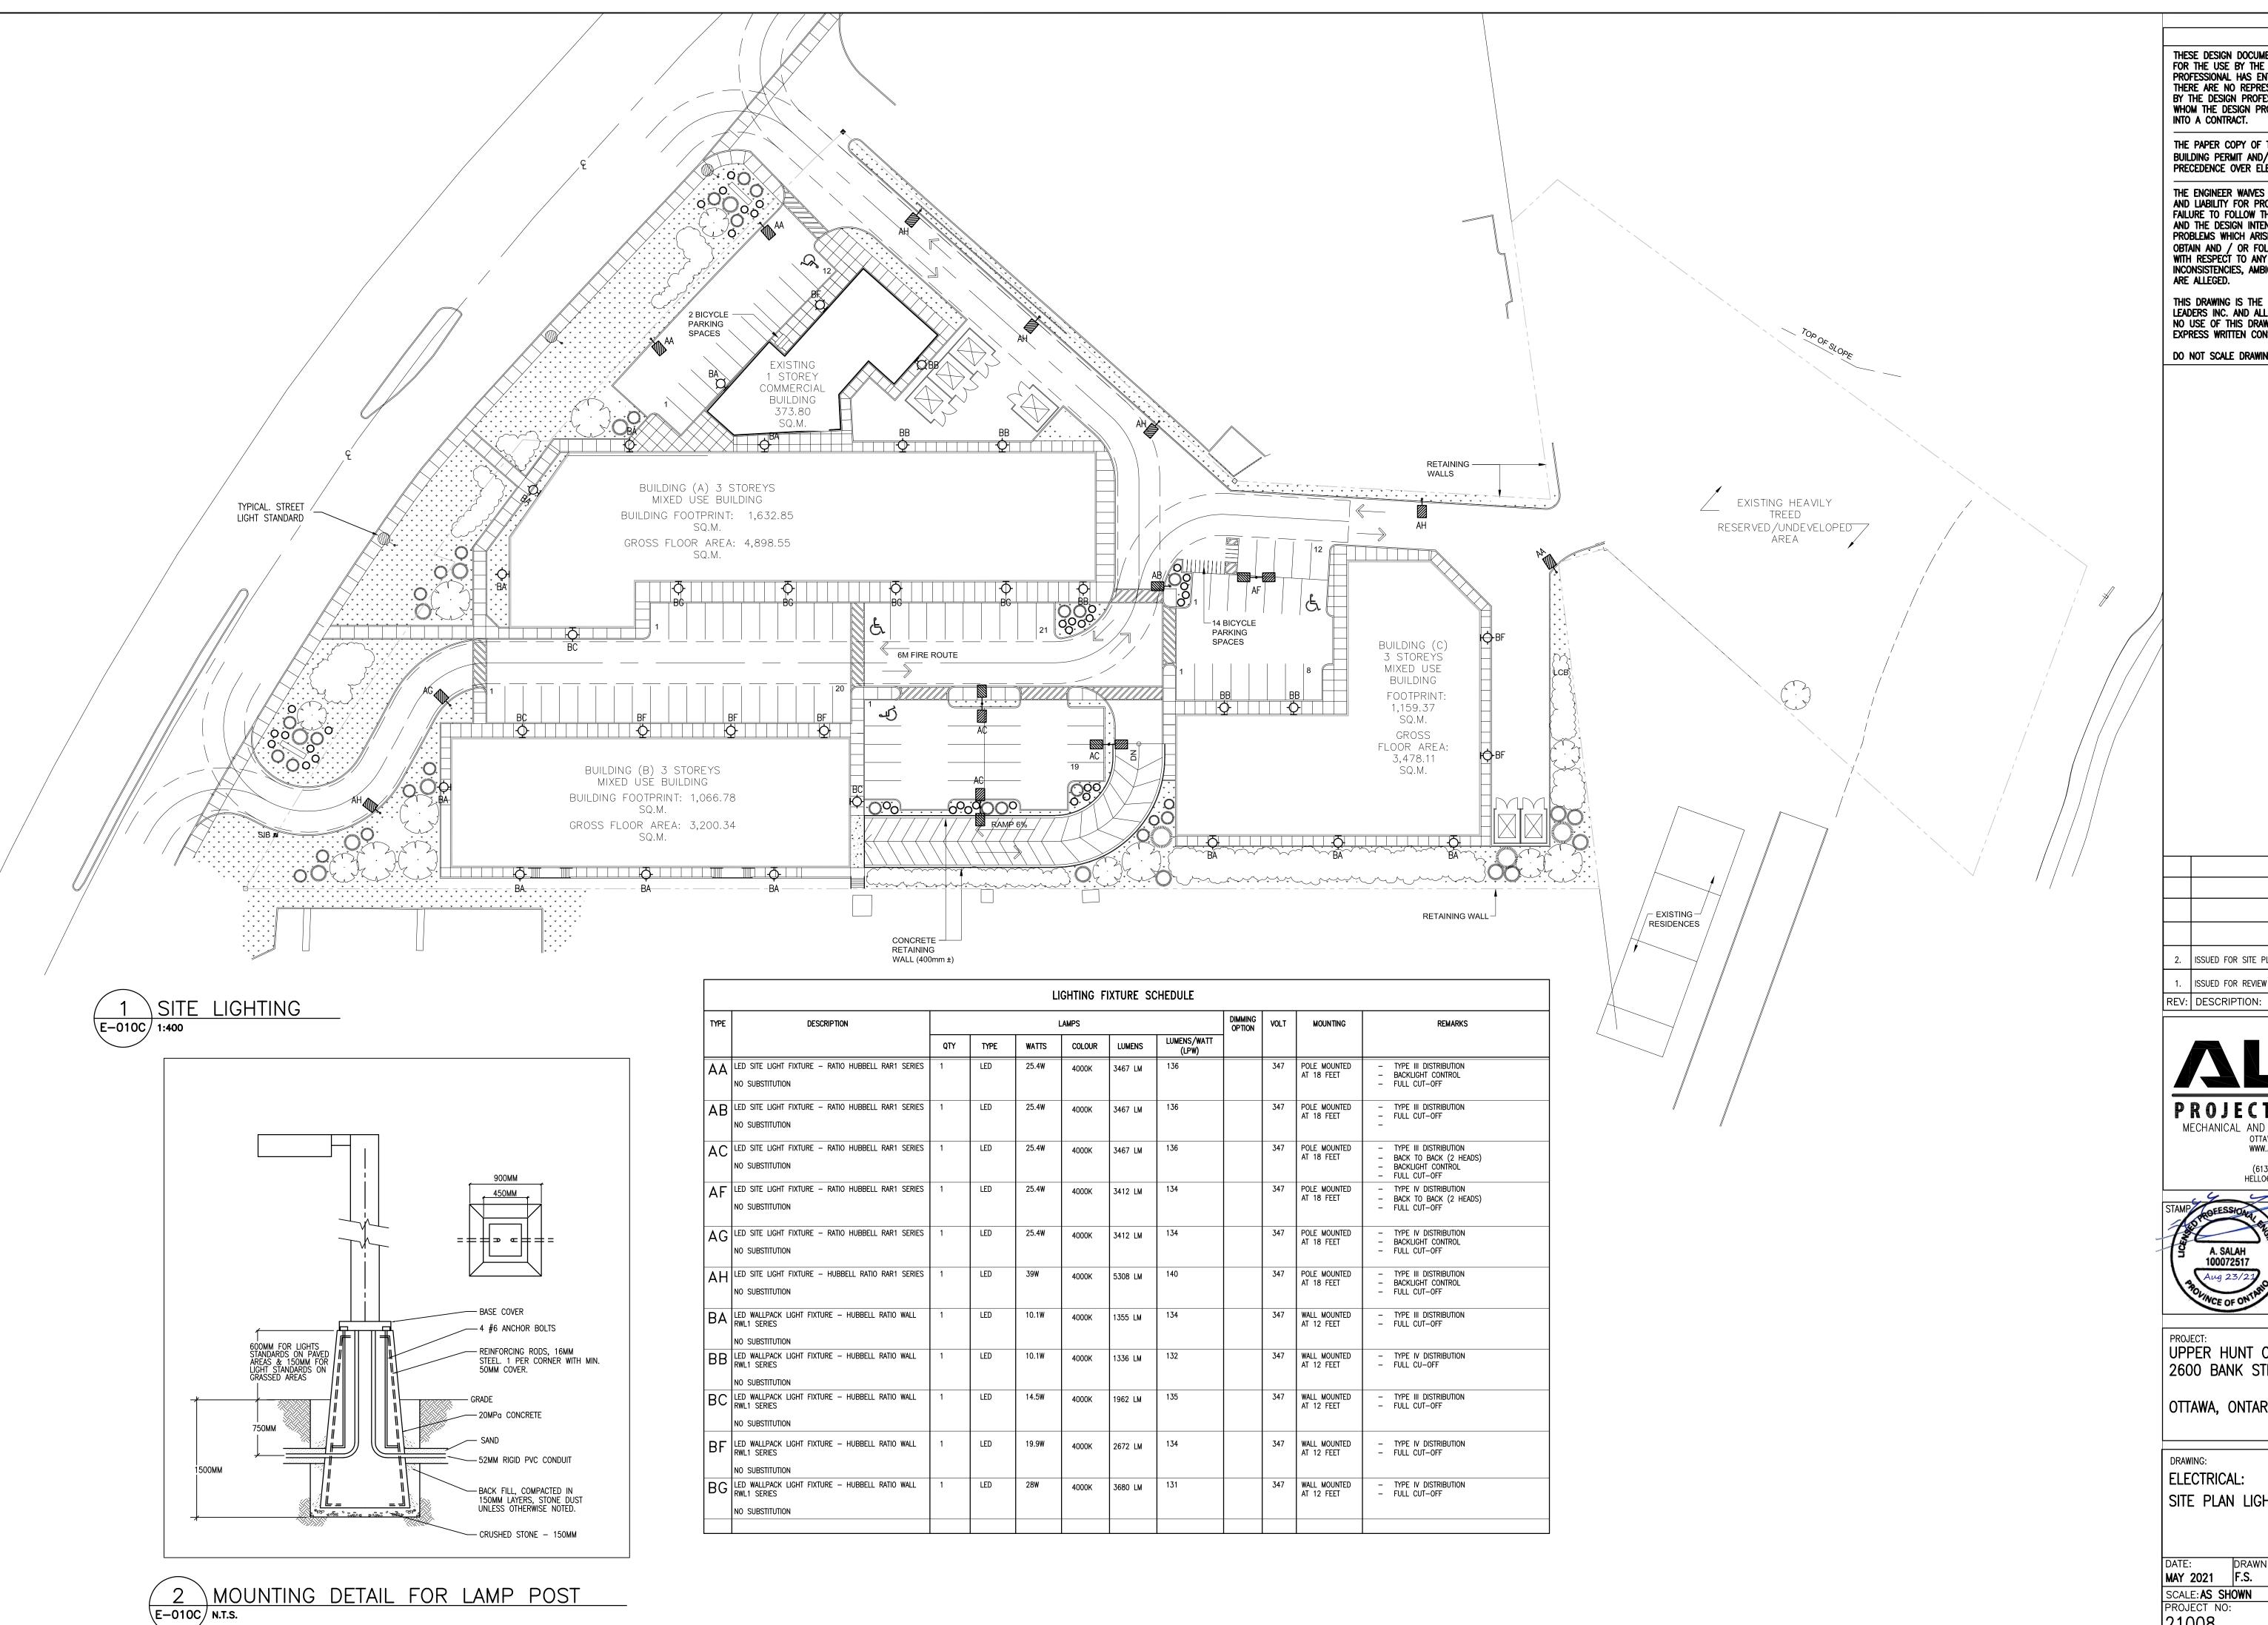
UPPER HUNT CLUB CENTRE 2600 BANK STREET

OTTAWA, ONTARIO

DRAWING: ELECTRICAL:

| SITE PLAN SERVICES - NEW

DATE:		DESIGNED:	
MAY 2021	F.S.	F.S./A.S.	A.S.
SCALE: AS SHOWN		DRAWING NO:	
PROJECT NO:		 = _010)R



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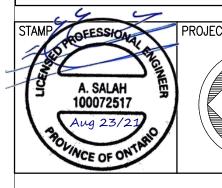
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2.	ISSUED FOR SITE PLAN APPLICATION	AUG 23/21
1.	ISSUED FOR REVIEW	JUL 21/21
REV:	DESCRIPTION:	DATE:



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UPPER HUNT CLUB CENTRE 2600 BANK STREET

OTTAWA, ONTARIO

DRAWING: ELECTRICAL:

SITE PLAN LIGHTING — NEW

DRAWN: DESIGNED: CHECKED: F.S./A.S. A.S. MAY 2021 SCALE: AS SHOWN DRAWING NO: E-010C 21008