

ELECTRICAL LEGEND

'вв–1' Q	WALL MOUNTED FIXTURE, LETTER DENOTES TYPE.
DD-1 O	DOWNLIGHT FIXTURE.
'1-AA1' 睅	NEW/RELOCATED EXTERIOR LIGHT STANDARD FIXTURE. LETTER DENOTES TYPE.
'1-AA1' 🗐	EXISTING TO REMAIN EXTERIOR LIGHT STANDARD FIXTURE. LETTER DENOTES TYPE.
	U/G RACEWAY FOR POWER SERVICES.
ЮHH	PRECAST HANDHOLE.
	ROUND PRECAST BOLLARD C/W BACK-TO-BACK 5-20R, GFI, WP RECEPTACLES.
×	JUNCTION BOX.
₩_	TRANSFORMER (RATED AS SHOWN).
۵	DISCONNECT SWITCH.
(M)	UTILITY METER BASE (PROVIDED BY HYDRO ONE AND INSTALLED BY THIS CONTRACTOR).

U/G RACEWAY FOR COMMUNICATION SERVICES.

ADDIVE	MATIONS.
HT	HEIGHT
GFI	 GROUND FAULT INTERRUPTER
WP	WEATHER PROOF
J.O.N.	 UNLESS OTHERWISE NOTED
N.T.S	- NOT TO SCALE
N.I.C.	NOT IN CONTRACT

POW - POWER SERVICES COMMS - COMMUNICATION SERVICES AFF - ABOVE FINISHED FLOOR DENOTES EXISTING ITEM TO BE RELOCATED IN NEW POSITION / RL 🔪

ELECTRICAL DRAWING LIST

DRAWING No. DESCRIPTION | ELECTRICAL: LEGEND, DRAWING LIST AND SITE PLAN ELECTRICAL: MCDONALD'S DRIVE-THRU AND IRRIGATION CONDUITS, DETAILS AND SCHEDULES ELECTRICAL: DETAILS AND SINGLE LINE DIAGRAMS

GENERAL NOTES

- ROUTING OF THE INCOMING BURIED SERVICES IS A PROPOSED DIAGRAMMATIC ROUTING. COORDINATE WITH CIVIL DRAWINGS, LANDSCAPE DRAWINGS, AND HYDRO ONE ON SITE PRIOR TO COMMENCING WORK TO FINALIZE ROUTING.
- THE UTILITY CONTRACTOR SHALL MAKE ARRANGEMENTS FOR A SITE MEETING WITH THE GENERAL CONTRACTOR, HYDRO ONE AND THE ELECTRICAL CONTRACTOR PRIOR TO INSTALLATION OF BUILDING POWER SUPPLY INFRASTRUCTURE. THE PURPOSE OF THE MEETING IS TO COORDINATE THE WORK, REVIEW THE RESPONSIBILITIES OF HYDRO ONE THE GENERAL CONTRACTOR, THE UTILITY CONTRACTOR AND THE ELECTRICAL CONTRACTOR TO ENSURE THAT THE INSTALLATION OF THE TRANSFORMER AND CABLE DUCTS ADHERE TO HYDRO ONE SPECIFICATIONS AND ESA REQUIREMENTS.
- 3. SITE CONDUITS FOR LIGHTING AND RECEPTACLES ARE NOT SHOWN. UTILITY AND ELECTRICAL CONTRACTORS ARE TO PROVIDE LAYOUT AND COORDINATE.
- 4. PROVIDE MINIMUM #8 AWG CONDUCTOR SIZE FOR SITE LIGHTING. ALL LIGHTING CONDUITS SHALL BE MINIMUM 53mm RIGID PVC.
- 5. SIZE RECEPTACLE CONDUCTORS FOR VOLTAGE DROP AT 80% CIRCUIT LOADING AND
- PROVIDE A MINIMUM WIRE SIZE OF #10 AWG. . ALL LIGHTING CIRCUITS ARE FED FROM PANEL A U.O.N. LOCATED IN RETAIL 'A' MAIN
- 7. CIRCUITS SHOWN FOR EXISTING LIGHTING STANDARDS ARE BASED ON EXISTING
- DRAWINGS AND PANEL SCHEDULES AND ARE FOR REFERENCE ONLY. 8. PROVIDE 53MM DUCT CONNECTING ALL LIGHT STANDARDS WITHIN MCDONALD'S SCOPE

DRAWING NOTES

Food Store Loading Dock + 3.0 fc 5.7 fc 1.7 fc 3.4:1 1.8:1

Off Property

+ 0.1 fc 0.5 fc 0.0 fc N/A N/A

- EXISTING HYDRO POLE. PROVIDE FOUR PVC CONDUITS AND CABLE GUARDS AS PER HYDRO ONE DETAIL DU-08-302.1 TERMINATE CONCRETE ENCLOSED DUCT BANK 1.5M FROM POLE. PROVIDE 2/0 ALUMINUM CONCENTRIC NEUTRAL 28kV CABLES FROM PADMOUNT TRANSFORMER TO POLE. COIL 20m OF PRIMARY CABLES AT POLE; HYDRO ONE SHALL CONNECT PRIMARY CABLES TO 27.6kV LINE AT POLE.
- 2 PROVIDE PRECAST BASE AND PAD FOR NEW HYDRO OWNED 500kVA TRANSFORMER. REFER TO HYDRO ONE DETAIL DU-09-202. PROVIDE PRIMARY GROUNDING AND BOLLARDS AS PER HYDRO ONE STANDARDS. REFER TO DETAILS DU-03-212 AND DU-14-101. COORDINATE WORK WITH HYDRO ONE AND INSPECTION AUTHORITY.
- 3 PROVIDE HANDHOLE TO INTERCEPT EXISTING LIGHTING AND PYLON SIGN CIRCUITS WITHIN EXISTING BELOW GRADE DUCT. PROVIDE NEW DUCT AND EXTEND CIRCUITS AS SHOWN TO CONNECT NEW LIGHT AND SIGN.
- 4 PROVIDE HANDHOLE TO INTERCEPT LIGHTING CIRCUIT WITHIN EXISTING BELOW GRADE DUCT. PROVIDE NEW WIRING AND DUCT TO CONNECT NEW/RELOCATED PARKING LOT FIXTURES AS INDICATED.
- 5 VENTILATED WEATHERPROOF CABINET MOUNTED ON POLE. REFER TO DETAILS.
- 6 LOCATION OF 3x75kVA POLE MOUNTED TRANSFORMERS BY HYDRO ONE ON EXISTING HYDRO POLE. TERMINATE DUCT BANK 1.5m FROM POLE. PROVIDE 103mm RIGID PVC DUCT FROM POLE BASE TO TRANSFORMER, PROVIDE WEATHERHEAD TO SUIT.
- MOUNT 5-20R, WP, GFI RECEPTACLES FOR SEASONAL DECORATIONS ON ARLINGTON INDUSTRIES GP19B-1 GARD-N POST. EXACT LOCATIONS TO BE COORDINATED WITH LANDSCAPE CONTRACTOR ONSITE.
- (8) PROVIDE HANDHOLE TO INTERCEPT BANK "DO NOT ENTER" SIGN CIRCUIT. PROVIDE NEW WIRING FROM BANK ELECTRICAL ROOM AND DUCT TO CONNECT RELOCATED SIGN AS INDICATED. TRACE 120V CIRCUIT PRIOR TO RELOCATING. REMOVE REDUNDANT WIRING BACK TO SOURCE AND ABANDON REDUNDANT DUCT. COORDINATE ACCESS TO ELECTRICAL ROOM WITH BGIS.
- 9 WORK SHOWN WITHIN THIS BORDER IS TO BE PRICED UNDER MCDONALD'S FORM OF

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3.	ISSUED FOR 60% REVIEW	NOV 18/21
2.	ISSUED FOR SPA CONTROL	OCT 29/21
1.	ISSUED FOR SPA REVIEW	OCT 14/21
REVISION	DESCRIPTION	DATE



Fax.:(613) 723-9584 www.mckeeottawa.ca 900 WATTERS ROAD

Tel.:(613) 723-9585

CROWN POINTE - PHASE 3

ELECTRICAL: LEGEND, DRAWING LIST AND SITE PLAN




OCTOBER 2021 DESIGNED BY: N.H. DRAWN BY: **N.H.** CHECKED BY: G.O.M.

SCALE: AS SHOWN NCE OF O

No. DWGS. 3 PROJECT No.

DRAWING No.

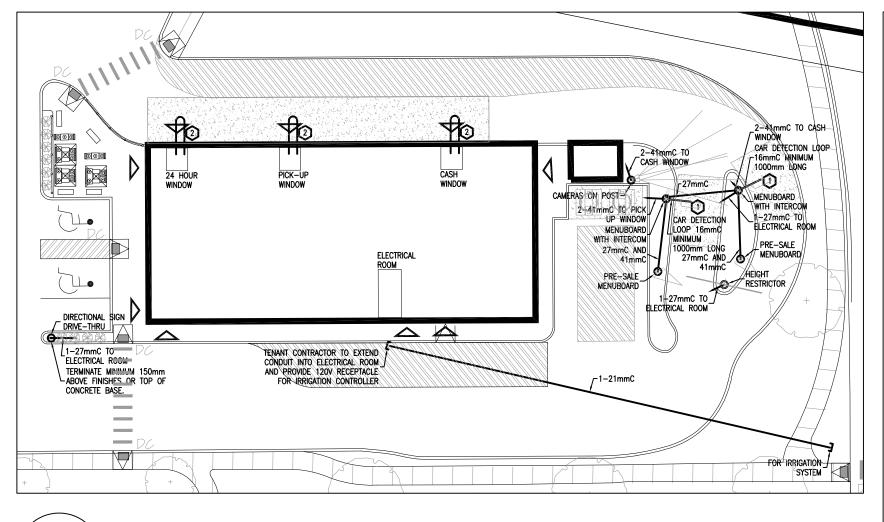

MCDONALD'S DRIVE-THRU AND IRRIGATION CONDUITS SP-E02

24 CIRCUITS 347/600 V	3 F	РΗ	4 w	22	5 MAI	NS	SL	JRFACE MOUNTED
DESCRIPTION	BR	CIR	A	В	Ç	CIF	BR	DESCRIPTION
PYLON SIGN	20	1				2	20	GOOSE NECK LIGHTS
PARKING LOT LIGHTS	20	3	•			4	20	GOOSE NECK LIGHTS
PARKING LOT LIGHTS	20	5		Ψ		6	20	GOOSE NECK LIGHTS
PARKING LOT LIGHTS	20	7			Ψ	8	20	SPARE (OFF)
PARKING LOT LIGHTS	20	9	•			10	20	WALL PACKS
PYLON SIGN	20	11		Ψ		12	2	SPACE
PARKING LOT LIGHTS	20	13				14	. 20	WALL PACKS
PARKING LOT LIGHTS	20	15	۳			16	5	SPACE
PARKING LOT LIGHTS	20	17		Ψ		18	20	BUILDING D GOOSE NECK LT
PARKING LOT LIGHTS	20	19			Ψ	20	20	BUILDING D GOOSE NECK LT
PARKING LOT LIGHTS	20	21	•			22	20	BUILDING D WALL PACKS
SPACE		23		Ψ		24	20	BUILDING D WALL PACKS


GENERAL NOTES

1. WORK SHOWN ON LAYOUT 1/SP-E02 IS TO BE PRICED UNDER MCDONALD'S FORM OF TENDER.

DRAWING NOTES


- PROVIDE CONDUIT FOR CAR DETECTION LOOP. CAR DETECTION LOOP SUPPLIED BY McDONALD'S, INSTALLED BY ELECTRICAL CONTRACTOR AS PER MANUFACTURER'S RECOMMENDATIONS.
- 2 CAR DETECTION LOOP SUPPLIED BY MCDONALD'S, INSTALLED BY ELECTRICAL CONTRACTOR AS PER MANUFACTURER'S RECOMMENDATIONS. RUN LOOP WIRES THROUGH CONDUIT SLEEVE IN FOUNDATION, SLEEVE PROVIDED BY OTHERS.

EXTERIOR LIGHTING FIXTURE SCHEDULE								
TYPE	DESCRIPTION	LAMPS	LED DIMMING DRIVER	DIMMING RANGE	VOLT	MOUNTING	REMARKS	
1-AA1	POLE MOUNTED FIXTURE, CREE NOCTURA SERIES.	230W LED			347	SQUARE STEEL POLE 5.5m ABOVE GRADE	- 35000 LUMENS, 4000K, 70 CRI, TYPE III DISTRIBUTION - FULL CUT-OFF, BRONZE FINISH - C/W BACK LIGHT SHIELDING - MOUNTING HEIGHT INCLUDES HEIGHT OF BASE	
1-AA2	POLE MOUNTED FIXTURE, CREE NOCTURA SERIES.	230W LED			347	SQUARE STEEL POLE 5.5m ABOVE GRADE	- 35000 LUMENS, 4000K, 70 CRI, TYPE IV DISTRIBUTION - FULL CUT-OFF, BRONZE FINISH - MOUNTING HEIGHT INCLUDES HEIGHT OF BASE	
1-AA3	POLE MOUNTED FIXTURE, CREE NOCTURA SERIES.	230W LED			347	SQUARE STEEL POLE 5.5m ABOVE GRADE	- 35000 LUMENS, 4000K, 70 CRI, TYPE IV DISTRIBUTION - C/W BACK LIGHT SHIELDING - FULL CUT-OFF, BRONZE FINISH - MOUNTING HEIGHT INCLUDES HEIGHT OF BASE	
1-AA4	POLE MOUNTED FIXTURE, CREE NOCTURA SERIES.	75W LED			347	SQUARE STEEL POLE 11.1m ABOVE GRADE	- 11000 LUMENS, 4000K, 70 CRI, TYPE III DISTRIBUTION - FULL CUT-OFF, BRONZE FINISH - MOUNTING HEIGHT INCLUDES HEIGHT OF BASE	
1-AA5	POLE MOUNTED FIXTURE, CREE NOCTURA SERIES.	230W LED			347	SQUARE STEEL POLE 11.1m ABOVE GRADE	- 35000 LUMENS, 4000K, 70 CRI, TYPE IV DISTRIBUTION - FULL CUT-OFF, BRONZE FINISH - MOUNTING HEIGHT INCLUDES HEIGHT OF BASE	
BB-1	BUILDING MOUNTED WALL PACK, CREE EDGE SERIES.	25W LED			120	EXTERIOR WALL 3.35m AFF	- 2500 LUMENS, 4000K, 70 CRI, TYPE II MEDIUM DISTRIBUTION - BLACK FINISH - SUPPLIED AND INSTALLED BY OTHERS, SHOWN FOR REFERENCE ONLY	
BB-2	DOWNLIGHT FIXTURE, COOPER HALO SERIES.	16W LED			120	RECESSED EXTERIOR CANOPY	- 1500 LUMENS, 2700K, 90 CRI, WHITE FINISH - SUPPLIED AND INSTALLED BY OTHERS, SHOWN FOR REFERENCE ONLY	
1-CC1	POLE MOUNTED FIXTURE, CSC LED FL04 SERIES.	300W LED			347	POLE 11.1m ABOVE GRADE	- 36705 LUMENS, 4000K, 70 CRI, TYPE III DISTRIBUTION - BLACK FINISH, EXISTING FIXTURES - MOUNTING HEIGHT INCLUDES HEIGHT OF BASE	
2-CC1	POLE MOUNTED FIXTURE, CSC LED FLO4 SERIES.	300W LED			347	POLE 11.1m ABOVE GRADE	- 36705 LUMENS, 4000K, 70 CRI, TYPE III DISTRIBUTION - BLACK FINISH, EXISTING FIXTURES - MOUNTING HEIGHT INCLUDES HEIGHT OF BASE	
3-CC1	POLE MOUNTED FIXTURE, CSC LED FL04 SERIES.	300W LED			347	POLE 11.1m ABOVE GRADE	- 36705 LUMENS, 4000K, 70 CRI, TYPE III DISTRIBUTION - BLACK FINISH, EXISTING FIXTURES - MOUNTING HEIGHT INCLUDES HEIGHT OF BASE	
DD-1	BUILDING MOUNTED WALL PACK, SIGNIFY KEENE LYTEPRO SERIES.	30W LED			120	EXTERIOR WALL 4.9m AFF	- 4000 LUMENS, 4000K, 70 CRI, TYPE III MEDIUM DISTRIBUTION - BLACK FINISH - SUPPLIED AND INSTALLED BY OTHERS, SHOWN FOR REFERENCE ONLY	
DD-2	BUILDING MOUNTED WALL PACK, SIGNIFY KEENE LYTEPRO SERIES.	30W LED			120	EXTERIOR WALL 4.9m AFF	- 4000 LUMENS, 4000K, 70 CRI, TYPE II MEDIUM DISTRIBUTION - BLACK FINISH - SUPPLIED AND INSTALLED BY OTHERS, SHOWN FOR REFERENCE ONLY	
DD-3	BUILDING MOUNTED SIGNAGE FIXTURE, RAB DESIGN VEK2 SERIES.	52W LED			120	EXTERIOR ARM 7.5m AFF	- 5333 LUMENS, 4000K, 70 CRI - BLACK FINISH - SUPPLIED AND INSTALLED BY OTHERS, SHOWN FOR REFERENCE ONLY	

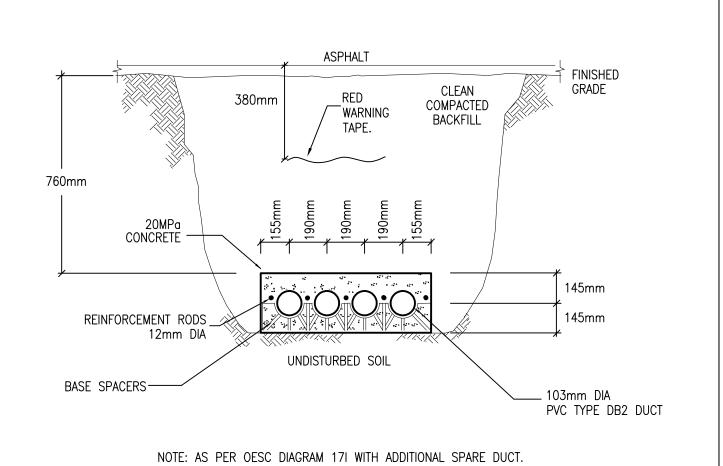



TRENCH DETAIL - PRIMARY 4 CELL


SP-E02 CONCRETE ENCASED

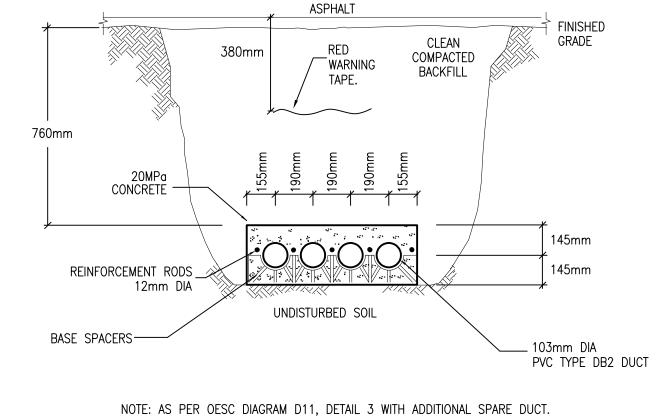


TRENCH DETAIL - SECONDARY 4 CELL SP-E02 CONCRETE ENCASED (FOOD STORE)

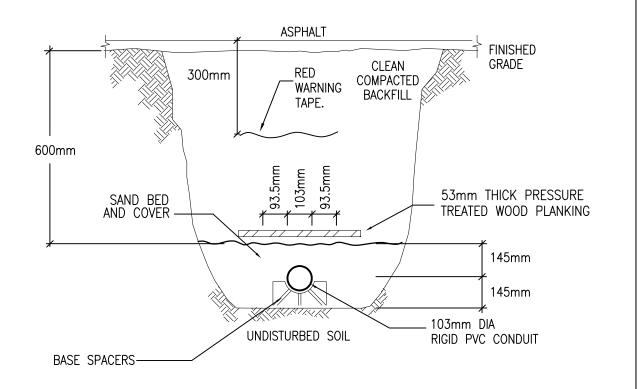

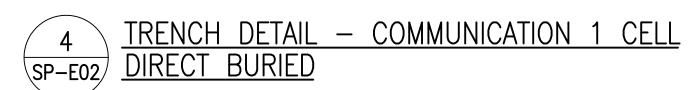


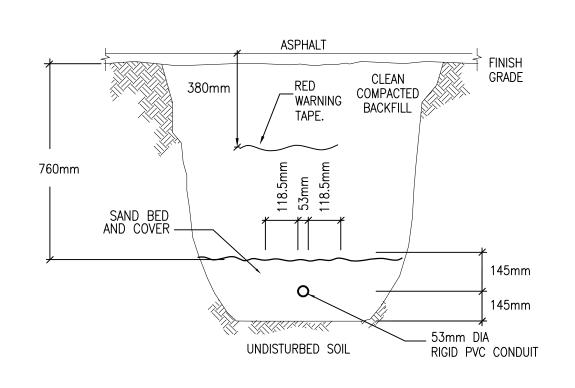

DIRECT BURIED CONDUIT FOR EXTERIOR LIGHTING STANDARDS OR POWER

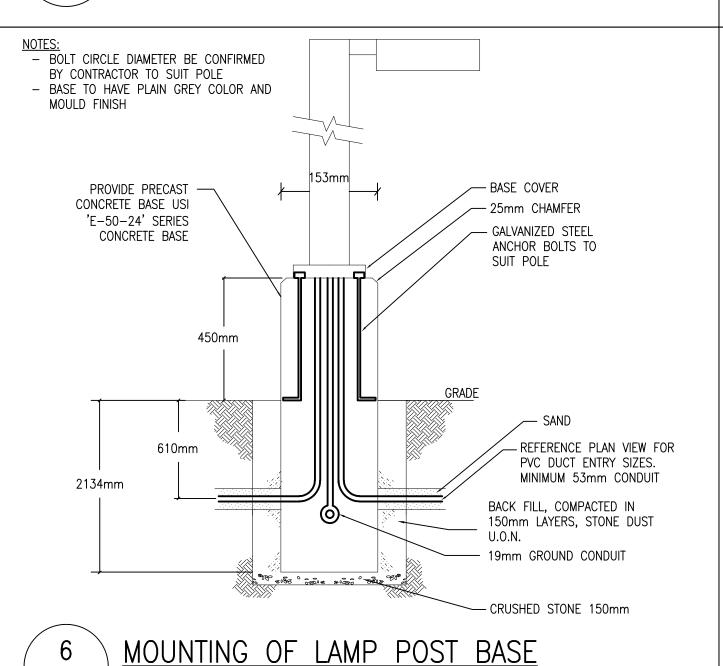

SP-E02

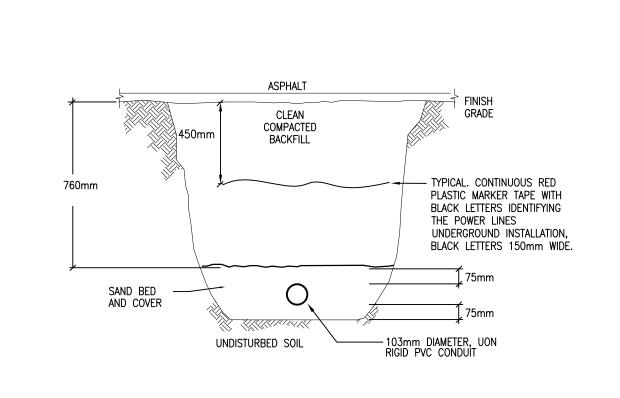

TRENCH DETAIL - SECONDARY 1 CELL SP-E02 DIRECT BURIED - (MCDONALD'S)

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1.	ISSUED FOR SPA REVIEW	OCT 14/21
REVISION No.	DESCRIPTION	DATE

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900 WATTERS ROAD CROWN POINTE - PHASE 3

ELECTRICAL: MCDONALD'S DRIVE—THRU AND IRRIGATION CONDUITS, SCHEDULES AND DETAILS





DATE: OCTOBER 2021 DESIGNED BY: N.H. DRAWN BY: N.H. CHECKED BY: G.O.M.

SCALE: N.T.S.


NCE OF ON lo. DWGS. 3 PROJECT No.

DRAWING No. 21117

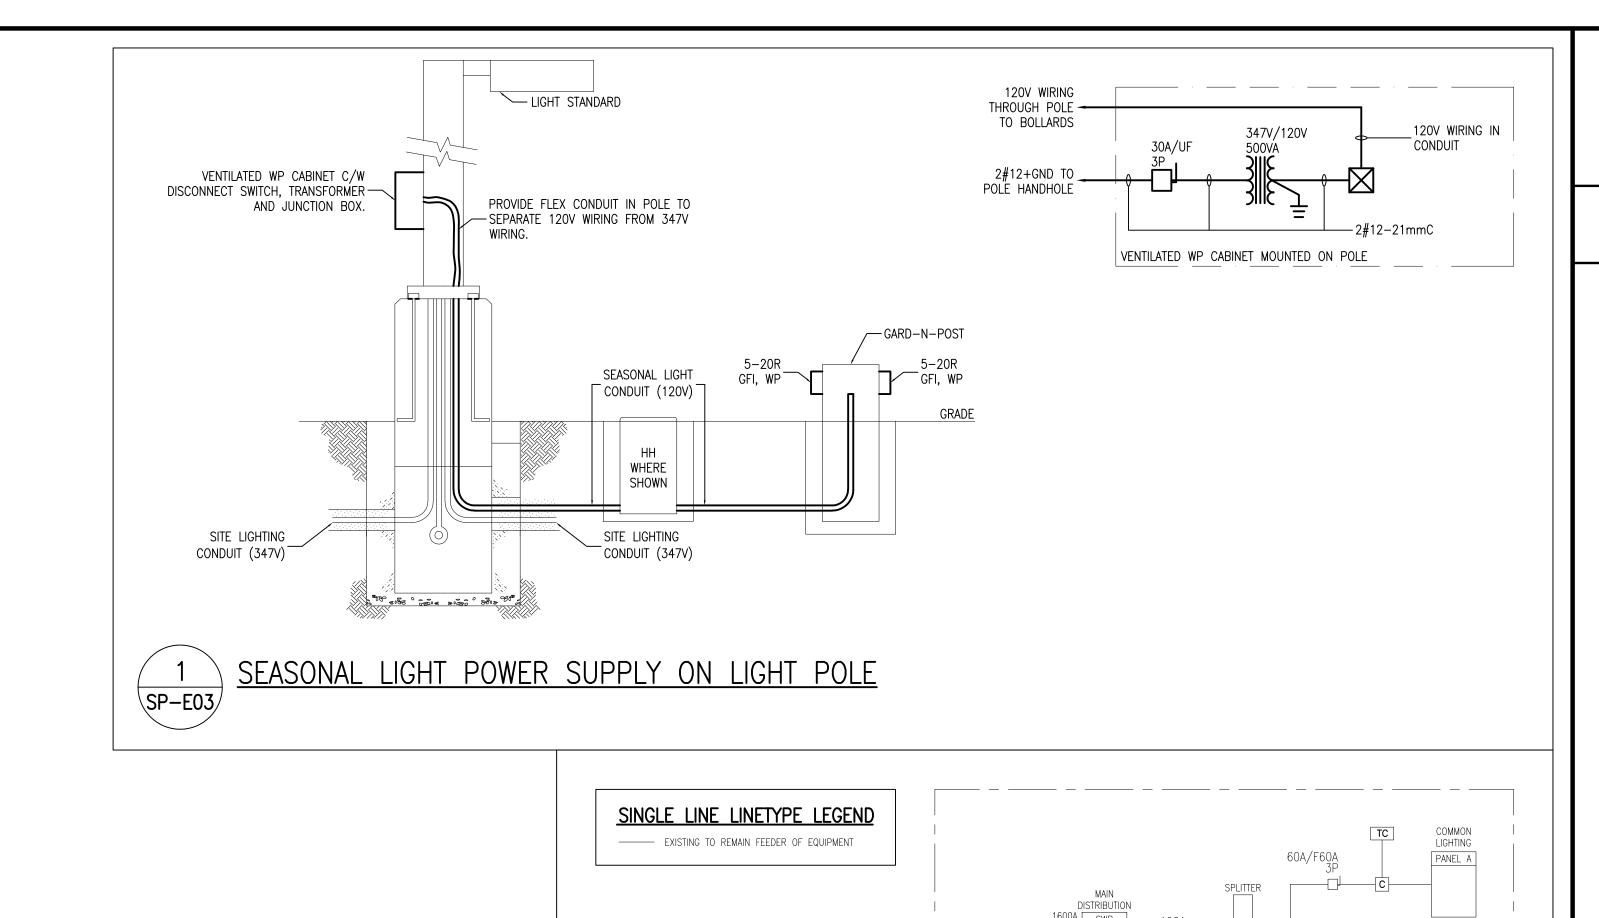

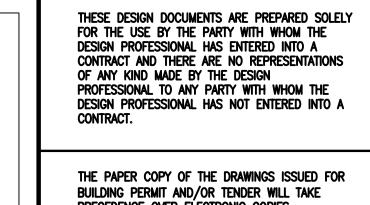

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CHECKED BY: G.O.M.

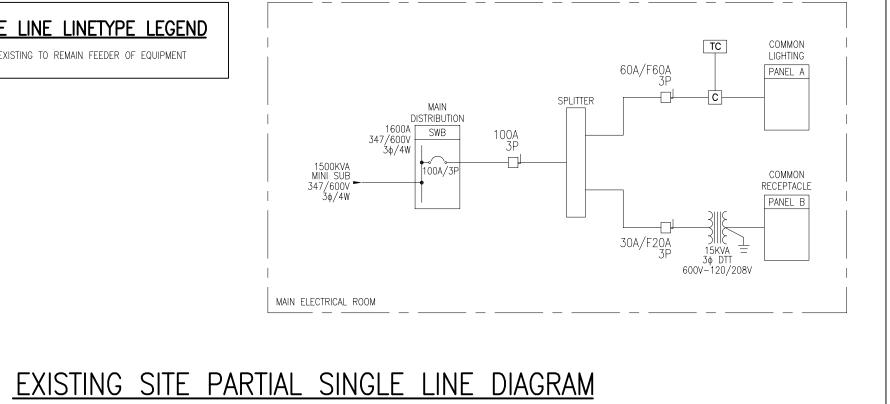PROJECT: 900 WATTERS ROAD CROWN POINTE - PHASE 3

ELECTRICAL:

DETAILS AND SINGLE LINE DIAGRAMS



SCALE: N.T.S.

No. DWGS. 3