

**GENERAL NOTES** 

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All dimensions shown are to be verified on site prior to any construction. No deviations are to be made from the layouts as shown on this plan without prior consultation with

the Landscape Architect and Owner. 4 Obtain approval of Landscape Architect for granular

5 Stake planting locations and receive approval of Landscape Architect, prior to excavation of any planting pits. No substitutions of plant material shall be made without prior

6 Where clay is encountered proper drainage must be ensured in tree/shrub pits, prior to planting. Have method approved by Landscape Architect.

All sodded areas to receive a minimum of 150mm of topsoil over graded sub-base. If sod with mesh is used, mesh to be removed completely during sodding operations. Sod shall come from an approved source and shall be laid within 24 hours of being cut in the nursery. Only nursery sod shall be


.8 Final subgrade is to approved by the Landscape Architect prior to sod being laid.

.9 Maintain positive surface runoff through the entire

construction period.

2023/01/09 Re-issued SPC submission 2022/07/08 Re-issued SPC submission 2021/11/22 issue / revision



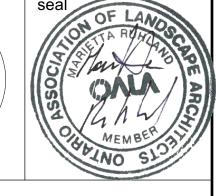

**Ruhland & Associates Ltd** 

**3996 INNES RD,** OTTAWA ON

drawing title

LANDSCAPE PLAN

scale	drawn by	designed by	
1:100	C. Reed/T. Frost	C. Reed	P
date	checked by	plot date	
November 2021	M. Ruhland	Nov10, 2021	
project number	drawing number		1 2


Contractor to check and verify all dimensions on the job


SOIL VOLUME NOTES TO GO WITH L1


TREE SOIL VOLUME REQUIREMENTS: - STANDARD TREE SOIL VOLUMES QUANTITIES INCLUDE THE TOP 900-1000mm OF SOIL/EXISTING SUBSOIL LAYER TO CALCULATE TOTAL SOIL VOLUMES REQUIRED BY CITY OF OTTAWA FOR SUSTAINABLE TREE GROWTH. WHERE LARGER SOFT AREAS ARE AVAILABLE, THE TOP 400-500mm LAYER IS USED TO CALCULATE SOIL VOLUMES.


WHERE EXISTING MATERIAL BELOW THE SPECIFIED TOPSOIL IS NOT CONDUCIVE TO TREE GROWTH. AN ADDITIONAL LAYER OF PLANTING MEDIUM IS TO BE INSTALLED BELOW SPECIFIED TOPSOIL DEPTH TO OBTAIN THE SOIL VOLUME DEPTH REQUIRED.


- REFER TO SOIL VOLUME CHART AND PLANS FOR AREA WHERE TREE SOIL VOLUMES ARE REQUIRED.

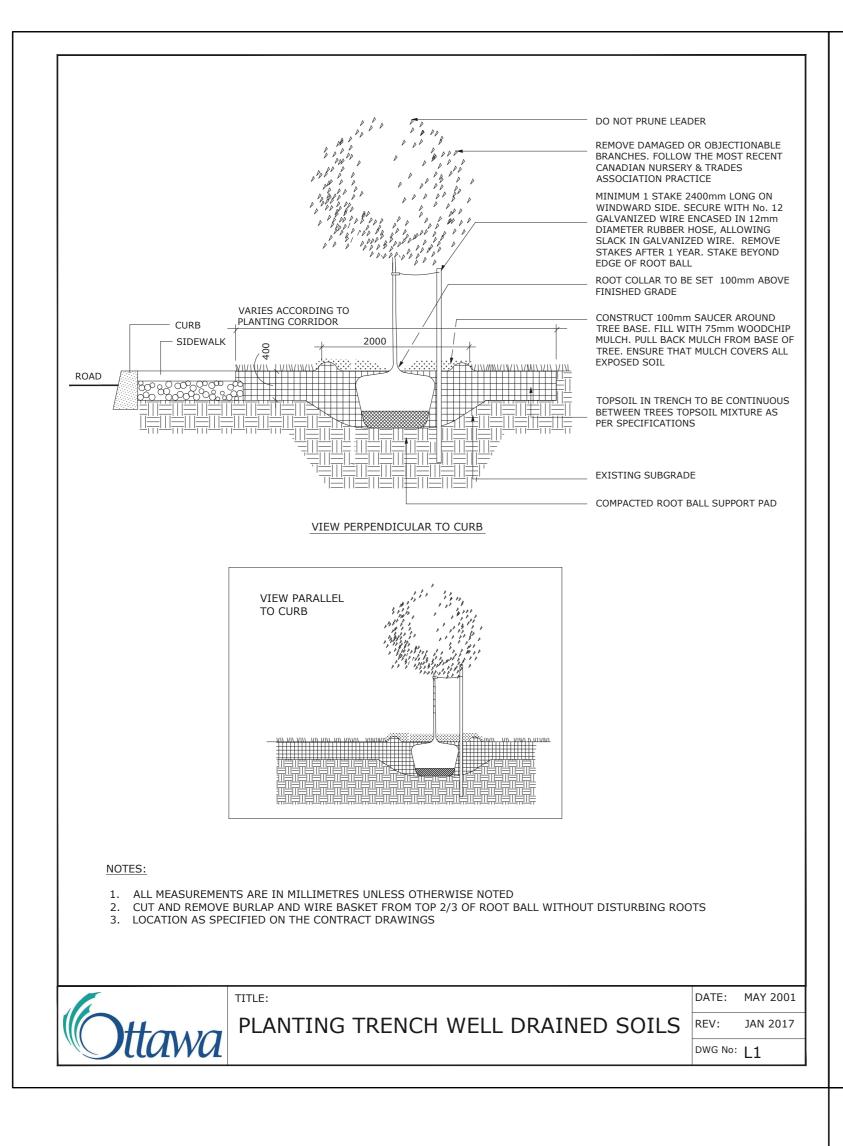

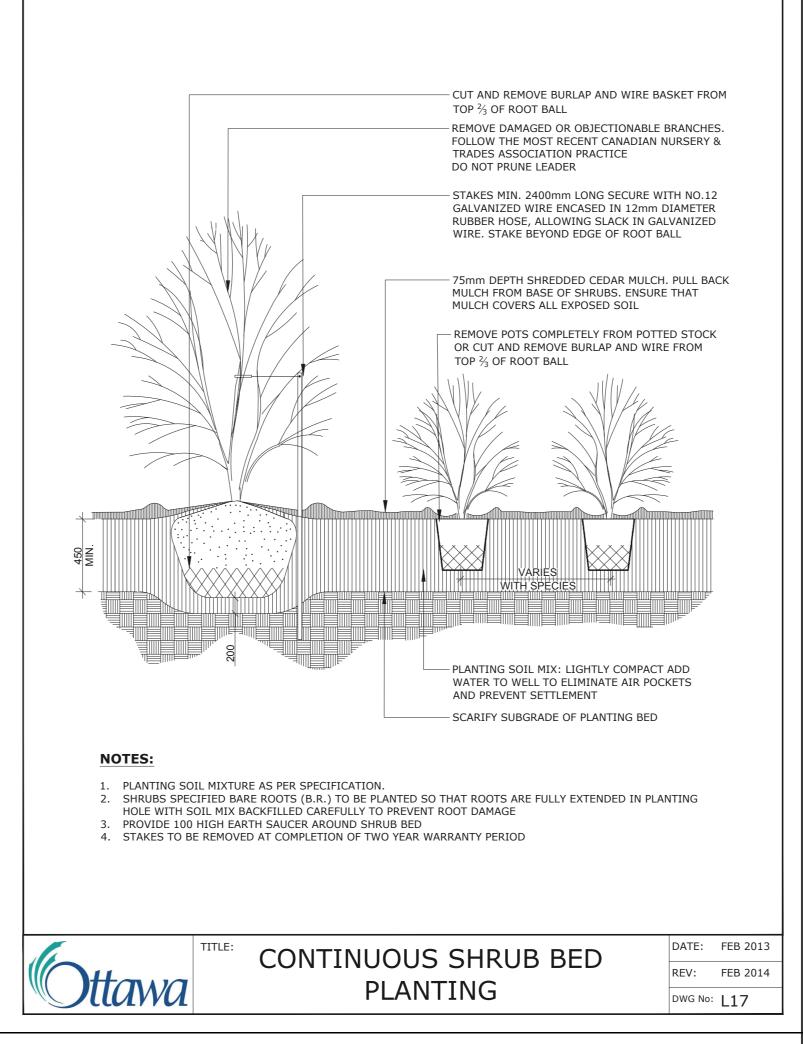

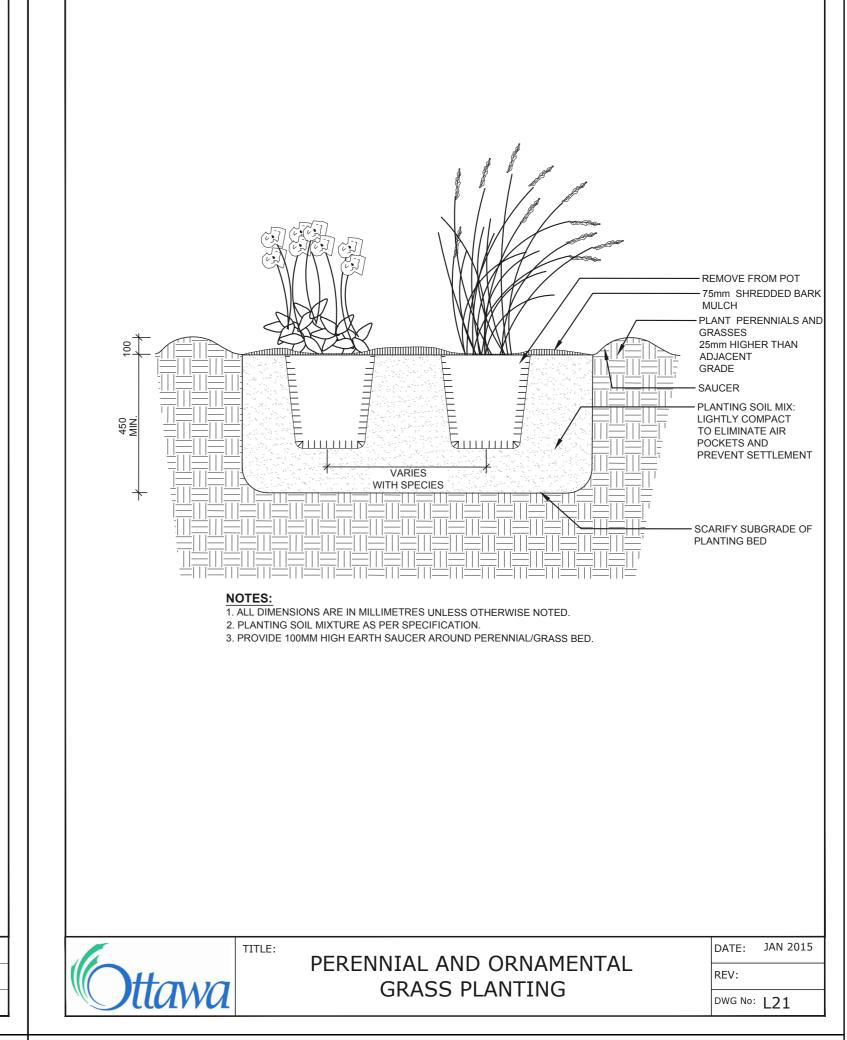


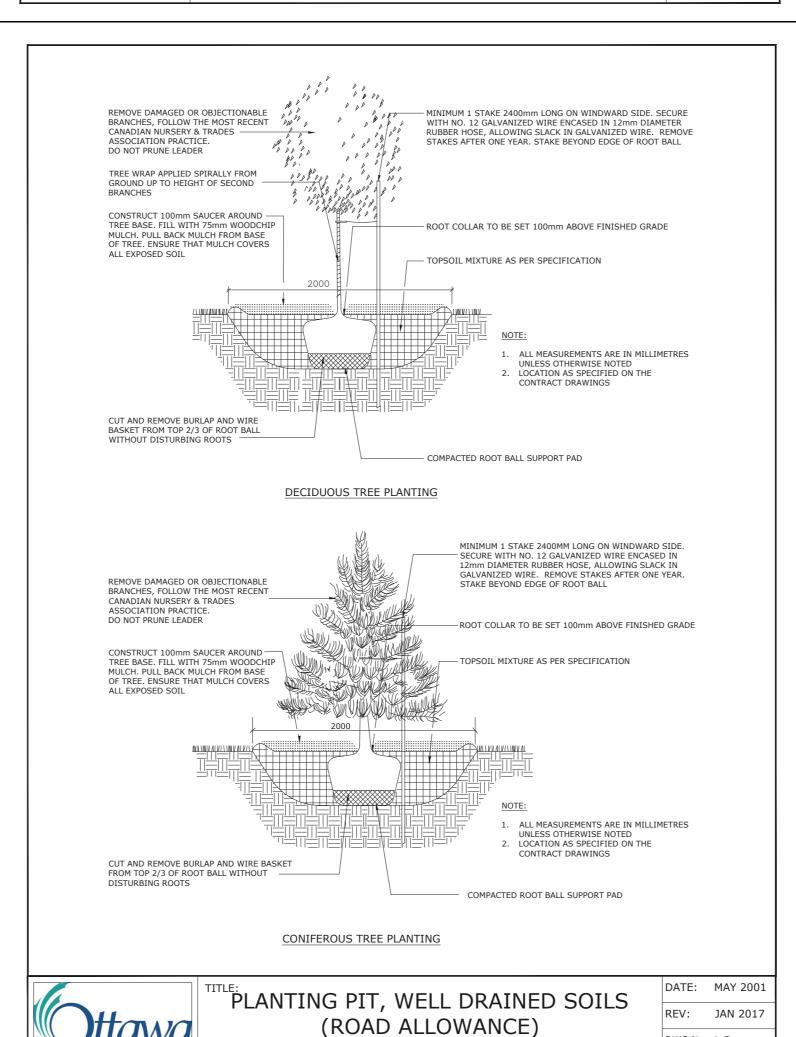

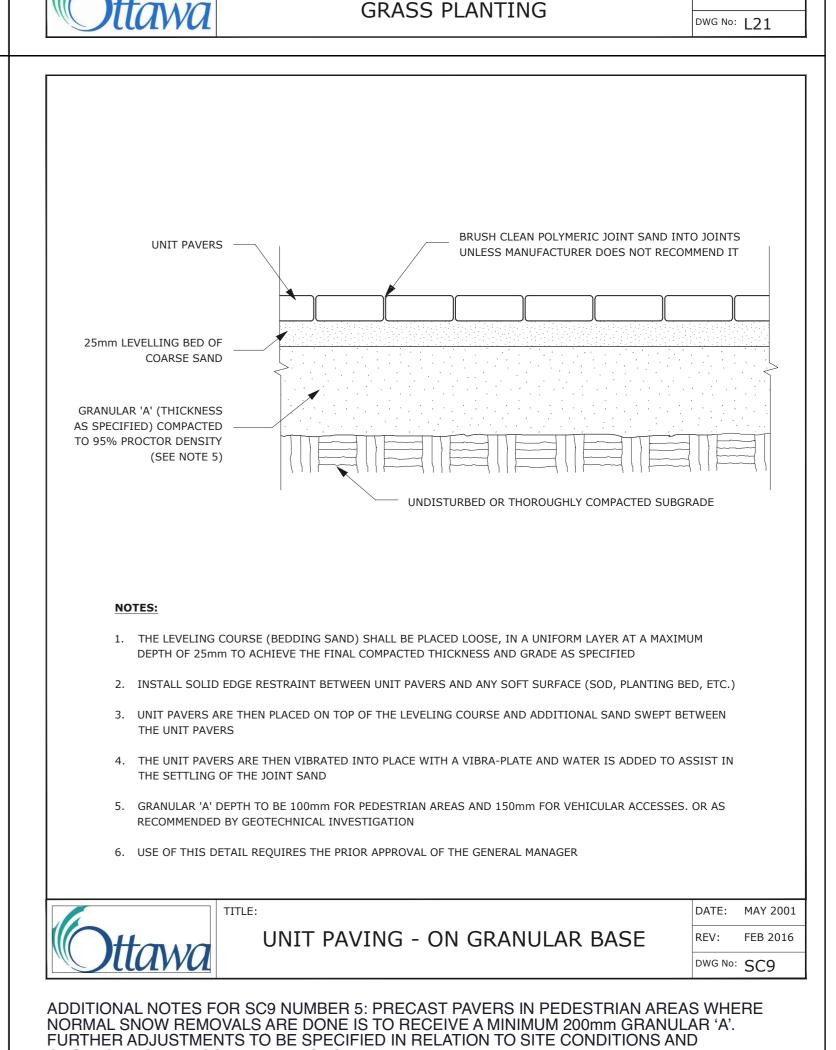

GEOTECHNICAL RECOMMENDATIONS.

DWG No: L3

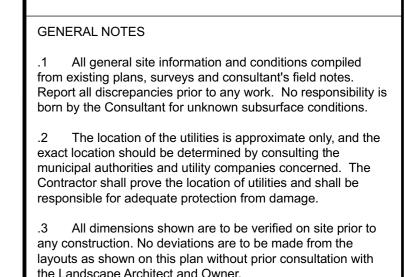

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base and layout of all pavement areas prior to construction.

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.8 Final subgrade is to approved by the Landscape Architect prior to sod being laid.

.9 Maintain positive surface runoff through the entire

construction period.

.10 Reinstate all areas and items damaged as a result of construction activities.

Re-issued SPC submission 2023/01/09 Re-issued SPC submission 2022/07/08 2021/11/22 Issued for SPC submission

date

no. issue / revision

north

Ruhland & Associates Ltd

project

**3996 INNES RD,** OTTAWA ON

drawing title

**DETAILS** 

scale designed by drawn by C. Reed/T. Frost C. Reed date checked by plot date November 2021 Nov10, 2021 M. Ruhland

drawing number

project number

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METALLIC GUARD RAIL

L-03 Scale: NTS


REFER TO SITE PLAN FOR LOCATIONS

SECTION ALONG EAST PROPERTY LINE

GLOBAL INDUSTRIAL™ 4' PARK BENCH

L-03 Tan, w/Backrest

## TYPICAL SECTION

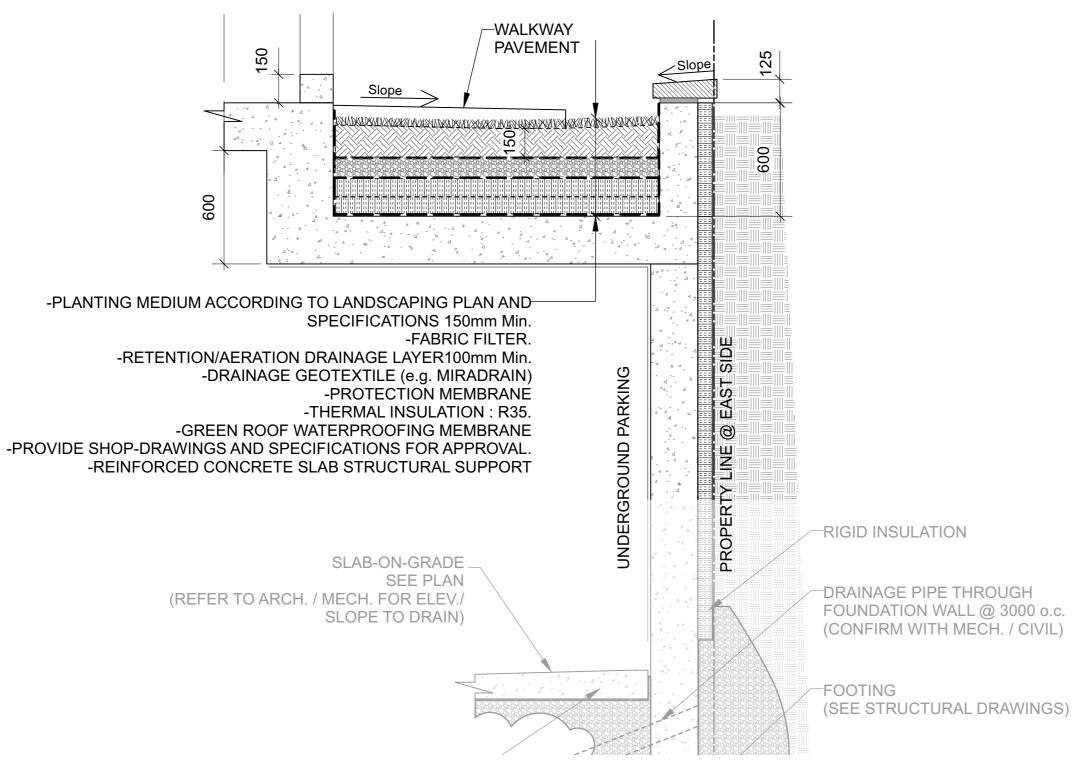

SKYLINE OUTDOOR PATIO HARD-TOP GAZEBO

L-03 Canvas, w/ Bug Net, Black 10'x12'

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21-1647

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