


**DRAWING LEGEND**

CB	CATCH BASIN
MH	MANHOLE
CB/MH	CATCH BASIN/MANHOLE
SPL	SPRINGLINE OF PIPE
INV	INVERT OF PIPE
SN	SANITARY SEWER
SS	STORM SEWER
WS/WA	WATER SERVICE/WATERMAIN
CS	CURB STOP & STANDPOST
VB	VALVE & VALVE BOX
FH	FIRE HYDRANT
FDC	FIRE DEPARTMENT CONNECTION
WM	WATER METER
± 67.89	EXISTING GRADE ELEVATION
± 67.89	PROPOSED GRADE ELEVATION
Z%	EXISTING SLOPE OF GRADE
Z%	PROPOSED SLOPE OF GRADE
↔	EMERGENCY OVERLAND FLOW
T.O.S	TOP OF SLOPE
B.O.S	BOTTOM OF SLOPE
---	CENTERLINE OF SWALE
---	PROPERTY LINE
---	SILT FENCE BARRIER
---	150mm CURB/DEPRESSED CURB
---	LIGHT-DUTY PAVEMENT
---	HEAVY-DUTY PAVEMENT
---	CONCRETE
---	LANDSCAPE
FFL	FIRST FLOOR ELEVATION
TOF	TOP OF FOUNDATION
USF	UNDERSIDE OF FOOTING

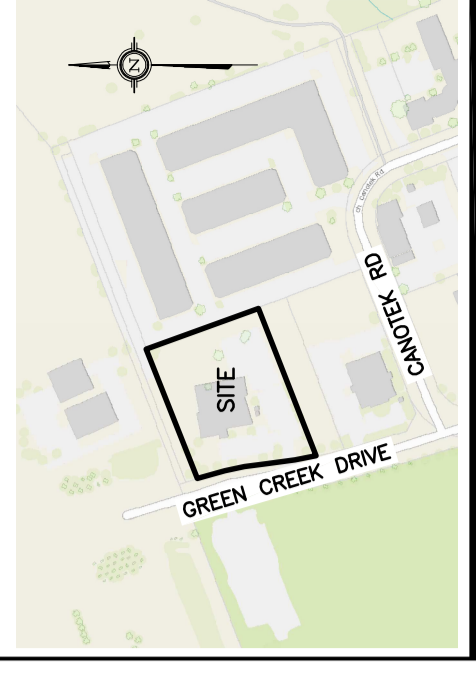


No.	DATE	ISSUED FOR COORDINATION	REVISION
1	SEP 10-20		

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**Project**  
 LOCAL 47  
 SMART LOCAL  
 TRAINING CENTRE  
 765 GREEN CREEK DRIVE  
 OTTAWA, ONTARIO

**Drawing Title**  
 GRADING PLAN AND  
 EROSION & SEDIMENT  
 CONTROL PLAN

Drawn: D.B.G.  
 Hor. Scale: 1:200  
 Vert. Scale: 1:20  
 Date: SEP 10-20  
 Job: 200014  
 Drawing No.: **C-2**  
 of **3**

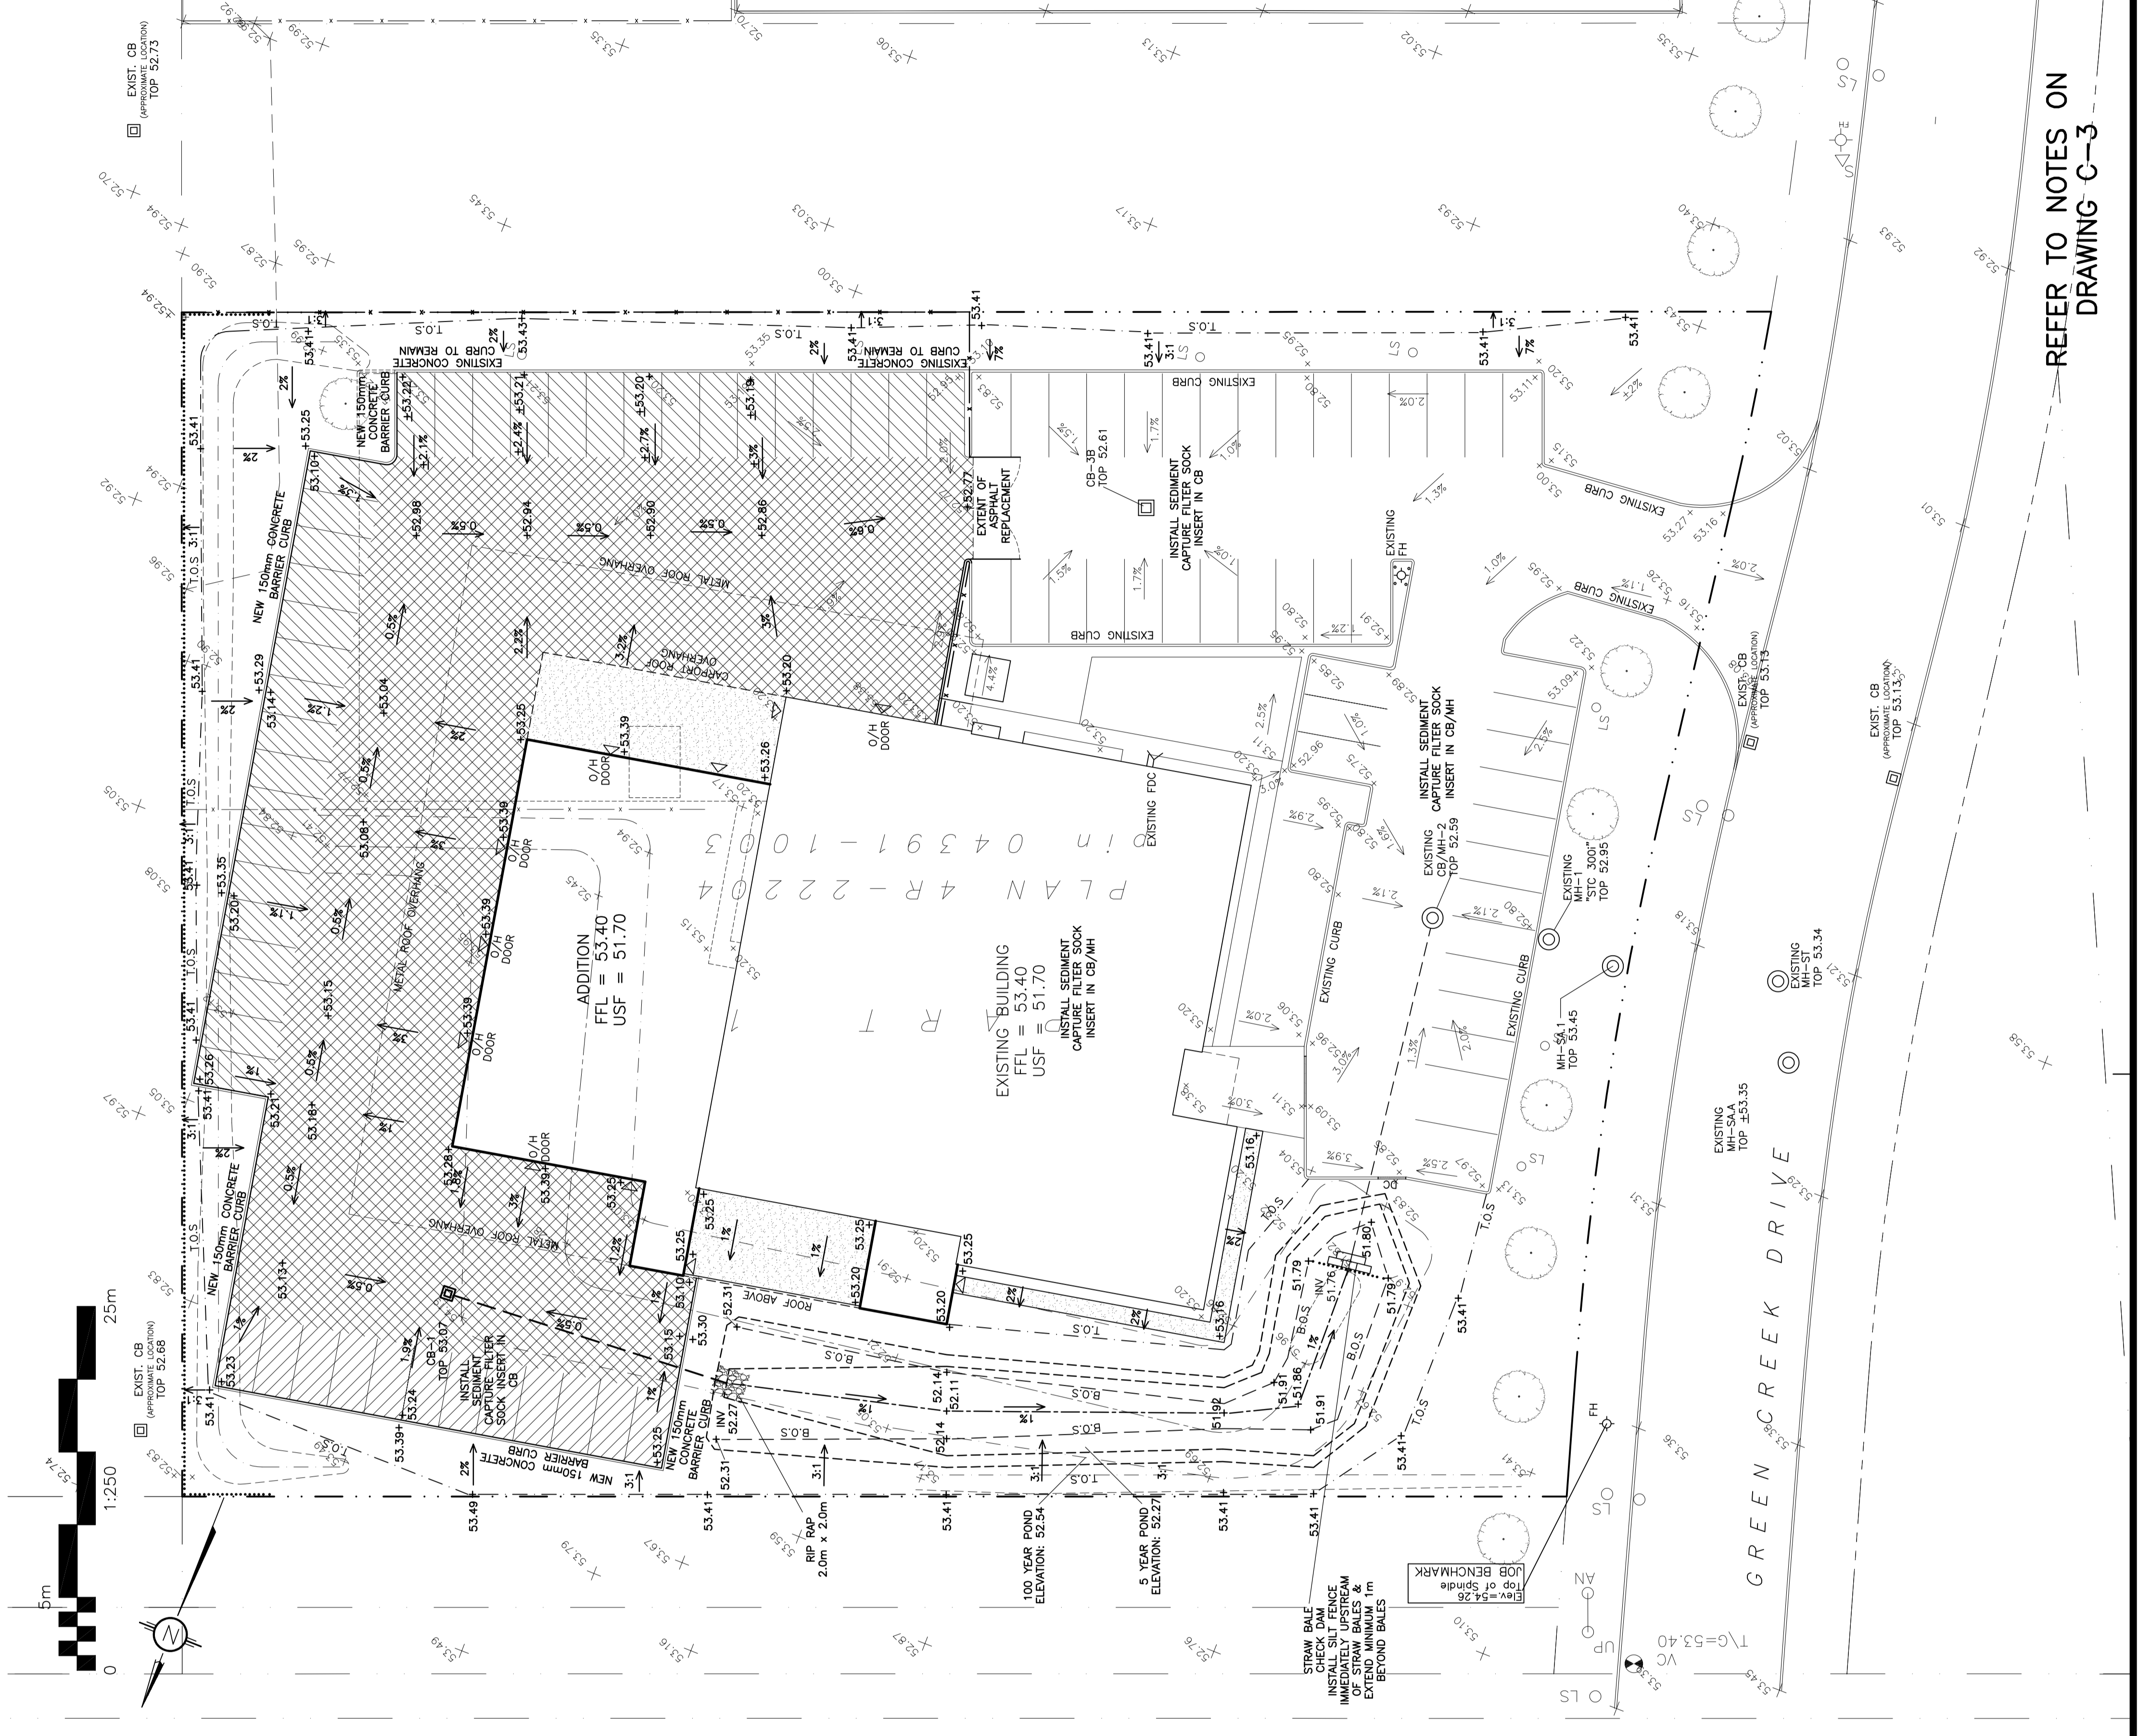

REFER TO NOTES ON  
 DRAWING C-3

