— A R C H I T E C T U R E — 88 boul. St-Joseph, Gatineau, QC, J8Y 3W5 Tel: 1 819-600-1555

I **«**OSSMANN

6 Re-Issued for SPC 2024/10/28 MR 2024/09/18 MR Issued for Building Permit 4 Re-Issued for SPC 2023/12/21 MR Re-Issued for SPC 2023/10/05 MR Re-Issued for SPC 2023/06/27 MR Issued for SPC 2023/06/09 MR DATE: (Y/M/D) INITIALS INITIALE NUMBER/ NUMÉRO MILESTONE / FAIT SAILLANT DESIGNED BY / CONCU PAR CHECKED BY / VERIFIE PAR

M. Ruhland M. Ruhland DRAWN BY / DESSINE PAR SCALE / ECHELLE

**Ruhland & Associates Ltd** landscape architecture • urban design • site planning

ARCHITECT



CONSULTANT CONSULTANT

PROJECT / LOCATION

LANDRIC HOMES **SEMIS & STACKED TOWN HOMES** 

6001 - 6005 RENAUD ROAD OTTAWA, ONTARIO

LANDSCAPE / PLANTING PLAN, TREE CANOPY COVERAGE /

SOIL VOLUME

L-01

PROJECT NO.

21-1660

**GENERAL NOTES** .1 All general site information and conditions compiled from existing plans, surveys and consultant's field notes. Report all discrepancies prior to any work. No responsibility is born by the Consultant for unknown subsurface conditions. .2 The location of the utilities is approximate only, and the exact location should be determined by consulting the municipal authorities and utility companies concerned. The Contractor shall prove the location of utilities and shall be responsible for

adequate protection from damage. .3 All dimensions shown are to be verified on site prior to any construction. No deviations are to be made from the layouts as shown on this plan without prior consultation with the Landscape Architect and

.4 Obtain approval of the Consultant(s) for granular base and layout of all pavement areas prior to construction.

.5 Stake planting locations and receive approval of Landscape Architect, prior to excavation of any planting pits. No substitutions of plant material shall be made without prior approval of the Landscape Architect.

.6 Where clay is encountered proper drainage must be ensured in tree/shrub pits, prior to planting. Have method approved by Landscape Architect. .7 Maintain positive surface runoff through the entire construction period.

.8 Reinstate all areas and items damaged as a result of construction activities.

**APPROVED** 

SOIL VOLUME EXTENTS

FOR TREE PLANTING


AT MATURITY

TREE CANOPY EXTENT

By sevignyjo at 4:01 pm, Jan 20, 2025

## **CANOPY COVERAGE CALCULATION**

COVERAGE	AREA (m2)
TOTAL CANOPY COVER	1662
SITE AREA	2914
Percent coverage	57.0%

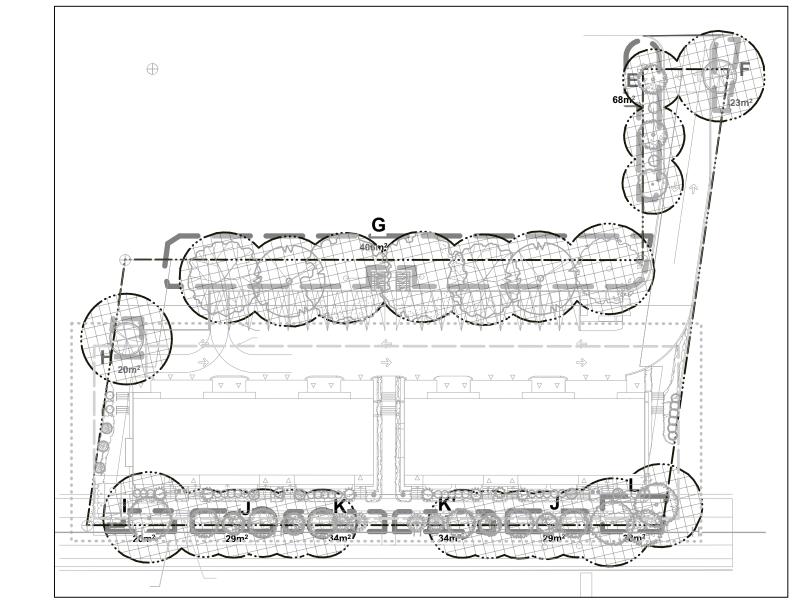

TREE CANOPY & SOIL VOLUME AREAS

Scale: 1:500

## **SOIL VOLUME CALCULATION**

**LEGEND** 

PHASING

— PROPERTY LINE

7.5m GEOTECHNICAL

**BUILDING OFFSET** 

**BUILDING OFFSET** 

**HYDRO LINE** 

**PERENNIALS** 

REMAIN

TREE PROTECTION FENCE

JOHN SEVIGNY C.E.T. MANAGER (A), DEVELOPMENT REVIEW EAST

PLANNING, DEVELOPMENT & BUILDING SERVICES **DEPARTMENT, CITY OF OTTAWA** 

4.5m GEOTECHNICAL


HYDRO LINE HEIGHT RESTRICTED AREA

ORNAMENTAL GRASSES

**EXISTING TREES TO** 

CRITICAL ROOT ZONE

plant bed (68 sq m x 0.8 ave metre deep)	5	59.0	54.4	92%
AREA F - 1 small tree				
plant bed (23 sq m x 1 ave metre deep)	1	25.0	23.0	92%
AREA G - 7 medium trees				
plant bed (406 sq m x 0.6 ave metre deep)	7	126.0	243.6	193%
AREA H - 1 small tree				
plant bed (20 sq m x 0.9 ave metre deep)	1	20.0	18.0	90%
AREA I - 1 ornamental trees				
plant bed (20 sq m x 0.9 metre deep	1	20.0	18.0	90%
AREA J - 3 ornamental trees				
plant bed (29 sq m x 1 metre deep	3	36.0	29.0	81%
AREA K, K' - 2 ornamental trees, 2 small orname	ental conifers			
plant bed (34 sq m x 1 metre deep	4	38.0	34.0	89%
AREA L - 3 ornamental trees				
plant bed (38 sq m x 0.9 metre deep	3	36.0	34.2	95%

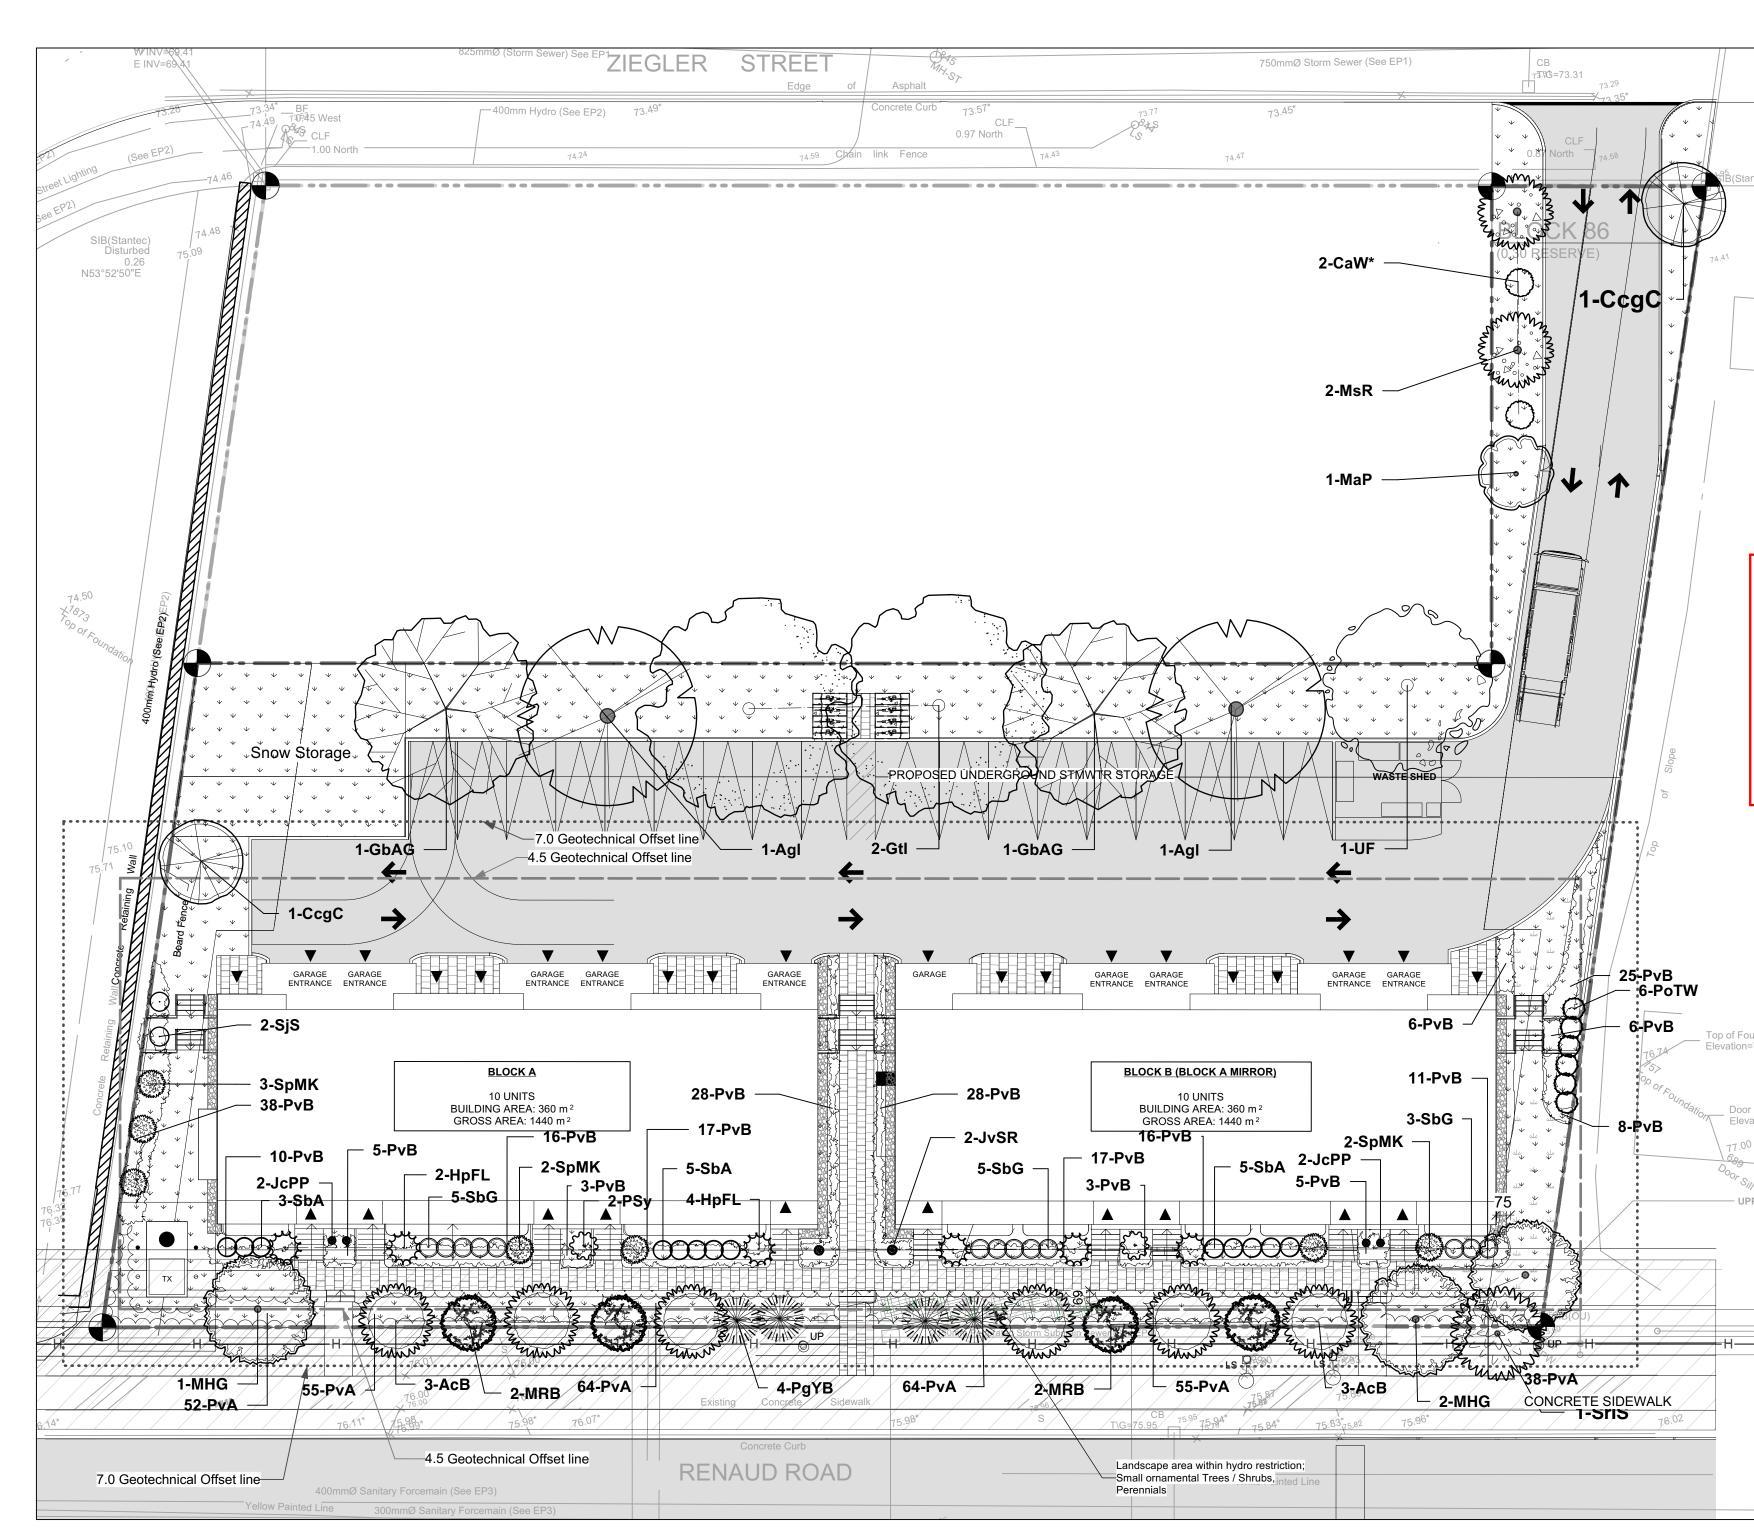

LANDSCAPE / PLANTING PLAN

Scale: 1:200

Plant Li	ist					
ID	Qty	Botanical Name	Common Name	Scheduled Size	Remarks	
		MEDIUM TREES: 9 - 13.5m ht, 8.5 - 20m Ø canopy				
Agl	2	Aesculus glabra	Ohio Buckeye	50mm caliper	WB, Staked	
GbAG	2	Ginkgo biloba 'Autumn Gold'	Autumn Gold Maidenhair Tree	60mm caliper	WB, Staked	
Gtl	2	Gleditsia triacanthos var. inermis 'Impcole'	Imperial Honeylocust	70mm caliper	WB, Staked	
UF	1	Ulmus minor x parvifolia 'Frontier'	Frontier Elm	60mm caliper	WB, Staked	
		SMALL TREES: 6 - 8m ht, 6 - 8m Ø canopy				
CcgC	2	Crataegus crus-galli inermis 'Cruzam'	Thornless Crusader Cockspur Hawth		WB, Staked	
		ORNAMENTAL TREES: 4 - 7m ht, 4 - 6m Ø canopy (6m ht max under power lines)				
AcB	6	Amelanchier canadensis 'Ballerina'	Ballerina Serviceberry (tree form)	50mm caliper	WB, Staked	
MHG	3	Malus x `Harvest Gold`	Harvest Gold Crabapple	50mm caliper	WB, Staked	
MRB	4	Malus x `Royal Beauty`	Royal Beauty Crabapple	45mm caliper	WB, Staked	
SrIS	1	Syringa reticulata 'Ivory Silk'	Ivory Silk Tree Lilac	50mm caliper	WB, Staked	
		SMALL ORNAMENTAL TREES: <4.5m ht, <4	l.5m Ø canopy			
CaW*	2	Caragana arborescens 'Walker'	Walker's Weeping Peashrub	125cm STEM	WB, Specimen	
MaP	1	Morus alba 'Pendula'	Weeping Mulberry, male	150cm stem	Fruitless, B&B	
MsR	2	Malus sargentii "Rosea"	Pink Flowering Crabapple	45mm caliper	WB, Staked	
PgYB	4	Picea glauca 'Yukon. Blue'	Yukon Blue White Spruce	75cm spd	WB, Staked	
		SHRUBS				
HpFL	6	Hydrangea paniculata 'Fire Light'	Fire Light pannicle hydrangea	2 gallon pot	0.9m o.c.	
JcPP	4	Juniperus communis 'Pencil Point'	Pencil Point Juniper	150cm stem	Potted	
JvSR	2	Juniperus virginiana 'Skyrocket' (J. scopulorum	Skyrocket Juniper	150cm stem	Potted	
PoTW	6	Physocarpus opulifolius 'Tiny Wine'	Tiny Wine Dwarf Ninebark	50cm ht.	Potted	
PSy	2	Philadelphus 'Sybile'	Minnesota Snowflake Mockorange	60mm dia.	WB Staked	
SbA	13	Spiraea bumalda 'Anthony Waterer'	Anthony Waterer Spirea	50cm ht.	Potted, 0.9m o.	
SbG	13	Spiraea bumalda 'Goldflame'	Goldflame Spirea	50cm ht	0.9m o.c.	
SjS	2	Spiraea japonica 'Shirobana'	Shirobana Spirea	50cm ht.	0.8m o.c.	
SpMK	7	Syringa patula 'Miss Kim'	Miss Kim Dwarf Lilac	100cm ht.	3 gallon Pot	

PERENNIALS Sched. Size Remarks **Qty** Description 264 Ornamental grasses Karl Foerster Feather Reed Grass, Blue Fescue Coneflower, Black-eyed Susan, Spiked 242 |Sun flowering perennials Speedwell, Seathrift, Beebalm, Daylily, Siberian Iris, Cardinal Flower, Ozark Sundrops 50 Full shade perennials Ballerina Cranesbill, Bottlebrush Grass

NOTE:

NOTE:

Potted

Potted

THIS PLAN IS ISSUED FOR BUILDING PERMIT SUBMISSION ONLY. ADDITIONAL DETAILING AND **SPECIFICATIONS ARE REQUIRED** PRIOR TO TENDERING OR CONSTRUCTION.

THIS PLAN TO BE READ IN CONJUNCTION WITH TCR BY DENDRON FORESTRY SERVICES. EXISTING TREES TO BE PRESERVED AND PROTECTED AS PER TCR.


SERVICING INFORMATION SHOWN AS REFERENCE ONLY. REFER TO CIVIL DRAWINGS.


64 **PERENNIALS** 48 Festuca glauca Blue Fescue 3 year 16 Panicum virgatum 'Heavy Metal' Heavy Metal Switch Grass 3 year


TREE SOIL VOLUME REQUIREMENTS: STANDARD TREE SOIL VOLUMES QUANTITIES INCLUDE THE TOP 900-1000mm OF SOIL/EXISTING SUBSOIL LAYER TO CALCULATE TOTAL SOIL VOLUMES REQUIRED BY CITY OF OTTAWA FOR SUSTAINABLE TREE GROWTH. WHERE LARGER SOFT AREAS ARE AVAILABLE, THE TOP 400-500mm LAYER IS USED TO CALCULATE SOIL VOLUMES.

WHERE EXISTING MATERIAL BELOW THE SPECIFIED TOPSOIL IS NOT CONDUCIVE TO TREE GROWTH. AN ADDITIONAL LAYER OF PLANTING MEDIUM IS TO BE INSTALLED BELOW SPECIFIED TOPSOIL DEPTH TO OBTAIN THE SOIL VOLUME DEPTH REQUIRED.

REFER TO SOIL VOLUME CHART AND PLANS FOR AREA WHERE TREE SOIL VOLUMES ARE REQUIRED.

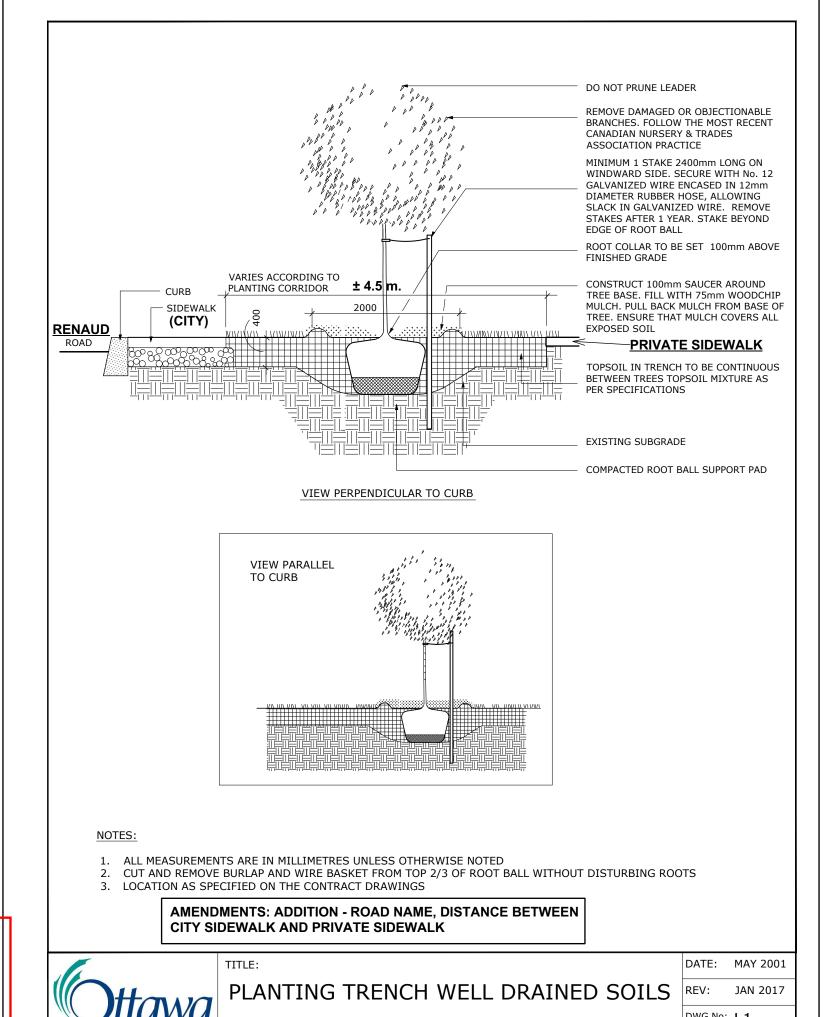

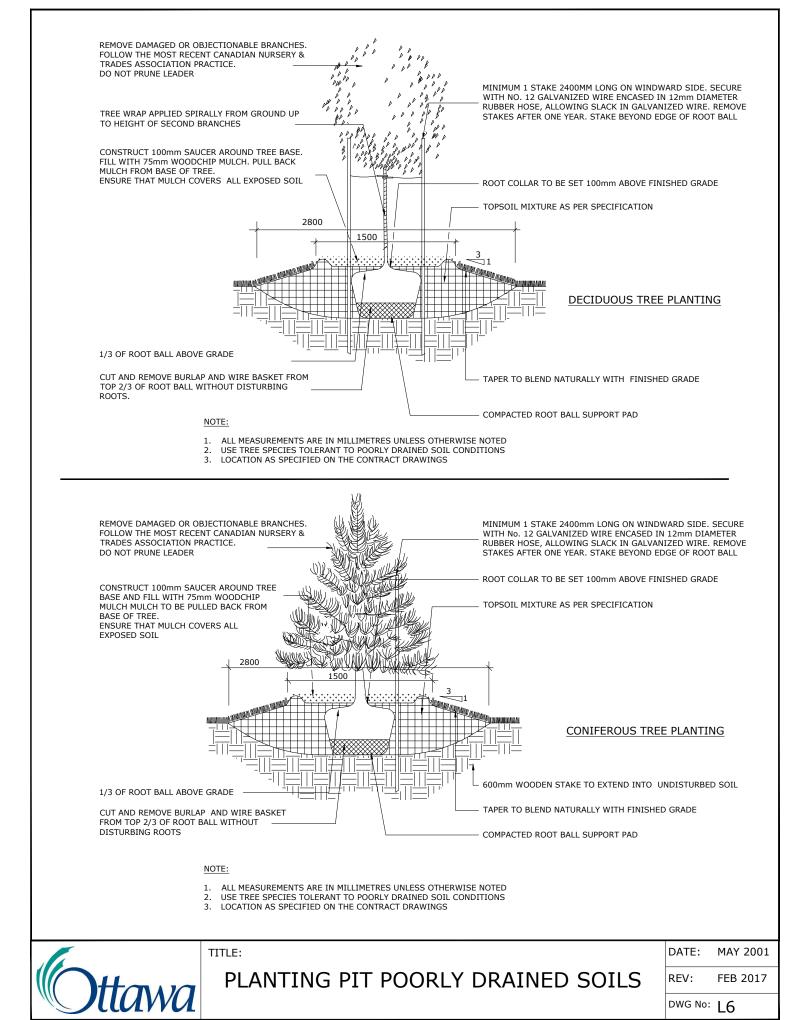

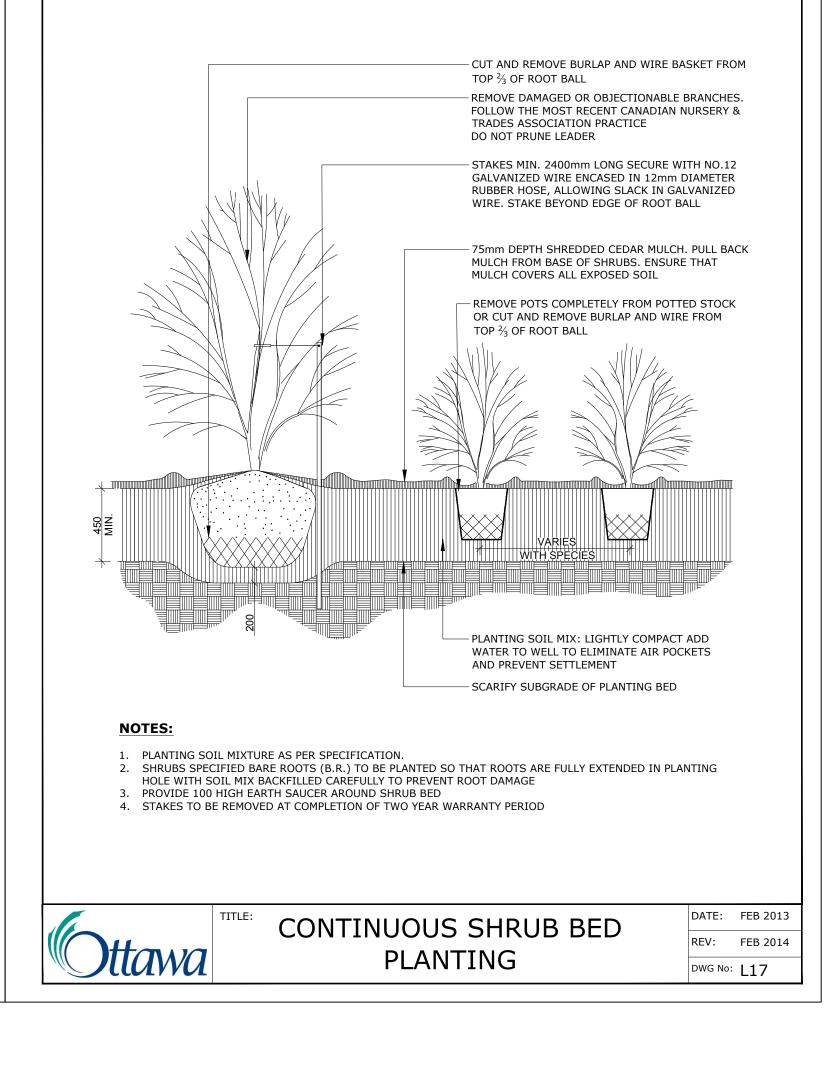




6	Re-Issued for SPC	2024/10/28	MR
5	Issued for Building Permit	2024/09/18	MR
4	Re-Issued for SPC	2023/12/21	MR
3	Re-Issued for SPC	2023/10/05	MR
2	Re-Issued for SPC	2023/06/27	MR
1	Issued for SPC	2023/06/09	MR
NUMBER/ NUMÉRO	MILESTONE / FAIT SAILLANT	DATE: (Y/M/D) (A/M/J)	INITIALS INITIALES


DESIGNED BY / CONCU PAR CHECKED BY / VERIFIE PAR M. Ruhland M. Ruhland DRAWN BY / DESSINE PAR SCALE / ECHELLE


JOHN SEVIGNY C.E.T. ANAGER (A), DEVELOPMENT REVIEW EAST PLANNING, DEVELOPMENT & BUILDING SERVICES DEPARTMENT, CITY OF OTTAWA


## **APPROVED**

By sevignyjo at 4:01 pm, Jan 20, 2025

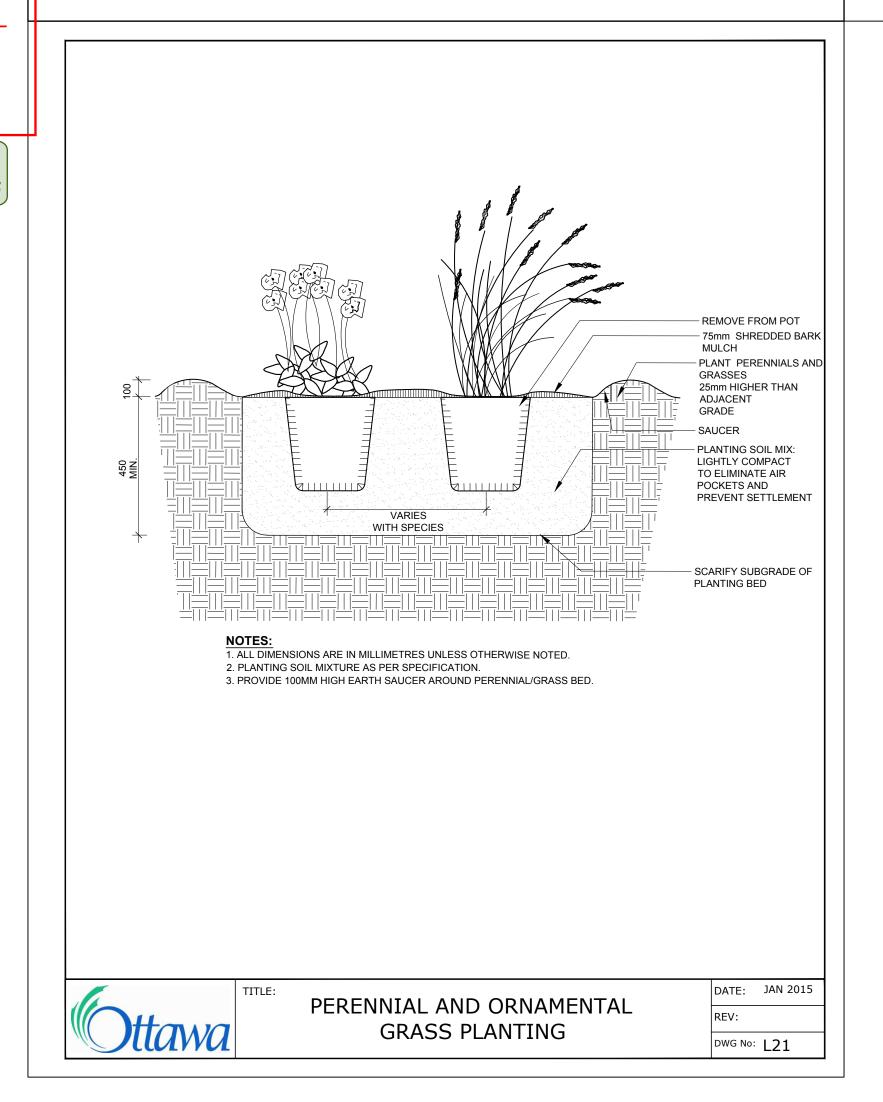

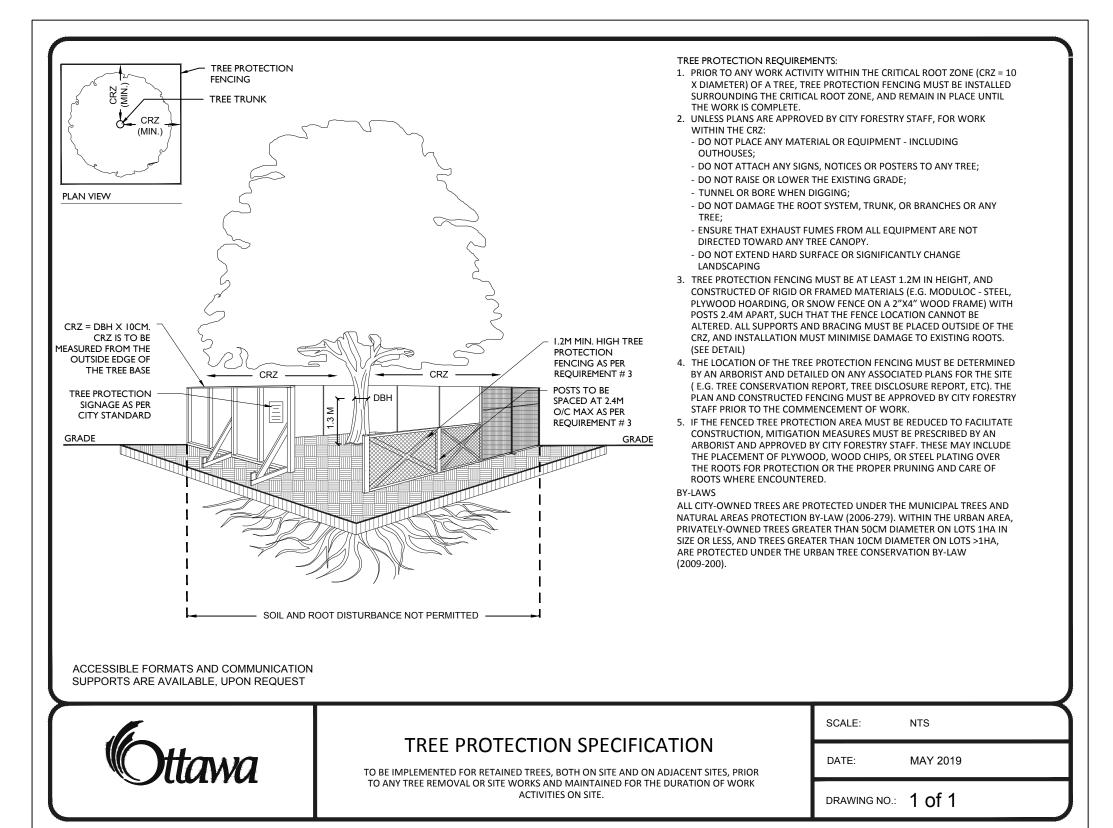

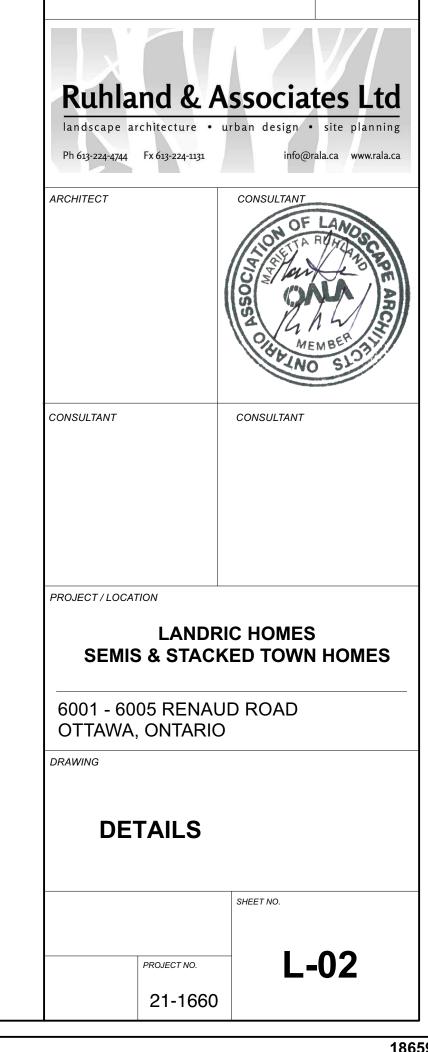


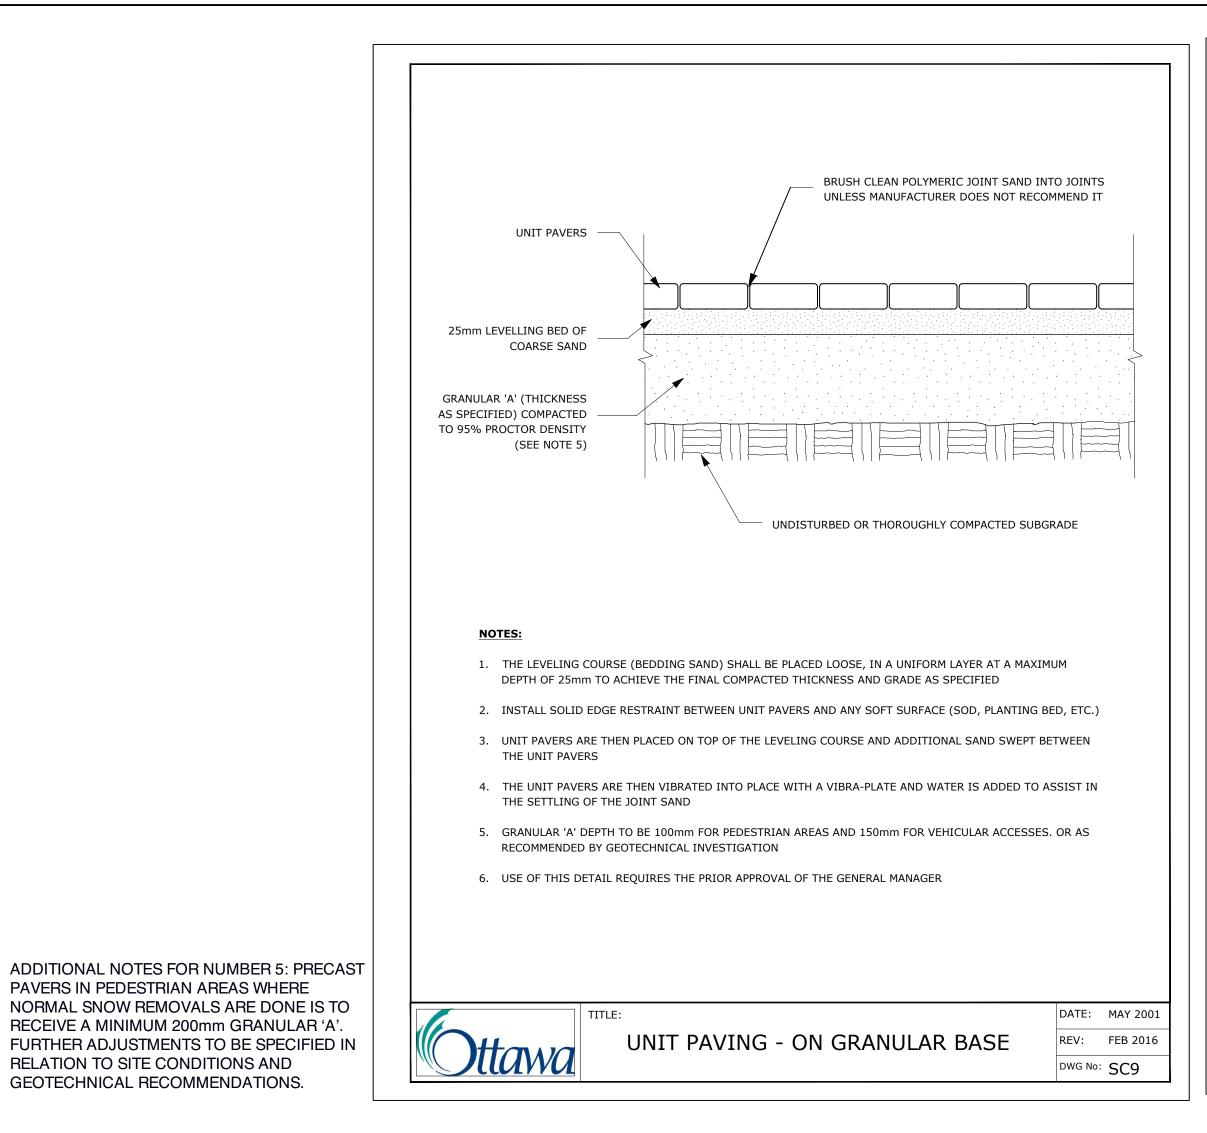



PAVERS IN PEDESTRIAN AREAS WHERE


RELATION TO SITE CONDITIONS AND


GEOTECHNICAL RECOMMENDATIONS.

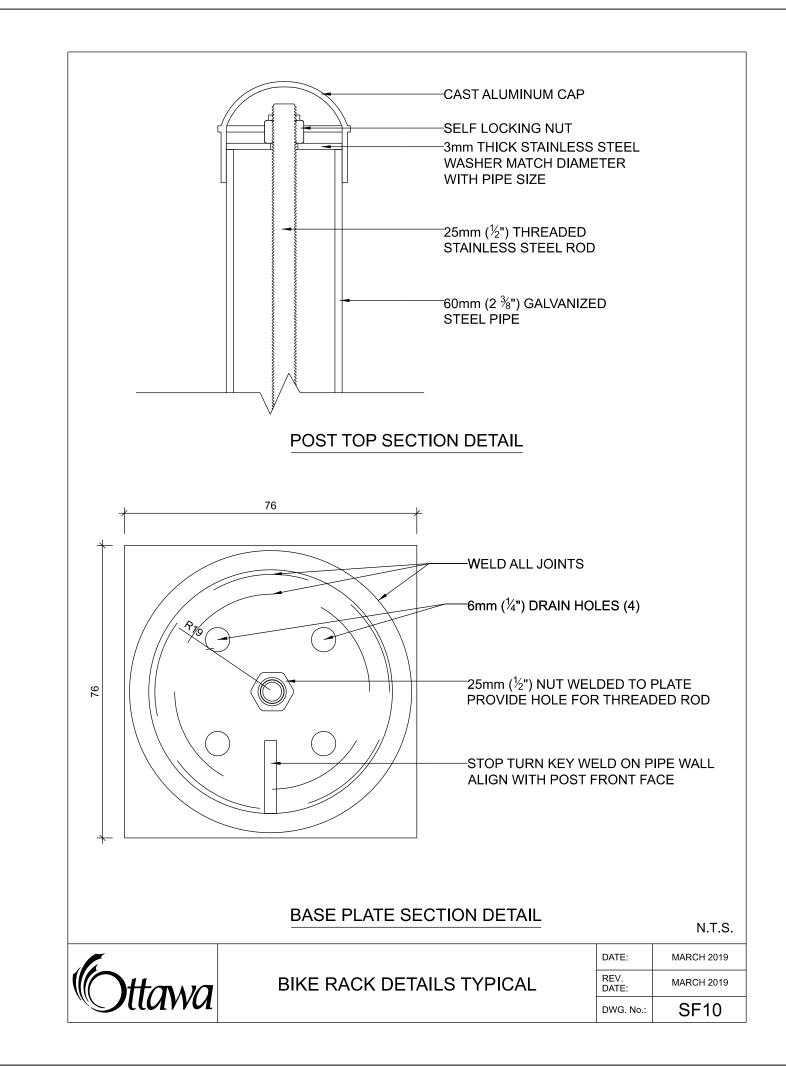

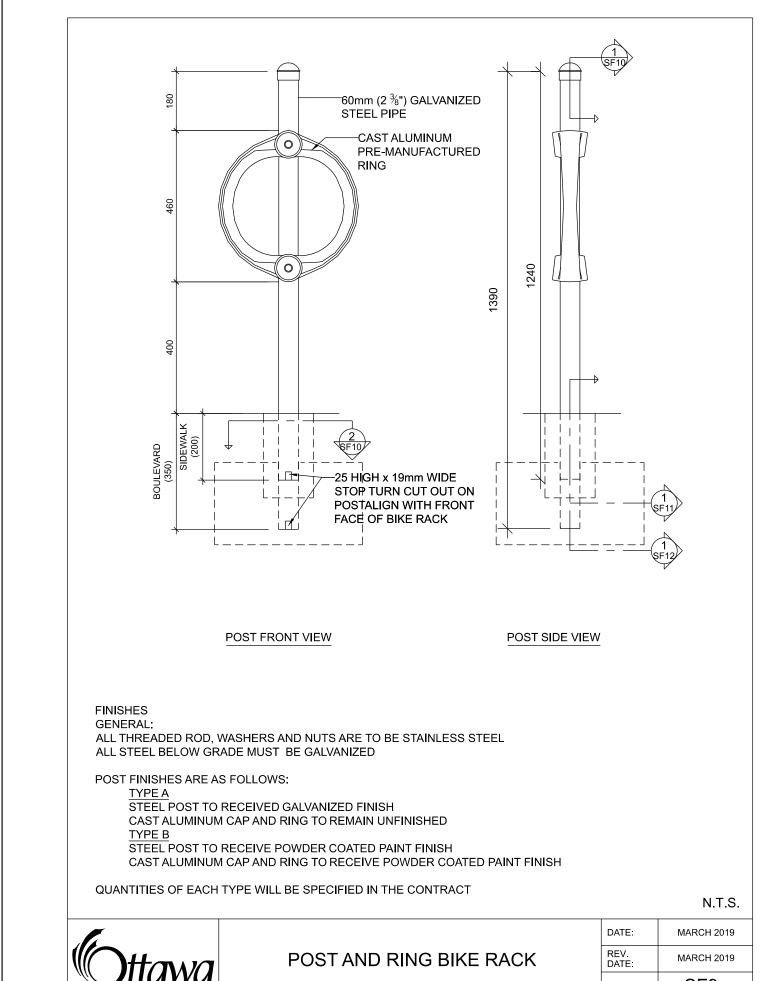

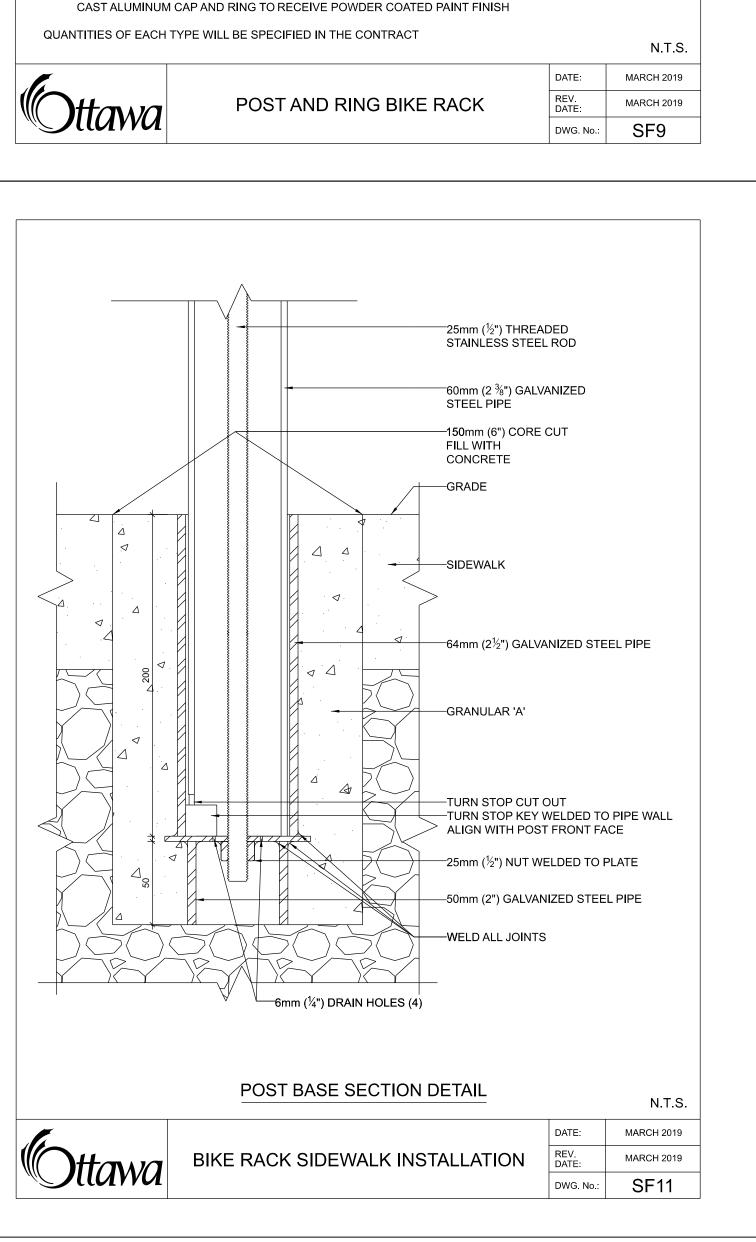

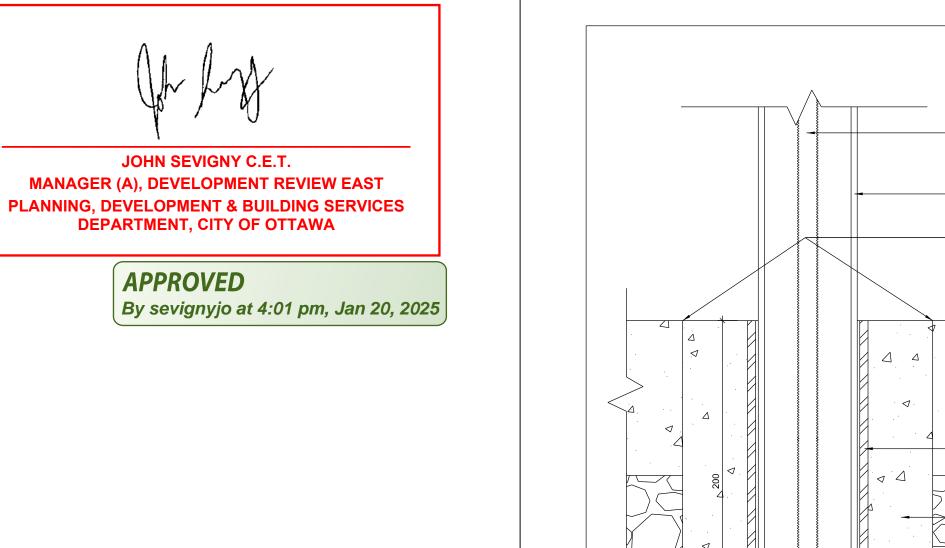

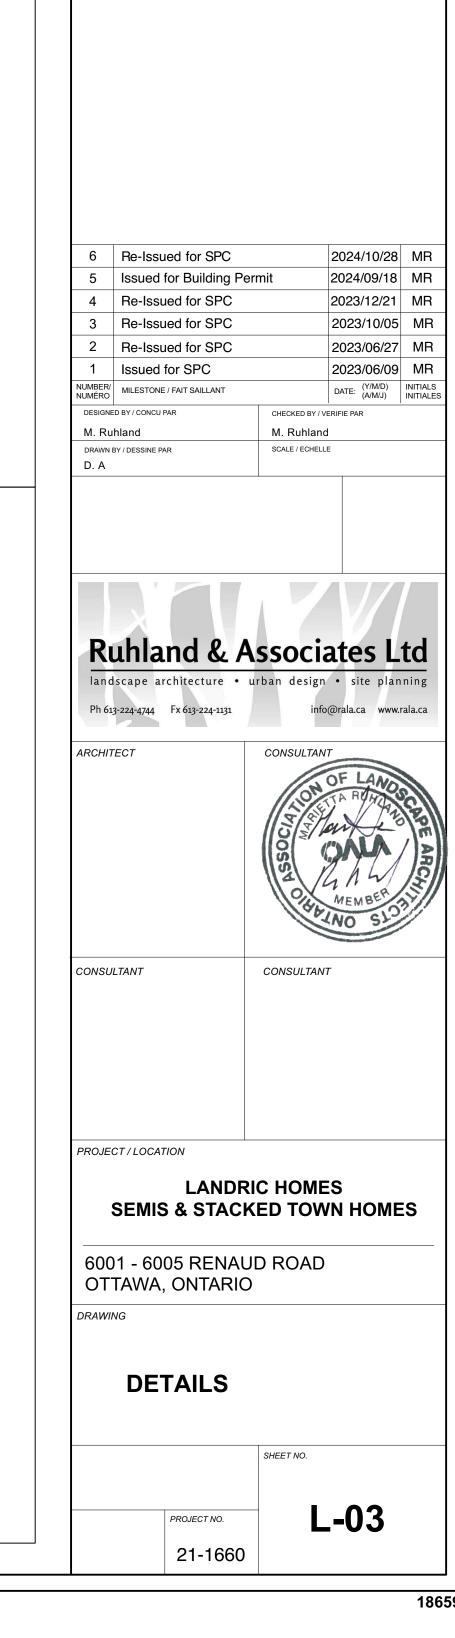

CLIENT / OWNER

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