

REMOVE	EXISTING TO REMAIN	NEW	ELECTRICAL LEGEND
₽AA	₽ AA	₽ <sup>AA</sup>	EXTERIOR LIGHT STANDARD FIXTURE. LETTER DENOTES TYPE.
⊋вв	⊋вв	О вв	WALL MOUNTED FIXTURE, LETTER DENOTES TYPE.
[ĒĒ]	PC	PC	PHOTOCELL.

ABBREVIATIONS:
WP — WEATHER PROOF
UON — UNLESS OTHERWISE NOTED
NIC — NOT IN CONTRACT

ELECT	TRICAL	DRAWING	LIST	
DAWING No.		DECODIDATION		

DRAWING No.	. DESCRIPTION				
	ELECTRICAL: LEGEND, DRAWING LIST AND DETAILS ELECTRICAL: SITE PLAN				

	LIGHTING FIXTURE SCHEDULE						
TYPE	DESCRIPTION	LAMPS	VOLT	MOUNTING	REMARKS		
AA	LED AREA FLOOD LIGHT STANDARD LITHONIA LIGHTING DSX1 SERIES	209W LED	347	POLE 5186mm	RUGGED DIE CAST ALUMINUM, TYPE DA MOUNT     4000°K     C/W BACKLIGHT CONTROL     COLOUR TO BE SELECTED BY CLIENT		
AB	LED AREA FLOOD LIGHT STANDARD LITHONIA LIGHTING DSX0 SERIES	45W LED	347	POLE 2260mm	- RUGGED DIE CAST ALUMINUM, TYPE DA MOUNT - 4000°K, TYPE II DISTRIBUTION - C/W HOUSE SIDE SHEILED - COLOUR TO BE SELECTED BY CLIENT		
ВА	LED WALL MOUNTED LIGHT FIXTURE CREE XSP—A SERIES	42.7W LED	347	WALL	- RUGGED LIGHTWEIGHT DIE CAST ALUMINUM - 4000°K, TYPE III DISTRIBUTION - COLOUR TO BE SELECTED BY CLIENT		
BB	LED WALL MOUNTED LIGHT FIXTURE CREE XSP-A SERIES	24.4W LED	347	WALL	RUGGED LIGHTWEIGHT DIE CAST ALUMINUM     4000°K, TYPE III DISTRIBUTION     COLOUR TO BE SELECTED BY CLIENT		
CC	EXISTING LIGHT STANDARD						

THESE DESIGN DOCUMENTS ARE PREPARED SOLELY FOR THE USE BY THE PARTY WITH WHOM THE DESIGN PROFESSIONAL HAS ENTERED INTO A CONTRACT AND THERE ARE NO REPRESENTATIONS OF ANY KIND MADE BY THE DESIGN
PROFESSIONAL TO ANY PARTY WITH WHOM THE
DESIGN PROFESSIONAL HAS NOT ENTERED INTO A

THE PAPER COPY OF THE DRAWINGS ISSUED FOR BUILDING PERMIT AND/OR TENDER WILL TAKE PRECEDENCE OVER ELECTRONIC COPIES.

1		1
1	SITE PLAN APPROVAL	APR 18/1
REVISION No.	DESCRIPTION	DATE



R.J. McKEE
ENGINEERING
ENGINEERING
ENGINEERING
ENGINEERING
1785 Woodward Drive
Ottawa, ON K2C 0P9
CANADA
Tel.:(613) 723-9585
Fax.:(613) 723-9584
www.mckeeottawa.ca

PROJECT:
CITANT PALLADIUM DRIVE NEW BUILDING 301 PALLADIUM DRIVE OTTAWA, ONTARIO

DRAWING: ELECTRICAL: LEGEND, DRAWING LIST AND DETAILS


DATE: MARC	H 2016
DESIGNED BY:	S. MILEK
DRAWN BY:	S. MILEK
CHECKED BY:	B.T.
SCALE: N.T.S	 S.

No. DWGS. 2 PROJECT No.

16-108

ES1

DRAWING No.

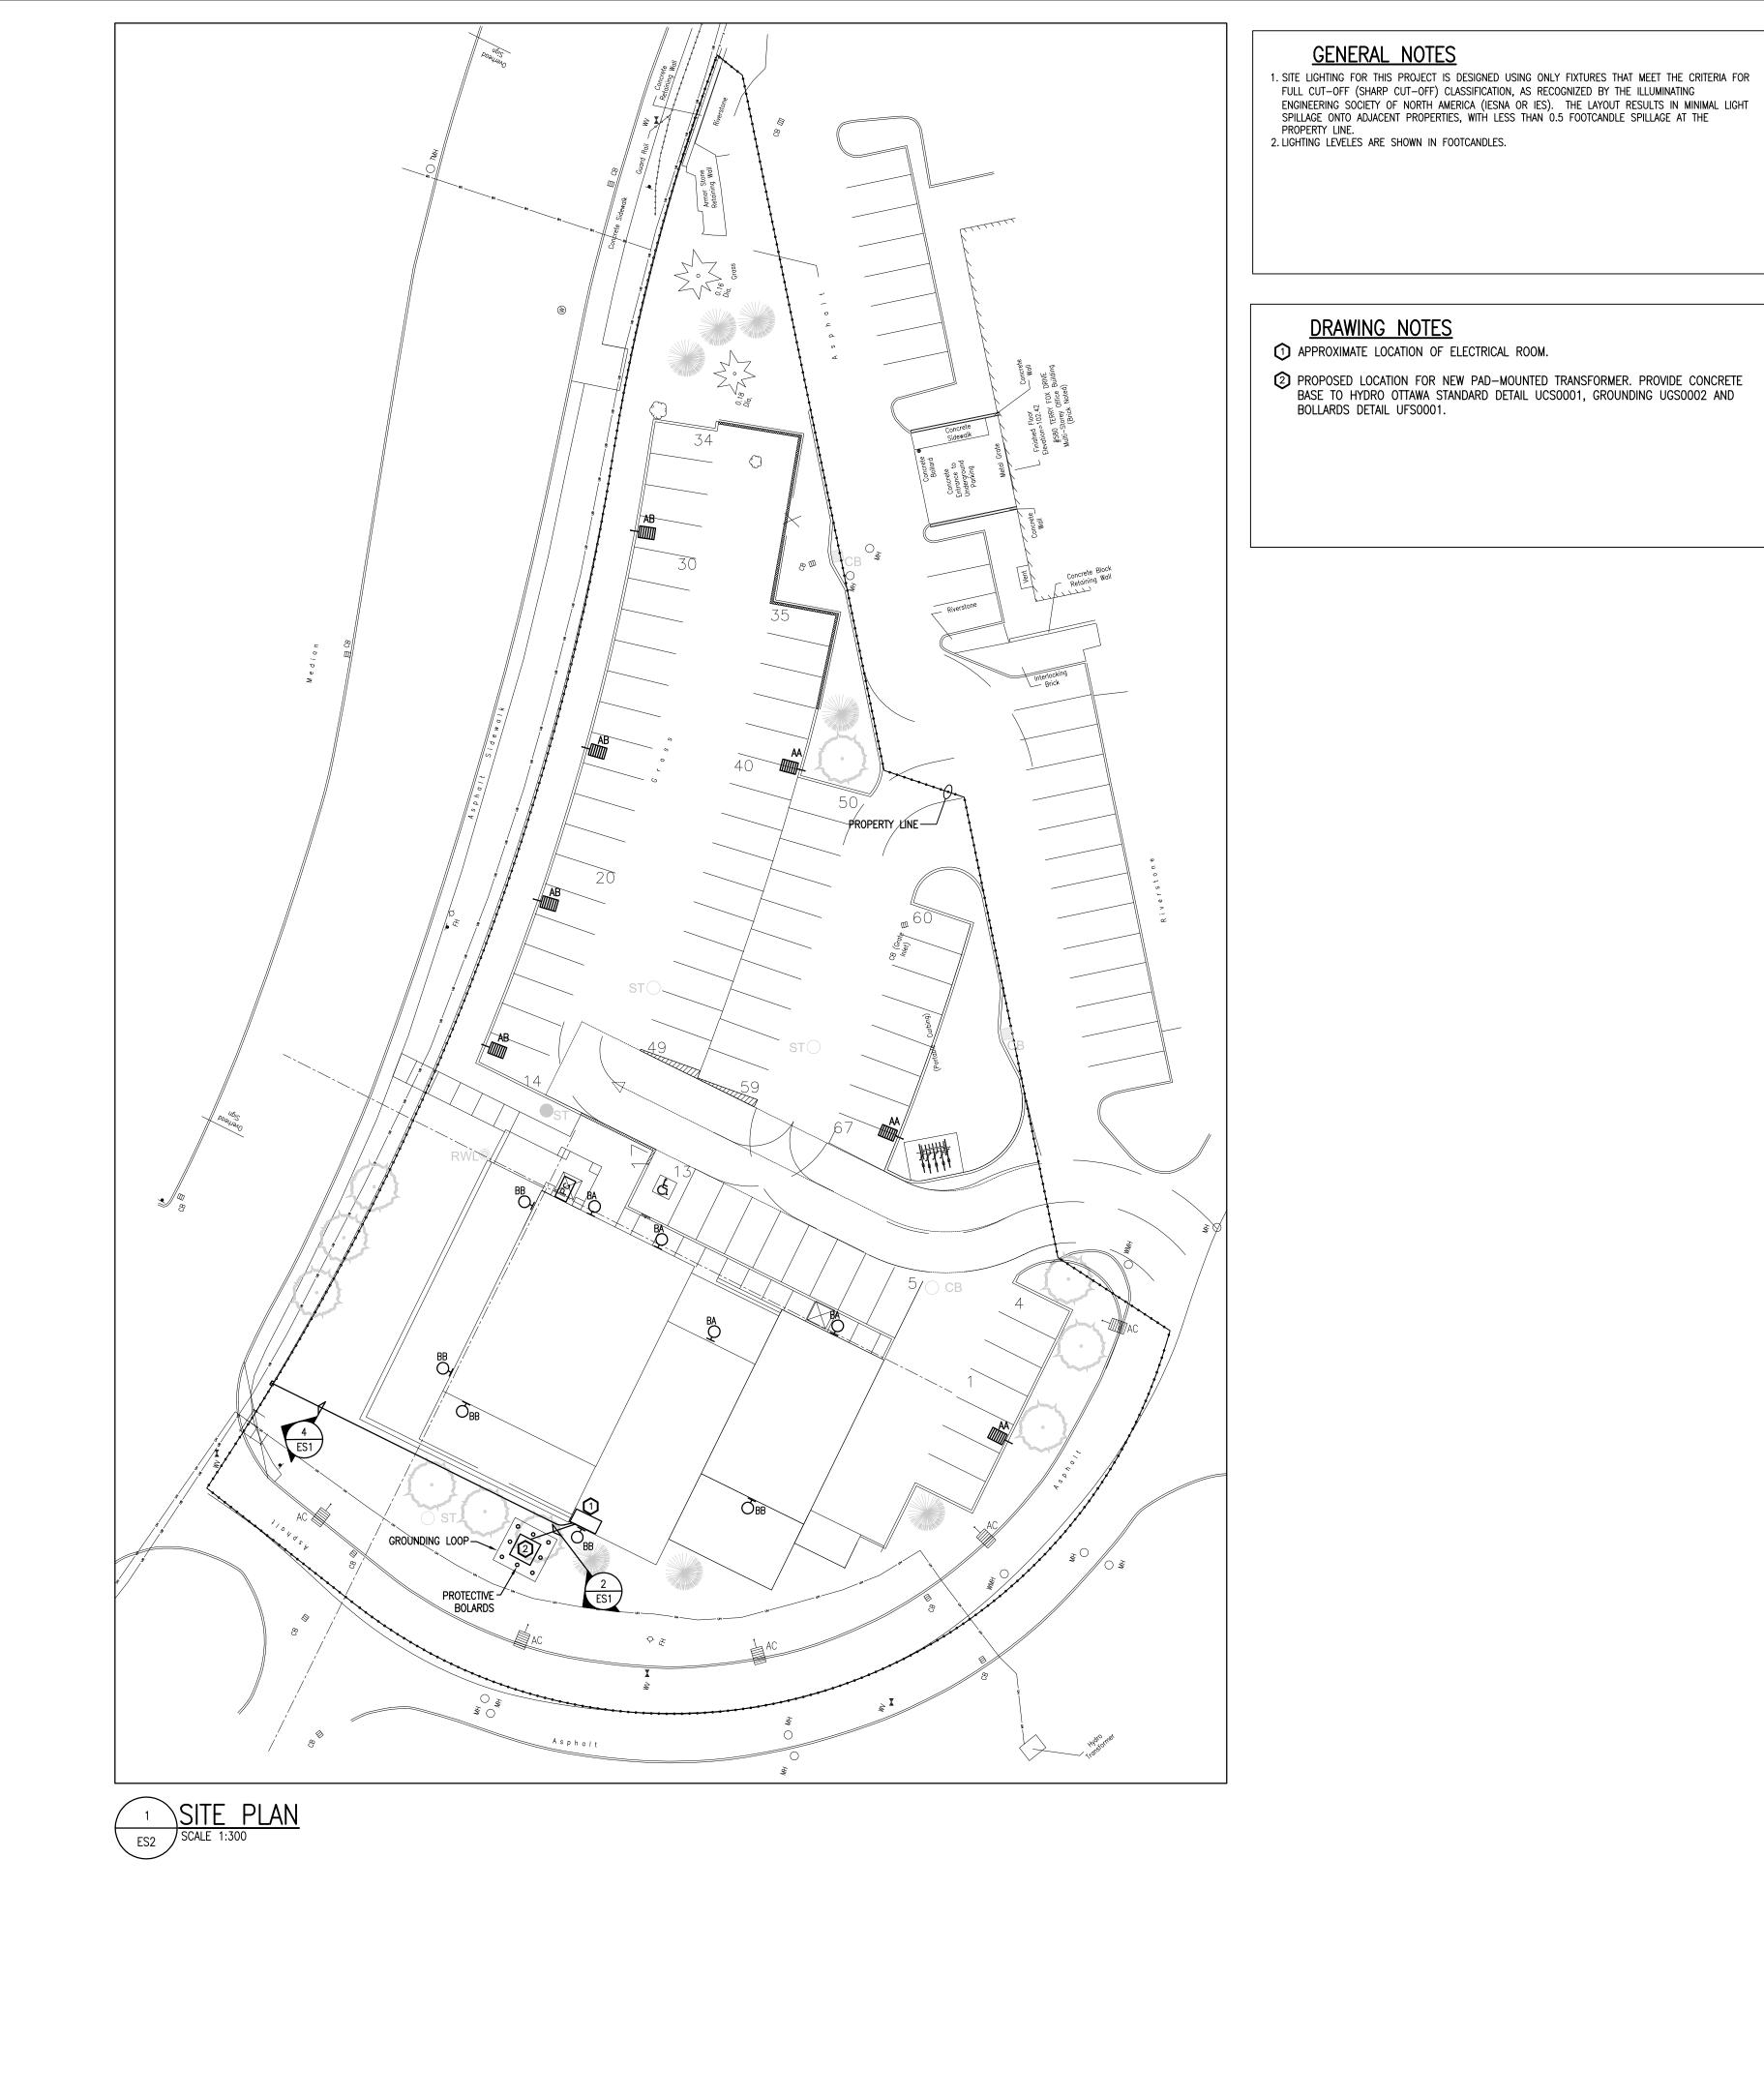

ENGINEERING SOCIETY OF NORTH AMERICA (IESNA OR IES). THE LAYOUT RESULTS IN MINIMAL LIGHT SPILLAGE ONTO ADJACENT PROPERTIES, WITH LESS THAN 0.5 FOOTCANDLE SPILLAGE AT THE

BASE TO HYDRO OTTAWA STANDARD DETAIL UCS0001, GROUNDING UGS0002 AND

THESE DESIGN DOCUMENTS ARE PREPARED SOLELY FOR THE USE BY THE PARTY WITH WHOM THE DESIGN PROFESSIONAL HAS ENTERED INTO A CONTRACT AND THERE ARE NO REPRESENTATIONS OF ANY KIND MADE BY THE DESIGN PROFESSIONAL TO ANY PARTY WITH WHOM THE DESIGN PROFESSIONAL HAS NOT ENTERED INTO A CONTRACT

THE PAPER COPY OF THE DRAWINGS ISSUED FOR BUILDING PERMIT AND/OR TENDER WILL TAKE PRECEDENCE OVER ELECTRONIC COPIES.

SITE PLAN APPROVAL DESCRIPTION

R.J. McKEE
ENGINEERING
ENGINEERING
ENGINEERING
ENGINEERING
1785 Woodward Drive
Ottawa, ON K2C 0P9
CANADA
Tel.:(613) 723-9585
Fax.:(613) 723-9584
www.mckeeottawa.ca

PROJECT:
CITANT PALLADIUM DRIVE
NEW BUILDING
301 PALLADIUM DRIVE OTTAWA, ONTARIO

DRAWING: ELECTRICAL: SITE PLAN

> DATE: MARCH 2016 DESIGNED BY: S. MILEK DRAWN BY: S. MILEK CHECKED BY: B.T. SCALE: AS SHOWN

No. DWGS. 2 PROJECT No.

DRAWING No.

16-108