



### DETAIL FOR STREET CB SILT PROTECTION

SCALE: NTS

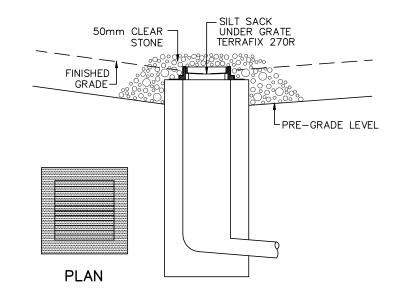

# DETAIL FOR RLCB/DICB SILT PROTECTION SCALE: NTS

#### STORM DRAIN INLET PROTECTION

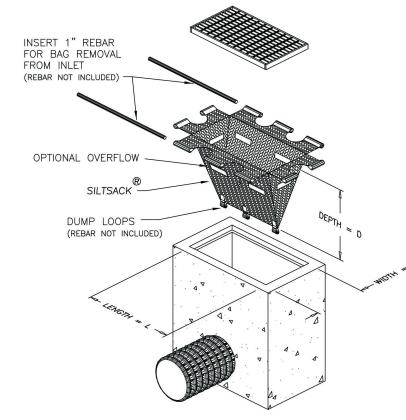

### **EROSION AND SEDIMENT CONTROL NOTES:**

PRIOR TO TOPSOIL STRIPPING, EARTHWORKS, OR UNDERGROUND CONSTRUCTION, EROSION AND SEDIMENT CONTROLS SHALL BE IMPLEMENTED TO THE SATISFACTION OF THE AUTHORITY HAVING JURISDICTION.

16500 CONC STM 82.0 @ 0.1%

BOTTOM OF BANK

BOTTOM OF BANK

SEDIMENT CONTROL FENCE SHALL BE CLEANED AND MAINTAINED IN GOOD REPAIR BY CONTRACTOR.

SEDIMENT CONTROL FENCE TO REMAIN IN PLACE UNTIL THE WORKING AREA HAS BEEN STABILIZED AND REVEGETATED.

ACCUMULATED SEDIMENT TO BE REMOVED OFF SITE PRIOR TO THE REMOVAL OF SEDIMENT CONTROL FENCE.

EROSION AND SEDIMENT CONTROL MEASURES MAY BE MODIFIED IN THE FIELD AT THE DISCRETION OF THE CITY OF OTTAWA SITE INSPECTOR OR CONSERVATION AUTHORITY PERSONNEL.

CONTRACTOR MUST USE BEST MANAGEMENT PRACTICES (BMPS) FOR EROSION AND SEDIMENT CONTROL.

THE SILTATION CONTROL PLAN IS INTENDED TO ASSIST THE CONTRACTOR IN THE LAYOUT AND CONSTRUCTION OF THE SILTATION CONTROL FEATURES ONLY. THIS DRAWING SHALL NOT BE USED FOR CONSTRUCTION OF SITE SERVICES.

### MONITORING OF SEDIMENT AND EROSION CONTROLS

MONITORING OF SEDIMENT AND EROSION CONTROLS


MONITORING AND REPORTING TO BE COMPLETED IN ACCORDANCE WITH THE MINISTRY OF THE ENVIRONMENT AND CLIMATE CHANGE (MOECC) AND RIDEAU VALLEY CONSERVATION AUTHORITY(RVCA) APPROVALS.

### MAINTENANCE PROGRAM

ALL DAMAGED ESC MEASURES SHOULD BE REPAIRED AND/OR REPLACEMENT WITHIN 48 HOURS OF THE INSPECTION.

THE ENVIRONMENTAL MONITOR IS REQUIRED TO SUBMIT UPDATES TO THE TOWN/ REGION/ CONSERVATION AUTHORITY BY EMAIL IN A TIMELY MANNER.

SEDIMENT SHOULD BE REMOVED FROM THE SEDIMENT CONTROL FENCING ONCE SEDIMENT HAS ACCUMULATED TO A LEVEL OF ONE-THIRD THE HEIGHT OF FENCING OR TO A HEIGHT OF 30 cm. ANY AMOUNT OF ACCUMULATED SEDIMENT SHOULD BE REMOVED PRIOR TO THE REMOVAL OF THE CONTROL MEASURES.

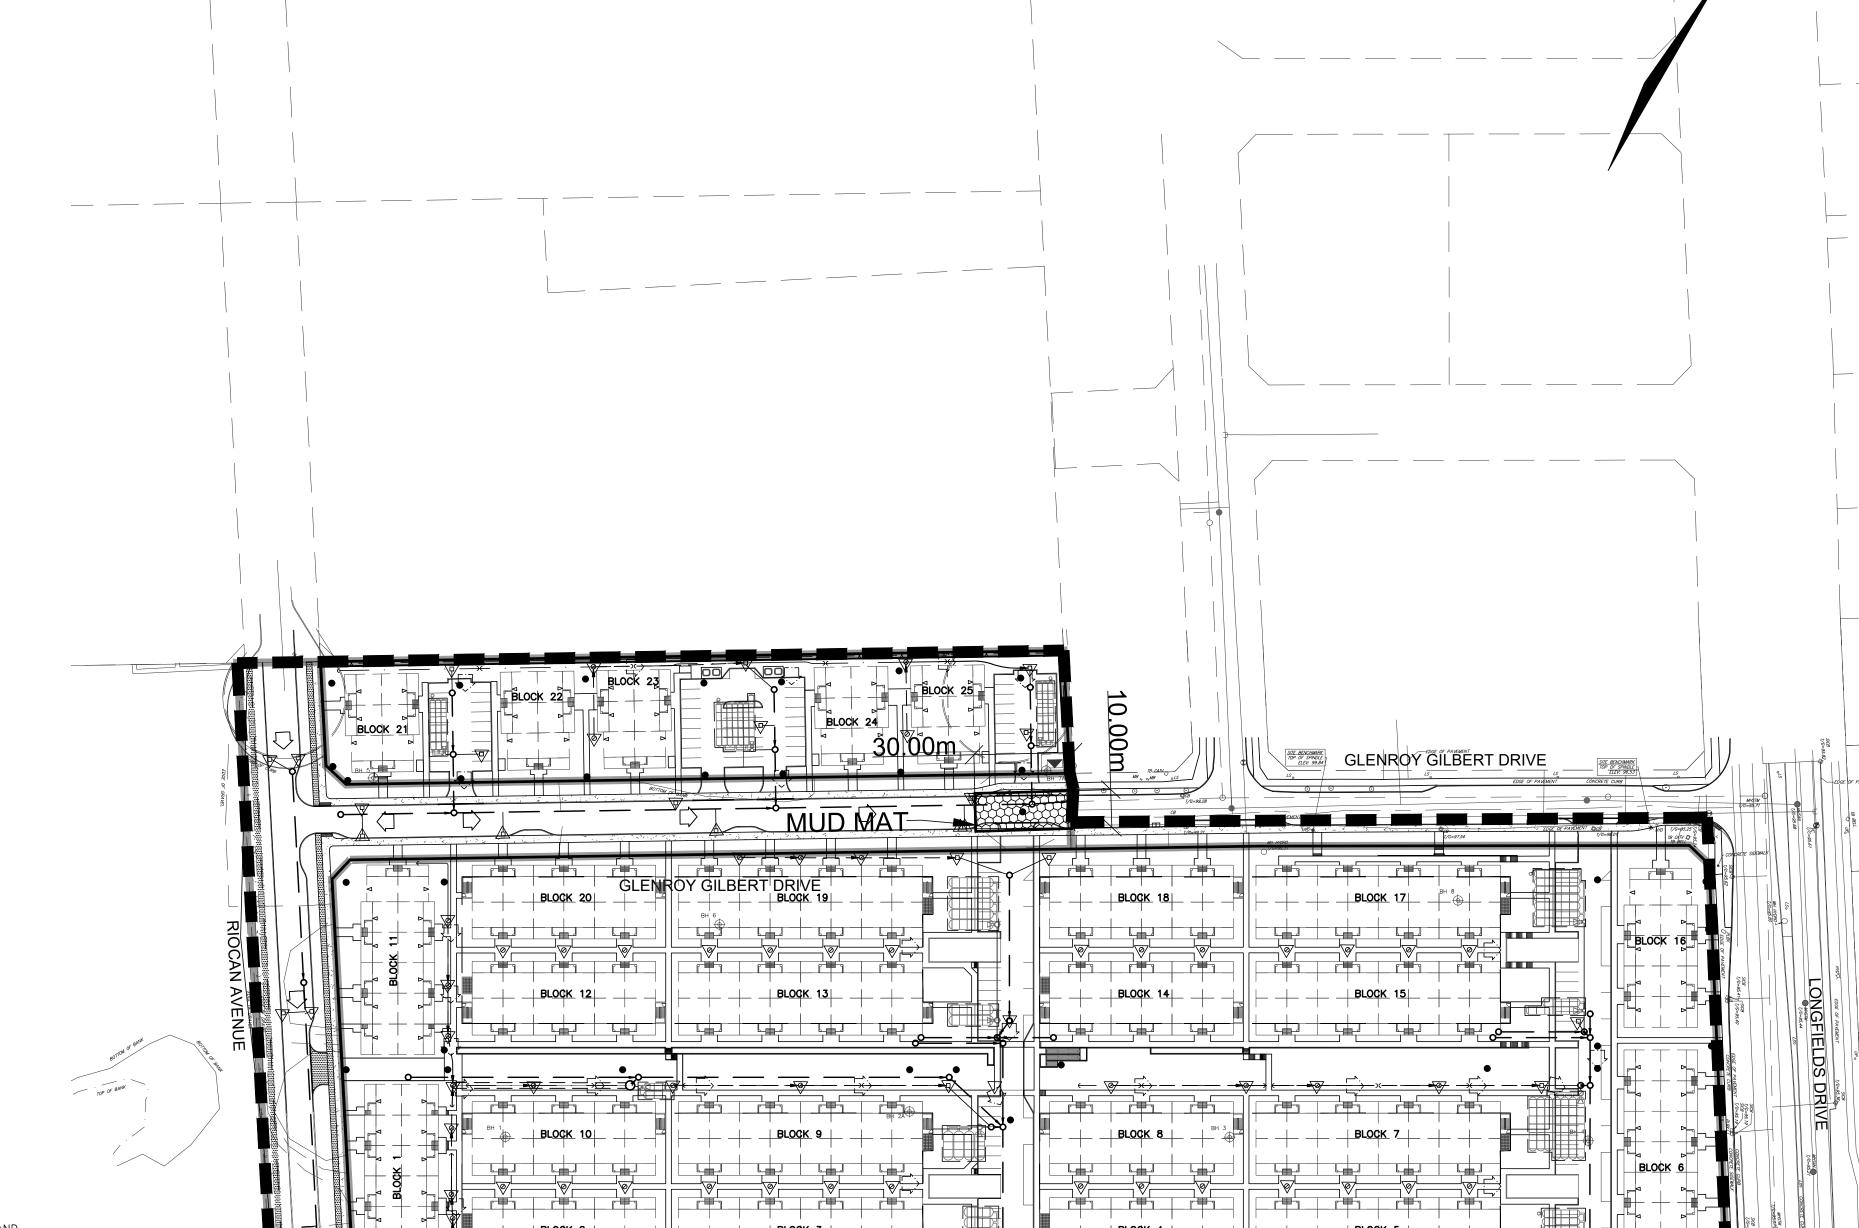

FUTURE CHAPMAN MILLS DRIVE

## NOT FOR CONSTRUCTION

ı					
-93	3	S.L.M.	23-06-30	3RD SUBMISSION	
	2	S.L.M.	23-03-10	2ND SUBMISSION	
	1	S.L.M.	22-06-10	1ST SUBMISSION	
	No.	BY	DATE	DESCRIPTION	

### TOPOGRAPHIC INFORMATION

TOPOGRAPHIC INFORMATION PROVIDED BY STANTEC GEOMATICS LTD., PROJECT No. 161614291-111 DATED MARCH 1, 2022

SITE PLAN INFORMATION

SITE PLAN PROVIDED BY SRN ARCHITECTS LTD., PROJECT No. S21001, DATED JUNE 27, 2023

FUTURE CHAPMAN MILLS DRIVE

KEY PLAN

### LEGAL INFORMATION

CALCULATED DRAFT PLAN PROVIDED BY STANTEC GEOMATICS LTD., PROJECT No. 161614291-111, DATED MAY 9, 2022

### BENCH MARK

**LEGEND** 

PROPOSED SILT FENCE

PROPOSED SNOW FENCE

PROPOSED ROCK FLOW CHECK DAM

PROPOSED STRAW BALE BARRIER WITH FILTER CLOTH

PROPOSED STRAW BALE BARRIER

SILTSACK FOR EXISTING STRUCTURE

MAJOR OVERLAND FLOW DIRECTION

PROPOSED RIP RAP TREATMENT


DITCH AND CULVERT

ELEVATIONS ARE REFERRED TO THE CANADIAN GEODETIC VERTICAL DATUM (CGVD-1928:1978) AND ARE DERIVED FROM BENCHMARK MONUMENT No. 196530071\*, HAVING A PUBLISHED ELEVATION OF 99.742 METRES

### MINTO COMMUNITIES

BARRHAVEN TOWN CENTRE
GLENROY GILBERT DRIVE RIOCAN
AVENUE & CHAPMAN MILLS DRIVE
EXTENSION



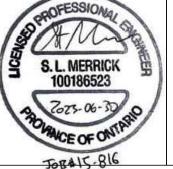



110 Laurier Ave W Ottawa, Ontario, K1P 1J1 Tel. (613) 580-2400 www.Ottawa.ca

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CITY ROW EROSION AND SEDIMENT CONTROL PLAN STAGE 2

DRAWN BY:	AM	CHECKED BY:	BC	PROJECT No.
DESIGNED BY:	BC	CHECKED BY:	SM	15-816
SCALE:	1:1000			
SCALL.	1.1000			SHEET NO

5-816 15