

NOTE:
A GEOTECHNICAL ENGINEER LICENSED IN THE PROVINCE OF ONTARIO IS TO INSPECT ALL SUBGRADE SURFACES FOR FOOTING AND PAVEMENT STRUCTURES PRIOR TO CONSTRUCTION

NOTE:
ALL EXISTING POST & WIRE FENCE, CULVERTS, UTILITY WIRE / POLES, TREES, SHRUBS ETC. WITHIN LOTS, BLOCKS AND ROADS TO BE REMOVED, UNLESS OTHERWISE NOTED

NOTE RE: PERFORATED PIPE
PERFORATED PIPE IS REQUIRED FOR SWALE SLOPE LESS THAN 1.5%. REFER TO CITY STD. S29, S30 FOR REAR YARD TRENCH AND PIPE DETAIL ONLY

NOTE:
ALL SWALES SHALL BE 0.15m DEEP WITH 3:1 SIDE SLOPES UNLESS OTHERWISE INDICATED

ANY DISTURBED AREA DURING CONSTRUCTION TO BE RESTORED TO ORIGINAL CONDITION OR BETTER TO THE SATISFACTION OF THE AUTHORITIES HAVING JURISDICTION

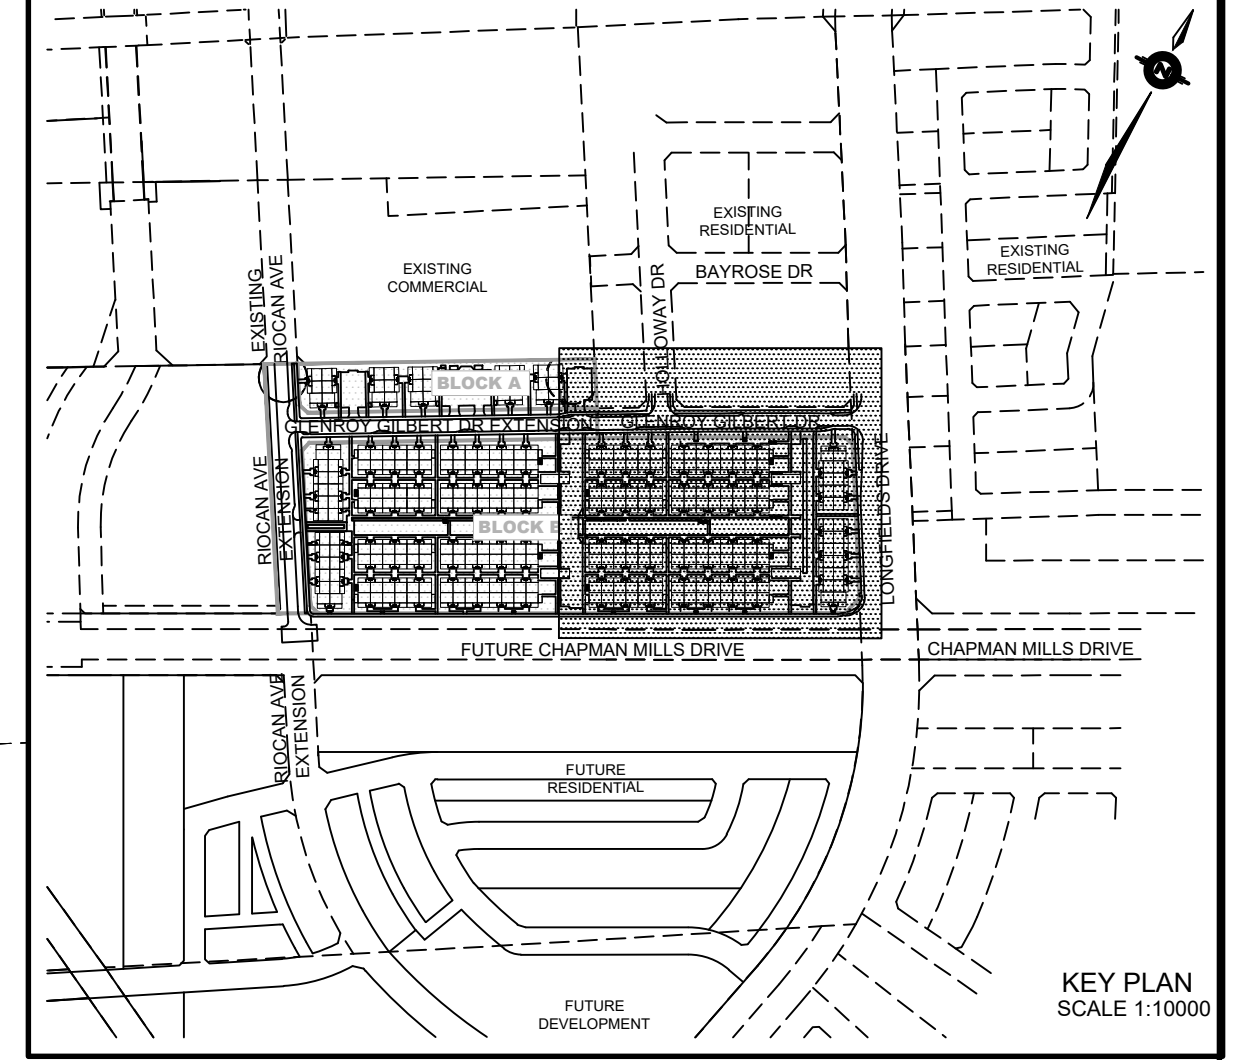
NOTE:
REFER TO DETAIL ON DWG 2 FOR FURTHER DETAILS ON SERVICES TO THE STACKED TOWNHOMES

NOTE:
REFER TO CITY STD. SC7.1 FOR DRIVEWAY DETAIL

NOTE:
ENTRANCES TO PRIVATE SITE PER SC7.1

CONTRACTOR TO VERIFY THE PRECISE LOCATIONS AND INVERT ELEVATIONS OF EX. UNDERGROUND SERVICES AND EX. UTILITIES PRIOR TO STARTING CONSTRUCTION

PERMISSION REQUIRED FOR WORK ON ADJACENT LANDS



LEGEND

PROPOSED ELEVATION	103.45	OVERLAND FLOW DIRECTION	→
EXISTING ELEVATION	102.73	EXTERNAL OVERLAND FLOW DIRECTION	→
FUTURE ELEVATION	[93.90]	EMERGENCY OVERLAND FLOW DIRECTION	→
PROPOSED SWALE GRADE	1.5%	RETAINING WALL AND ELEVATIONS	1/6=103.10 8/6=102.44
HIGH POINT	102.16	CHAINLINK FENCE (1.5m UNLESS OTHERWISE NOTED)	— —
STREET CATCHBASIN		NOISE BARRIER (3.0m UNLESS OTHERWISE NOTED)	— —
STREET CATCHBASIN WITH CLOSED LID		DECORATIVE FENCE (SEE LANDSCAPE DWGS FOR DETAIL)	— —
CATCHBASIN MANHOLE		CONSTRUCTION FENCE	— —
TIE CATCHBASIN		PROPERTY BOUNDARY	— —
ELBOW CATCHBASIN		3:1 RETAINING MAXIMUM SLOPE	3:1
HYDRANT, VALVE & VB		PRV FLOODING AREA WITH SPILLWAY ELEVATION (MAXIMUM 0.30m)	— —
VALVE & VC		W.O.	— —
VALVE & VB		50G	— —
BUILDING ENVELOPE		250# PVC PERFORATED PIPE (REFER TO CITY STD S29 FOR REAR YARD TRENCH AND PIPE DETAILS ONLY)	— —
TOP OF FOUNDATION (TOF)		SUBIRAN APPLIED FOR SLOPE LESS THAN 1.5%	— —
FINISHED FLOOR ELEVATION (FFE)			
UNDERSIDE OF FOOTING ELEVATION (USF)			
UNITS REQUIRING WATER PRESSURE REDUCING VALVES			
WALKOUT UNITS			
HYDRO SWITCHGEAR			
HYDRO TRANSFORMER			
STREET LIGHT STANDARD			
TACTILE WALKING SURFACE INDICATOR (AS PER CITY OF OTTAWA STD. SC6)			
PREVIOUS PHASES / PHASES NOT PART OF CURRENT GRADING APPROVAL			

NOT FOR CONSTRUCTION

No.	BY	DATE	DESCRIPTION
3	S.L.M.	23-06-30	3RD SUBMISSION
2	S.L.M.	23-03-10	2ND SUBMISSION
1	S.L.M.	22-06-10	1ST SUBMISSION

TOPOGRAPHIC INFORMATION
TOPOGRAPHIC INFORMATION PROVIDED BY STANTEC GEOMATICS LTD., PROJECT No. 161614291-111, DATED MARCH 1, 2022

SITE PLAN INFORMATION
SITE PLAN PROVIDED BY SRN ARCHITECTS LTD., PROJECT No. S21001, DATED JUNE 27, 2023

LEGAL INFORMATION
CALCULATED DRAFT PLAN PROVIDED BY STANTEC GEOMATICS LTD., PROJECT No. 161614291-111, DATED MAY 9, 2022

BENCH MARK
ELEVATIONS ARE REFERRED TO THE CANADIAN GEODETIC VERTICAL DATUM (CGVD-1928:1978) AND ARE DERIVED FROM BENCHMARK MONUMENT No. 196530071*, HAVING A PUBLISHED ELEVATION OF 99.742 METRES

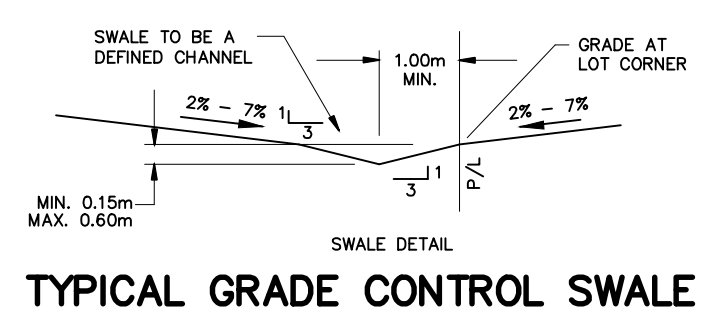
MINTO COMMUNITIES INC. BARRHAVEN TOWN CENTRE STAGE 1

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GRADING PLAN EAST

DRAWN BY: AM	CHECKED BY: BC	PROJECT No. 15-816
DESIGNED BY: BC	CHECKED BY: SM	SHEET No. 6
SCALE: 1:400		



CITY PLAN No. 18822
D07-12-22-0104