

NOTES: GENERAL

- 1. DRAWINGS TO BE READ IN CONJUNCTION WITH ARCHITECTURAL AND LANDSCAPE DRAWINGS
2. ALL SERVICES, MATERIALS, CONSTRUCTION METHODS AND INSTALLATIONS SHALL BE IN ACCORDANCE WITH THE LATEST STANDARDS AND REGULATIONS OF THE CITY OF OTTAWA STANDARD SPECIFICATIONS AND DRAWINGS, ONTARIO PROVINCIAL SPECIFICATION STANDARD SPECIFICATION (OPSS) AND ONTARIO PROVINCIAL STANDARD DRAWINGS (OPSD), UNLESS OTHERWISE SPECIFIED, TO THE SATISFACTION OF THE CITY AND THE CONSULTANT
3. THE POSITION OF EXISTING POLE LINES, CONDUITS, WATERMANS, SEWERS AND OTHER UNDERGROUND AND ABOVEGROUND UTILITIES, STRUCTURES AND APPURTENANCES IS NOT NECESSARILY SHOWN ON THE CONTRACT DRAWING, AND WHERE SHOWN, THE ACCURACY OF THE POSITION OF SUCH UTILITIES AND STRUCTURES IS NOT GUARANTEED, PRIOR TO CONSTRUCTION, THE CONTRACTOR SHALL SATISFY HIMSELF OF THE EXACT LOCATION OF ALL SUCH UTILITIES AND STRUCTURES, AND SHALL ASSUME ALL LIABILITY FOR DAMAGE TO THEM DURING THE COURSE OF CONSTRUCTION, ANY RELOCATION OF EXISTING UTILITIES REQUIRED BY THE DEVELOPMENT OF SUBJECT LANDS IS TO BE UNDERTAKEN AT CONTRACTOR'S EXPENSE
4. THE CONTRACTOR MUST NOTIFY ALL EXISTING UTILITY COMPANY OFFICIALS FIVE (5) BUSINESS DAYS PRIOR TO START OF CONSTRUCTION AND HAVE ALL EXISTING UTILITIES AND SERVICES LOCATED IN THE FIELD OR EXPOSED PRIOR TO THE START OF CONSTRUCTION, INCLUDING BUT NOT LIMITED TO POWER, COMMUNICATION AND GAS LINES
5. ALL TRENCHING AND EXCAVATIONS TO BE IN ACCORDANCE WITH THE LATEST REVISIONS OF THE OCCUPATIONAL HEALTH AND SAFETY ACT AND REGULATIONS FOR CONSTRUCTION PROJECTS AND AS PER THE RECOMMENDATIONS INCLUDED IN THE GEOTECHNICAL REPORT
6. REFER TO ARCHITECTS PLANS FOR BUILDING DIMENSIONS, LAYOUT AND REMOVALS. REFER TO LANDSCAPE PLAN FOR LANDSCAPED DETAILS AND OTHER RELEVANT INFORMATION. ALL INFORMATION SHALL BE CONFIRMED PRIOR TO COMMENCEMENT OF CONSTRUCTION
7. TOPOGRAPHIC SURVEY COMPLETED AND PROVIDED BY ANNIS, O'SULLIVAN, VOLLEBERG LTD. DATED ON MARCH 5, 2020. CONTRACTOR TO VERIFY IN THE FIELD PRIOR TO CONSTRUCTION OF ANY WORK AND NOTIFY THE ENGINEER OF ANY DISCREPANCIES
8. ALL ELEVATIONS ARE GEODETIC AND UTILIZE METRIC UNITS. VERIFY THAT JOB BENCHMARKS HAVE NOT BEEN ALTERED OR DISTURBED
9. ALL GROUND SURFACES SHALL BE EVENLY GRADED WITHOUT PONDING AREAS AND WITHOUT LOW POINTS EXCEPT WHERE APPROVED SWALE OR CATCH BASIN OUTLETS ARE PROVIDED
10. ALL EDGES OF DISTURBED PAVEMENT SHALL BE SAW CUT TO FORM A NEAT AND STRAIGHT LINE PRIOR TO PLACING NEW PAVEMENT. PAVEMENT REINSTATEMENT SHALL BE WITH STEP JOINTS OF 500mm WIDTH MINIMUM
11. ALL DISTURBED AREAS OUTSIDE PROPOSED GRADING LIMITS TO BE RESTORED TO ORIGINAL ELEVATIONS AND CONDITIONS UNLESS OTHERWISE SPECIFIED. ALL RESTORATION SHALL BE COMPLETED WITH THE GEOTECHNICAL REQUIREMENTS FOR BACKFILL AND COMPACTION
12. ABUTTING PROPERTY GRADES TO BE MATCHED UNLESS OTHERWISE SHOWN
13. CONTRACTOR SHALL OBTAIN AND PAY FOR ALL NECESSARY PERMITS AND APPROVALS FROM THE MUNICIPAL AUTHORITIES PRIOR TO COMMENCING CONSTRUCTION, INCLUDING WATER PERMIT AND ROAD CUT PERMIT
14. MINIMIZE DISTURBANCE TO EXISTING VEGETATION DURING THE EXECUTION OF ALL WORKS
15. REMOVE FROM SITE ALL EXCESS EXCAVATED MATERIAL UNLESS OTHERWISE DIRECTED FROM THE ENGINEER, EXCAVATE AND REMOVE ALL ORGANIC MATERIAL AND DEBRIS LOCATED WITHIN THE PROPOSED BUILDING, PARKING AND ROADWAY LOCATIONS
16. AT PROPOSED UTILITY CONNECTION POINTS AND CROSSINGS (I.E. STORM SEWER, SANITARY SEWER, WATER, ETC.) THE CONTRACTOR SHALL DETERMINE THE PRECISE LOCATION AND DEPTH OF EXISTING UTILITIES AND REPORT ANY DISCREPANCIES OR CONFLICTS TO THE ENGINEER BEFORE COMMENCING WORK
17. CONTRACTOR TO OBTAIN POST-CONSTRUCTION TOPOGRAPHIC SURVEY, COMPLETED BY OLS OR PENS CONFIRMING COMPLIANCE WITH DESIGN GRADING AND SERVICING. SURVEY IS TO INCLUDE LOCATION AND INVERTS FOR BURIED UTILITIES
18. ABIDE BY RECOMMENDATIONS OF GEOTECHNICAL REPORT. REPORT ANY VARIATIONS IN OBSERVED CONDITIONS FROM THOSE INCLUDED IN REPORT
19. REPORT REFERENCES
I. DESIGN BRIEF, WATERIDGE VILLAGE AT ROCKCLIFFE PHASE 1B, PREPARED BY IBI GROUP, PROJ. NO. 38295-5.2.2, JUNE 16, 2017
II. DESIGN BRIEF, WATERIDGE VILLAGE AT ROCKCLIFFE PHASE 2B, PREPARED BY IBI GROUP, PROJ. NO. 118863-5.2.2, APRIL 2019
III. SUBSURFACE INVESTIGATION REPORT, PREPARED BY YURI MENDEZ ENGINEERING, MEMO NO. 44-8HH-R0, MAY 24, 2022
20. PROVIDE CCTV INSPECTION REPORT FOR ALL SEWERS AND CATCHBASIN LEADS 200mm DIAMETER AND LARGER. REPEAT CCTV INSPECTION FOLLOWING RECTIFICATION OF ANY DEFICIENCIES

NOTES: EROSION AND SEDIMENT CONTROL

\*\* CONTRACTOR IS RESPONSIBLE FOR ALL INSTALLATION, MONITORING, REPAIR AND REMOVAL OF ALL EROSION AND SEDIMENT CONTROL FEATURES. \*\*

1. PRIOR TO START OF CONSTRUCTION:

- 1.1. INSTALL SILT FENCE IN LOCATION SHOWN ON DWG C206 AND DWG C207
1.2. INSTALL FILTER FABRIC OR SILT SACK FILTERS IN ALL THE CATCHBASINS AND MANHOLES TO REMAIN DURING CONSTRUCTION WITHIN THE SITE (SEE TYPICAL DETAIL)
1.3. INSPECT MEASURES IMMEDIATELY AFTER INSTALLATION
2. DURING CONSTRUCTION:

- 2.1. MINIMIZE THE EXTENT OF DISTURBED AREAS AND THE DURATION OF EXPOSURE AND IMPACTS TO EXISTING GRADING
2.2. PERIMETER VEGETATION TO REMAIN IN PLACE UNTIL PERMANENT STORM WATER MANAGEMENT IS IN PLACE. OTHERWISE, IMMEDIATELY INSTALL SILT FENCE WHEN THE EXISTING SITE IS DISTURBED AT THE PERIMETER
2.3. PROTECT DISTURBED AREAS FROM OVERLAND FLOW BY PROVIDING TEMPORARY SWALES TO THE SATISFACTION OF THE FIELD ENGINEER. TIE-IN TEMPORARY SWALES TO EXISTING CPSS AS REQUIRED
2.4. PROVIDE TEMPORARY COVER SUCH AS SEEDING OR MULCHING IF DISTURBED AREA WILL NOT BE REHABILITATED WITHIN 30 DAYS
2.5. INSPECT SILT FENCES, FILTER FABRIC FILTERS AND CATCH BASIN SUMPS WEEKLY AND WITHIN 24 HOURS AFTER A STORM EVENT. CLEAN AND REPAIR WHEN NECESSARY
2.6. DRAWING TO BE REVIEWED AND REVISED AS REQUIRED DURING CONSTRUCTION
2.7. EROSION CONTROL FENCING TO BE ALSO INSTALLED AROUND THE BASE OF ALL STOCKPILES
2.8. DO NOT LOCATE TOPSOIL PILES AND EXCAVATION MATERIAL CLOSER THAN 2.5m FROM ANY PAVED SURFACE OR ONE WHICH IS TO BE PAVED BEFORE THE PILE IS REMOVED. ALL TOPSOIL PILES ARE TO BE SEEDED IF THEY ARE TO REMAIN ON SITE LONG ENOUGH FOR SEEDS TO GROW (LONGER THAN 30 DAYS)
2.9. CONTROL WIND-BLOWN DUST OFF SITE BY SEEDING TOPSOIL PILES AND OTHER AREAS TEMPORARILY (PROVIDE WATERING AS REQUIRED AND TO THE SATISFACTION OF THE ENGINEER)
2.10. NO ALTERNATE METHODS OF EROSION PROTECTION SHALL BE PERMITTED UNLESS APPROVED BY THE FIELD ENGINEER
2.11. CITY ROADWAY AND SIDEWALK TO BE CLEARED OF ALL SEDIMENT FROM VEHICULAR TRACKING AS REQUIRED
2.12. DURING WET CONDITIONS, TIRES OF ALL VEHICLES/EQUIPMENT LEAVING THE SITE ARE TO BE SCRAPPED
2.13. ANY MUD/MATERIAL TRACKED ONTO THE ROAD SHALL BE REMOVED IMMEDIATELY BY HAND OR RUBBER TIRE LOADER
2.14. TAKE ALL NECESSARY STEPS TO PREVENT BUILDING MATERIAL, CONSTRUCTION DEBRIS OR WASTE BEING SPILLED OR TRACKED ONTO ADJACENT PROPERTIES OR PUBLIC STREETS DURING CONSTRUCTION AND PROCEED IMMEDIATELY TO CLEAN UP ANY AREAS SO AFFECTED
2.15. ALL EROSION CONTROL STRUCTURE TO REMAIN IN PLACE UNTIL ALL DISTURBED GROUND SURFACES HAVE BEEN STABILIZED EITHER BY PAVING OR RESTORATION OF VEGETATIVE GROUND COVER
2.16. THE CONTRACTOR SHALL IMPLEMENT BEST MANAGEMENT PRACTICES, TO PROVIDE FOR PROTECTION OF THE AREA DRAINAGE SYSTEM AND THE RECEIVING WATERCOURSE, DURING CONSTRUCTION ACTIVITIES. THE CONTRACTOR ACKNOWLEDGES THAT FAILURE TO IMPLEMENT APPROPRIATE EROSION AND SEDIMENT CONTROL MEASURES MAY BE SUBJECT TO PENALTIES IMPOSED BY ANY APPLICABLE REGULATORY AGENCY

NOTES: WATERMAIN

- 1. ALL WATERMAIN AND WATERMAIN APPURTENANCES, MATERIALS, CONSTRUCTION AND TESTING METHODS SHALL CONFORM TO THE CURRENT CITY OF OTTAWA AND MINISTRY OF ENVIRONMENT STANDARDS AND SPECIFICATIONS
2. ALL WATERMAIN 300mm DIAMETER AND SMALLER TO BE POLY VINYL CHLORIDE (PVC) CLASS 150 DR 18 MEETING AWMA SPECIFICATION C900
3. ALL WATERMAIN TO BE INSTALLED AT MINIMUM COVER OF 2.4m BELOW FINISHED GRADE, WHERE WATERMANS CROSS OVER OTHER UTILITIES, A MINIMUM 0.30m CLEARANCE SHALL BE MAINTAINED, WHERE WATERMANS CROSS UNDER OTHER UTILITIES, A MINIMUM 0.50m CLEARANCE SHALL BE MAINTAINED, WHERE THE MINIMUM SEPARATION CANNOT BE ACHIEVED, THE WATERMAIN SHALL BE INSTALLED AS PER CITY OF OTTAWA STANDARDS W25 AND W25.2, WHERE 2.4m MINIMUM DEPTH CANNOT BE ACHIEVED, THERMAL INSULATION SHALL BE PROVIDED AS PER CITY OF OTTAWA STANDARD W22, WHERE A WATERMAIN IS IN CLOSE PROXIMITY TO AN OPEN STRUCTURE, THERMAL INSULATION SHALL BE PROVIDED AS PER CITY OF OTTAWA STANDARD W23
4. CONCRETE THRUST BLOCKS AND MECHANICAL RESTRAINTS ARE TO BE INSTALLED AT ALL TEES, BENDS, HYDRANTS, REDUCERS, ENDS OF MAINS AND CONNECTIONS 100mm AND LARGER, IN ACCORDANCE WITH CITY OF OTTAWA STANDARDS W25.3 & W25.4
5. CATHODIC PROTECTION REQUIRED FOR ALL IRON FITTINGS AS PER CITY OF OTTAWA STANDARD W40 & W42
6. ALL VALVES AND VALVE BOXES AND CHAMBERS, HYDRANTS, AND HYDRANT VALVES AND ASSEMBLES SHALL BE INSTALLED AS PER CITY OF OTTAWA STANDARD
7. FIRE HYDRANT LOCATION AND INSTALLATION AS PER CITY OF OTTAWA STANDARD W18 & W19. CONTRACTOR TO PROVIDE FLOW TEST AND PAINTING OF NEW HYDRANT IN ACCORDANCE WITH CITY STANDARDS
8. IF WATER MAIN MUST BE DEFLECTED TO MEET ALIGNMENT, ENSURE THAT THE AMOUNT OF DEFLECTION USED IS LESS THAN HALF THAT RECOMMENDED BY THE MANUFACTURER
9. REFER TO LANDSCAPE DRAWINGS FOR IRRIGATION SYSTEM REQUIREMENTS

NOTES: SANITARY SEWER AND MANHOLES

- 10. ALL SANITARY SEWER, SANITARY SEWER APPURTENANCES AND CONSTRUCTION METHODS SHALL CONFORM TO THE CURRENT CITY OF OTTAWA STANDARDS AND SPECIFICATIONS, PROVIDE CCTV INSPECTION REPORTS FOR ALL NEW SANITARY PIPING, PROVIDE DYE TESTING FOR NEW SERVICES
11. SANITARY SEWER PIPE SIZE 150mm DIAMETER AND GREATER TO BE PVC SDR-35 UNLESS SPECIFIED OTHERWISE WITH RUBBER GASKET TYPE JOINTS IN CONFORMANCE WITH CSA B-182.2.3.4
12. SEWER BEDDING AS PER CITY OF OTTAWA DETAIL S6
13. ALL SANITARY MANHOLES 1200mm IN DIAMETER TO BE AS PER OPSD 701.01, FRAME AND COVER TO BE AS PER CITY OF OTTAWA STANDARD S25 AND S24
14. MAINTENANCE HOLE BENCHING AND PIPE OPENING ALTERNATIVES AS PER THE OPSD 701.021
15. PROVIDE WATER TIGHT COVER FOR SANMH201 AS PER OPSD 401.030
16. ANY SANITARY SEWER WITH LESS THAN 2.0m COVER REQUIRES THERMAL INSULATION AS PER CITY OF OTTAWA STANDARD W22, OR APPROVED BY THE ENGINEER

NOTES: PARKING LOT AND WORK IN PUBLIC RIGHTS OF WAY

- 1. CONTRACTOR TO REINSTATE ROAD CUTS AS PER CITY OF OTTAWA DETAIL R10
2. CONTRACTOR TO PREPARE SUBGRADE, INCLUDING PROOFROLLING, TO THE SATISFACTION OF THE GEOTECHNICAL CONSULTANT PRIOR TO THE COMMENCEMENT OF PLACEMENT OF GRANULAR B MATERIAL
3. FILL TO BE PLACED AND COMPACTED PER THE GEOTECHNICAL REPORT REQUIREMENTS
4. CONTRACTOR TO SUPPLY, PLACE AND COMPACT GRANULAR B MATERIAL IN ACCORDANCE WITH THE RECOMMENDATIONS OF THE GEOTECHNICAL CONSULTANT. CONTRACTOR TO PROVIDE CONSULTANT WITH SAMPLES OF GRANULAR B MATERIAL FOR TESTING AND CERTIFICATION FROM THE GEOTECHNICAL CONSULTANT THAT THE MATERIAL MEETS THE GRADATION REQUIREMENTS SPECIFIED IN THE GEOTECHNICAL REPORT
5. GRANULAR A MATERIAL TO BE PLACED ONLY UPON APPROVAL BY THE GEOTECHNICAL CONSULTANT OF GRANULAR B PLACEMENT
6. CONTRACTOR TO SUPPLY, PLACE AND COMPACT GRANULAR A MATERIAL IN ACCORDANCE WITH THE RECOMMENDATIONS OF THE GEOTECHNICAL CONSULTANT. CONTRACTOR TO PROVIDE CONSULTANT WITH SAMPLES OF GRANULAR A MATERIAL FOR TESTING AND CERTIFICATION FROM THE GEOTECHNICAL CONSULTANT THAT THE MATERIAL MEETS THE GRADATION REQUIREMENTS SPECIFIED IN THE GEOTECHNICAL REPORT
7. ASPHALT MATERIAL TO BE PLACED ONLY UPON APPROVAL BY THE GEOTECHNICAL CONSULTANT OF GRANULAR A PLACEMENT
8. CONTRACTOR TO SUPPLY, PLACE AND COMPACT ASPHALT MATERIAL IN ACCORDANCE WITH THE RECOMMENDATIONS OF THE GEOTECHNICAL CONSULTANT. CONTRACTOR TO PROVIDE CONSULTANT WITH SAMPLES OF ASPHALT MATERIAL FOR TESTING AND CERTIFICATION FROM THE GEOTECHNICAL CONSULTANT THAT THE MATERIAL MEETS THE REQUIREMENTS SPECIFIED IN THE GEOTECHNICAL REPORT
9. CONTRACTOR IS RESPONSIBLE FOR ESTABLISHING LINE AND GRADE IN ACCORDANCE WITH THE PLANS, AND FOR PROVIDING THE CONSULTANT WITH VERIFICATION PRIOR TO PLACEMENT
10. ALL EXCESS MATERIAL TO BE HAULLED OFFSITE AND DISPOSED OF AT AN APPROVED DUMP SITE. SHOULD THE CONTRACTOR DISCOVER ANY HAZARDOUS MATERIAL, CONTRACTOR IS TO NOTIFY CONSULTANT, CONSULTANT TO DETERMINE APPROPRIATE DISPOSAL METHOD/LOCATION
11. PAVEMENT STRUCTURE (MATERIAL TYPES AND THICKNESS) FOR HEAVY DUTY, LIGHT DUTY AND BASKETBALL COURT AREAS TO BE AS SPECIFIED IN THE GEOTECHNICAL REPORT AND SHOWN ON THE PLANS

Table with 3 columns: COURSE, MATERIAL, THICKNESS. Rows include SURFACE (HL3 OR SUPERPAVE 12.5 AC, 40 mm), BINDER (HL3 OR SUPERPAVE 19.0 AC, 50 mm), BASECOURSE (OPSS GRANULAR 'A', 150 mm), SUBBASE (OPSS GRANULAR 'B' TYPE II, 450 mm).


Table with 3 columns: COURSE, MATERIAL, THICKNESS. Rows include SURFACE (HL3 OR SUPERPAVE 12.5 AC, 50 mm), BASECOURSE (OPSS GRANULAR 'A', 150 mm), SUBBASE (OPSS GRANULAR 'B' TYPE II, 300 mm).

NOTES: STORM SEWERS AND STRUCTURES


- 17. ALL STORM SEWER MATERIALS AND CONSTRUCTION METHODS SHALL CONFORM TO THE CURRENT CITY OF OTTAWA STANDARDS AND SPECIFICATIONS, PROVIDE CCTV INSPECTION REPORTS FOR ALL NEW STORM SEWERS, SERVICES AND CB LEADS
18. STORM SEWERS 450mm DIAMETER AND SMALLER SHALL BE PVC SDR-35, WITH RUBBER GASKET PER CSA A-257.3
19. STORM SEWER LARGER THAN 450mm SHALL BE REINFORCED CONCRETE CLASS 100
20. SEWER BEDDING AS PER CITY OF OTTAWA DETAIL S6
21. ALL STORM MANHOLES TO BE AS PER STORM STRUCTURE TABLE ON DRAWING C02
22. ANY NEW OR EXISTING STORM SEWER WITH LESS THAN 2.0m COVER REQUIRES THERMAL INSULATION AS PER CITY OF OTTAWA STANDARD W22, OR APPROVED BY THE ENGINEER, ADD INSULATION ABOVE EXISTING STORM SEWER BETWEEN CBM109 AND CB114
23. CB IN LANDSCAPE AREAS SHALL BE AS PER CITY OF OTTAWA STANDARD S29, S30 AND S31
24. ALL CATCHBASIN LEADS TO BE MINIMUM 200mm DIAMETER AT MINIMUM 1.0% SLOPE UNLESS OTHERWISE SPECIFIED
25. STORM CATCHBASINS AS PER OPSD 705.010 AND FRAME/COVER AS PER CITY STANDARD DRAWINGS S19, STORM CBMH'S AS INDICATED IN TABLE WITH SUMP, ADJUSTMENT SECTIONS SHALL BE AS PER OPSD 704.010
26. INSTALLATION OF FLOW CONTROL ICDS TO BE VERIFIED BY QUALITY VERIFICATION ENGINEER RETAINED BY CONTRACTOR

LEGEND:

Legend table listing symbols for existing and proposed features: EXISTING FIRE HYDRANT, EXISTING VALVE CHAMBER, PROPOSED FIRE HYDRANT, PROPOSED VALVE AND VALVE BOX, PROPOSED VALVE AND VALVE CHAMBER, PROPOSED REMOTE METER, PROPOSED METER, PROPOSED CATCHBASIN MANHOLE, PROPOSE CATCHBASIN, PROPOSE LANDSCAPE CATCHBASIN, EXISTING CATCHBASIN MANHOLE, EXISTING SANITARY SEWER AND MANHOLE, PROPOSED SANITARY SEWER AND MANHOLE, EXISTING STORM SEWER AND MANHOLE, PROPOSED STORM SEWER AND MANHOLE, PROPOSED WATERMAIN, PROPOSED SUBDRAIN, EXISTING WATERMAIN, PROPOSED CENTERLINE OF SWALE, PROPOSED TERRACING (3:1 MAX), PROPOSED CONCRETE CURB, EXISTING BUILDING OR STRUCTURE, LIMIT OF CONSTRUCTION, EXISTING CONCRETE CURB, EXISTING GRADE, PROPOSED GRADE, PROPOSED TOP OF CURB, PROPOSED SWALE ELEVATION, PROPOSED SLOPE, 100 YEAR PONDING LIMIT, 5 YEAR PONDING LIMIT, SIAMENSE CONNECTION, OVERLAND MAJOR FLOW ROUTE, STORM DRAINAGE BOUNDARY, ID DENOTES WATERSHED NAME, A DENOTES AREA IN HECTARES, C DENOTES RUNOFF COEFFICIENT, ID DENOTES SANITARY DRAINAGE NAME, GA DENOTES GROSS AREA IN HECTARES, DA DENOTES DEVELOPED AREA IN HECTARES, FINISHED FLOOR ELEVATION, GRASS AREAS, ASPHALT PAVING, INTERLOCK PAVING, EXISTING DRAINAGE FLOW.

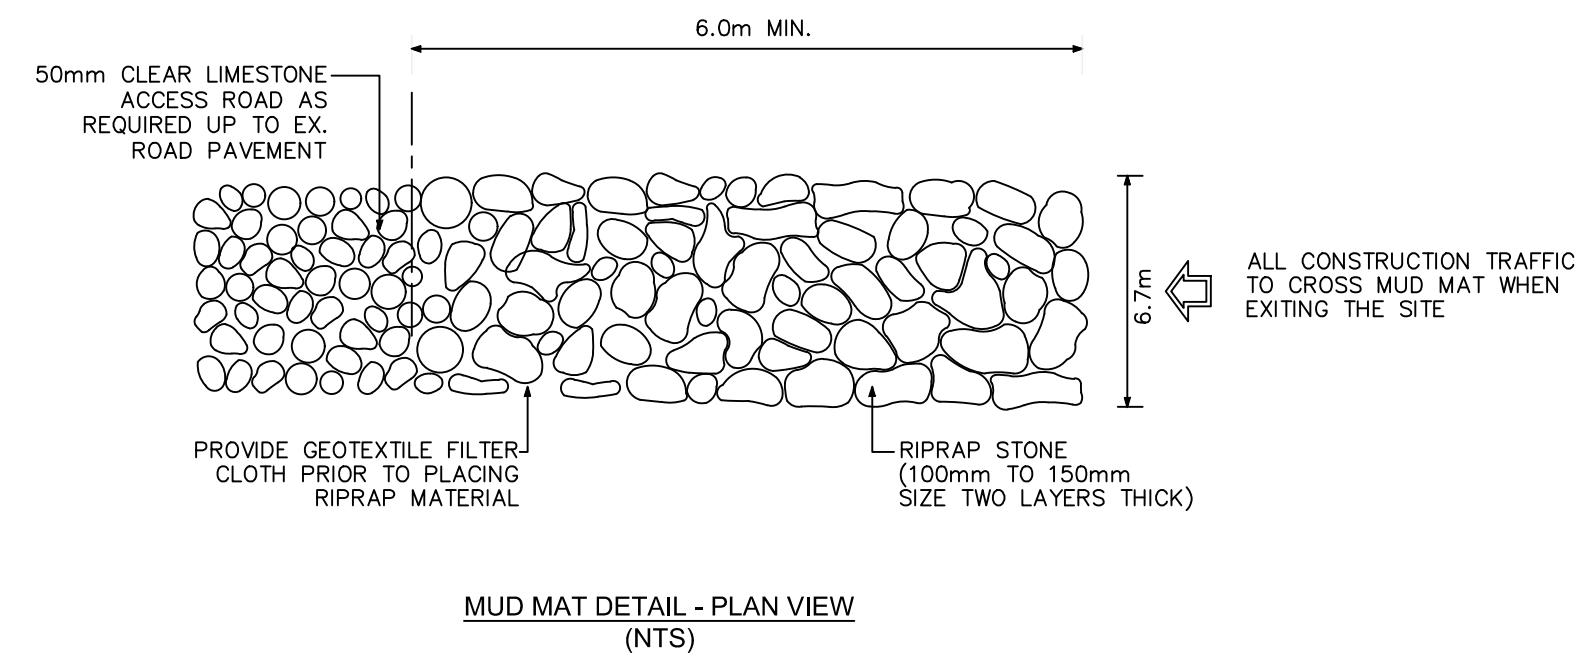

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WATERIDGE APARTMENTS BUILDINGS
375 CODD'S ROAD AND
1345 HEMLOCK ROAD,
OTTAWA, ON

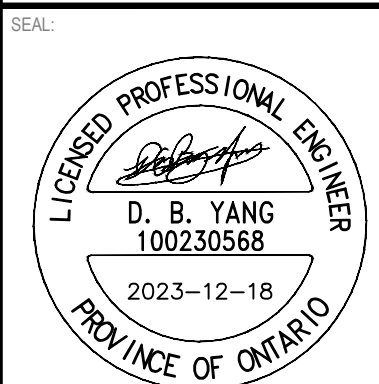

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BENCHMARK No. 0191968130 ELEVATION = 526.61
ELEVATIONS ARE GEODETIC, REFERRED TO CITY OF OTTAWA VERTICAL BENCHMARK No. 396 (1999MAD) HAVING AN ELEVATION OF 86.8 METRES. COORDINATES ARE DERIVED FROM CANADIAN 2011 REAL TIME NETWORK GPS OBSERVATIONS REFERENCED TO SPECIFIED CONTROL POINTS 0191968105 AND 0191968191, MTM ZONE 9 (1930 WEST LONGITUDE) NAD83 (ORIGINAL).

Table with columns: IS, RE, DATE, DESCRIPTION. Includes revision history for 2023-12-18, 2023-11-24, 2023-05-25, 2023-08-15, and 2022-05-24.

Table with columns: PROJECT NO., ORIGINAL SCALE, DESIGNED BY, DRAWN BY, CHECKED BY, DISCIPLINE. Includes project details for 221-04473-00, CIVIL, and designer DY.



Table with columns: TITLE, SHEET NUMBER, SHEET #, ISSUE, DATE OF. Includes title 'NOTES AND DETAILS', sheet number 'C201', and issue 'REVISED AS PER CITY COMMENTS' dated 2023-12-18.

#XXXXX

**ELEVATION NOTES**  
 1. ELEVATIONS ARE GEODETIC AND REFERRED TO CITY OF OTTAWA VERTICAL BENCH MARK NO. 396 (01919680138), HAVING AN ELEVATION OF 95.06 METRES.



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**CLIENT REF #**  
**PROJECT**  
**WATERIDGE APARTMENTS BUILDINGS**  
**375 CODD'S ROAD AND**  
**1345 HEMLOCK ROAD,**  
**OTTAWA, ON**

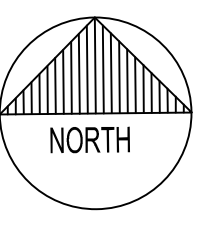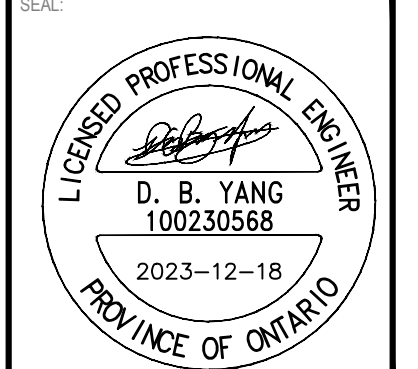



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 BENCH MARK NO. 01919680138 ELEVATION = 95.06 m  
 ELEVATIONS ARE GEODETIC, REFERRED TO CITY OF OTTAWA VERTICAL BENCH MARK NO. 396 (01919680138), HAVING AN ELEVATION OF 95.06 METRES.  
 COORDINATES ARE DERIVED FROM CANADIAN 2011 REAL TIME NETWORK GPS OBSERVATIONS REFERENCED TO SPECIFIED CONTROL POINTS 01919680100 AND 01919680101, MTM ZONE 9 (NAD83) ORIGINAL.

**ISSUED FOR - REVISION**

NO.	DATE	DESCRIPTION
5	2023-12-18	REVISED AS PER CITY COMMENTS
4	2023-11-24	REVISED AS PER CITY COMMENTS
3	2023-05-25	REVISED AS PER CITY COMMENTS
2	2022-08-15	ISSUED FOR SPA
1	2022-05-24	ISSUED FOR CLC REVIEW

**PROJECT NO:** 221-04473-00  
**ORIGINAL SCALE:** 1:150  
**DESIGNED BY:** DY  
**DRAWN BY:** JT  
**CHECKED BY:** DY  
**DISCIPLINE:** CIVIL  
**TITLE:** GRANDING PLAN - BUILDING 2  
**SHEET NUMBER:** C202  
**ISSUE:** REVISED AS PER CITY COMMENTS  
**DATE OF:** 2023-12-18


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V:\10-13-18-2022\Projects\221-04473-00\_Civ3\_Drawing\Working Drawings\Working Drawings\Building 2 - Wateridge 14.00\_Civ3\_Prof\_Siteplan\_14.00\_Tech\_Prof\_Siteplan\_14.00\_2023-12-18.dwg, Dec 18, 2023, 5:01pm BY: (saw/69741)

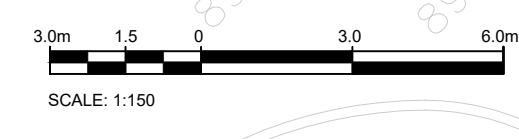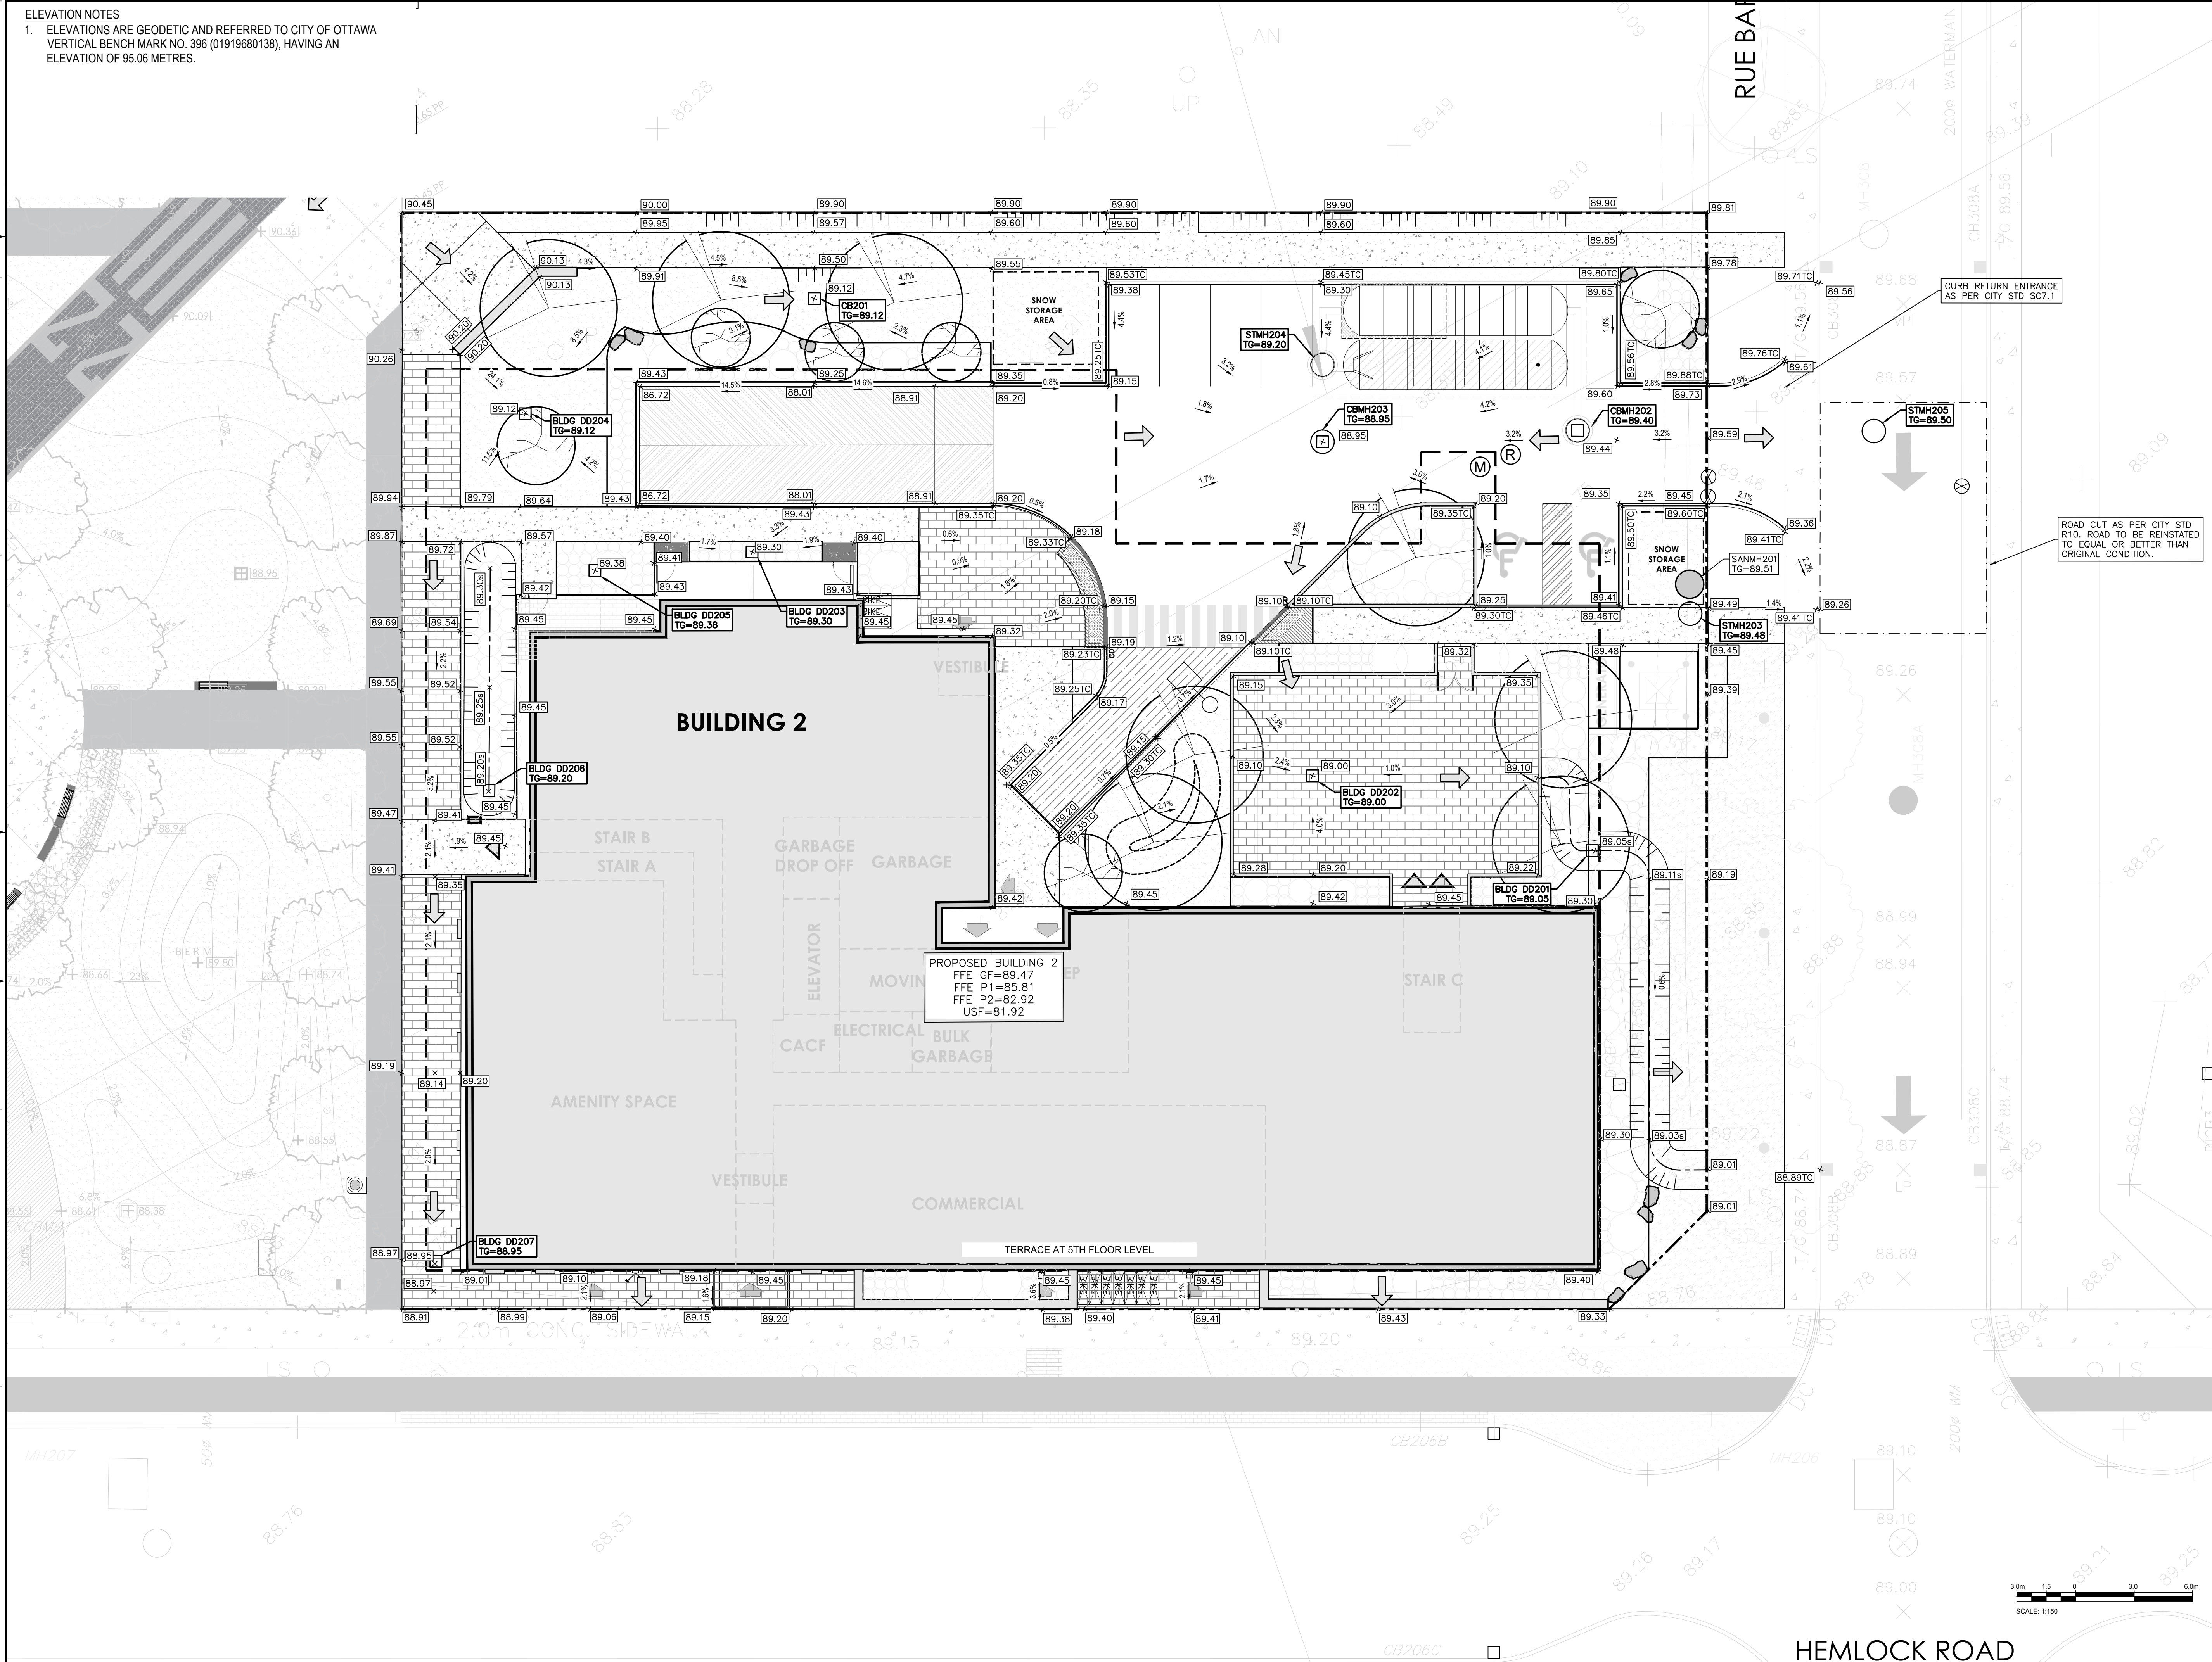D07-12-22-0122

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**ELEVATION NOTES**  
 1. ELEVATIONS ARE GEODETIC AND REFERRED TO CITY OF OTTAWA VERTICAL BENCH MARK NO. 396 (01919680138), HAVING AN ELEVATION OF 95.06 METRES.

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SEAL:  
**Licensed Professional Engineer**  
**D. B. YANG**  
**100230568**  
 2023-12-18  
 PROVINCE OF ONTARIO

CLIENT:  
**BG BAYVIEW GROUP**

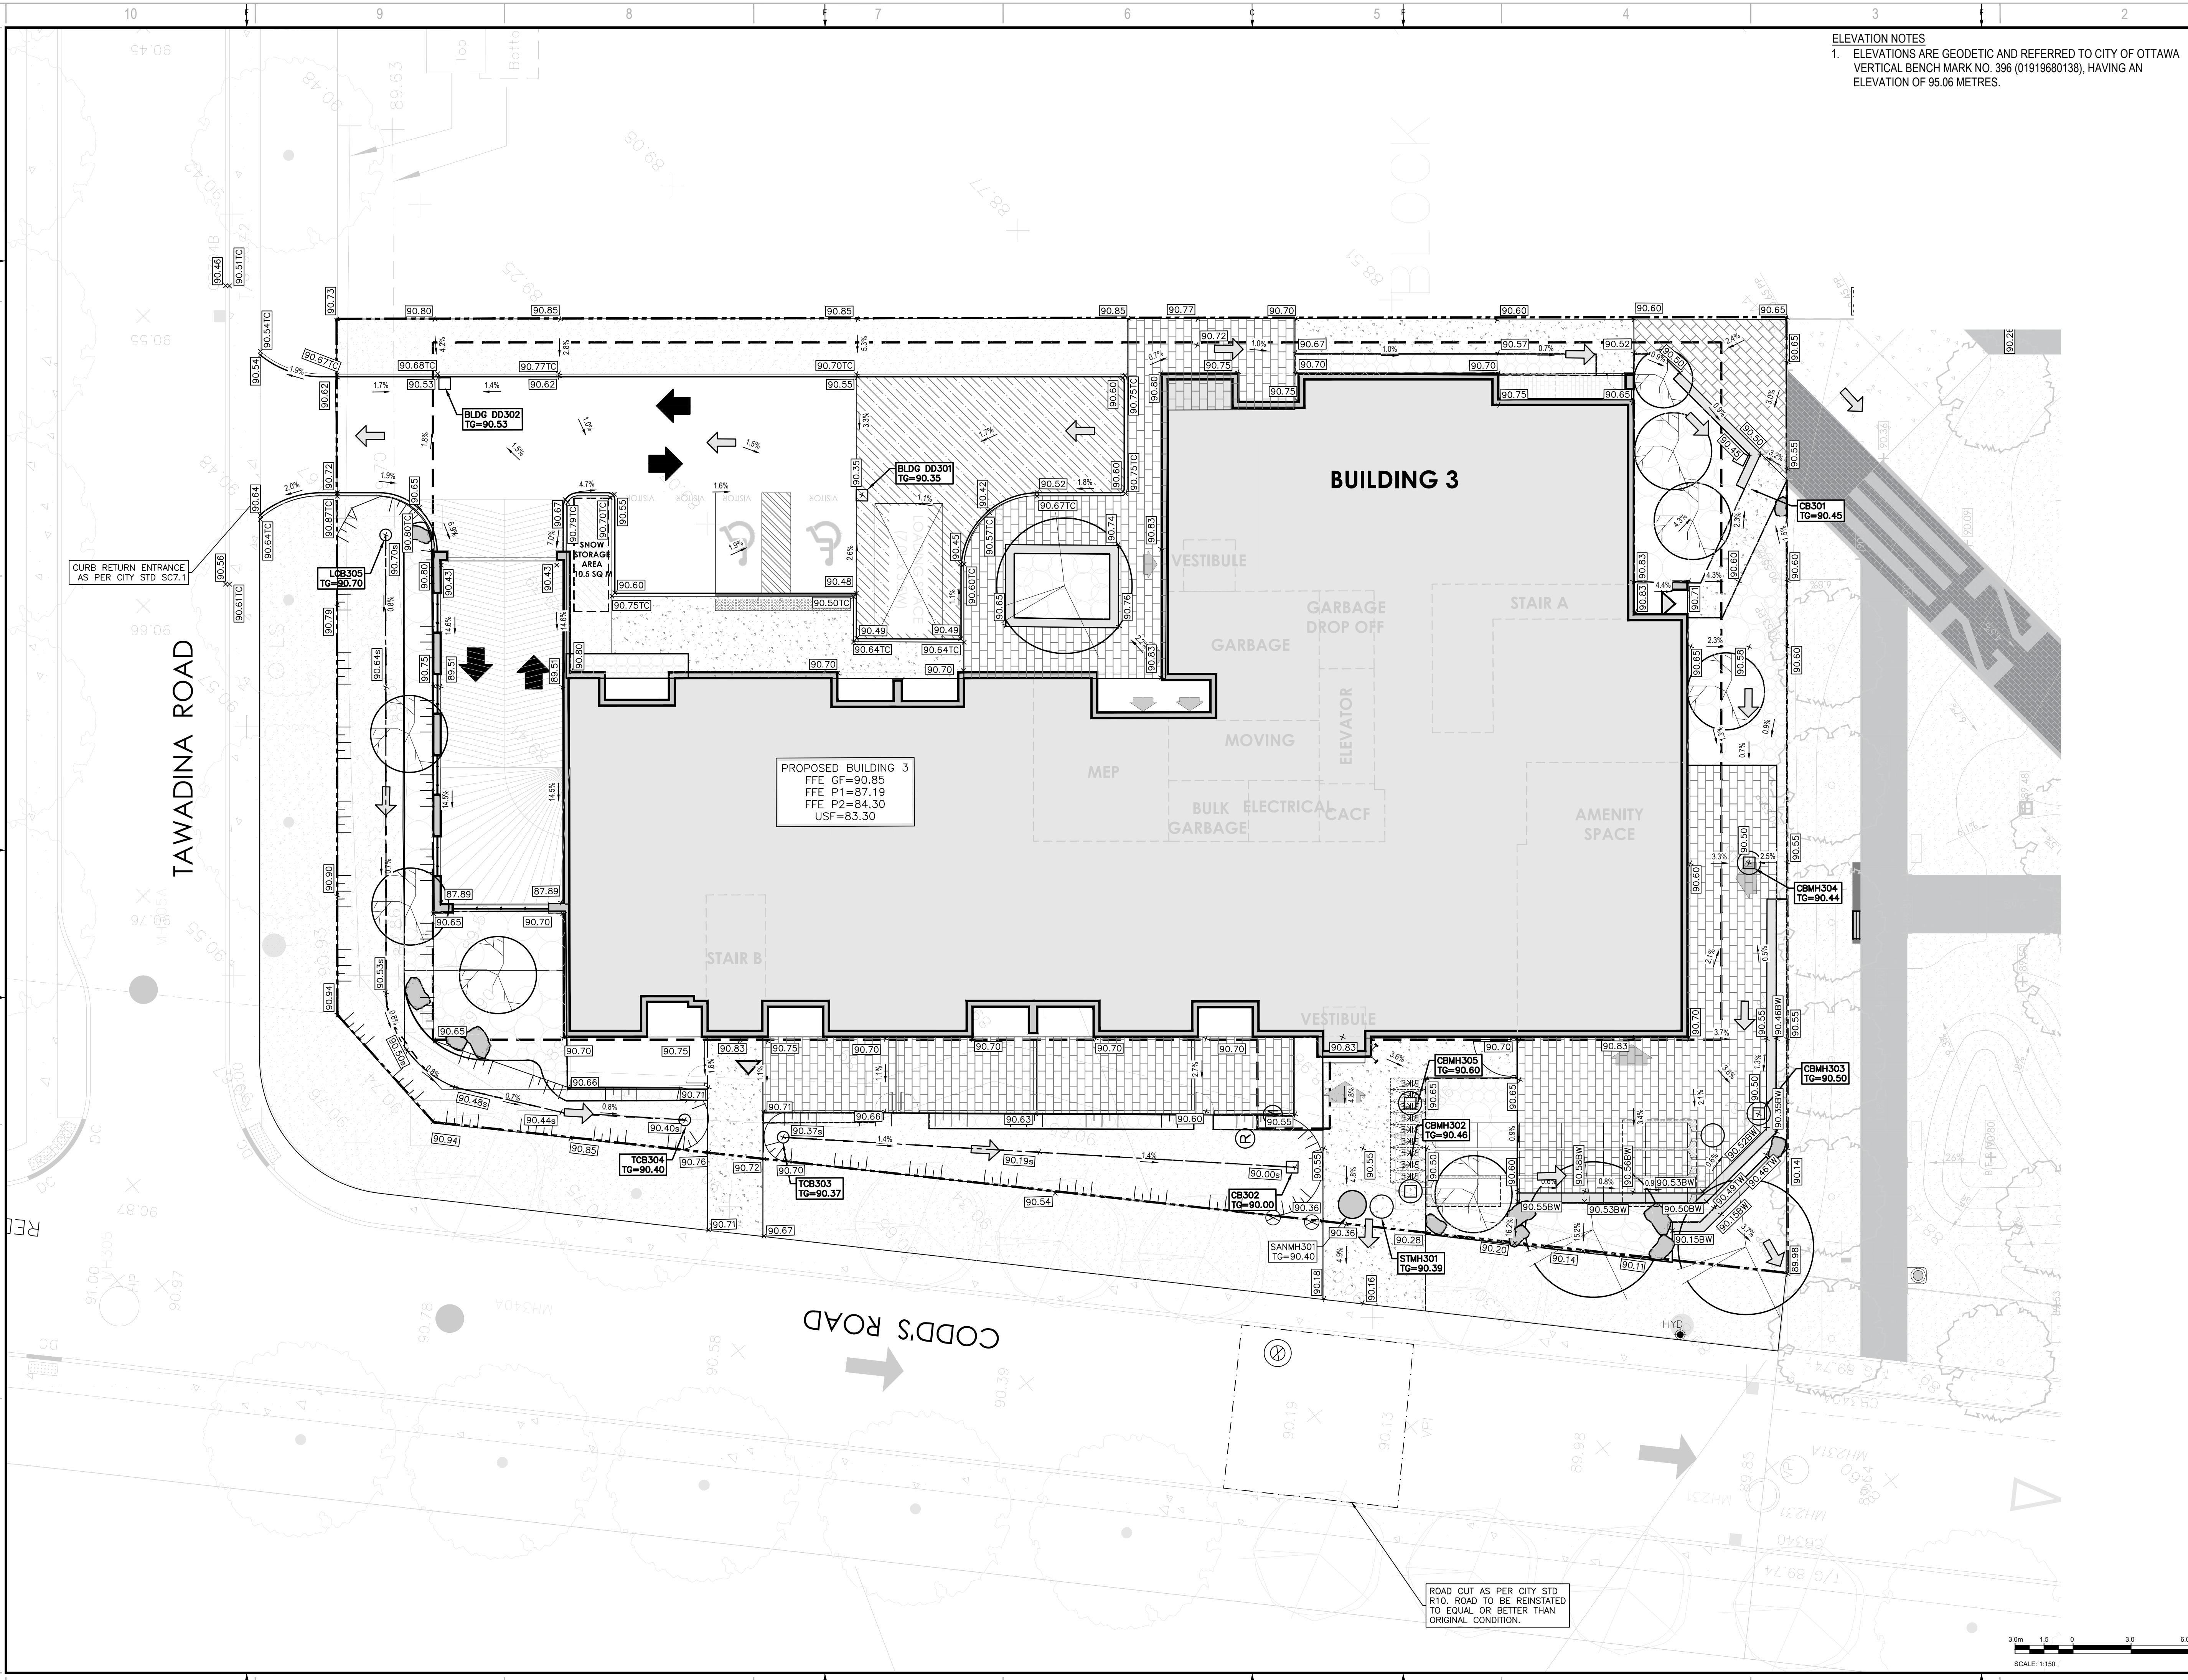CLIENT REF #  
 PROJECT:  
**WATERIDGE APARTMENTS BUILDINGS**  
**375 CODD'S ROAD AND**  
**1345 HEMLOCK ROAD,**  
**OTTAWA, ON**



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 COORDINATES ARE DERIVED FROM CANMET 2011 REAL TIME NETWORK GPS OBSERVATIONS REFERENCED TO SPECIFIED CONTROL POINTS 01919680138 AND 01919680139, MTM ZONE 8 (NAD 83) (ORIGINAL).

ISSUED FOR - REVISION

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5	2023-12-18	REVISED AS PER CITY COMMENTS
4	2023-11-24	REVISED AS PER CITY COMMENTS
3	2023-05-25	REVISED AS PER CITY COMMENTS
2	2022-08-15	ISSUED FOR SPA
1	2022-05-24	ISSUED FOR CLC REVIEW

PROJECT NO:  
**221-04473-00**  
 ORIGINAL SCALE:  
**1:150**  
 DESIGNED BY:  
**DY**  
 DRAWN BY:  
**JT**  
 CHECKED BY:  
**DY**  
 DISCIPLINE:  
**CIVIL**

TITLE:  
**GRANDING PLAN - BUILDING 3**

SHEET NUMBER:  
**C203**  
 SHEET # OF  
 ISSUE:  
**REVISED AS PER CITY COMMENTS**  
 DATE OF: 2023-12-18  
 REV #  
**0**

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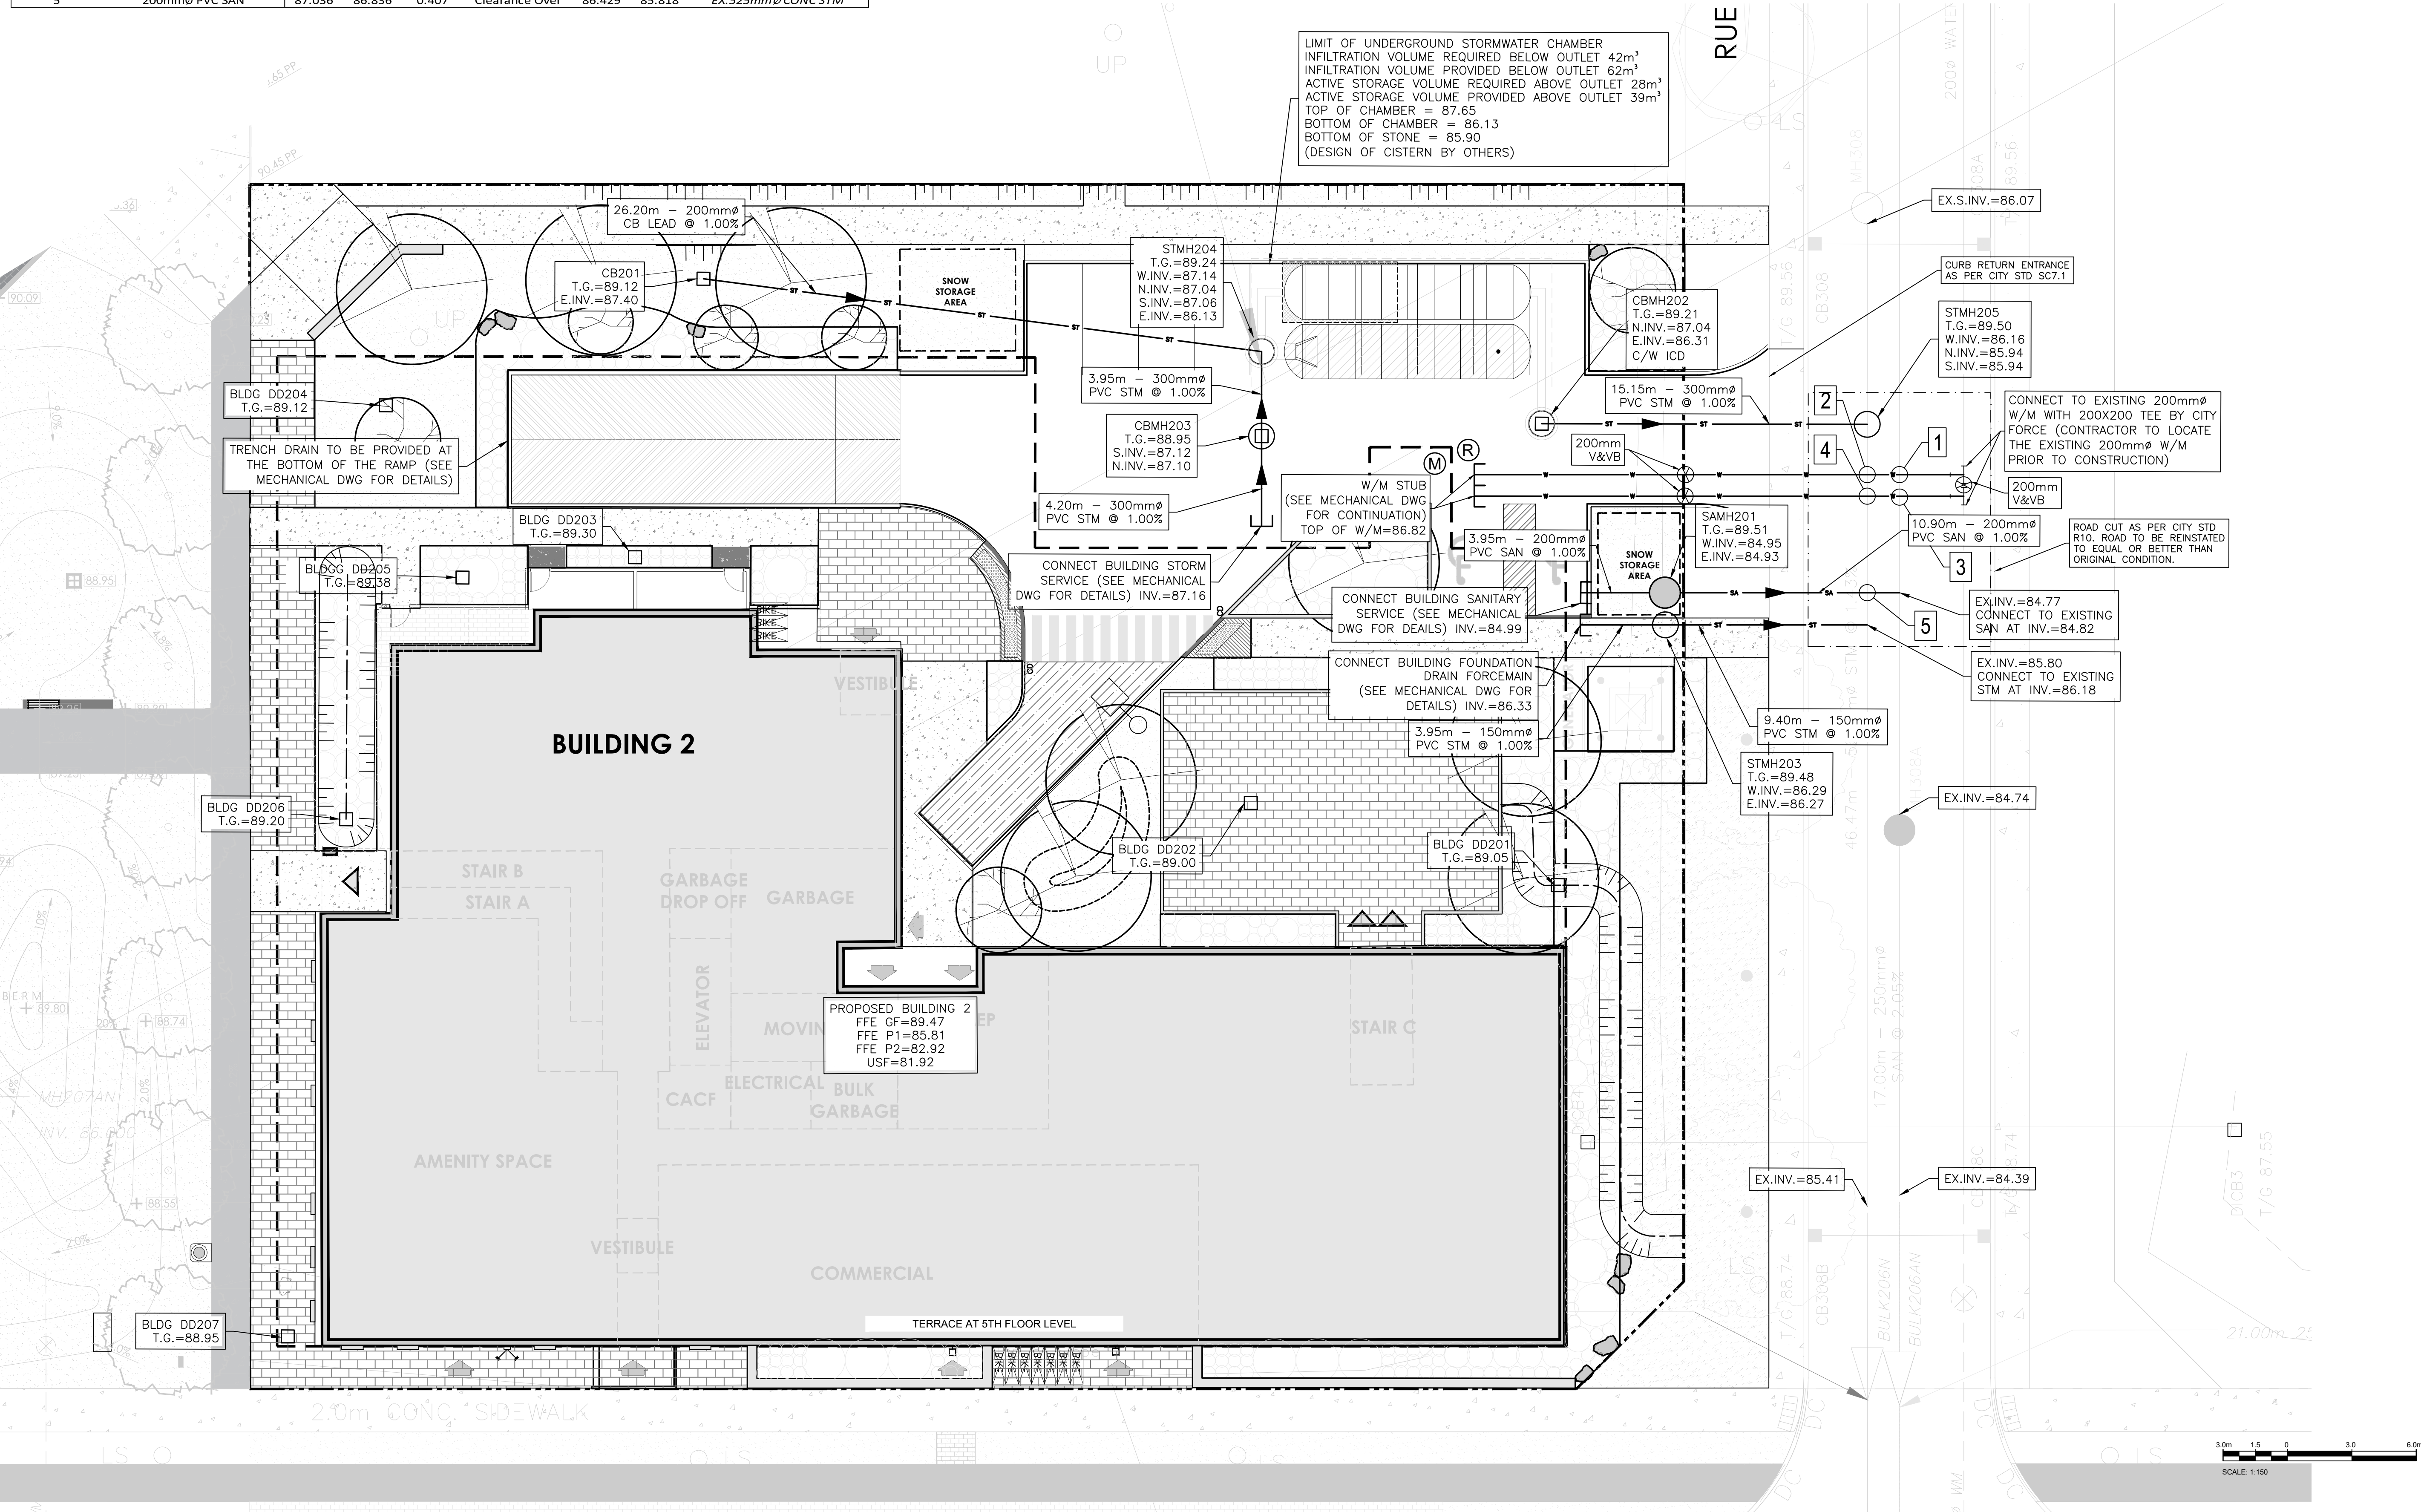
D07-12-22-0122

STORM STRUCTURE TABLE														
STRUCTURE ID	AREA ID	TOP OF GRATE	STRUCTURE INFO				OPSD	COVER	OUTLET PIPE INFO		ICD INFO			
			INLET	INLET	INLET	OUTLET			SIZE	DIAMETER		TYPE	HEAD (m)	FLOW (l/s)
BUILDING 2														
CB201		89.12				600x600mm	OPSD 701.010	S19.1	200	PVC SDR-35				
STMH204		89.24	87.140	87.040	86.430	1200mm DIA.	OPSD 701.010	S24.1	250	PVC SDR-35				
CBMH203		88.95			86.490	1200mm DIA.	OPSD 701.010	S28.1	300	PVC SDR-35				
CBMH202		89.21			87.040	1200mm DIA.	OPSD 701.010	S28.1	300	PVC SDR-35				

BUILDING 2 - CROSSING TABLE										
1	200mm Ø W/M	Obvert		1.819	Clearance Over	Obvert		85.031	84.780	EX. 250mm Ø PVC SAN
		87.050	86.850			85.545	85.930			
2	200mm Ø W/M	87.139	86.939	0.394	Clearance Over	86.545	85.930			EX. 525mm Ø CONC STM
3	200mm Ø W/M	87.030	86.830	1.801	Clearance Over	85.029	84.779			EX. 250mm Ø PVC SAN
4	200mm Ø W/M	87.068	86.868	0.371	Clearance Over	86.497	85.883			EX. 525mm Ø CONC STM
5	200mm Ø PVC SAN	87.036	86.836	0.407	Clearance Over	86.429	85.818			EX. 525mm Ø CONC STM

SAN STRUCTURE TABLE										
STRUCTURE ID	TOP OF GRATE ELEVATION	INVERT			SIZE	DESCRIPTION	COVER			
		INLET	INLET	OUTLET						
BUILDING 2										
SANMH201	89.51		84.950	84.930	1200mm DIA.	OPSD-701.010	OPSD-401.030			

WATERMAIN SCHEDULE					
STATION	DESCRIPTION	FINISHED GRADE	TOP OF WATERMAIN	AS-BUILT WATERMAIN	COVER
BUILDING 2					
0+000	W/M STUB	89.22	86.820		2.40
0+009.84	200mm VB	89.51	87.110		2.40
0+018.30	Crossing 525mm Ø CONC STM	89.36	86.960		2.40
0+019.82	Crossing 250mm Ø PVC SAN	89.32	86.920		2.40
0+022.80	Connect to ex. 200mm W/M with TEE	89.25	86.850		2.40
1+000	W/M STUB	89.23	86.820		2.41
1+009.96	200mm VB	89.47	87.070		2.40
1+018.34	Crossing 525mm Ø CONC STM	89.34	86.940		2.40
1+019.85	Crossing 250mm Ø PVC SAN	89.30	86.900		2.40
1+022.84	Connect to ex. 200mm W/M with TEE	89.23	86.830		2.40



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**Licensed Professional Engineer**  
 D. B. YANG  
 100230568  
 2023-12-18  
 PROVINCE OF ONTARIO

**NORTH**

**BG BAYVIEW GROUP**

**WATERIDGE APARTMENTS BUILDINGS**  
 375 CODD'S ROAD AND  
 1345 HEMLOCK ROAD,  
 OTTAWA, ON



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 BENCHMARK No. 01919680130 ELEVATION = 526.61  
 ELEVATIONS ARE GEODETIC, REFERRED TO CITY OF OTTAWA VERTICAL BENCHMARK No. 396 (1999/2001) HAVING AN ELEVATION OF 86.08 METRES.  
 COORDINATES ARE DERIVED FROM CANMET 2011 REAL TIME NETWORK GPS OBSERVATIONS REFERENCED TO SPECIFIED CONTROL POINTS 01919680100 AND 01919680101, MTM ZONE 9 (18) WEST (NAD83) (NAD83 ORIGINAL).

IS	RE	DATE	DESCRIPTION
5		2023-12-18	REVISED AS PER CITY COMMENTS
4		2023-11-24	REVISED AS PER CITY COMMENTS
3		2023-05-25	REVISED AS PER CITY COMMENTS
2		2022-08-15	ISSUED FOR SPA
1		2022-05-24	ISSUED FOR CLC REVIEW

PROJECT NO.	DATE
221-04473-00	DECEMBER 2023

ORIGINAL SCALE: 1:150  
 DESIGNED BY: DY  
 DRAWN BY: JT  
 CHECKED BY: DY

DISCIPLINE: CIVIL  
 TITLE: SERVICING - BUILDING 2  
 SHEET NUMBER: C204  
 SHEET # OF  
 ISSUE: REVISED AS PER CITY COMMENTS  
 DATE OF: 2023-12-18

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D07-12-22-0122


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
STRUCTURE ID	AREA ID	TOP OF GRATE	STRUCTURE INFO						OUTLET PIPE INFO			ICD INFO		
			INLET	INLET	INLET	OUTLET	SIZE	OPSD	COVER	DIAMETER	TYPE	HEAD (m)	FLOW (l/s)	ICD TYPE
BUILDING 3														
CB301		90.45				88.080	600x600mm	OPSD 705.010	\$19.1	200	PVC SDR-35			
CB302		90.00				88.800	600x600mm	OPSD 705.010	\$19.1	200	PVC SDR-35			
TCB303		90.25				89.050	600x600mm	OPSD 705.010	\$30	200	HDPE			
TCB304		90.28				89.080	600x600mm	OPSD 705.010	\$30	200	HDPE			
LCB305		90.70				89.500	600x600mm	OPSD 705.010	\$30	200	HDPE			
STMH301		90.39				86.570	1200mm DIA.	OPSD 701.010	\$24.1	150	PVC SDR-35			
CBMH302		90.40	87.470	87.050	87.370	1200mm DIA.	OPSD 701.010	\$28.1	300	PVC SDR-35				
CBMH303		90.50				87.750	1200mm DIA.	OPSD 701.010	\$28.1	250	PVC SDR-35			
CBMH304		90.44				87.870	1200mm DIA.	OPSD 701.010	\$28.1	250	PVC SDR-35			
CBMH305		90.61				87.390	1200mm DIA.	OPSD 701.010	\$28.1	300	PVC SDR-35			
STMH306		90.54				87.670	1200mm DIA.	OPSD 701.010	\$28.1	250	PVC SDR-35			

BUILDING 3		Obvert	Invert			Obvert	Invert	
1	200mmØ PVC SAN	85.000	84.800	2.320	Clearance Under	87.720	87.320	EX.400mmØ WM
2	300mmØ PVC STM	86.940	86.640	0.350	Clearance Under	87.690	87.290	EX.400mmØ WM
3	150mmØ PVC STM	86.639	86.489	0.641	Clearance Under	87.680	87.280	EX.400mmØ WM
4	300mmØ PVC STM	86.687	86.387	1.018	Clearance Over	85.369	85.119	EX.250mmØ PVC SAN
5	150mmØ PVC STM	86.609	86.459	1.068	Clearance Over	85.391	85.141	EX.250mmØ PVC SAN

WATERMAIN SCHEDULE					
STATION	DESCRIPTION	FINISHED GRADE	TOP OF WATERMAIN	AS-BUILT WATERMAIN	COVER
BUILDING 3					
0+000	W/M STUB		90.20	87.100	3.10
0+003.55	200mm VB		90.41	88.010	2.40
0+010.50	Connect to ex. 400mm W/M with TEE		90.17	87.770	2.40
1+000	W/M STUB		90.41	87.100	3.31
1+003.79	200mm VB		90.38	87.980	2.40
1+010.72	Connect to ex. 400mm W/M with TEE		90.15	87.750	2.40

SAN STRUCTURE TABLE						
STRUCTURE ID	TOP OF GRATE ELEVATION	INLET	INLET	OUTLET	SIZE	DESCRIPTION
BUILDING 3						
SANMH301	90.40		84.900	84.880	1200mm DIA.	OPSD-701.010 S24



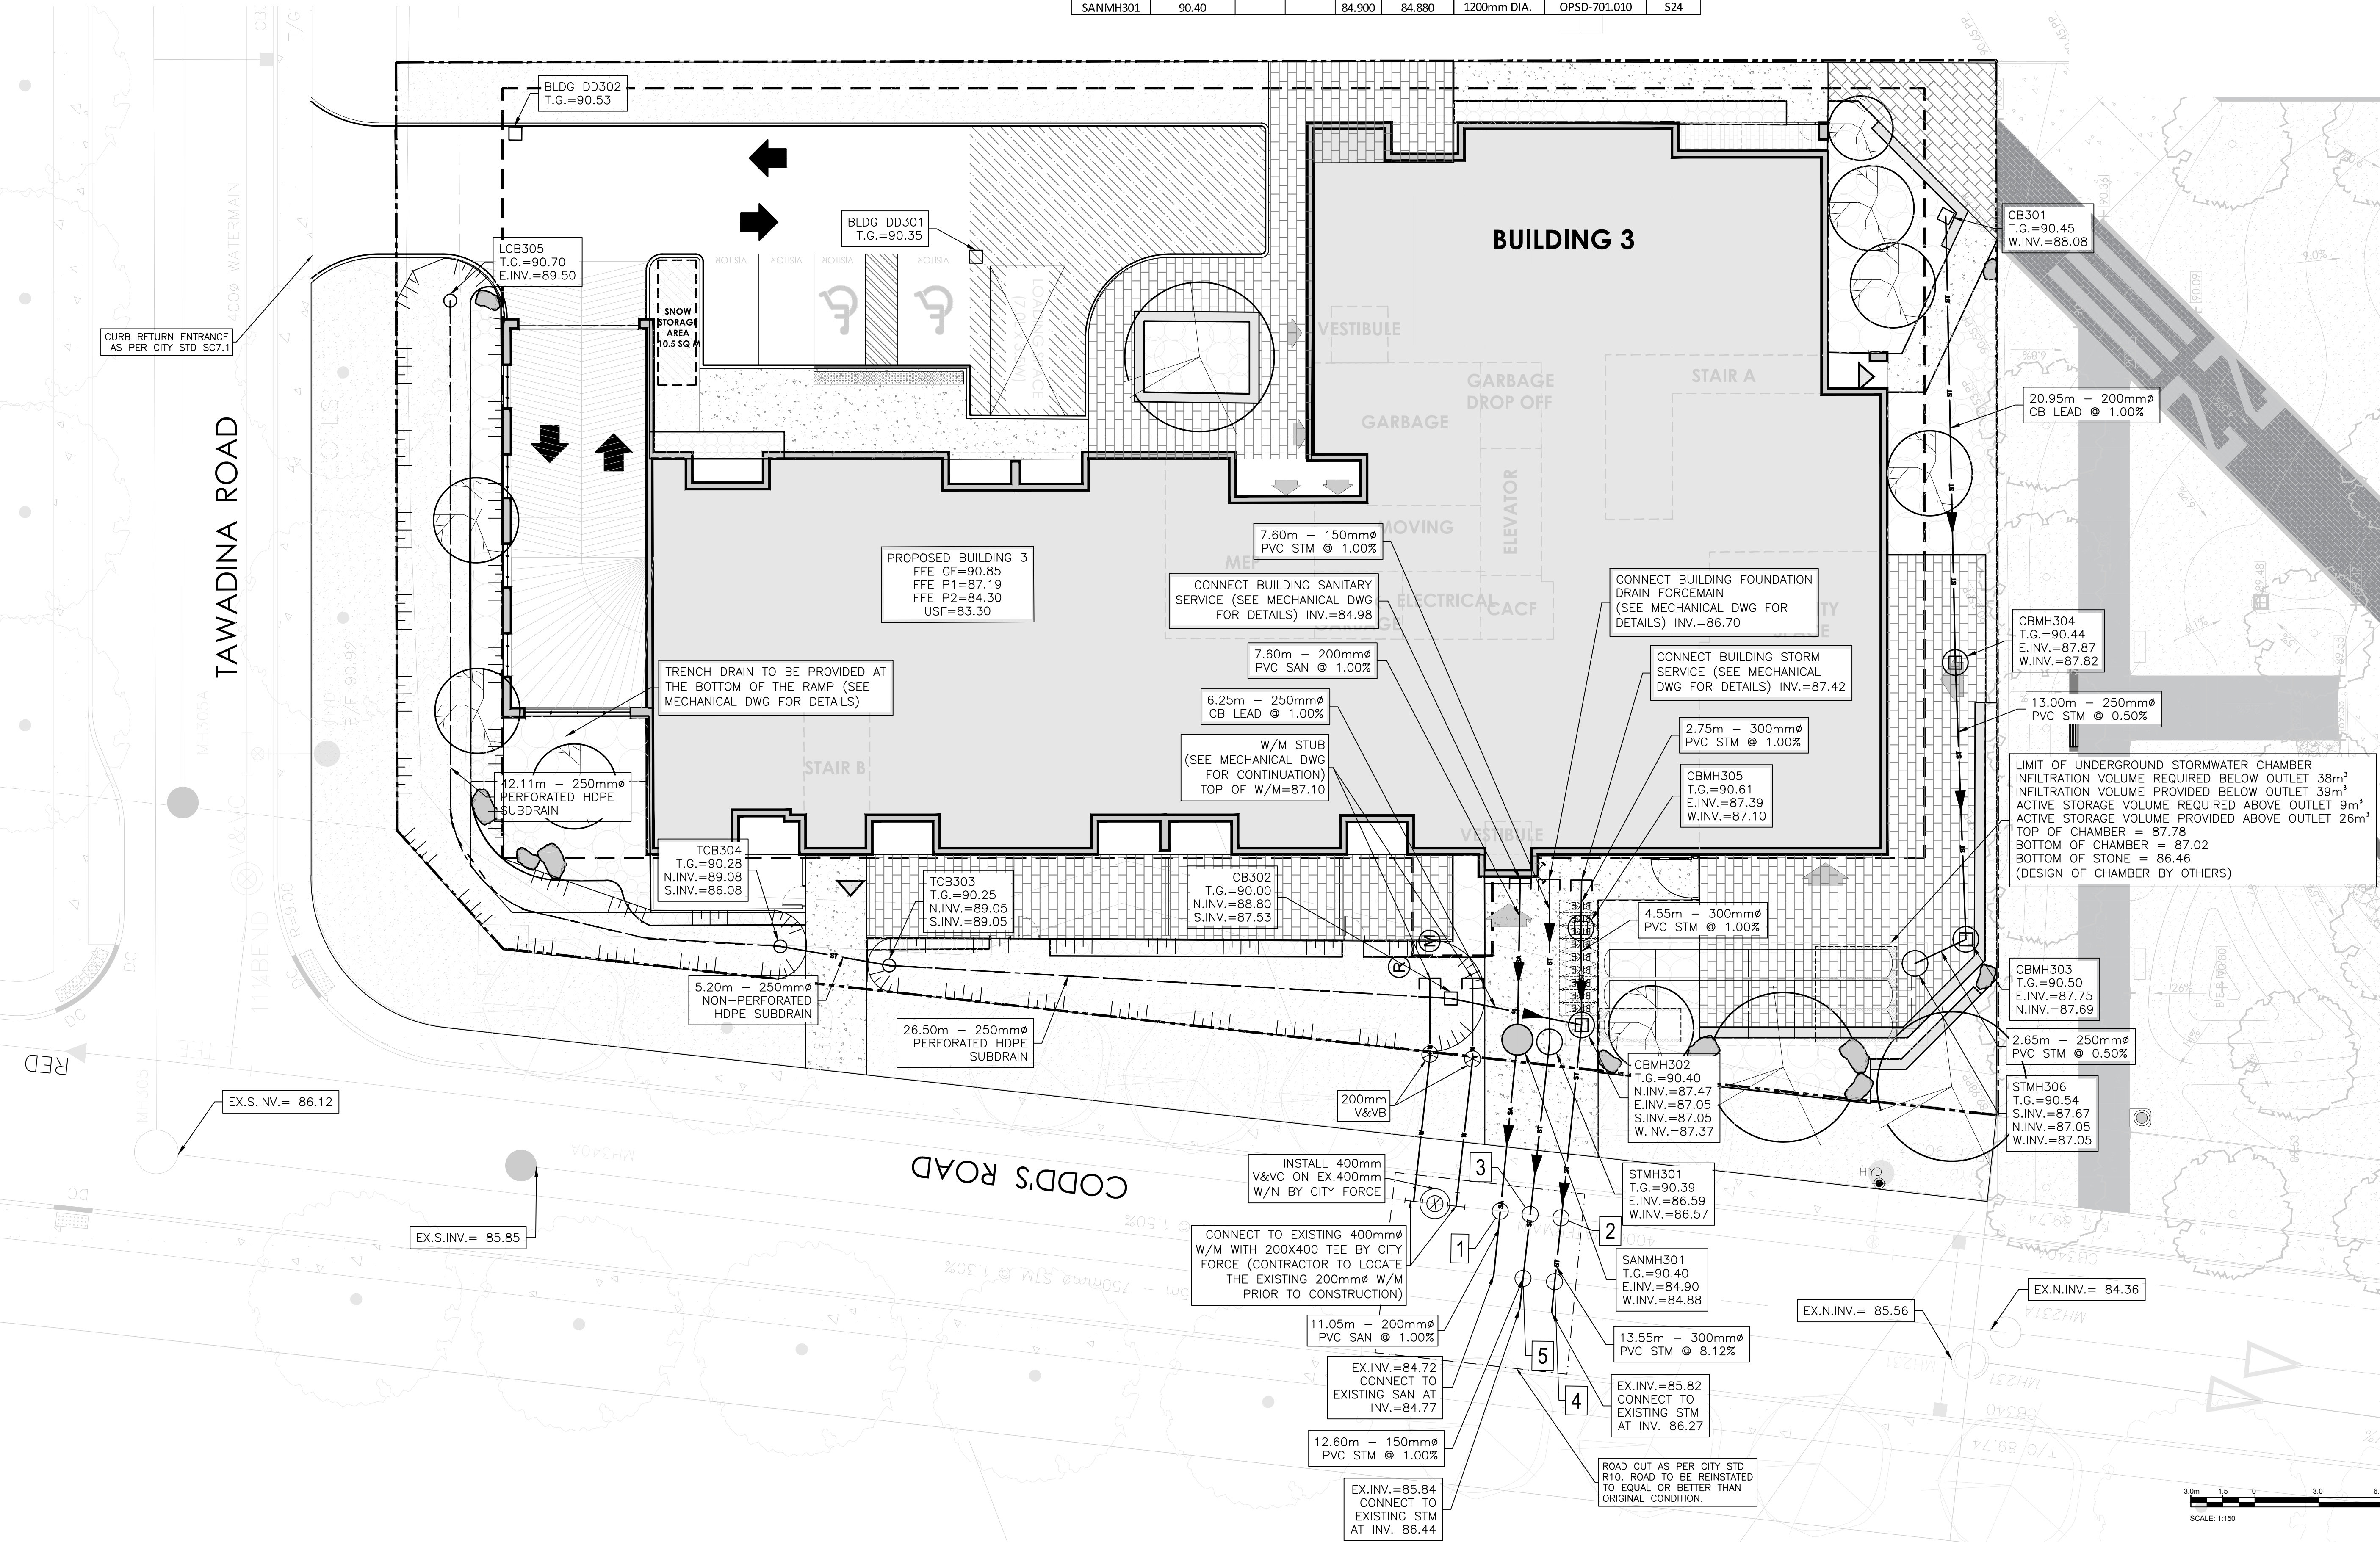


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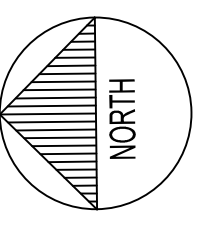
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418 IRAQUOIS SHORE ROAD, UNIT 206  
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CANADA L6H 0H7  
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


LICENCED PROFESSIONAL ENGINEER  
D. B. YANG  
100230568  
2023-12-18  
PROVINCE OF ONTARIO



NORTH
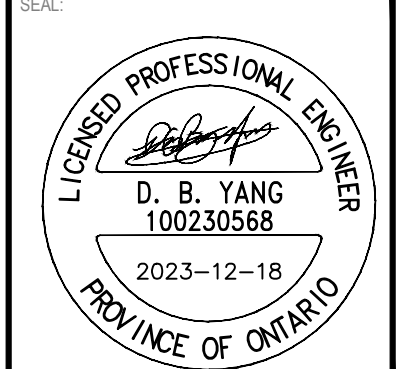
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


**BG**  
BAYVIEW  
GROUP

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**WATERIDGE APARTMENTS BUILDINGS**  
375 CODD'S ROAD AND  
1345 HEMLOCK ROAD,  
OTTAWA, ON

---



KEY PLAN

---

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BENCHMARK No: 0191968130 ELEVATION = 5526.11  
ELEVATIONS ARE GEODETIC, REFERRED TO CITY OF OTTAWA VERTICAL BENCHMARK No. 396  
COORDINATES ARE DERIVED FROM CANMET 2011 REAL TIME NETWORK GPS OBSERVATIONS REFERENCED TO SPECIFIED CONTROL POINTS 0191968105 AND 0191968161, MTM ZONE 9 (NAD 83 ORIGINAL).  
ISSUED FOR: REVISION

IS	RE	DATE	DESCRIPTION
5	2023-12-18	REVISED AS PER CITY COMMENTS	
4	2023-11-24	REVISED AS PER CITY COMMENTS	
3	2023-05-25	REVISED AS PER CITY COMMENTS	
2	2022-08-15	ISSUED FOR SPA	
1	2022-05-24	ISSUED FOR CLC REVIEW	


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PROJECT NO: <b>221-04473-00</b>	DATE: DECEMBER 2023
ORIGINAL SCALE: 1:150	IF THIS BAR IS NOT 25mm LONG, ADJUST YOUR PLOTTING SCALE.
DESIGNED BY: DY	
DRAWN BY: JT	
CHECKED BY: DY	
DISCIPLINE: CIVIL	
TITLE: <b>SERVICING - BUILDING 3</b>	
SHEET NUMBER: C205	
SHEET # 0	REV # 0
ISSUE: REVISED AS PER CITY COMMENTS	
DATE OF: 2023-12-18	

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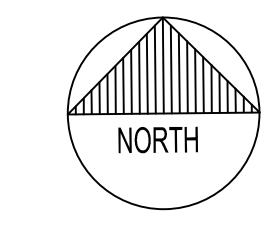
D07-12-22-0122

#XXXXX



2011 QUEENVIEW DR.  
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CANADA K2B 8K2  
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OAKVILLE, ONTARIO  
CANADA L6H 0H7  
T: 416-897-2867  
E: EVA@MATAJARCHITECTS.COM

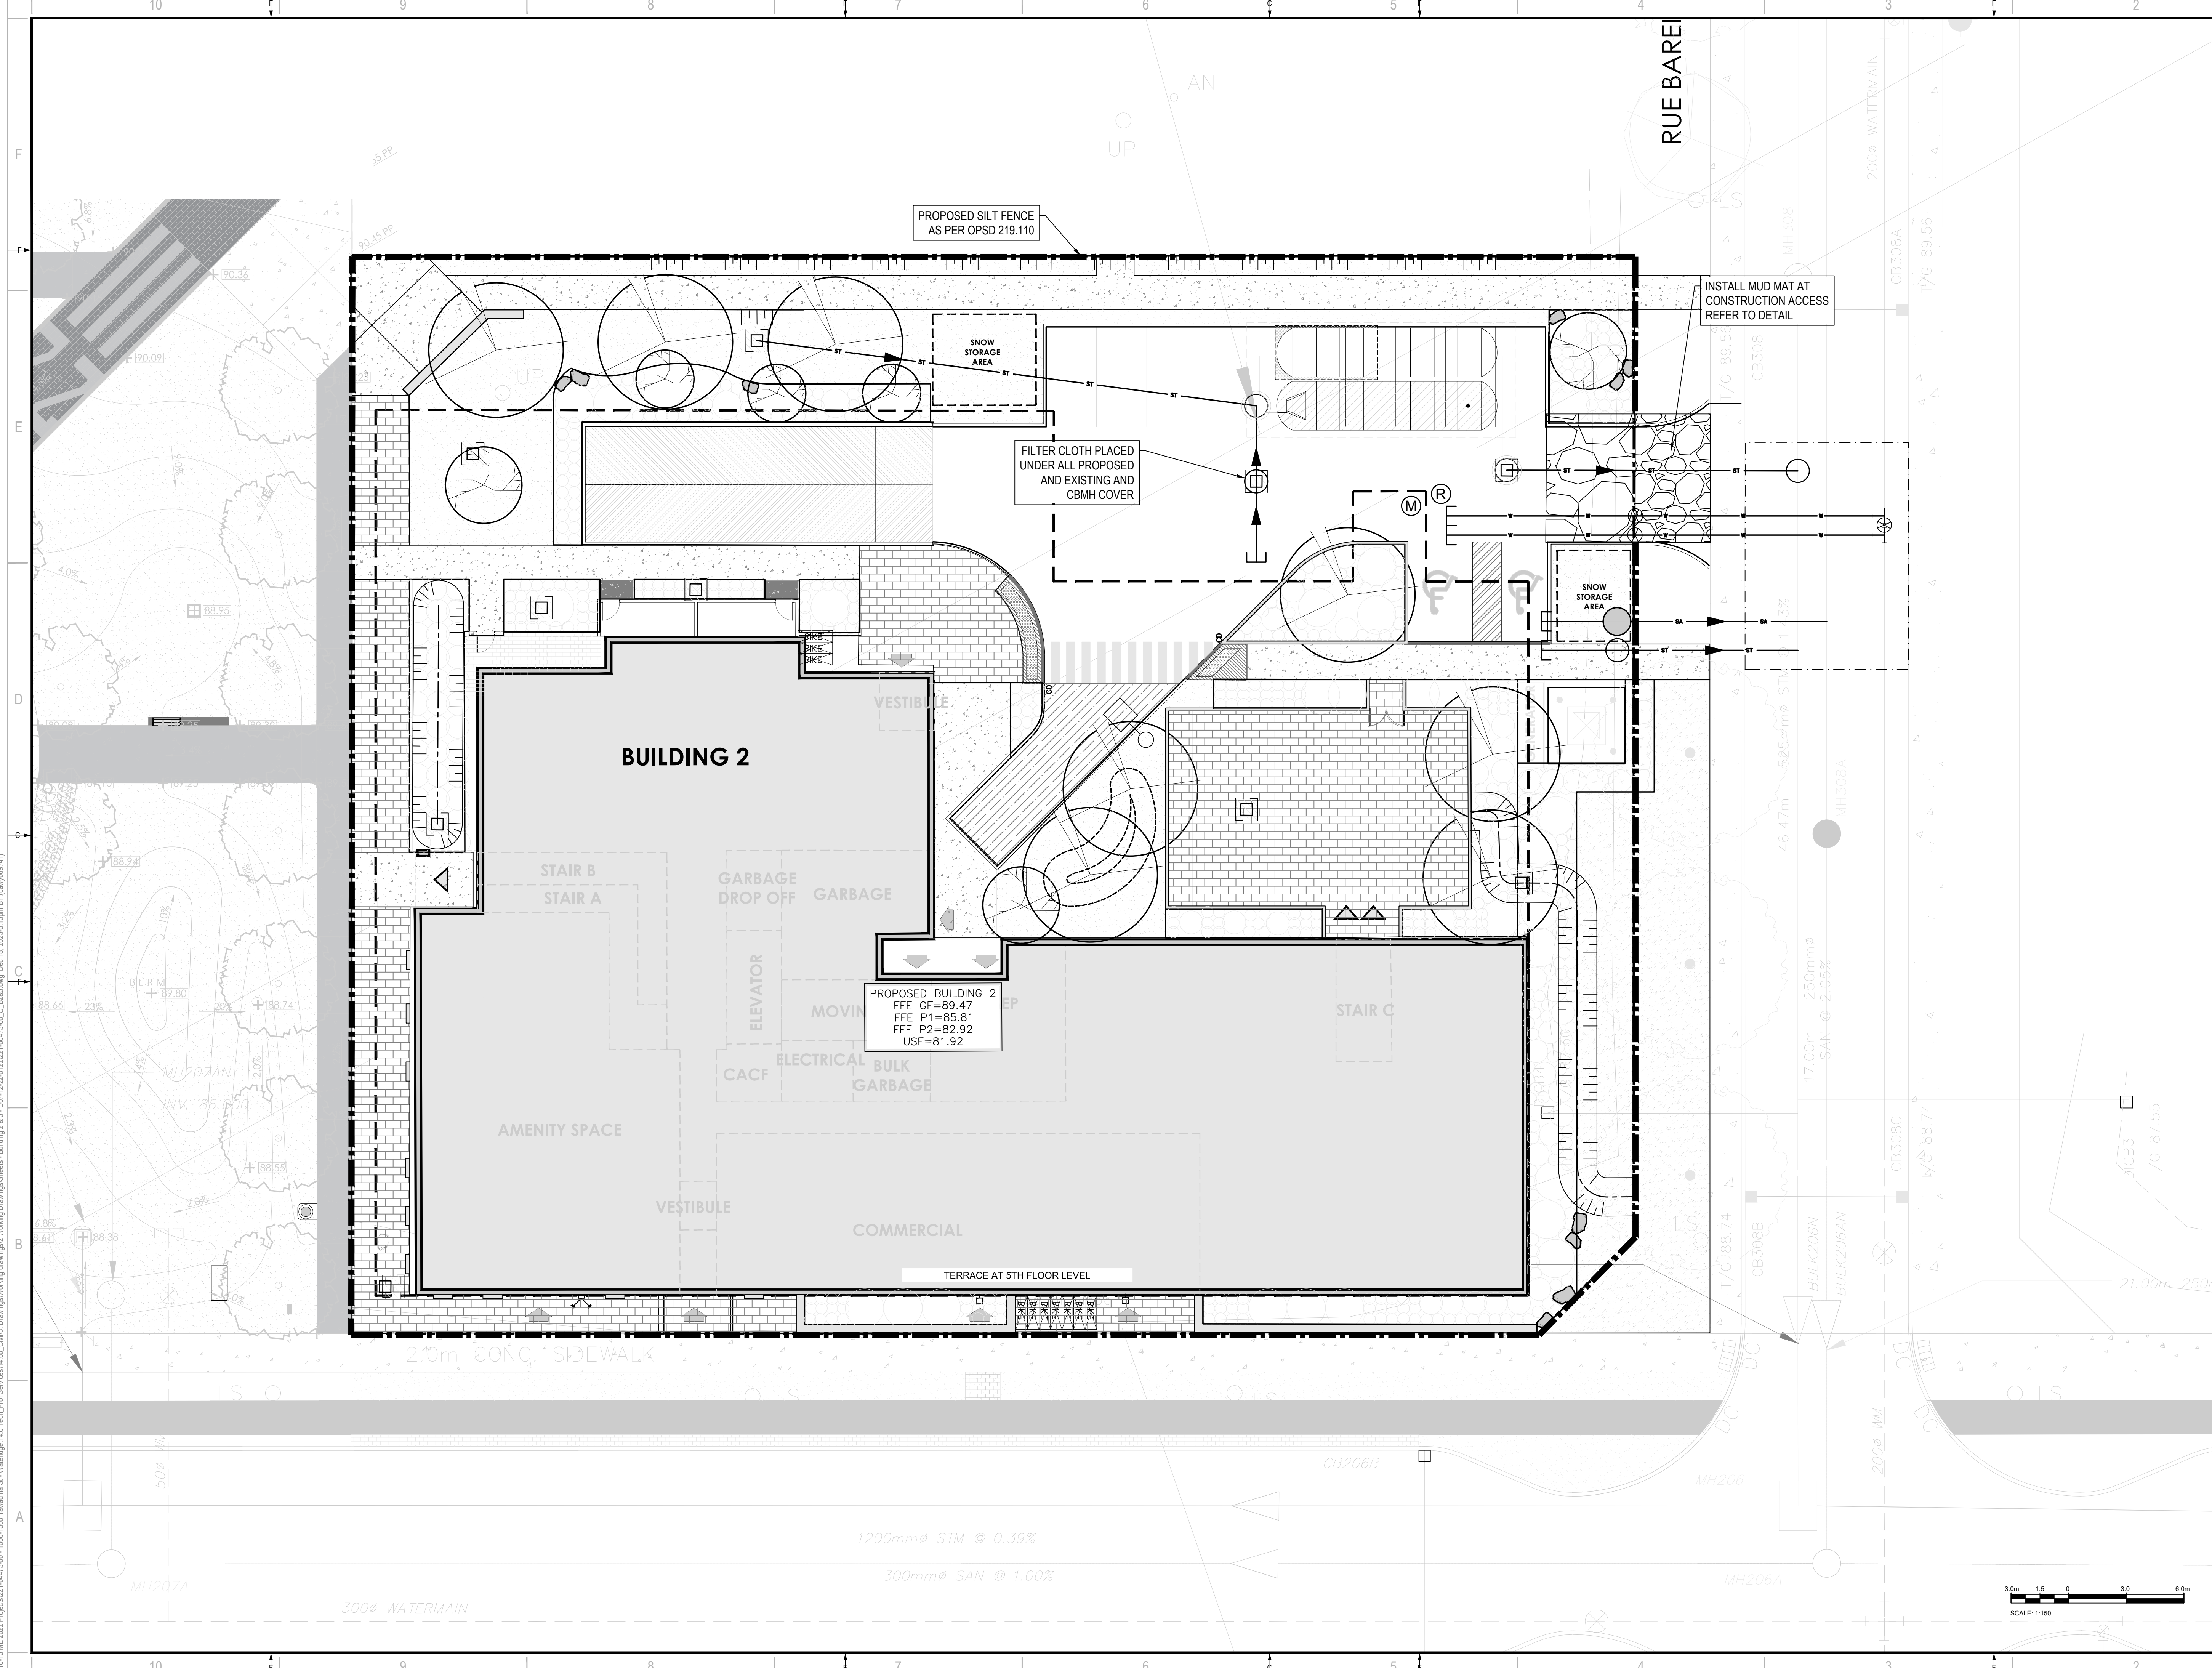

**BG BAYVIEW GROUP**

CLIENT REF #  
PROJECT  
**WATERIDGE APARTMENTS BUILDINGS**  
375 CODD'S ROAD AND  
1345 HEMLOCK ROAD,  
OTTAWA, ON



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BENCH MARK NO. 0191988130 ELEVATION + 55.06 m  
ELEVATIONS ARE GEODETIC, REFERRED TO CITY OF OTTAWA VERTICAL BENCH MARK NO. 396 (191988130), HAVING AN ELEVATION OF 85.08 METRES.  
COORDINATES ARE DERIVED FROM CANADIAN 2011 REAL TIME NETWORK GPS OBSERVATIONS REFERENCED TO SPECIFIED CONTROL POINTS 0191988100 AND 0191984761, MTM ZONE 9 (19'30" WEST LONGITUDE) NAD83 (SPRING91).

IS	REV	DATE	DESCRIPTION
5	2023-12-18	REVISED AS PER CITY COMMENTS	
4	2023-11-24	REVISED AS PER CITY COMMENTS	
3	2023-05-25	REVISED AS PER CITY COMMENTS	
2	2022-08-15	ISSUED FOR SPA	
1	2022-05-24	ISSUED FOR CLC REVIEW	

PROJECT NO: 221-04473-00  
ORIGINAL SCALE: 1:150  
DESIGNED BY: DY  
DRAWN BY: JT  
CHECKED BY: DY  
DISCIPLINE: CIVIL  
DATE: DECEMBER 2023  
IF THIS BAR IS NOT 25mm LONG, ADJUST YOUR PLOTTING SCALE.


TITLE:  
**EROSION AND SEDIMENTATION CONTROL PLAN - BUILDING 2**

SHEET NUMBER: C206  
SHEET # OF  
ISSUE: REVISED AS PER CITY COMMENTS  
DATE OF: 2023-12-18



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D07-12-22-0122

#XXXXX

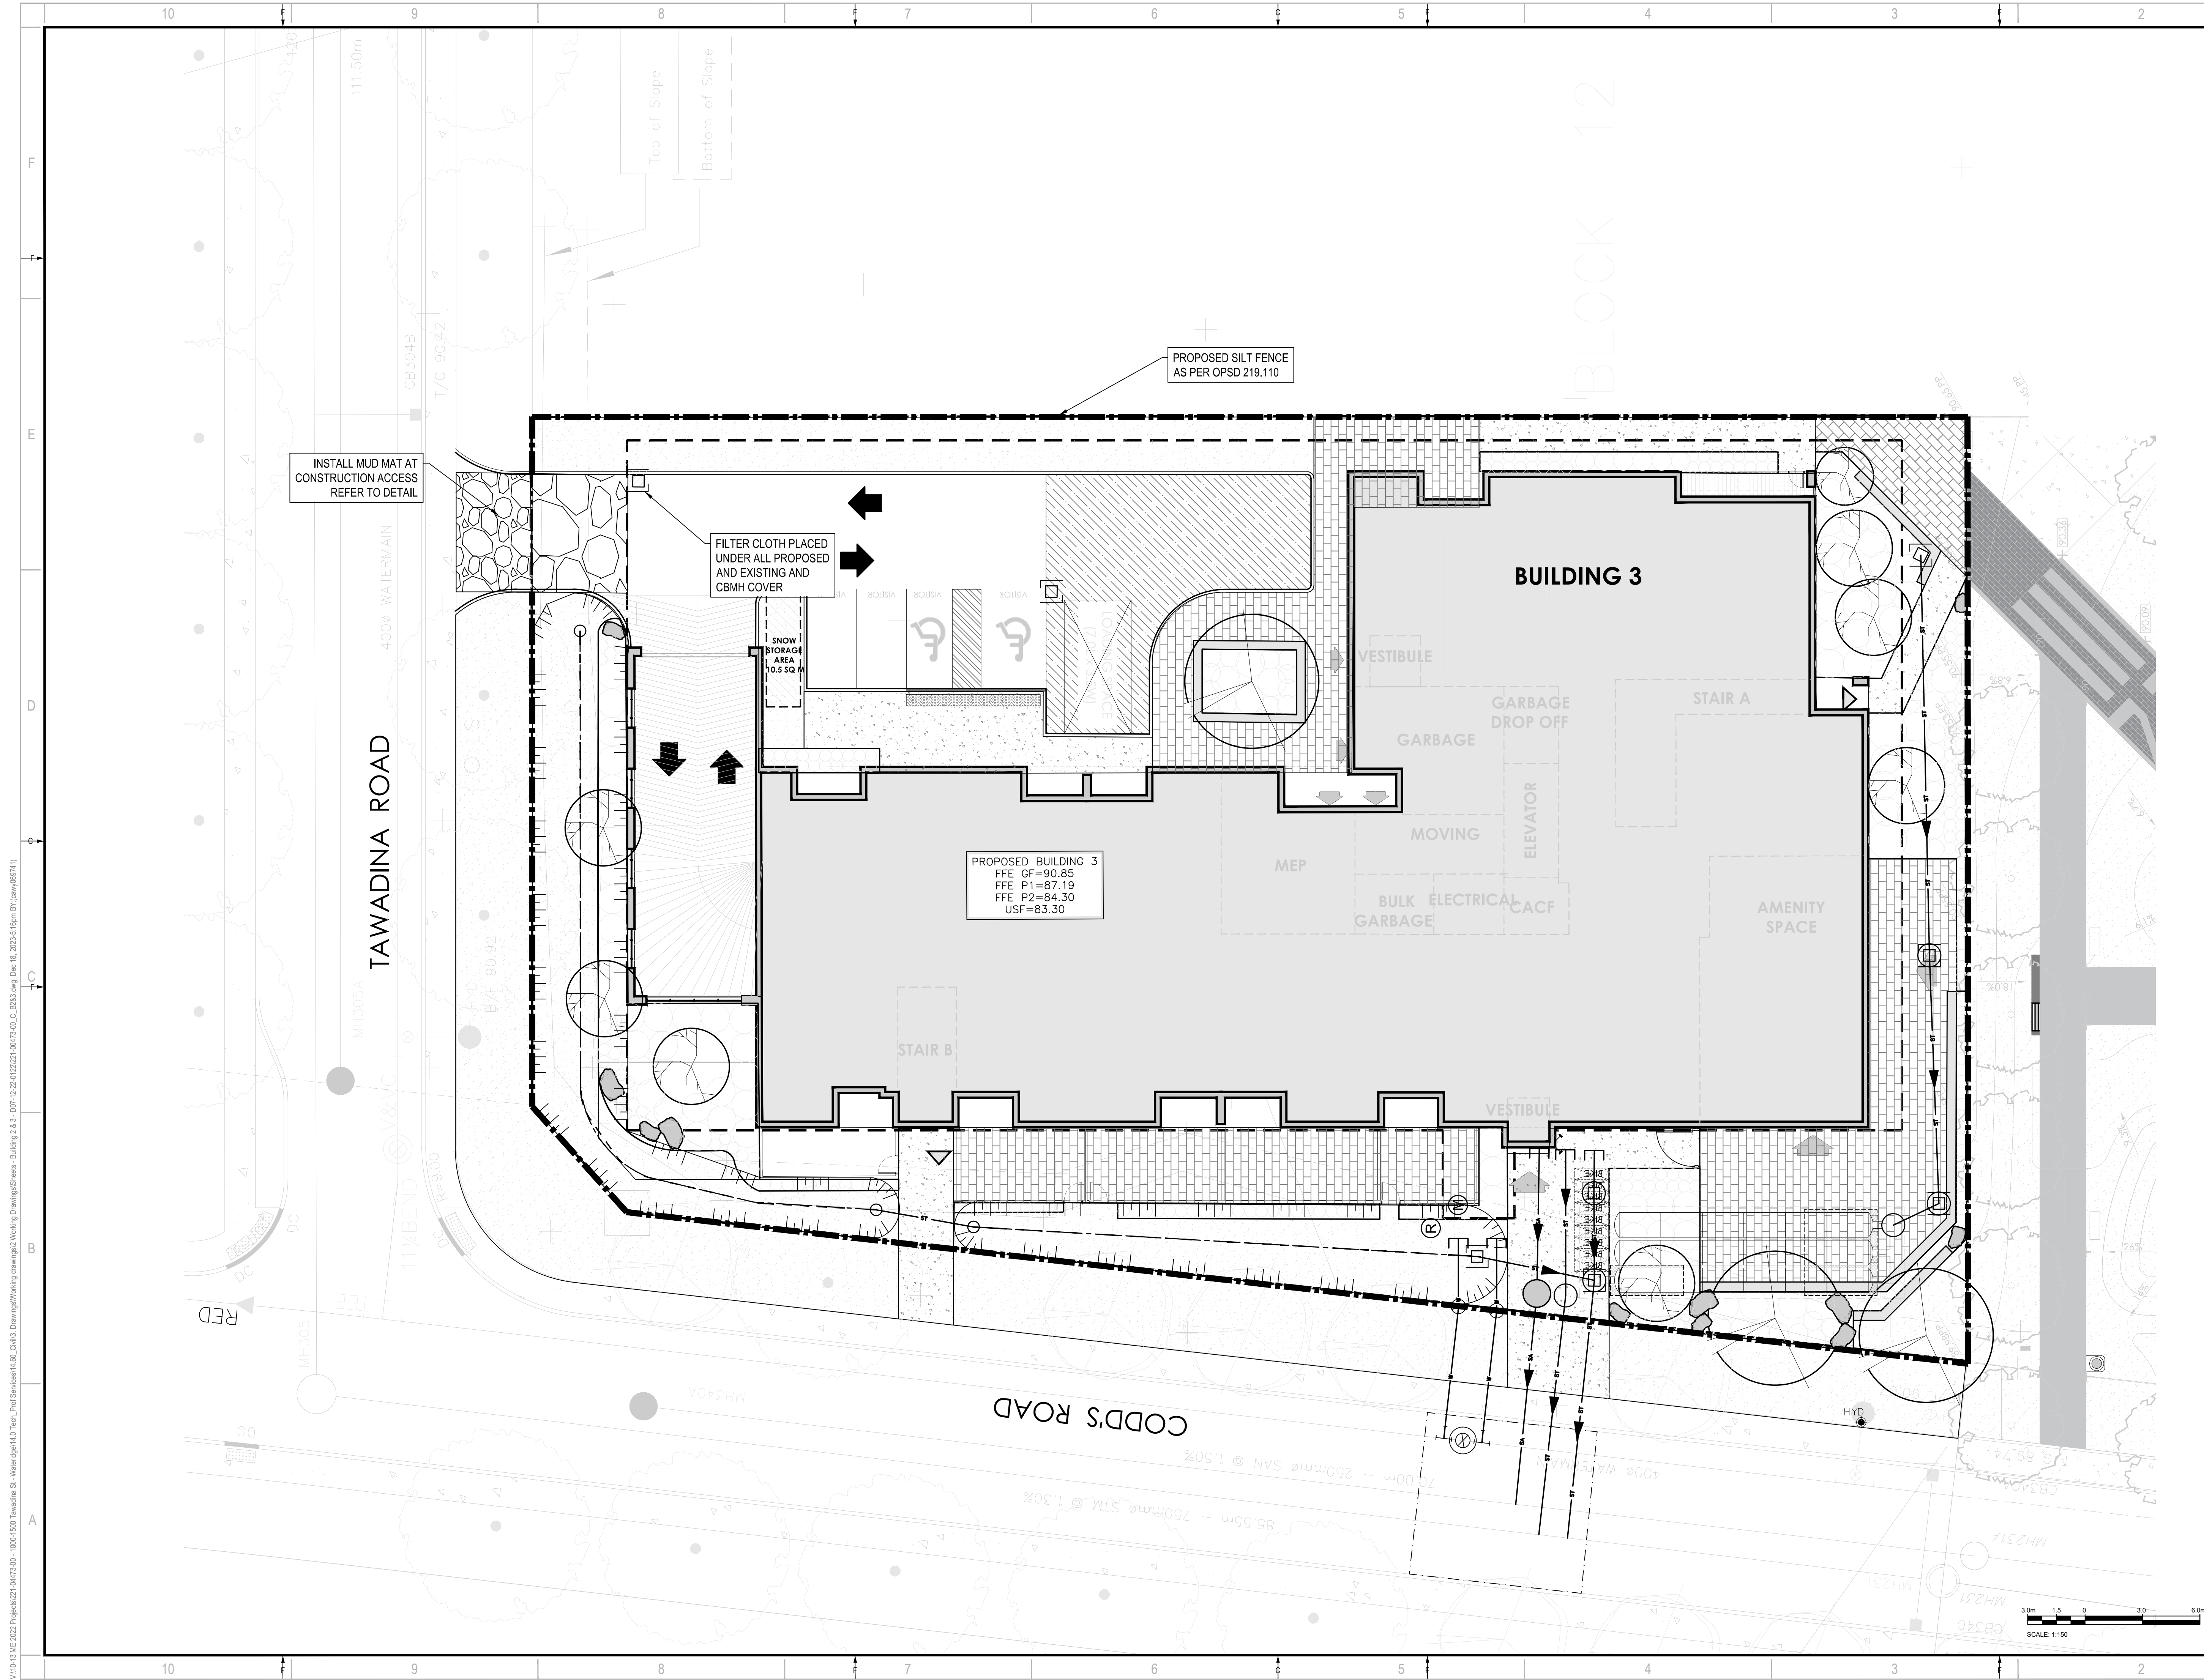

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CANADA L6H 0H7  
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**CLIENT REF #**  
**PROJECT**  
WATERIDGE  
APARTMENTS BUILDINGS  
375 CODD'S ROAD AND  
1345 HEMLOCK ROAD,  
OTTAWA, ON

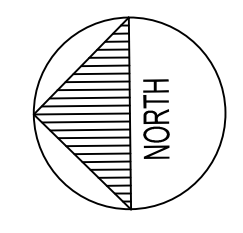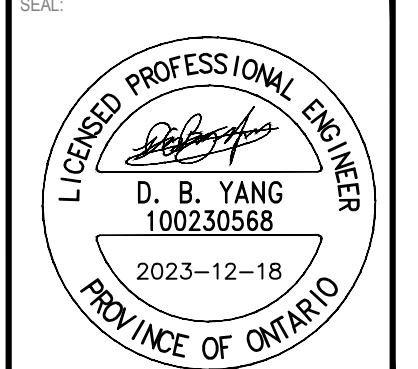

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**BENCH MARK No. 0191968130** ELEVATION = 55.06 m  
ELEVATIONS ARE GEODETIC, REFERRED TO CITY OF OTTAWA VERTICAL BENCH MARK No. 396  
@191968130, HAVING AN ELEVATION OF 86.08 METRES.  
COORDINATES ARE DERIVED FROM CANMET 2011 REAL TIME NETWORK GPS OBSERVATIONS  
REFERENCED TO SPECIFIED CONTROL POINTS 0191968100 AND 019484761, MTM ZONE 9 (19'30" WEST  
LONGITUDE) (NAD83 ORIGINAL).

**ISSUED FOR - REVISION**

NO.	DATE	DESCRIPTION
5	2023-12-18	REVISED AS PER CITY COMMENTS
4	2023-11-24	REVISED AS PER CITY COMMENTS
3	2023-05-25	REVISED AS PER CITY COMMENTS
2	2022-08-15	ISSUED FOR SPA
1	2022-05-24	ISSUED FOR CLC REVIEW

IS	RE	DATE	DESCRIPTION


<b>PROJECT NO.</b> 221-04473-00	<b>DATE:</b> DECEMBER 2023
<b>ORIGINAL SCALE:</b> 1:150	IF THIS BAR IS NOT 25mm LONG, ADJUST YOUR PLOTING SCALE.
<b>DESIGNED BY:</b> DY	
<b>DRAWN BY:</b> JT	
<b>CHECKED BY:</b> DY	

<b>DISCIPLINE:</b> CIVIL	
<b>TITLE:</b> EROSION AND SEDIMENTATION CONTROL PLAN - BUILDING 3	
<b>SHEET NUMBER:</b> C207	
<b>SHEET #</b> OF	
<b>ISSUE:</b> REVISED AS PER CITY COMMENTS	<b>REV #</b> 0
<b>DATE OF:</b> 2023-12-18	

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#XXXXX

D07-12-22-0122

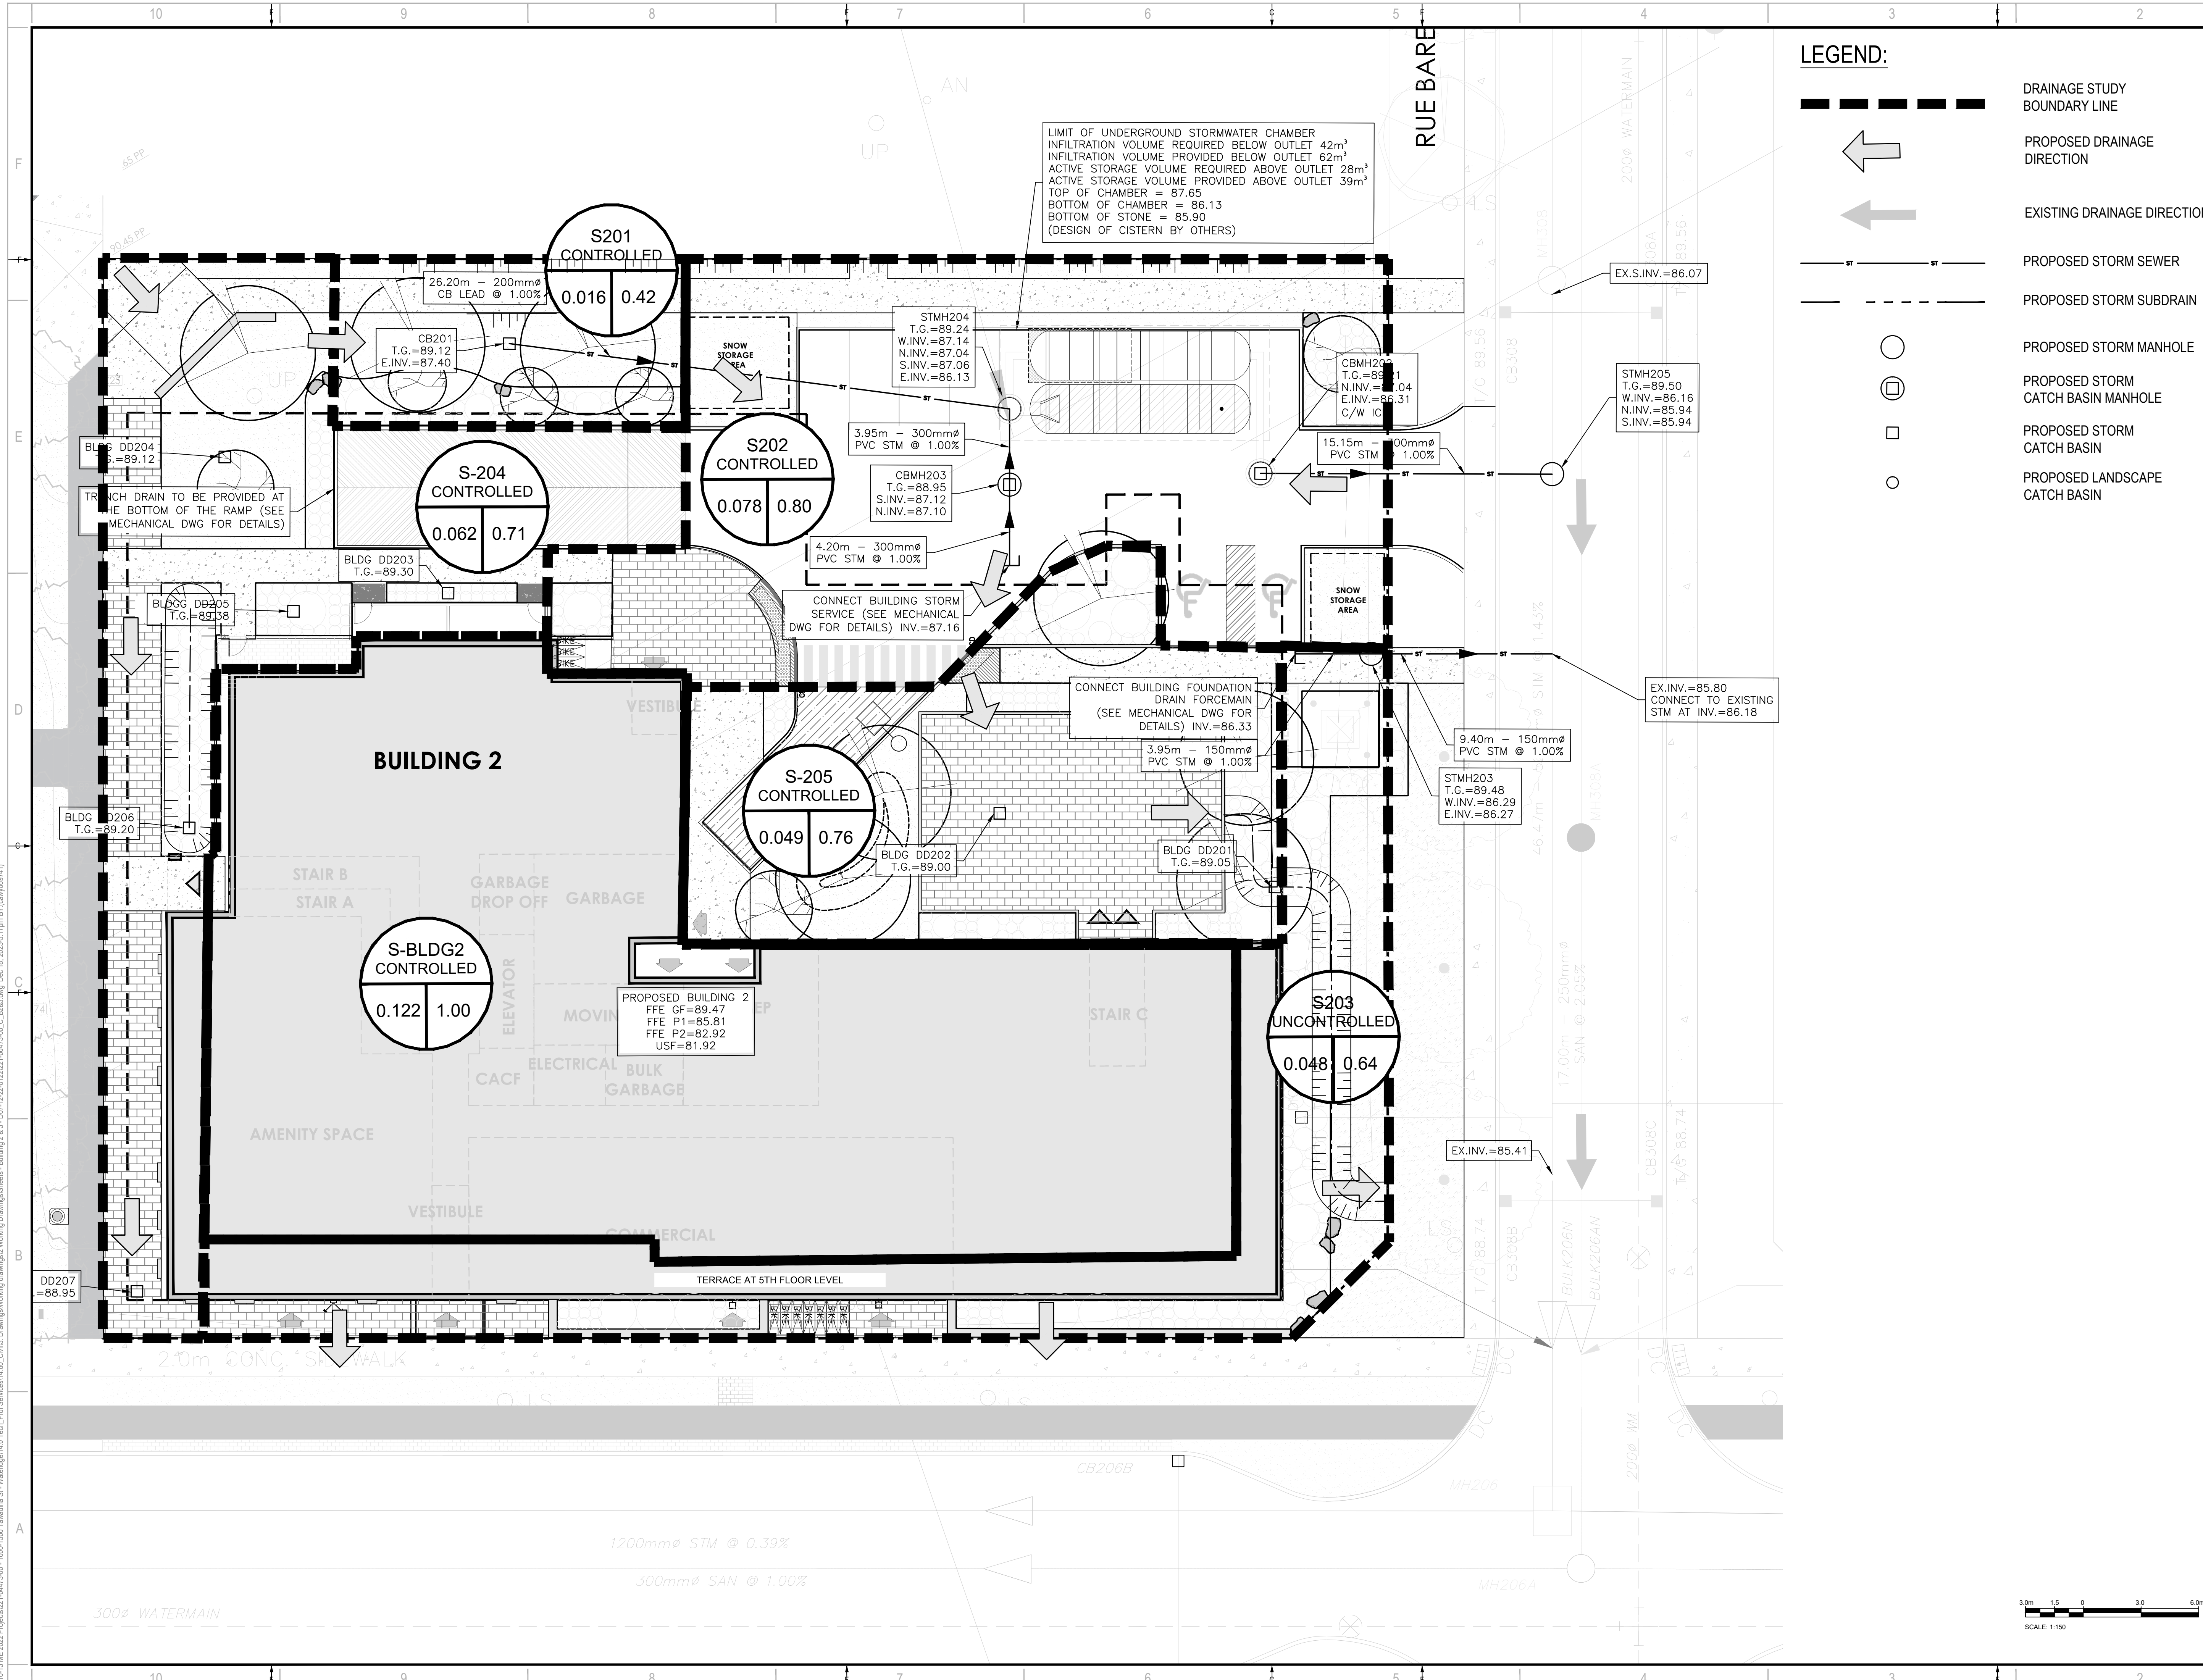

**LEGEND:**

- DRAINAGE STUDY BOUNDARY LINE
- PROPOSED DRAINAGE DIRECTION
- EXISTING DRAINAGE DIRECTION
- PROPOSED STORM SEWER
- PROPOSED STORM SUBDRAIN
- PROPOSED STORM MANHOLE
- PROPOSED STORM CATCH BASIN MANHOLE
- PROPOSED STORM CATCH BASIN
- PROPOSED LANDSCAPE CATCH BASIN

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ARCHITECT:  
**MATAJ ARCHITECTS INC.**  
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 CANADA L6H 0R7  
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 E: EVA@MATAJARCHITECTS.COM

SEAL:  
  
**D. B. YANG**  
 100230568  
 2023-12-18  
 PROVINCE OF ONTARIO

CLIENT:  
  
**BG BAYVIEW GROUP**

CLIENT REF #  
 PROJECT:  
**WATERIDGE APARTMENTS BUILDINGS**  
**375 CODD'S ROAD AND**  
**1345 HEMLOCK ROAD,**  
**OTTAWA, ON**

KEY PLAN:

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 ELEVATIONS ARE GEODETIC, REFERRED TO CITY OF OTTAWA VERTICAL BENCH MARK NO. 396 (1999/2001) HAVING AN ELEVATION OF 85.08 METRES.  
 COORDINATES ARE DERIVED FROM CANADIAN 2011 REAL TIME NETWORK GPS OBSERVATIONS REFERENCED TO SPECIFIED CONTROL POINTS 0191968100 AND 0191968101, MTM ZONE 9 (1983) WEST (LONGITUDE/NAD83 ORIGINAL).  
 ISSUED FOR: REVISION

NO.	DATE	DESCRIPTION
5	2023-12-18	REVISED AS PER CITY COMMENTS
4	2023-11-24	REVISED AS PER CITY COMMENTS
3	2023-05-25	REVISED AS PER CITY COMMENTS
2	2022-08-15	ISSUED FOR SPA
1	2022-05-24	ISSUED FOR CLC REVIEW

PROJECT NO:  
**221-04473-00**

DATE:  
**DECEMBER 2023**

ORIGINAL SCALE:  
**1:150**

DESIGNED BY:  
**DY**

DRAWN BY:  
**JT**

CHECKED BY:  
**DY**

DISCIPLINE:  
**CIVIL**

TITLE:  
**RESIDENTIAL DEVELOPMENT**  
**STORM DRAINAGE PLAN**  
**BUILDING 2**

SHEET NUMBER:  
**C208**

SHEET # OF  
**1**

ISSUE:  
**REVISED AS PER CITY COMMENTS**

DATE OF: 2023-12-18


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D07-12-22-0122





**LEGEND:**

- DRAINAGE STUDY BOUNDARY LINE
- PROPOSED DRAINAGE DIRECTION
- EXISTING DRAINAGE DIRECTION
- PROPOSED STORM SEWER
- PROPOSED STORM SUBDRAIN
- PROPOSED STORM MANHOLE
- PROPOSED STORM CATCH BASIN MANHOLE
- PROPOSED STORM CATCH BASIN
- PROPOSED LANDSCAPE CATCH BASIN
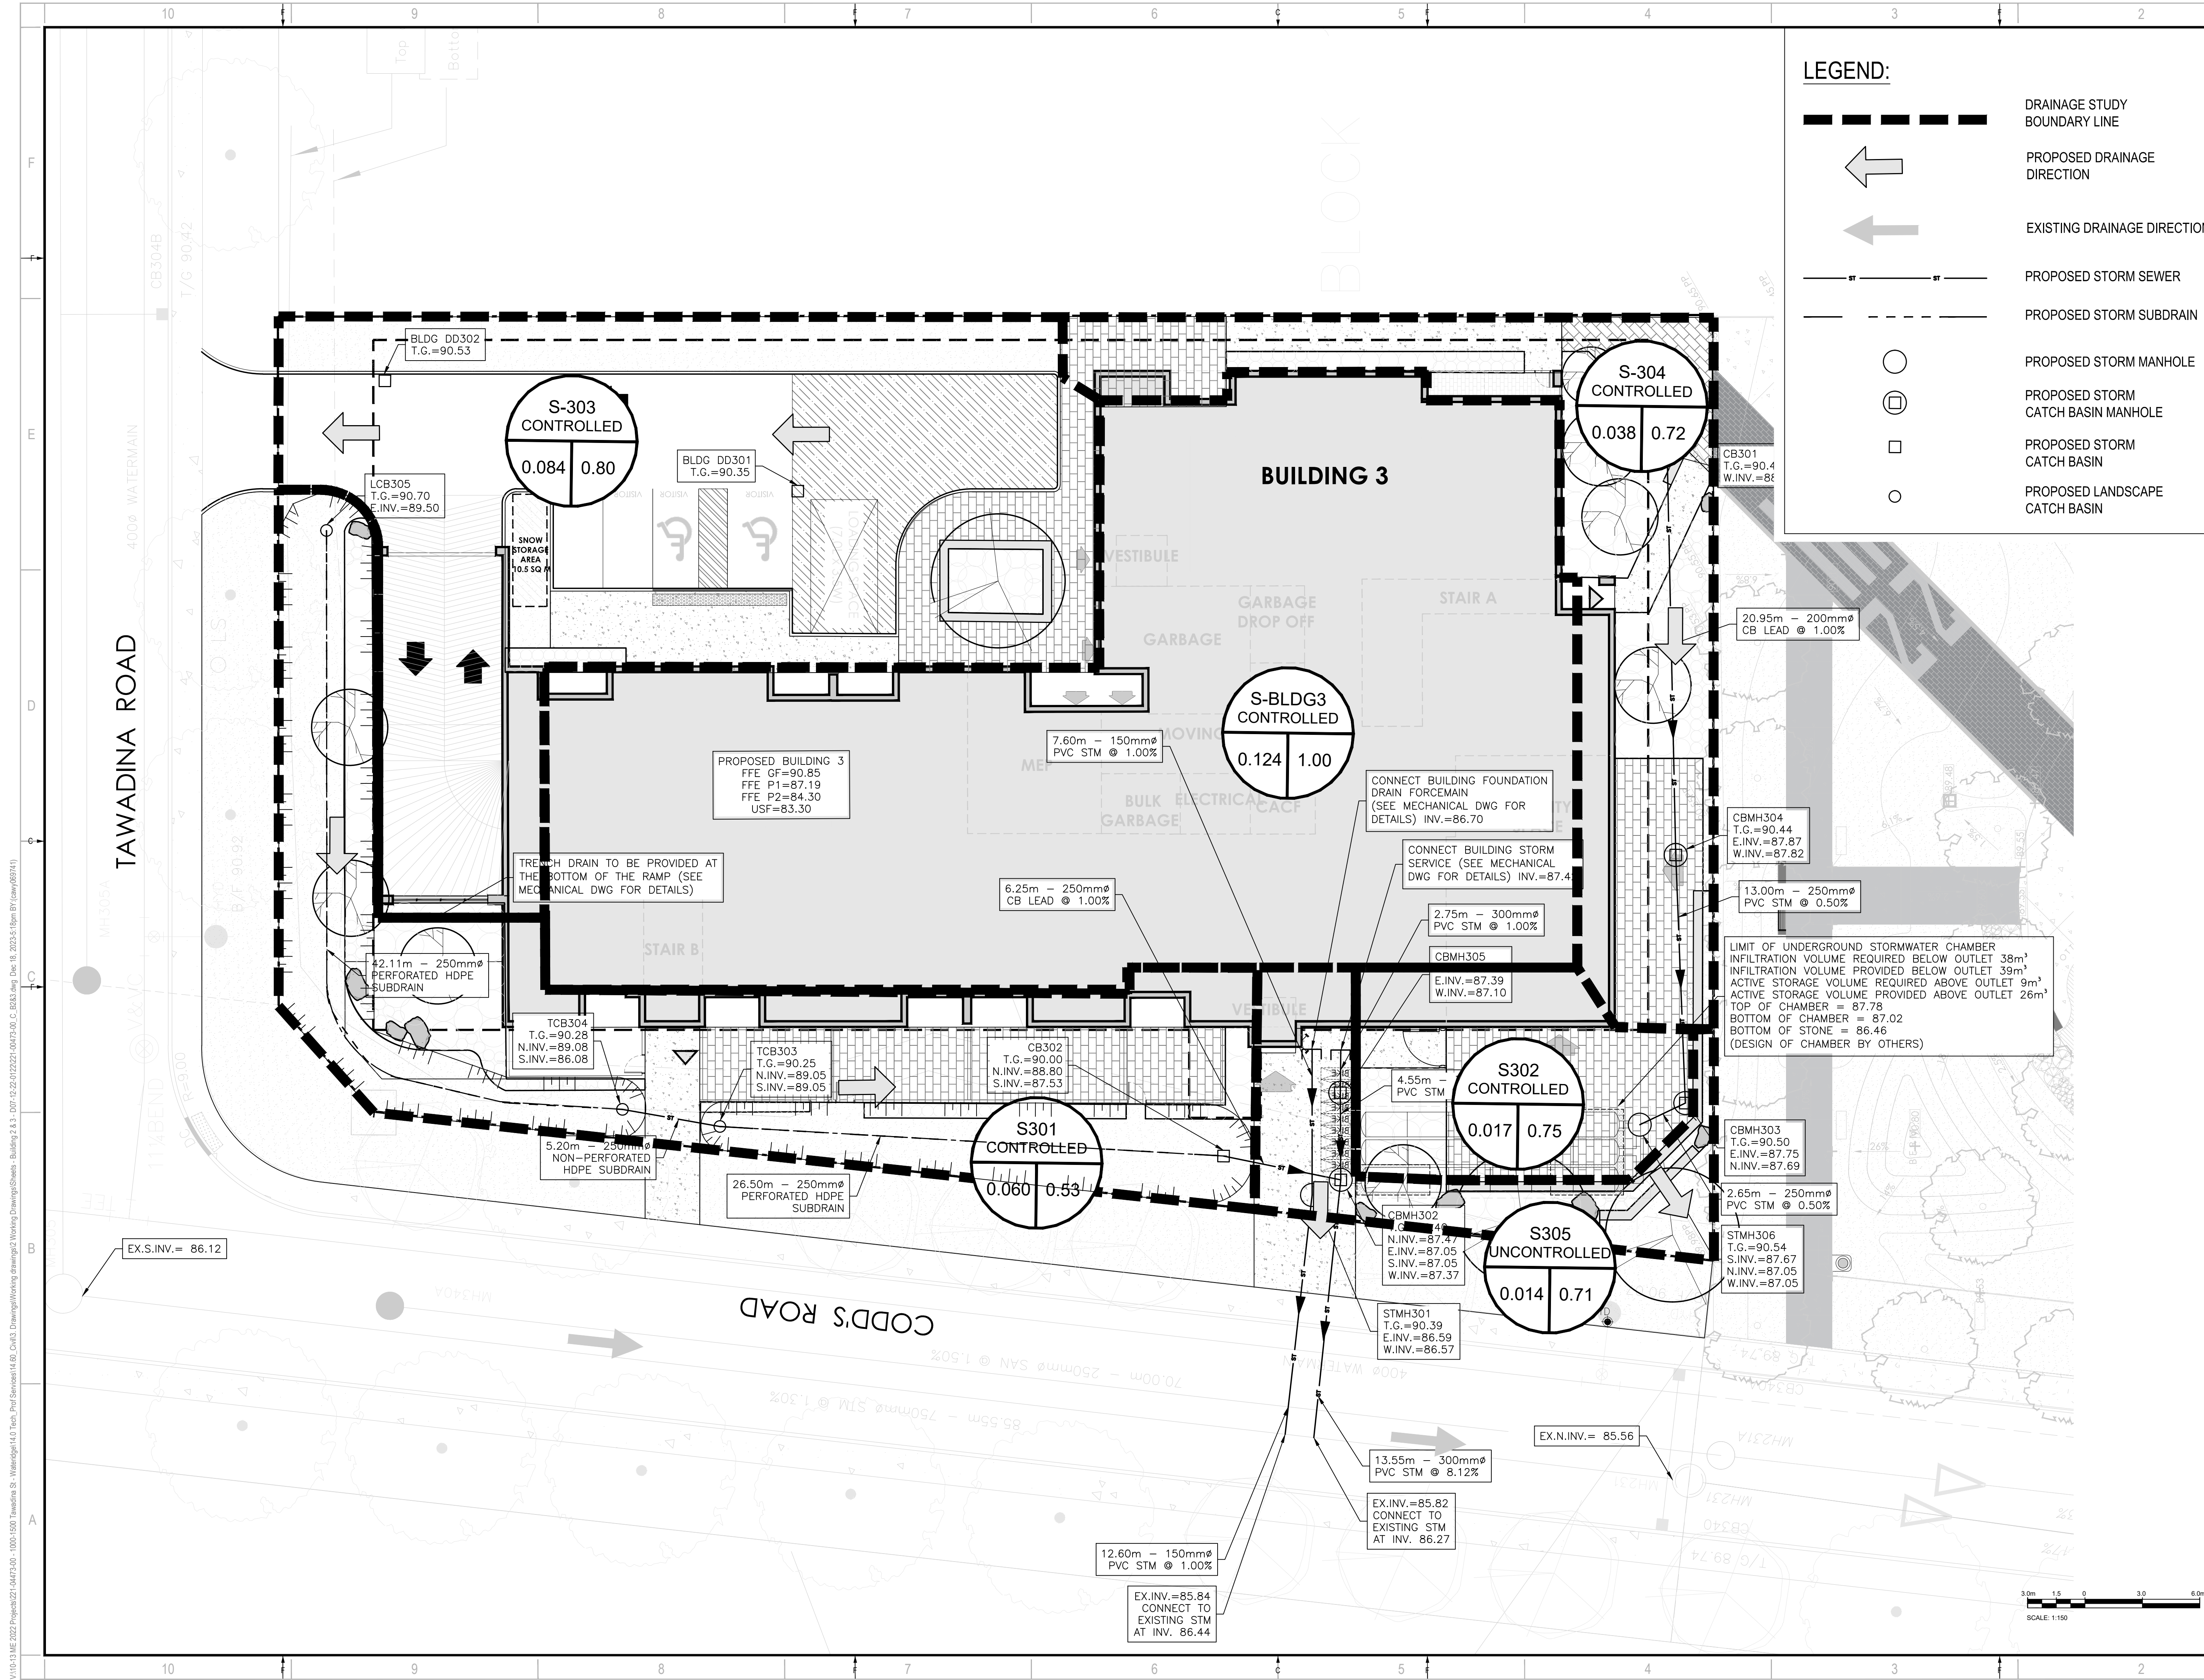
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 D. B. YANG  
 100230568  
 2023-12-18  
 PROVINCE OF ONTARIO

**NORTH**

**BG BAYVIEW GROUP**

**CLIENT REF #**  
**PROJECT**  
**WATERIDGE APARTMENTS BUILDINGS**  
**375 CODD'S ROAD AND**  
**1345 HEMLOCK ROAD,**  
**OTTAWA, ON**

**KEY PLAN**

**DISCLAIMER:**  
 THIS DRAWING AND DESIGN IS COPYRIGHT PROTECTED WHICH SHALL NOT BE USED, REPRODUCED OR REVISED WITHOUT WRITTEN PERMISSION BY WSP. THE CONTRACTOR SHALL CHECK AND VERIFY ALL DIMENSIONS AND UTILITY LOCATIONS AND REPORT ALL ERRORS AND OMISSIONS PRIOR TO COMMENCING WORK.  
 THIS DRAWING IS NOT TO BE SCALED.  
 BENCH MARK NO. 0191968100 ELEVATION = 92.06 m  
 ELEVATIONS ARE GEODETIC, REFERRED TO CITY OF OTTAWA VERTICAL BENCH MARK NO. 396  
 COORDINATES ARE DERIVED FROM CANADIAN 2011 REAL TIME NETWORK GPS OBSERVATIONS REFERENCED TO SPECIFIED CONTROL POINTS 0191968100 AND 019484761. MTM ZONE 9 (19'30" WEST LONGITUDE) (NAD83) (ORIGINAL).  
 ISSUED FOR: REVISION

IS	RE	DATE	DESCRIPTION
5		2023-12-18	REVISED AS PER CITY COMMENTS
4		2023-11-24	REVISED AS PER CITY COMMENTS
3		2023-05-25	REVISED AS PER CITY COMMENTS
2		2022-08-15	ISSUED FOR SPA
1		2022-05-24	ISSUED FOR CLC REVIEW

PROJECT NO.	DATE
221-04473-00	DECEMBER 2023

ORIGINAL SCALE: 1:150  
 DESIGNED BY: DY  
 DRAWN BY: JT  
 CHECKED BY: DY

**DISCIPLINE:** CIVIL

**TITLE:** RESIDENTIAL DEVELOPMENT STORM DRAINAGE PLAN BUILDING 3

**SHEET NUMBER:** C209

**ISSUE:** REVISED AS PER CITY COMMENTS

**DATE OF:** 2023-12-18

**REV #:** 0

V:\10-13-18-2022\Projects\221-04473-00-1000-1500\Tasadda.St.-Wateridge\14.00\_Civil3\_Drawing\Working drawings\2 Working Drawings\Sheets- Building 2 & 3 - D07-12-22-0122-001473-00\_C\_B233.dwg Dec 18, 2023 3:18pm BY: (maw/69741)

D07-12-22-0122

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