



ELEVATION NOTES
 1. ELEVATIONS ARE GEODETIC AND REFERRED TO CITY OF OTTAWA VERTICAL BENCH MARK NO. 396 (01919680138), HAVING AN ELEVATION OF 95.06 METRES.

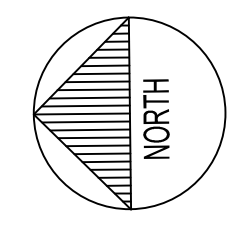

MATAJ ARCHITECTS INC.
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WATERIDGE APARTMENTS BUILDINGS
 375 CODD'S ROAD AND
 1345 HEMLOCK ROAD,
 OTTAWA, ON

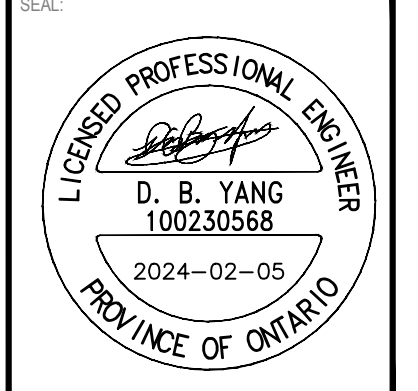

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 THIS DRAWING IS NOT TO BE SCALED.
 BENCH MARK NO. 01919680138 ELEVATION = 95.06 m
 ELEVATIONS ARE GEODETIC, REFERRED TO CITY OF OTTAWA VERTICAL BENCH MARK NO. 396 (01919680138), HAVING AN ELEVATION OF 95.06 METRES.
 COORDINATES ARE DERIVED FROM CANMET 2011 REAL TIME NETWORK GPS OBSERVATIONS REFERENCED TO SPECIFIED CONTROL POINTS 01919680100 AND 01919680101, MTM ZONE 9 (19'30" WEST LONGITUDE) (NAD83) (ORIGINAL).

ISSUED FOR - REVISION

NO.	DATE	DESCRIPTION
6	2024-02-05	REVISED AS PER CITY COMMENTS
5	2023-12-18	REVISED AS PER CITY COMMENTS
4	2023-11-24	REVISED AS PER CITY COMMENTS
3	2023-05-25	REVISED AS PER CITY COMMENTS
2	2022-08-15	ISSUED FOR SPA
1	2022-05-24	ISSUED FOR CLC REVIEW

PROJECT NO.	DATE
221-04473-00	FEBRUARY 2024

ORIGINAL SCALE: 1:150
 IF THIS BAR IS NOT 25mm LONG, ADJUST YOUR PLOTTING SCALE.

DESIGNED BY: DY
 DRAWN BY: JT
 CHECKED BY: DY


DISCIPLINE: CIVIL

TITLE
GRANDING PLAN - BUILDING 3

SHEET NUMBER: C203

ISSUE	REV #
REVISED AS PER CITY COMMENTS	0

DATE OF: 2024-02-05

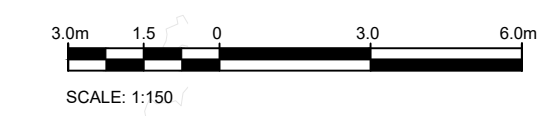

ROAD CUT AS PER CITY STD R10. ROAD TO BE REINSTATED TO EQUAL OR BETTER THAN ORIGINAL CONDITION.

V:\10-13.ME 2022 Projects\221-04473-00 - 1500 Tawadina St - Wateridge 14.00_Civil3_Drawing\Working drawings\2 Working Drawings\Sheet - Building 3 - 107-12-22-0122-0122-00_C. B333.dwg File 05_2024 14:02pm BY (maw08741)

D07-12-22-0122


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
STRUCTURE ID	AREA ID	TOP OF GRATE	STRUCTURE INFO				OUTLET PIPE INFO			ICD INFO			
			INLET	INLET	INLET	OUTLET	SIZE	OPSD	COVER	DIAMETER	TYPE	HEAD (m)	FLOW (l/s)
BUILDING 3													
CB301		90.45				88.080	600X600mm	OPSD 705.010	S19.1	200	PVC SDR-35		
CB302		90.00				88.800	87.000	600X600mm	OPSD 705.010	S19.1	200	PVC SDR-35	
TCB303		90.25				89.050	89.050	600X600mm	OPSD 705.010	S30	200	HDPE	
TCB304		90.28				89.080	86.080	600X600mm	OPSD 705.010	S30	200	HDPE	
LCB305		90.70				89.500	600X600mm	OPSD 705.010	S30	200	HDPE		
STMH301		90.39				86.590	86.570	1200mm DIA.	OPSD 701.010	S24.1	150	PVC SDR-35	
CBMH302		90.40		87.030		87.030	87.370	1200mm DIA.	OPSD 701.010	S28.1	300	PVC SDR-35	
CBMH303		90.50				87.750	87.690	1200mm DIA.	OPSD 701.010	S28.1	250	PVC SDR-35	
CBMH304		90.44				87.870	87.820	1200mm DIA.	OPSD 701.010	S28.1	250	PVC SDR-35	
CBMH305		90.61		87.030		87.030	87.030	1200mm DIA.	OPSD 701.010	S28.1	300	PVC SDR-35	
STMH306		90.54		87.670		87.050	87.050	1200mm DIA.	OPSD 701.010	S28.1	250	PVC SDR-35	

BUILDING 3	STATION	DESCRIPTION	Obvert		Invert		Clearance	Type	Notes
			Grade	Structure	Grade	Structure			
1	200mmØ PVC SAN		85.000	84.800	2.320	Clearance Under		EX. 400mmØ WM	
2	300mmØ PVC STM		86.940	86.640	0.350	Clearance Under		EX. 400mmØ WM	
3	150mmØ PVC STM		86.639	86.489	0.641	Clearance Under		EX. 400mmØ WM	
4	300mmØ PVC STM		86.687	86.387	1.018	Clearance Over		EX. 250mmØ PVC SAN	
5	150mmØ PVC STM		86.609	86.459	1.068	Clearance Over		EX. 250mmØ PVC SAN	

STATION	DESCRIPTION	FINISHED GRADE	TOP OF WATERMAIN	AS-BUILT WATERMAIN	COVER
0+000	W/M STUB		90.20	87.100	3.10
0+003.55	200mm VB		90.41	88.010	2.40
0+010.50	Connect to ex. 400mm W/M with TEE		90.17	87.770	2.40
1+000	W/M STUB		90.41	87.100	3.31
1+003.79	200mm VB		90.38	87.980	2.40
1+010.72	Connect to ex. 400mm W/M with TEE		90.15	87.750	2.40

STRUCTURE ID	TOP OF GRATE ELEVATION	INVERT			DESCRIPTION	SIZE	OPSD	COVER
		INLET	INLET	OUTLET				
BUILDING 3								
SANMH301	90.40		84.900	84.880	1200mm DIA.	OPSD-701.010	S24	




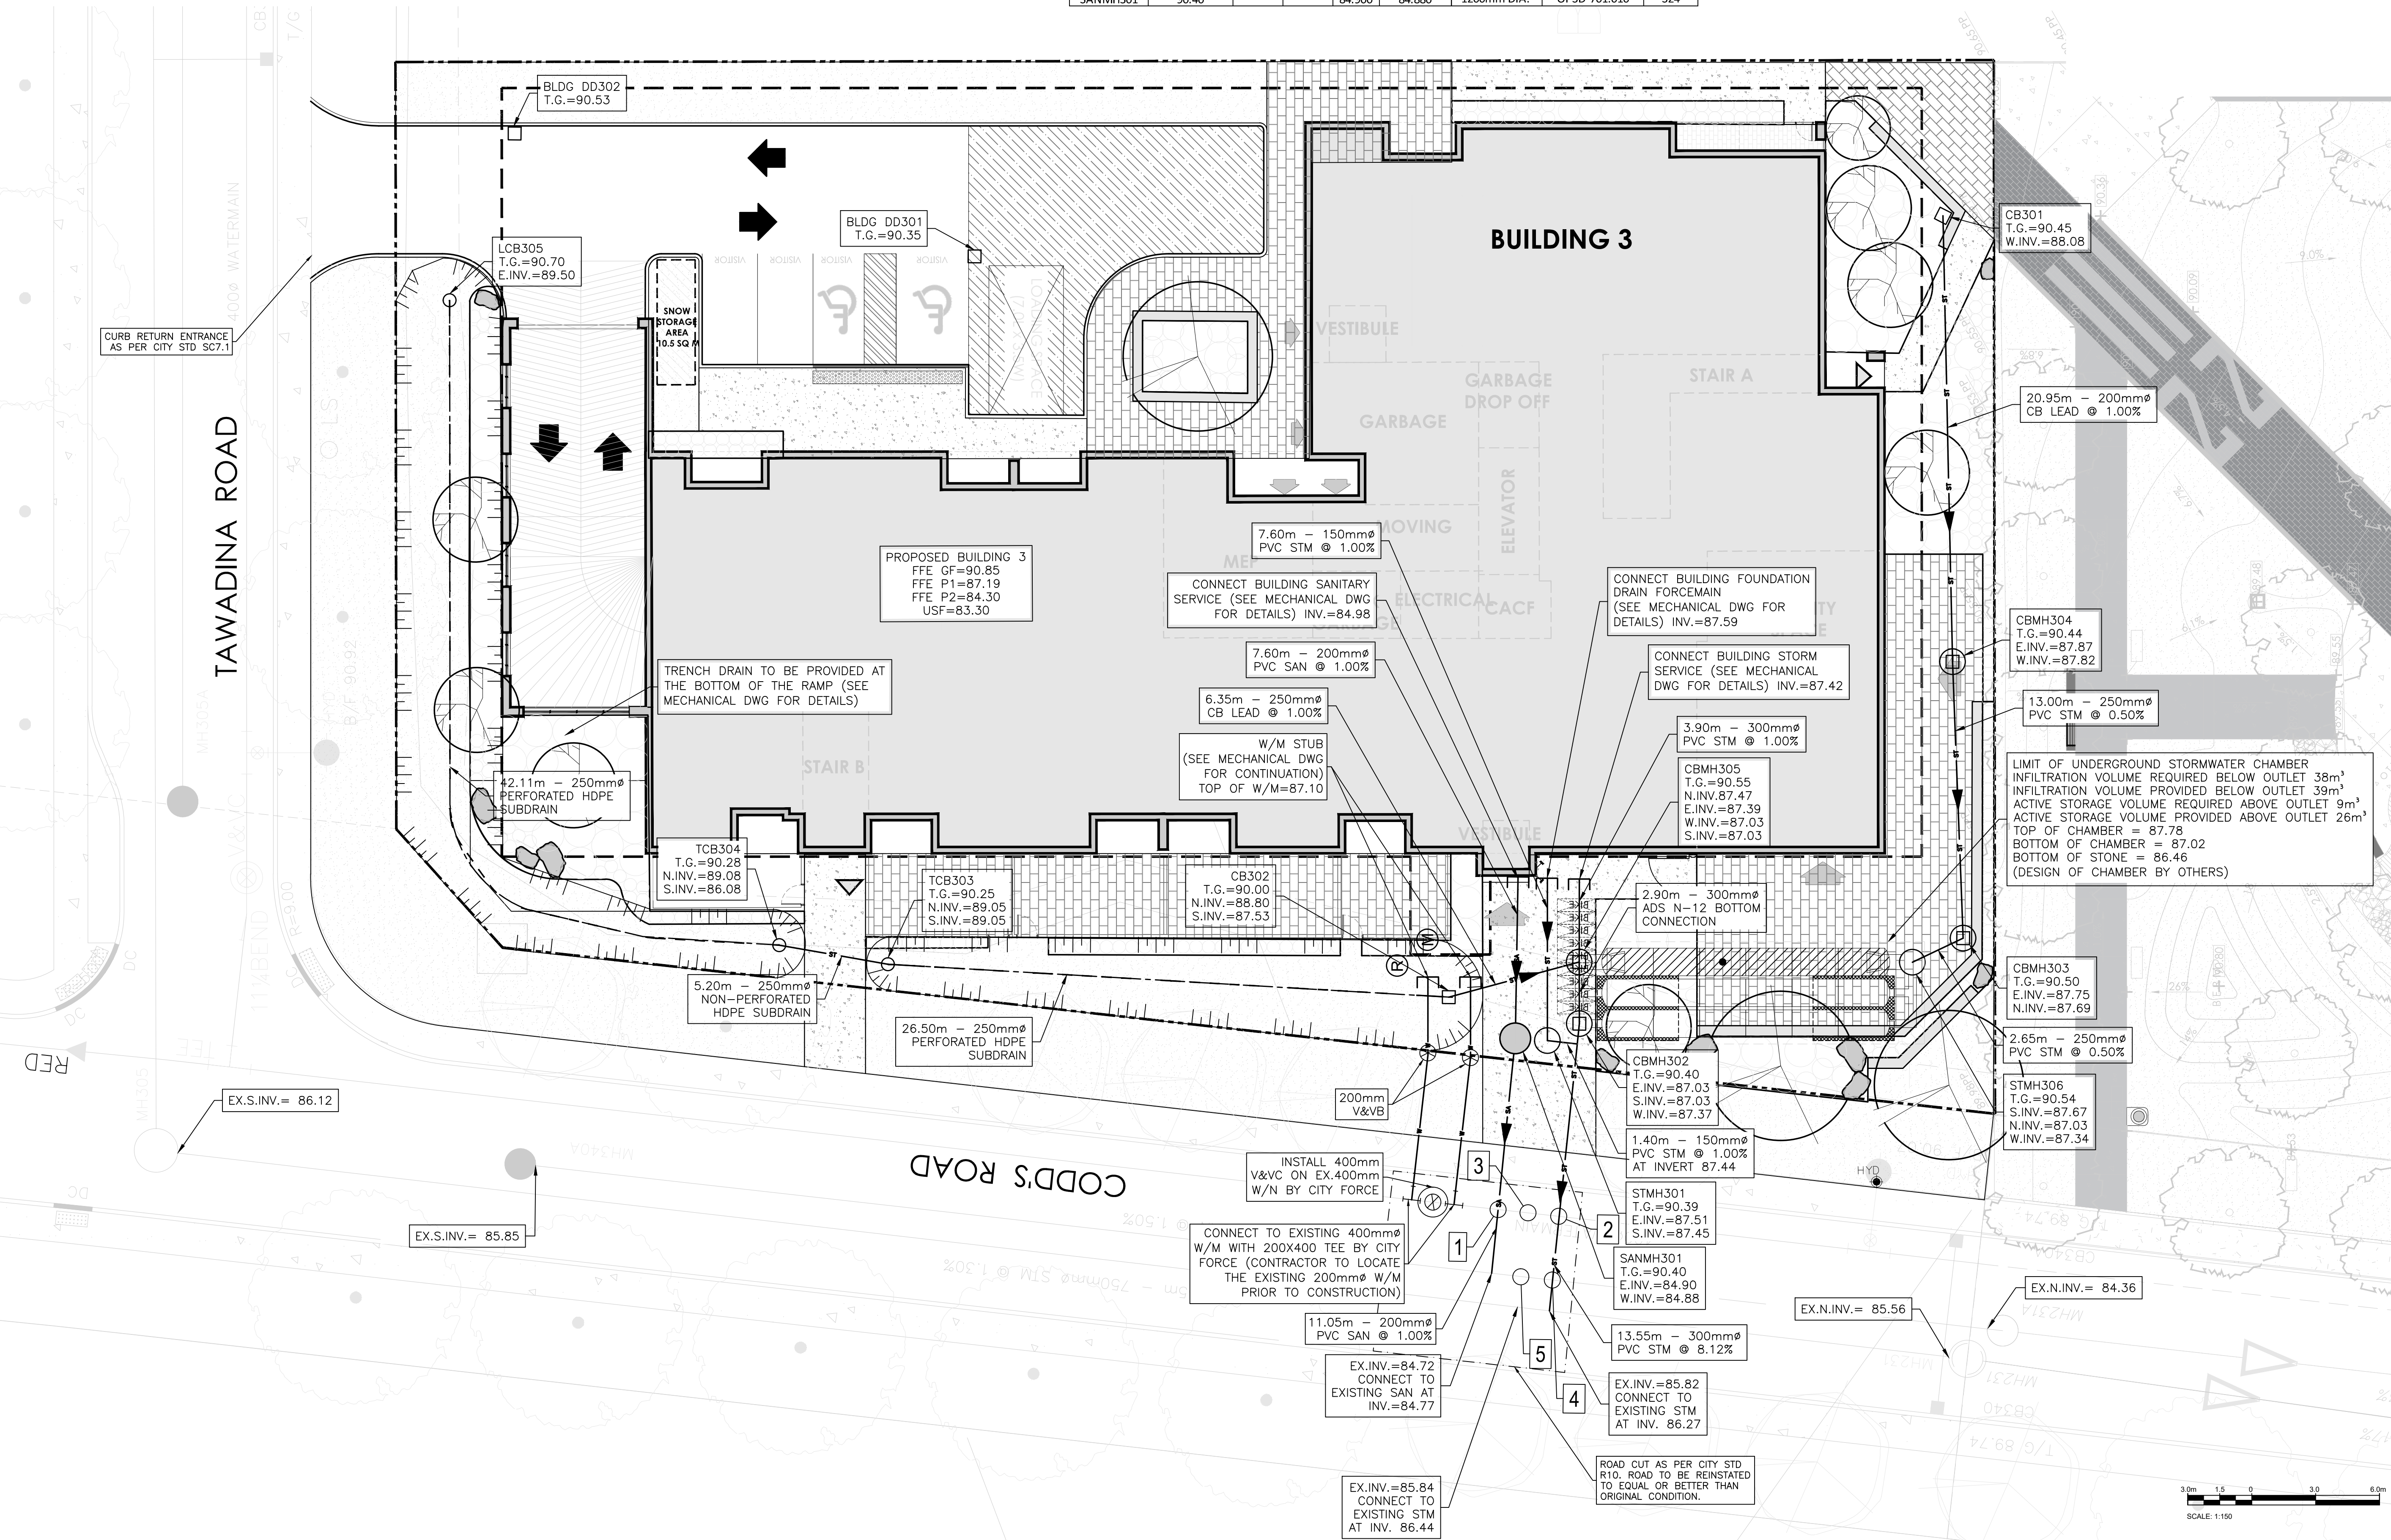


2011 QUEENSWAY DR.
OTTAWA, ONTARIO
CANADA K2B 8K2
T: 613-829-8300
F: 613-829-8299
WWW.WSP.COM

MATAJ ARCHITECTS INC.


418 IRAQUOIS SHORE ROAD, UNIT 206
OAKVILLE, ONTARIO
CANADA L6H 0H7
T: 416-897-2867
E: EVA@MATAJARCHITECTS.COM

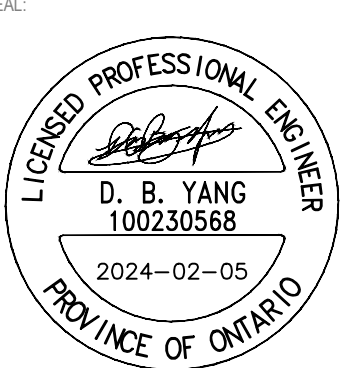


LICENCED PROFESSIONAL ENGINEER
D. B. YANG
100230568
2024-02-05
PROVINCE OF ONTARIO

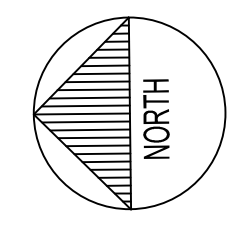

NORTH



WATERIDGE APARTMENTS BUILDINGS
375 CODD'S ROAD AND
1345 HEMLOCK ROAD,
OTTAWA, ON



NO.	DATE	DESCRIPTION
6	2024-02-05	REVISED AS PER CITY COMMENTS
5	2023-12-18	REVISED AS PER CITY COMMENTS
4	2023-11-24	REVISED AS PER CITY COMMENTS
3	2023-05-25	REVISED AS PER CITY COMMENTS
2	2022-08-15	ISSUED FOR SPA
1	2022-05-24	ISSUED FOR CLC REVIEW

IS	RE	DATE	DESCRIPTION
221-04473-00			FEBRUARY 2024

DESIGNED BY	DESIGNED BY	DATE
DI	DI	

DISCIPLINE	TITLE
CIVIL	SERVICING - BUILDING 3

SHEET NUMBER	OF
C205	


ISSUE	REV #
REVISED AS PER CITY COMMENTS	0

DATE OF: 2024-02-05

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D07-12-22-0122



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2011 QUEENVIEW DR.
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CANADA K2B 8K2
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WWW.WSP.COM

MATAJ ARCHITECTS INC.
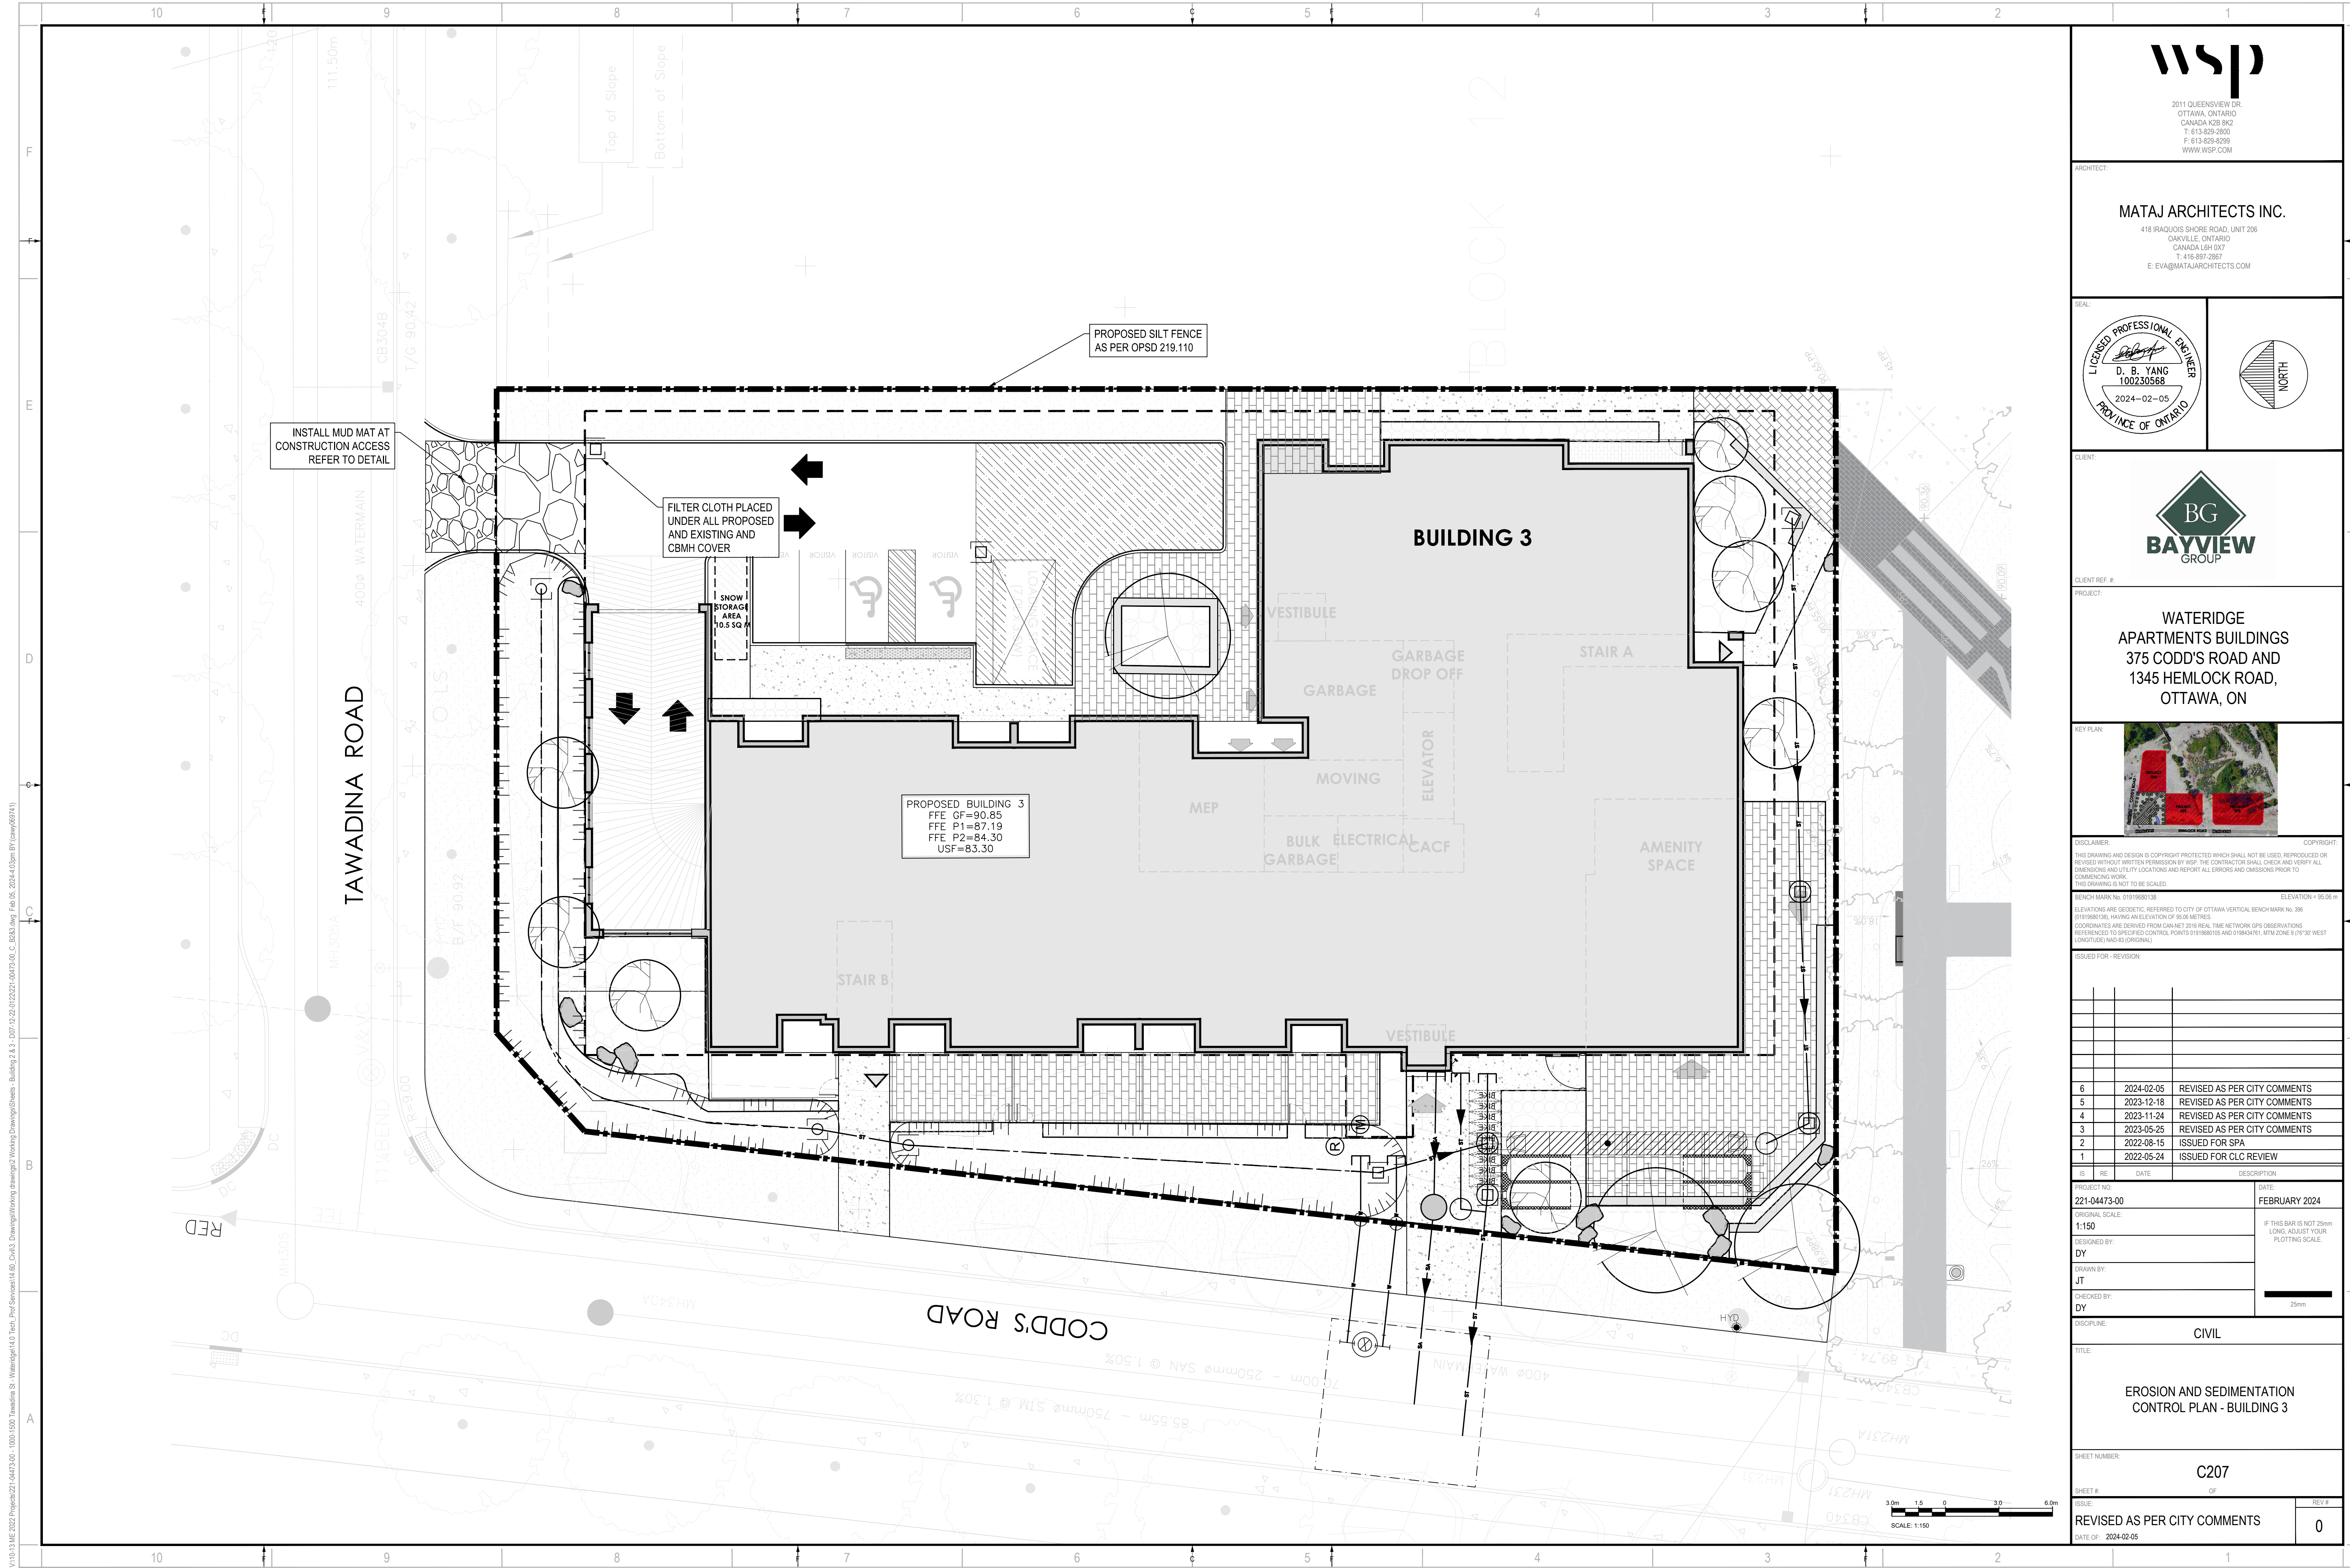
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OAKVILLE, ONTARIO
CANADA L6H 0H7
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CLIENT REF #
PROJECT
WATERIDGE APARTMENTS BUILDINGS
375 CODD'S ROAD AND
1345 HEMLOCK ROAD,
OTTAWA, ON



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BENCH MARK NO: 01919680130 ELEVATION: +55.06 m
ELEVATIONS ARE GEODETIC, REFERRED TO CITY OF OTTAWA VERTICAL BENCH MARK NO. 396 (P1919680130), HAVING AN ELEVATION OF 86.08 METRES.
COORDINATES ARE DERIVED FROM CANADIAN 2011 REAL TIME NETWORK GPS OBSERVATIONS REFERENCED TO SPECIFIED CONTROL POINTS 01919680100 AND 0194454701 (MTM ZONE 9 19'30" WEST LONGITUDE) (NAD83 ORIGINAL).

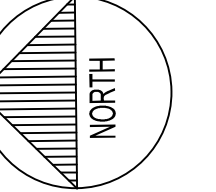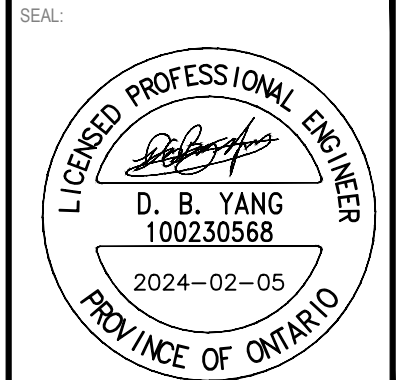ISSUED FOR: REVISION

NO.	DATE	DESCRIPTION
6	2024-02-05	REVISED AS PER CITY COMMENTS
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4	2023-11-24	REVISED AS PER CITY COMMENTS
3	2023-05-25	REVISED AS PER CITY COMMENTS
2	2022-08-15	ISSUED FOR SPA
1	2022-05-24	ISSUED FOR CLC REVIEW

PROJECT NO: 221-04473-00 DATE: FEBRUARY 2024

ORIGINAL SCALE: 1:150
DESIGNED BY: DY
DRAWN BY: JT
CHECKED BY: DY
DISCIPLINE: CIVIL


TITLE: **EROSION AND SEDIMENTATION CONTROL PLAN - BUILDING 3**
SHEET NUMBER: C207
SHEET # OF
ISSUE: REVISED AS PER CITY COMMENTS
DATE OF: 2024-02-05



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D07-12-22-0122

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LEGEND:

- DRAINAGE STUDY BOUNDARY LINE
- PROPOSED DRAINAGE DIRECTION
- EXISTING DRAINAGE DIRECTION
- PROPOSED STORM SEWER
- PROPOSED STORM SUBDRAIN
- PROPOSED STORM MANHOLE
- PROPOSED STORM CATCH BASIN MANHOLE
- PROPOSED STORM CATCH BASIN
- PROPOSED LANDSCAPE CATCH BASIN
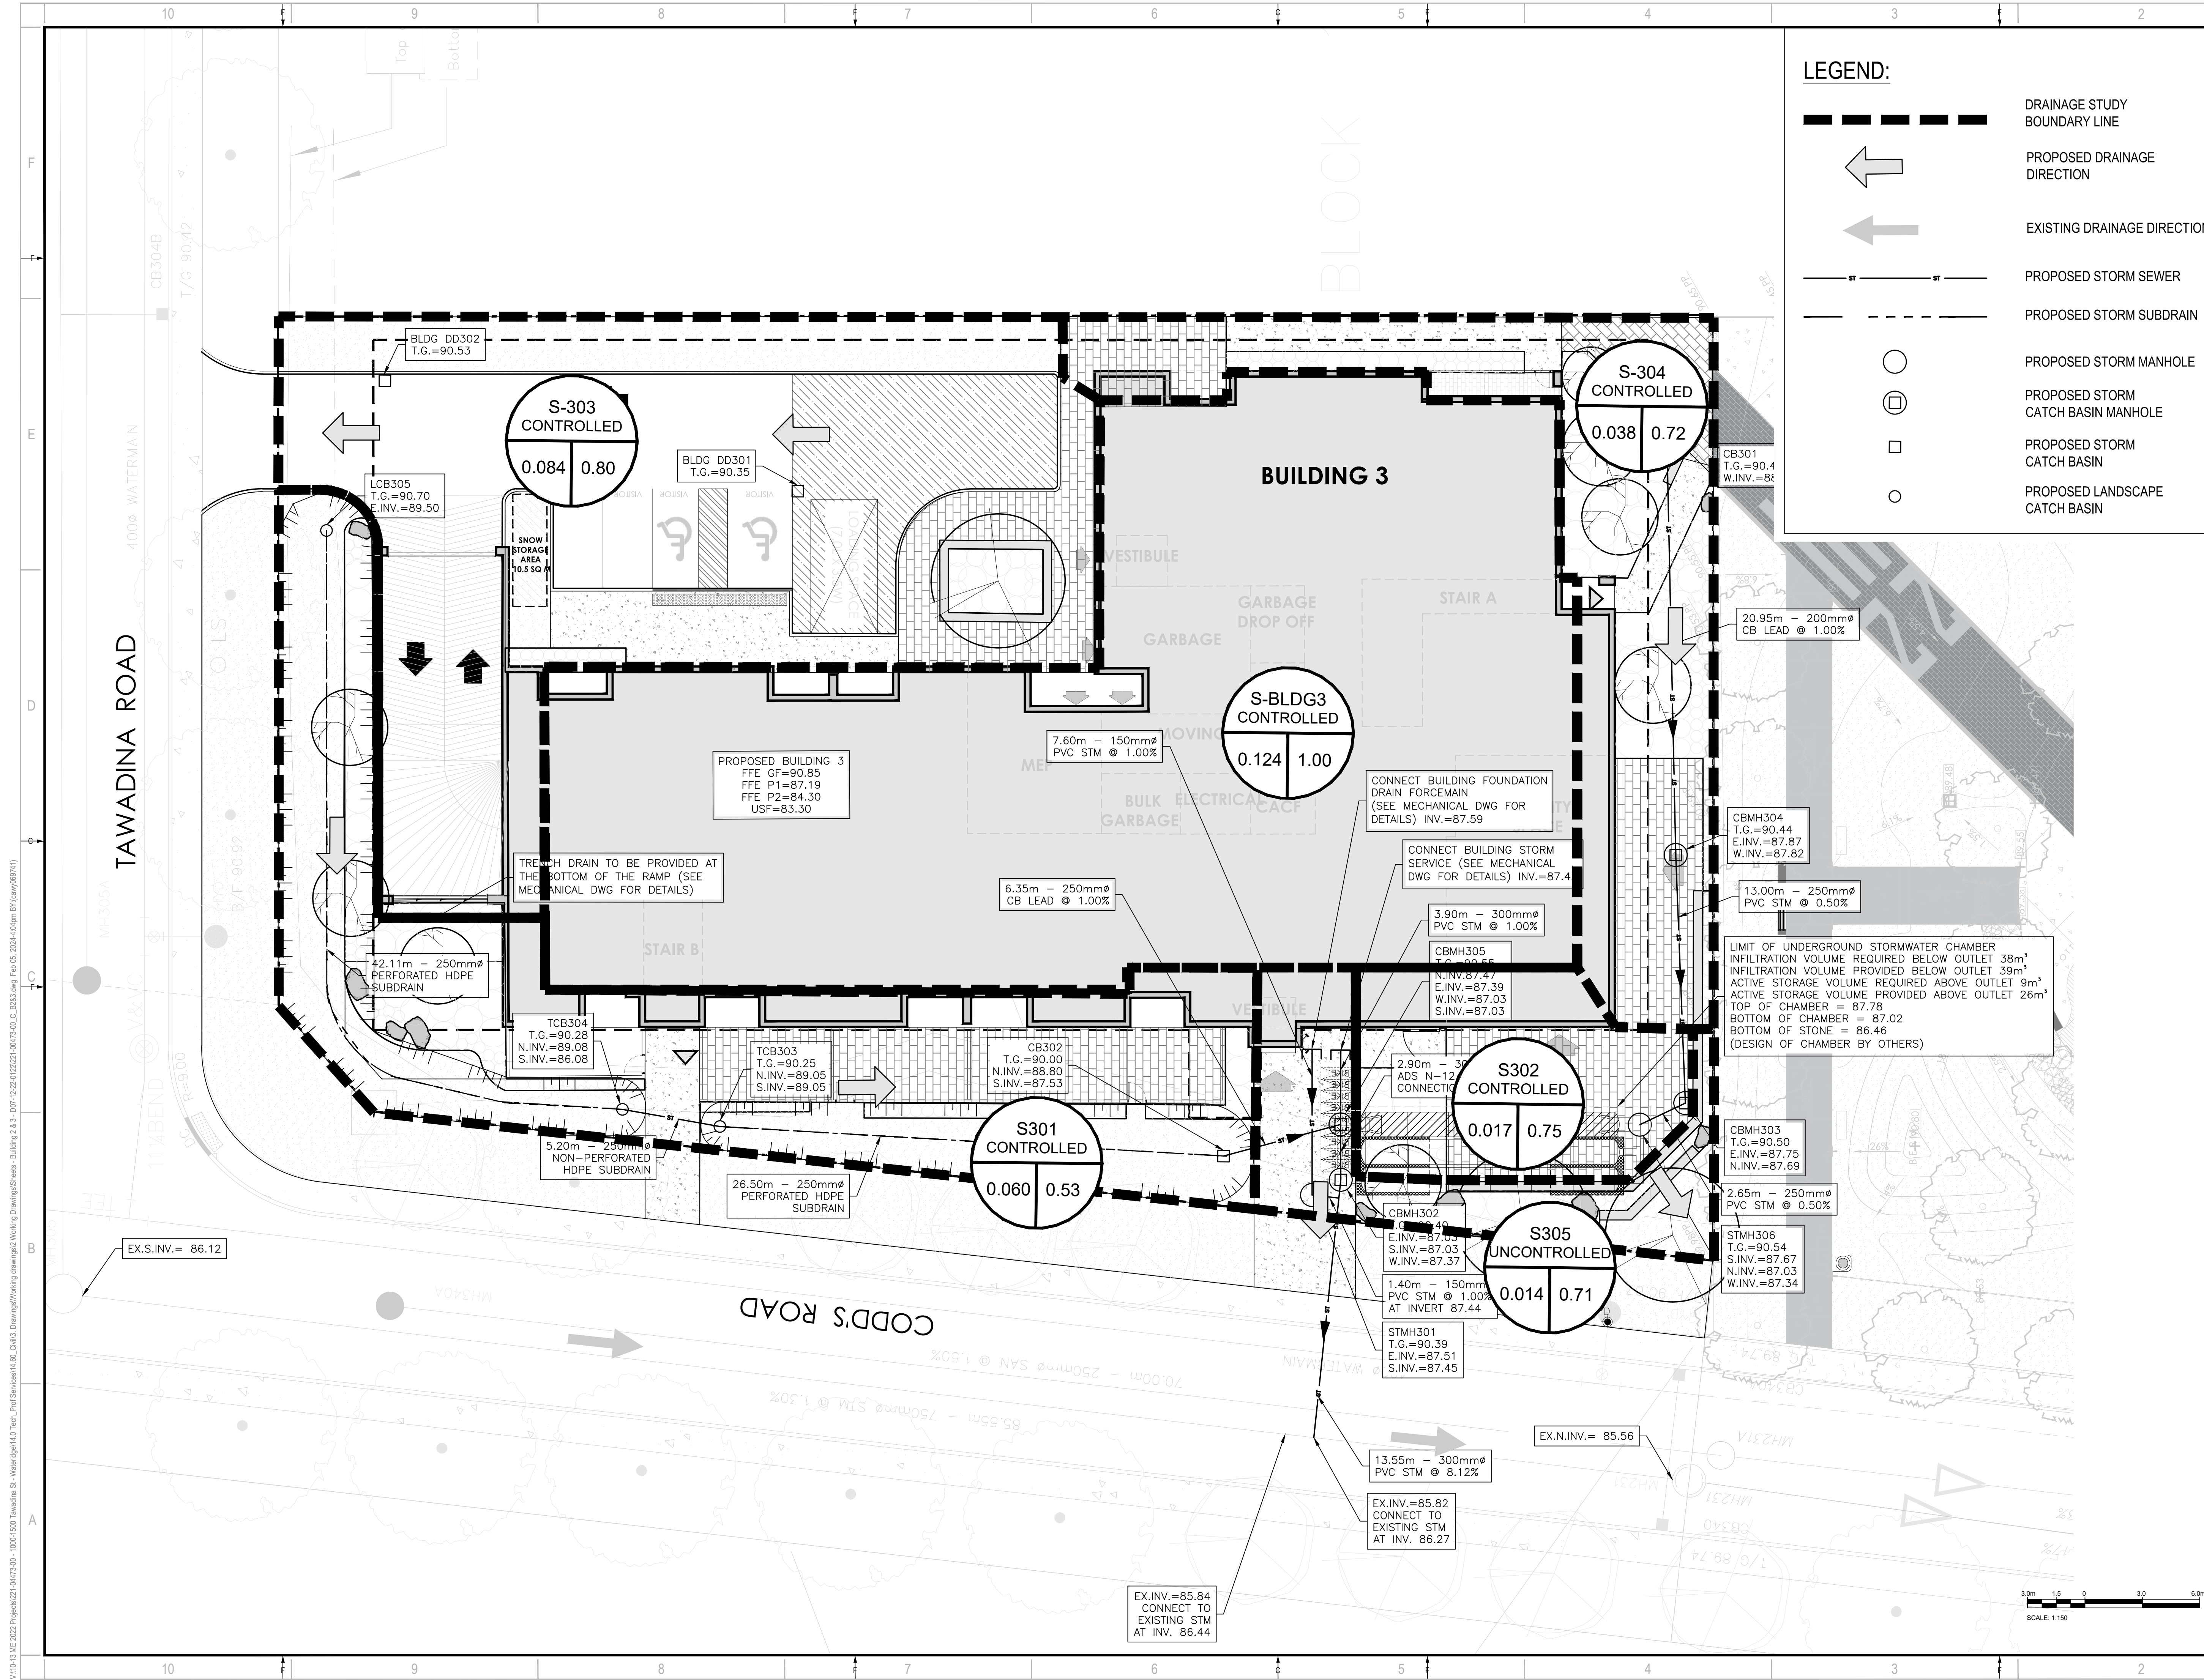
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MATAJ ARCHITECTS INC.
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 E: EVA@MATAJARCHITECTS.COM

LICENCED PROFESSIONAL ENGINEER
 D. B. YANG
 100230568
 2024-02-05
 PROVINCE OF ONTARIO

NORTH

BG BAYVIEW GROUP

CLIENT REF #
PROJECT
 WATERIDGE APARTMENTS BUILDINGS
 375 CODD'S ROAD AND
 1345 HEMLOCK ROAD,
 OTTAWA, ON

KEY PLAN

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 BENCHMARK No. 0191968130 ELEVATION = 55.06 m
 ELEVATIONS ARE GEODETIC, REFERRED TO CITY OF OTTAWA VERTICAL BENCHMARK No. 396
 COORDINATES ARE DERIVED FROM CANADIAN 2011 REAL TIME NETWORK GPS OBSERVATIONS REFERENCED TO SPECIFIED CONTROL POINTS 0191968100 AND 019484761, MTM ZONE 9 (18°30' WEST LONGITUDE) (NAD83 ORIGINAL).

ISSUED FOR - REVISION

NO.	DATE	DESCRIPTION
6	2024-02-05	REVISED AS PER CITY COMMENTS
5	2023-12-18	REVISED AS PER CITY COMMENTS
4	2023-11-24	REVISED AS PER CITY COMMENTS
3	2023-05-25	REVISED AS PER CITY COMMENTS
2	2022-08-15	ISSUED FOR SPA
1	2022-05-24	ISSUED FOR CLC REVIEW

PROJECT NO: 221-04473-00
DATE: FEBRUARY 2024

ORIGINAL SCALE: 1:150
 IF THIS BAR IS NOT 25mm LONG, ADJUST YOUR PLOTTING SCALE.

DESIGNED BY: DY
DRAWN BY: JT
CHECKED BY: DY

DISCIPLINE: CIVIL

TITLE:
 RESIDENTIAL DEVELOPMENT
 STORM DRAINAGE PLAN
 BUILDING 3

SHEET NUMBER: C209

ISSUE: REVISED AS PER CITY COMMENTS

DATE OF: 2024-02-05

REV #: 0

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D07-12-22-0122

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