

0 2 4 6 8 10m

EXISTING TREE LIST KEY KEY BOTANICAL NAME COMMON NAME **CRITICAL ROOT OWNERSHIP** CONDITION ACTION ZONE 8-AN Acer negundo Manitoba Maple 150-250mm DBH 1500-2500mm 637 Cummings Ave POOR-FAIR TO BE REMOVED 637 Cummings Ave 80-130mm DBH 80-1300mm GOOD TO REMAIN 2-JU Juniperus spp. Juniper 12-QR Quercus rubra Red Oak 150-400mm DBH 1500-4000mm NCC GOOD TO REMAIN

KEY	QTY.	BOTANICAL NAME	COMMON NAME	SIZE	CONDITION	REMARKS
TRE	EES					
=M	4	Acer x freemanii	Freeman's Maple	60mm cal.	B&B	
GB	2	Ginkgo biloba 'Princeton Sentry	Princeton Sentry Ginkgo	60mm cal.	B&B	Male tree
JL	1	Syringa reticulata	Japanese Tree Lilac	60mm cal.	B&B	
PE	1	Ulmus wilsoniana 'Prospector	Prospector Elm	60mm cal.	B&B	
SK	2	Gleditsia tricanthos 'Draves'	Street Keeper Honey Locust	60mm cal.	B&B	
SS	7	Picea omorika	Serbian Spruce	1800mm ht.	B&B	
SHF	RUBS	3				
АН	12	Hydrangea arborescens 'Annabelle'	Annabelle Hydrangea	1 gallon pot	Potted	Space 1000mm o.c.
3B	5	Euonymus alatus 'Compactus'	Dwarf Burning Bush	600mm ht.	Potted	Space 800mm o.c.
JT	14	Juniperus sabina 'Tamariscifolia'	Tamarix Juniper	600mm spr.	Potted	Space 800mm o.c.

GENERAL NOTES:

1. It is the responsibility of the appropriate contractor or official to report any errors, omissions or discrepancies on this plan with actual site conditions to the Landscape Architect before proceeding with construction.

2. The contractor is to notify all utility companies and authorities prior to any excavation and ascertain locations of

underground services. 3. The contractor is to reinstate all areas and items damaged as a result of construction activity.

4. The contractor is to comply with all pertinent codes and by-laws.

5. The contractor is to maintain a positive surface run-off throughout the entire construction period.

6. The Landscape Architect is not responsible for subsurface conditions.

7. The contractor is to identify all existing trees to remain on site with the Landscape Architect prior to construction.

8. The contractor is to stake the proposed location of all plant material in conjunction with the Landscape Architect prior to excavation.

9. Minimum distances for selected deciduous trees are as follows:

- Building Foundations 7.5m Sidewalks 1.5m

- Public Streets 2.5m Underground Infrastructure 2.0m

10. All trees within 1m of underground utility trenches are to be excavated by hand.

11. Remove all protective wrapping from tree trunks after installation.

12. Staking of trees shall only be performed if necessary. 13. Ensure that mulch is pulled back a min. distance of 75mm from base of tree trunk.

CONSULTANTS

ARCHITECTS:

McINTOSH PERRY

Woodman Architect

ASSOCIATES LTD.

JAWAN PROPERTIES INC.

MANOTICK ON K4M 0M5

200 SKIPPER DRIVE

LEGEND

EXISTING TREE TO REMAIN



GROUP OF EXISTING TREES TO BE REMOVED



PROPOSED DECIDUOUS TREE



PROPOSED CONIFEROUS TREE



PROPOSED SHRUBS / ORNAMENTAL GRASSES



PROPOSED SOD



PAVERS

PROPOSED PRECAST CONCRETE



PROPOSED GRASS BLOCK



TREE PROTECTION REQUIREMENTS:

1. PRIOR TO ANY WORK ACTIVITY WITHIN THE CRITICAL

- DO NOT PLACE ANY MATERIAL OR EQUIPMENT

POSTERS TO ANY TREE;
- DO NOT RAISE OR LOWER THE EXISTING GRADE;

- DO NOT DAMAGE THE ROOT SYSTEM, TRUNK, OR BUNCHES OR ANY TREE; - ENSURE THAT EXHAUST FUMES FROM ALL

EQUIPMENT ARE NOT DIRECTED TOWARD ANY

INCLUDING OUTHOUSES;
- DO NOT ATTACH ANY SIGNS, NOTICES OR

- TUNNEL OR BORE WHEN DIGGING;

- DO NOT EXTEND HARD SURFACE OR SIGNIFICANTLY CHANGE LANDSCAPING

ROOT ZONE (CRZ = 10X DIAMETER) OF A TREE, TREE PROTECTION FENCING MUST BE INSTALLED SURROUNDING THE CRITICAL ROOT ZONE AND REMAIN IN PLACE UNTIL THE WORK IS COMPLETE.

PROPOSED CONCRETE

TREE PROTECTION FENCE

PAVERS

1	ISSUED FOR SITE PLAN CONTROL	08/29/2022	ML	JL
No.	Issue	Date MM/DD/YY	DR	СК

JAMES B. LENNOX & ASSOCIATES INC. LANDSCAPE **ARCHITECTS** OTTAWA, ONTARIO 3332 CARLING AVE.

Tel. (613) 722-5168 PROJECT

29 UNIT 3 STOREY APARTMENT

637 CUMMINGS AVENUE, OTTAWA ON

TREE CONSERVATION REPORT & LANDSCAPE PLAN



AS SHOWN TART DATE JULY 2022 PROJECT NO.

SCALE


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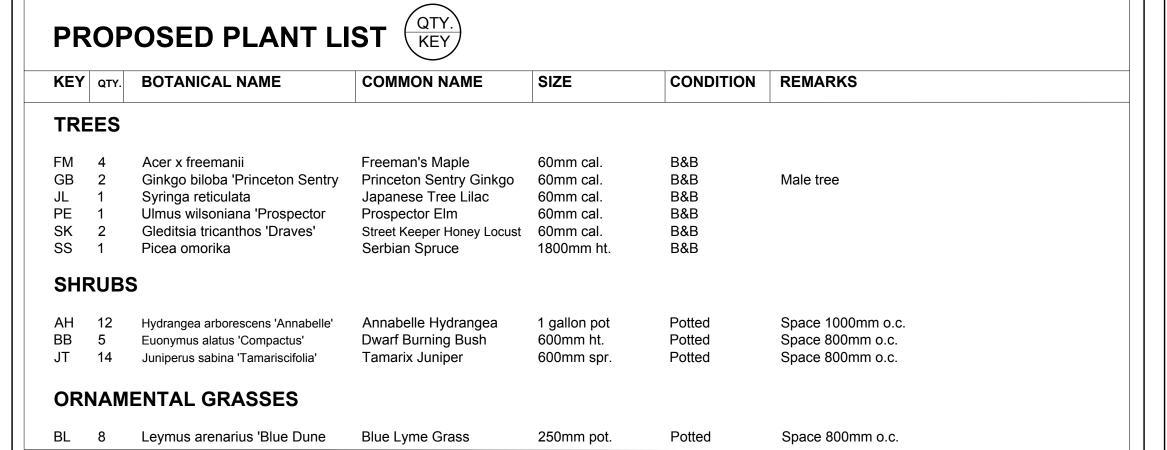
PROJECT NORTH

DRAWING NO.


LOT SIZE ARCH-D


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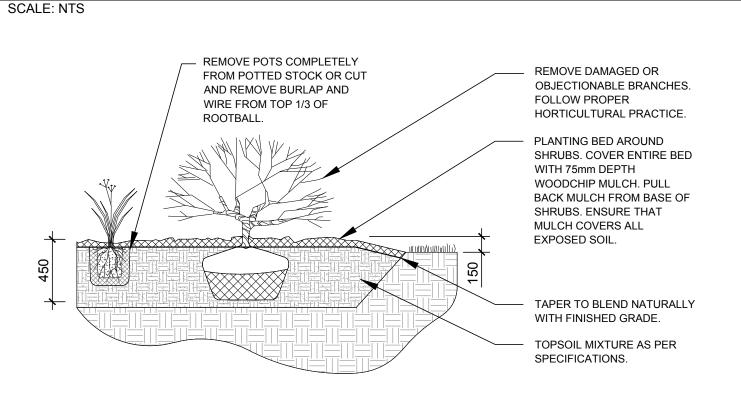


- PREVAILING WIND

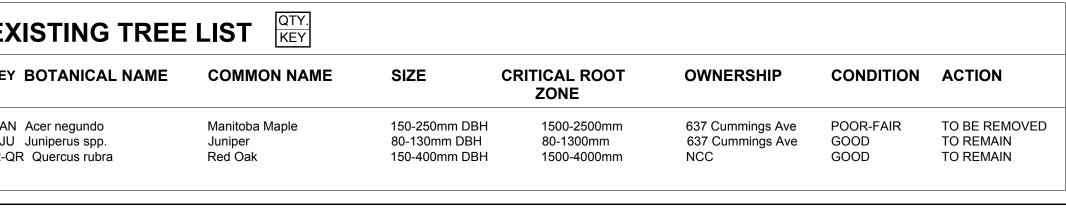


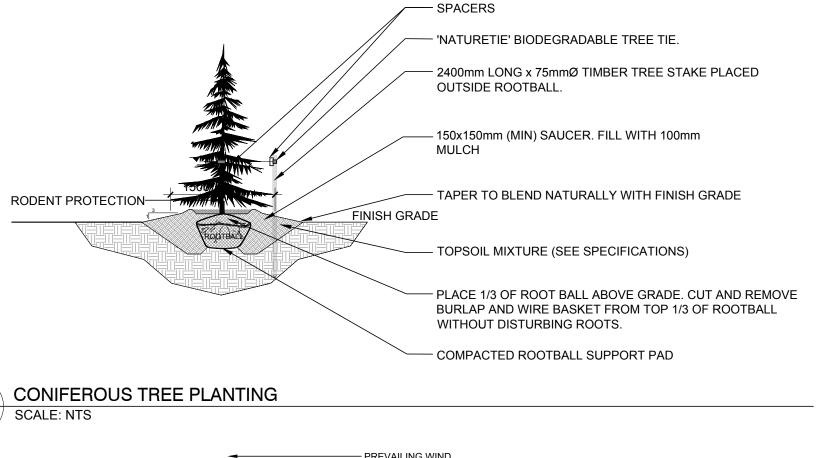

DECIDUOUS TREE PLANTING

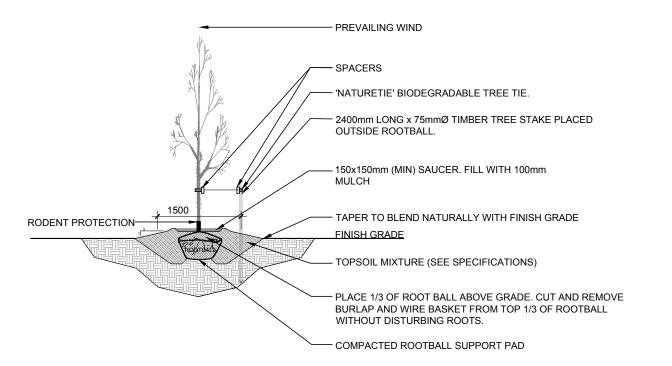

4 SHRUB / ORNAMENTAL GRASS PLANTING

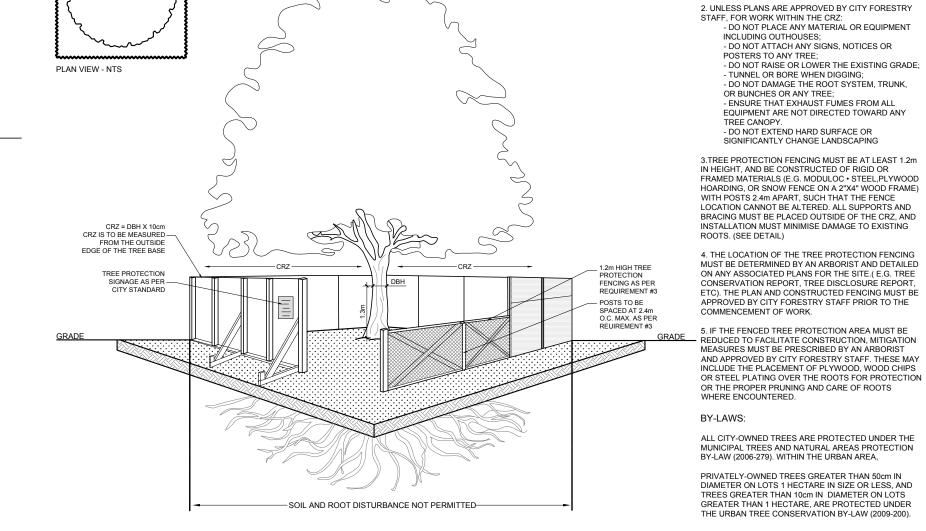

TREE PROTECTION FENCE

L.1 | SCALE: NTS