

1 ELECTRICAL SITE PLAN
E2 1:150

SITE LIGHTING FIXTURE SCHEDULE								
TYPE	DESCRIPTION	CATALOG NUMBER	LAMPS PER FIXTURE			VOLT	MOUNTING	REMARKS
			TYPE	WATTS	COLOUR			
P1	POLE	STANPRO/ ALK-L-S2C-4-347-40-OSI-PB-1001	LED	50	4000K	347	SURFACE	C/W ACCESSORIES 20' POLE
W4	WALL MOUNT	STANPRO/ ALK-L-S2C-4-347-40-OSI-PB-1001	LED	50	4000K	347	WALL MOUNT	C/W ACCESSORIES
W2	WALL MOUNT	STANPRO/ ALK-L-S2C-3-I-40-OSI-PB-1001	LED	37	4000K	347	SURFACE	C/W ACCESSORIES
W3	WALL MOUNT	STANPRO/ WFC-PS60A-3-0-3C-25W-40K-68607	LED	25	4000K	347	SURFACE	C/W ACCESSORIES

LIGHTING LEGEND	
SYMBOL	DESCRIPTION
[Symbol]	LIGHT FIXTURE - TYPE AS SHOWN
[Symbol]	LIGHT FIXTURES ON EMERGENCY POWER OR NIGHT LIGHT - DO NOT SWITCH
[Symbol]	CEILING MOUNTED LIGHT FIXTURE - TYPE AS SHOWN
[Symbol]	WALL MOUNTED LIGHT FIXTURE - TYPE AS SHOWN
[Symbol]	EXTERIOR POLE MOUNTED LIGHT FIXTURE - TYPE AS SHOWN
[Symbol]	EXTERIOR BOLLARD LIGHT FIXTURE - TYPE AS SHOWN

GENERAL NOTES

TYPICAL

- REFER TO ARCHITECTURAL ELEVATIONS FOR ALL BUILDING MOUNTED LIGHTS. COORDINATE EXACT LOCATION PRIOR TO ROUGH-IN.
- ALL LED FIXTURES SHALL BE C/W DRIVERS.
- ALL EXTERIOR SITE LIGHT FIXTURE TO BE OPERATED BY PHOTOCCELL.

Client

DATE	REVISION	REF
2023-08-16	ISSUED FOR SITE PLAN	-
2023-07-14	ISSUED FOR 33% REVIEW	1

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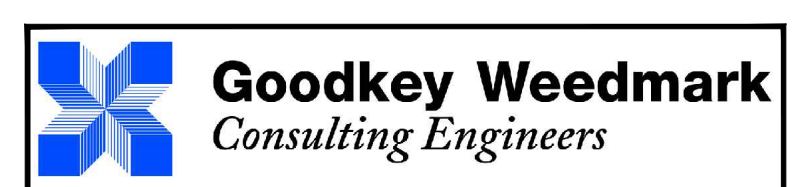
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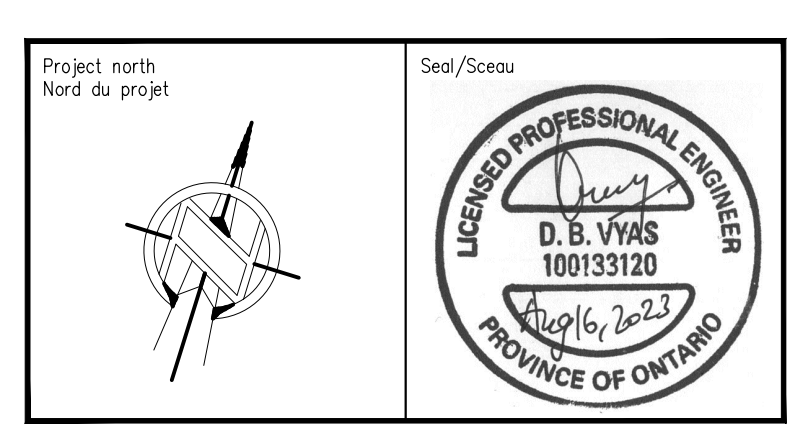
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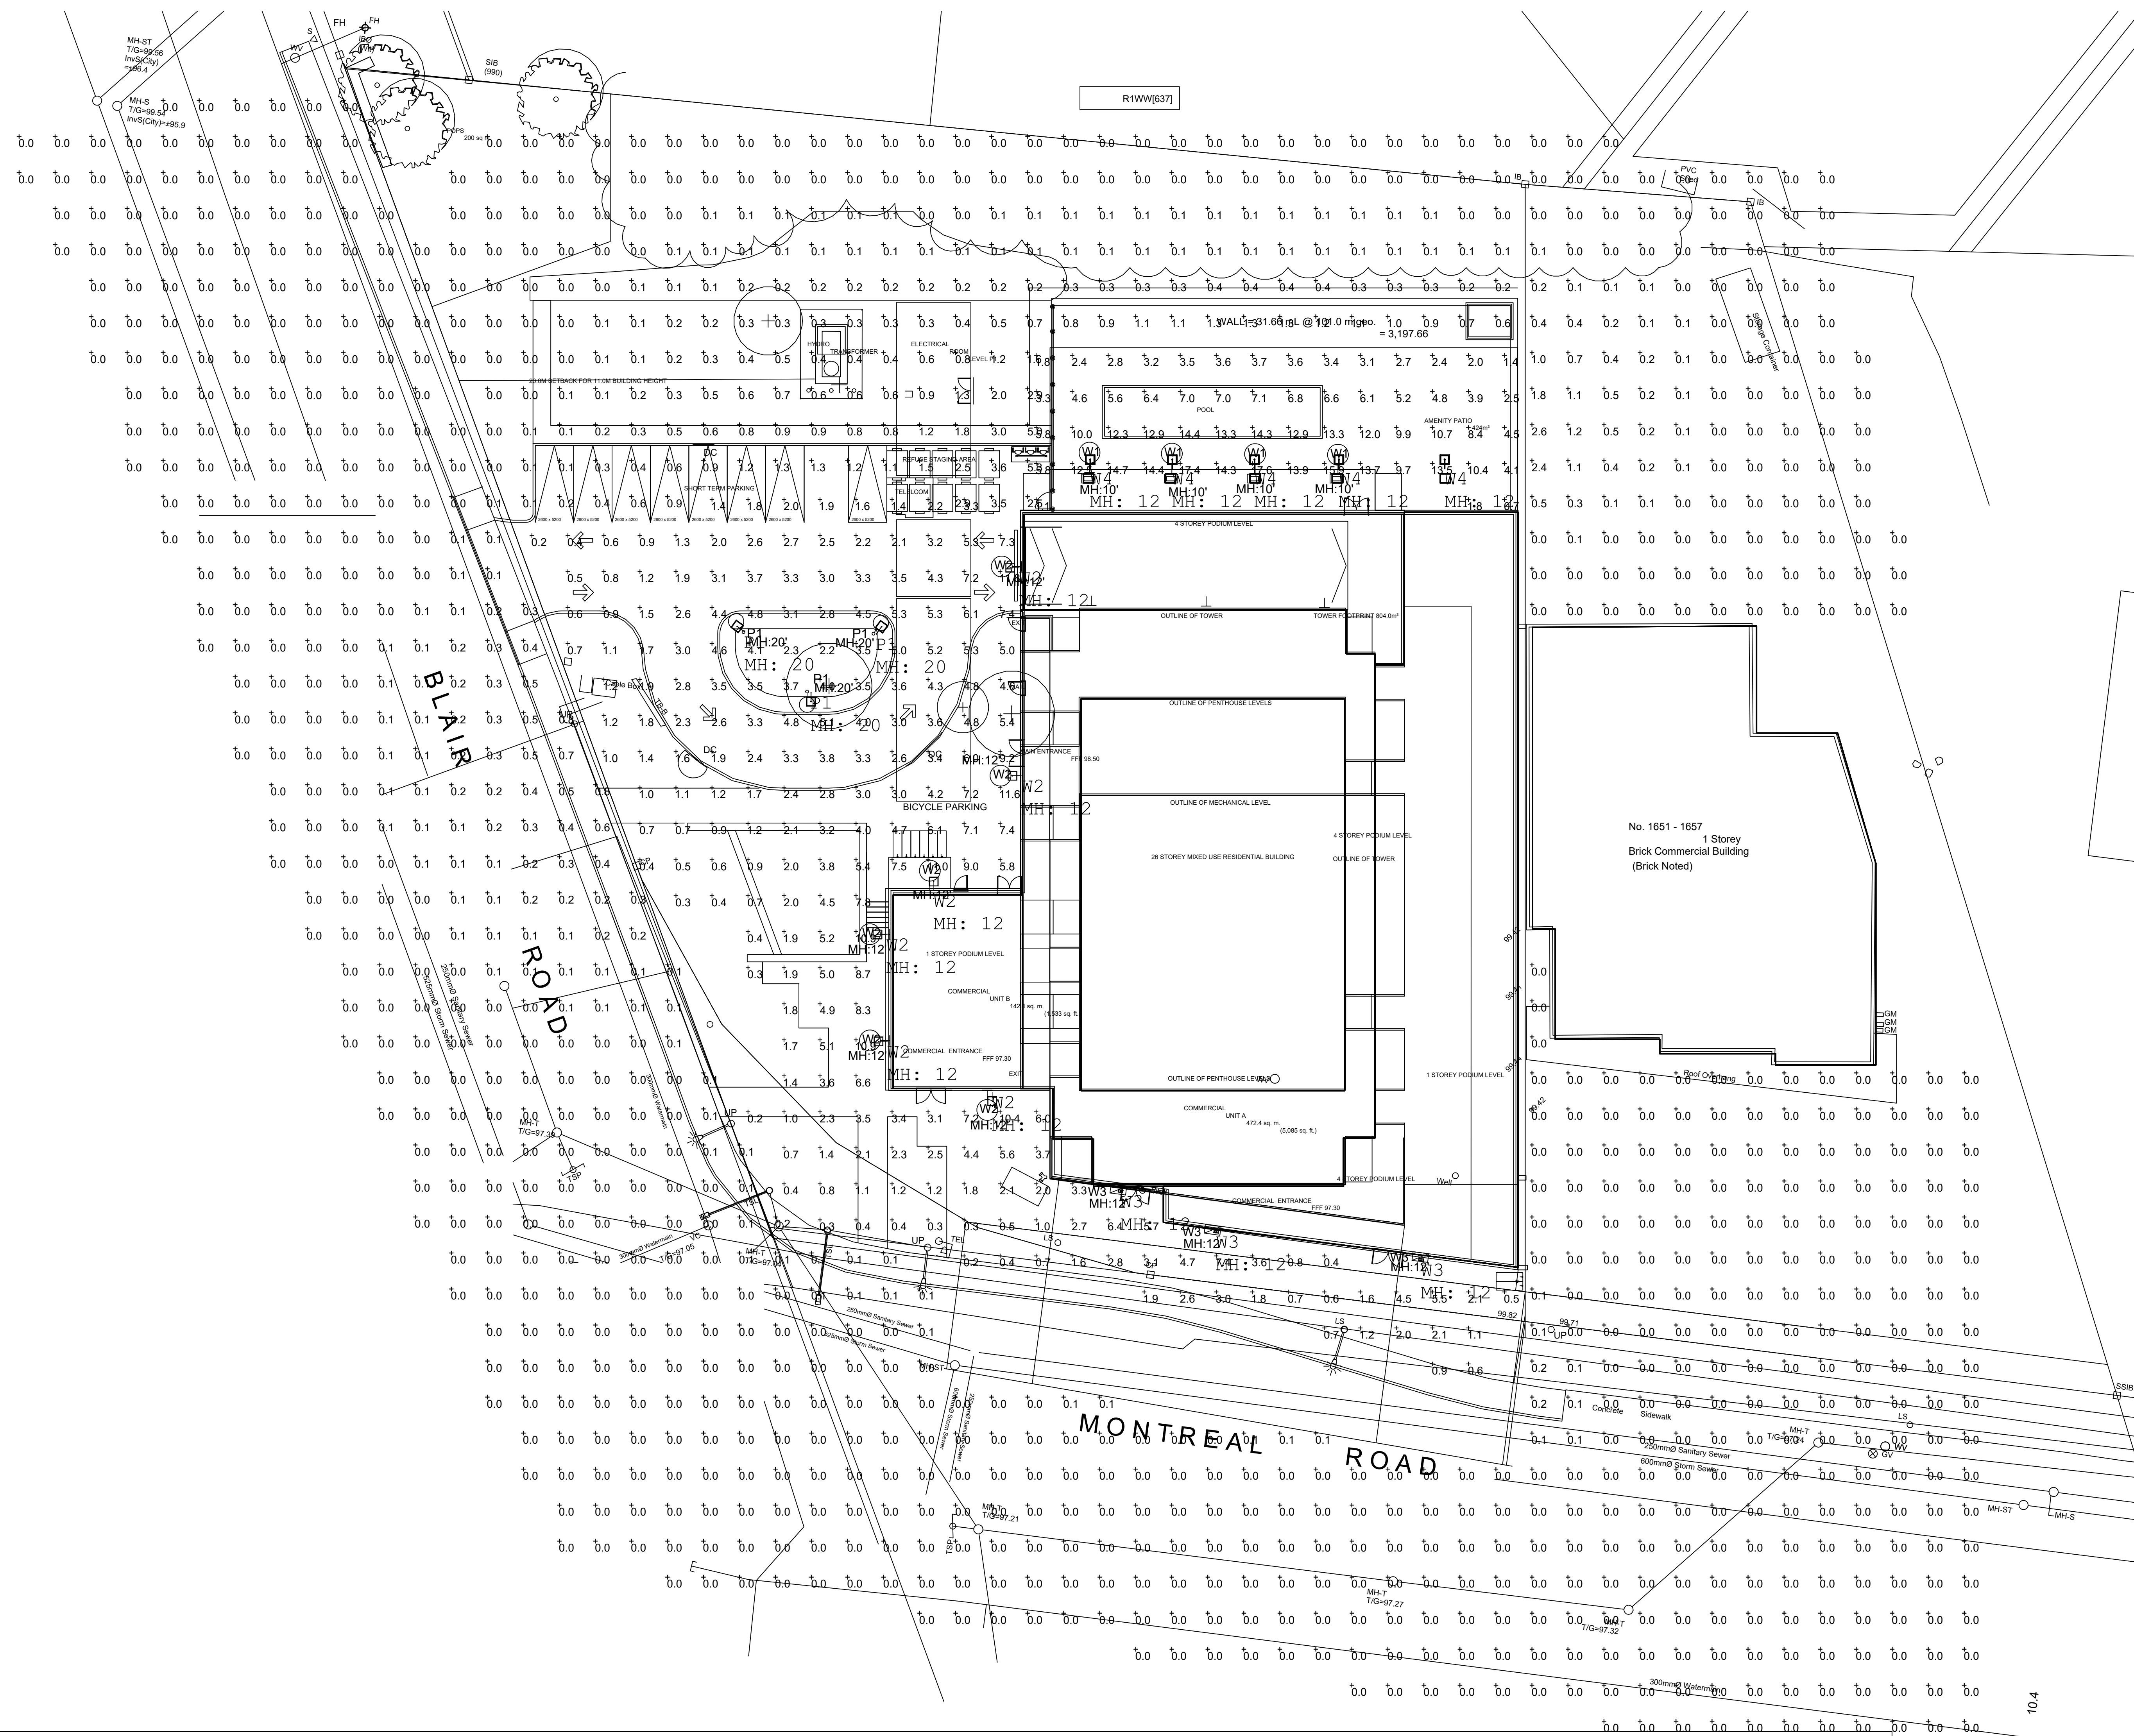
GOODKEY WEEDMARK & ASSOCIATES LIMITED
1688 Woodward Dr. 613 727-5111 Voice
Ottawa Ontario 613 727-5115 Fax
Canada K2C 3R8 www.gweal.com Web



Project/Projet
1649 MONTREAL ROAD

Drawing title/Titre du dessin
ELECTRICAL SITE PLAN

Scale Échelle	AS NOTED	Project no./No. du projet 2023-169
Design by Conçu par	L.ALI	E2
Drawn by Dessiné par	L.ALI	
Reviewed by Examiné par	D. VYAS	OF
Date	APRIL 2023	Revision no. / Acad file/Fichier: 2/ELEC/2023-169



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2023-08-16	ISSUED FOR SITE PLAN	-
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Goodkey Weedmark Consulting Engineers

GOODKEY WEEDMARK & ASSOCIATES LIMITED
 1688 Woodward Dr. Ottawa Ontario Canada K2C 3R8
 613 727-5111 Voice
 613 727-5115 Fax
 www.gweal.com Web

Project/Projet: 1649 MONTREAL ROAD

Drawing/Desin: PHOTOMETRIC STUDY

Scale: AS NOTED
 Etchelle: 2023-169

Design by: LALU
 Conçu par: LALU

Drawn by: LALU
 Dessiné par: LALU

Reviewed by: D. VYAS
 Examiné par: D. VYAS

Date: APRIL 2023
 Date: 2023-04-16

Revision no.: 2/ELEC/2023-169

Acad file/Fichier: 2/ELEC/2023-169

Symbol	Qty	Label	Description	Lum. Lumens	Lum. Watts	LLF	Filename	Arrangement	Mounting Height
☐	5	W4	ALK-LS2C4-XX-40K	7833	50	0.900	ALK-LS2C4-XX-40K.IES	Single	12
☐	6	W2	ALK-LS1C3-XX-40K	5675	37	0.900	ALK-LS1C3-XX-40K.IES	Single	12
☐	3	W3	WFC-PS60A3-Q-3C-25W-40K-68607	3625	25	0.900	WFC-PS60A3-Q-3C-25W-40K-68607.IES	Single	12
☐	3	P1	ALK-LS2C4-XX-40K	7833	50	0.900	ALK-LS2C4-XX-40K.IES	Single	20

Label	CalcType	Units	Avg	Max	Min	Avg/Min	Max/Min
CalcPts_1	ILLUMINANCE	Fc	4.10	17.6	0.2	20.50	88.00
Spill	ILLUMINANCE	Fc	0.11	5.3	0.0	N.A.	N.A.