




- GENERAL NOTES:**
- It is the responsibility of the appropriate contractor or official to report any errors, omissions or discrepancies on this plan with actual site conditions to the Landscape Architect before proceeding with construction.
 - The contractor is to notify all utility companies and authorities prior to any excavation and ascertain locations of underground services.
 - The contractor is to restore all areas and items damaged as a result of construction activity.
 - The contractor is to comply with all pertinent codes and by-laws.
 - The contractor is to maintain a positive surface run-off throughout the entire construction period.
 - The Landscape Architect is not responsible for subsurface conditions.
 - The contractor is to identify all existing trees to remain on site with the Landscape Architect prior to construction.
 - The contractor is to stake the proposed location of all plant material in conjunction with the Landscape Architect prior to excavation.
 - Minimum distances for selected deciduous trees are as follows:
 - Building Foundations 4.5m medium trees,
 - 7.5m large trees
 - Sidewalks 1.5m
 - Public Streets 2.5m
 - Underground Infrastructure 2.0m
 - All trees within 1m of underground utility trenches are to be excavated by hand.
 - Remove all protective wrapping from tree trunks after installation.
 - Staking of trees shall only be performed if necessary.
 - Ensure that mulch is pulled back a min. distance of 75mm from base of tree trunk.

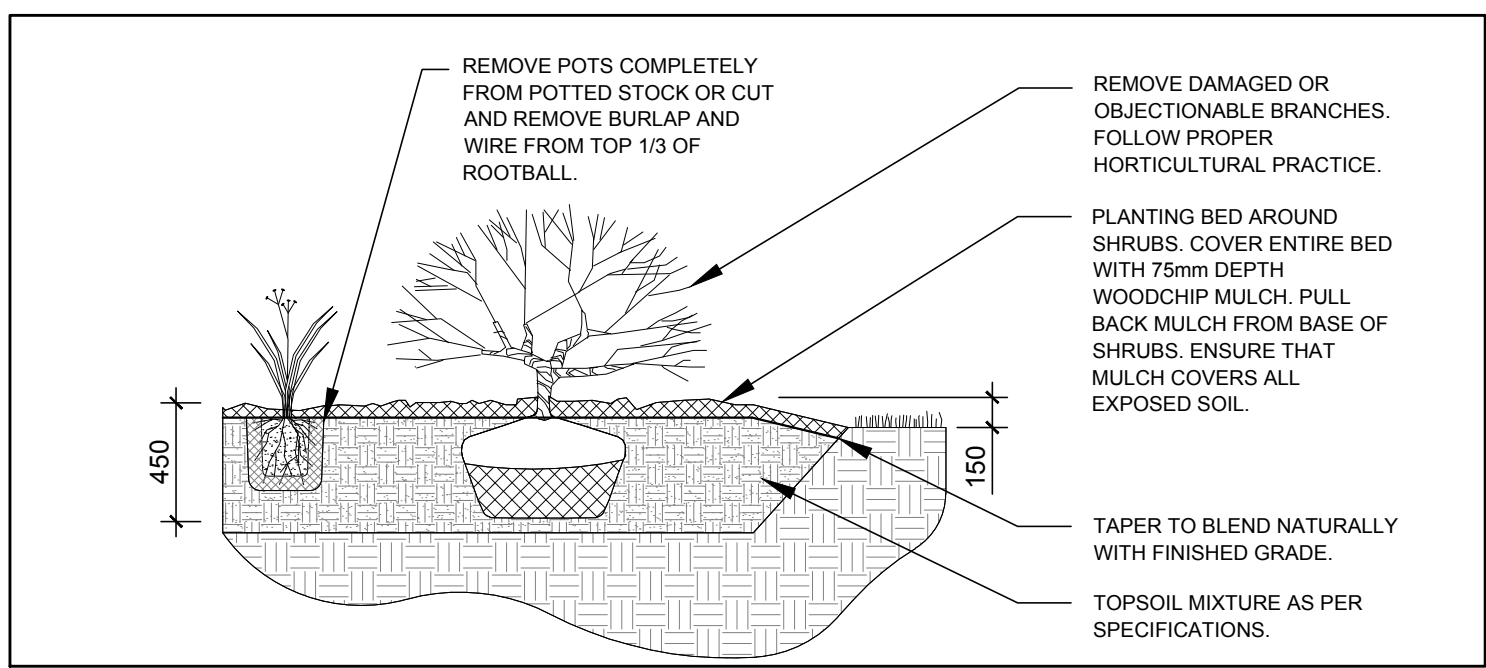


5 SHRUB / PERENNIAL PLANTING
SCALE: N.T.S.

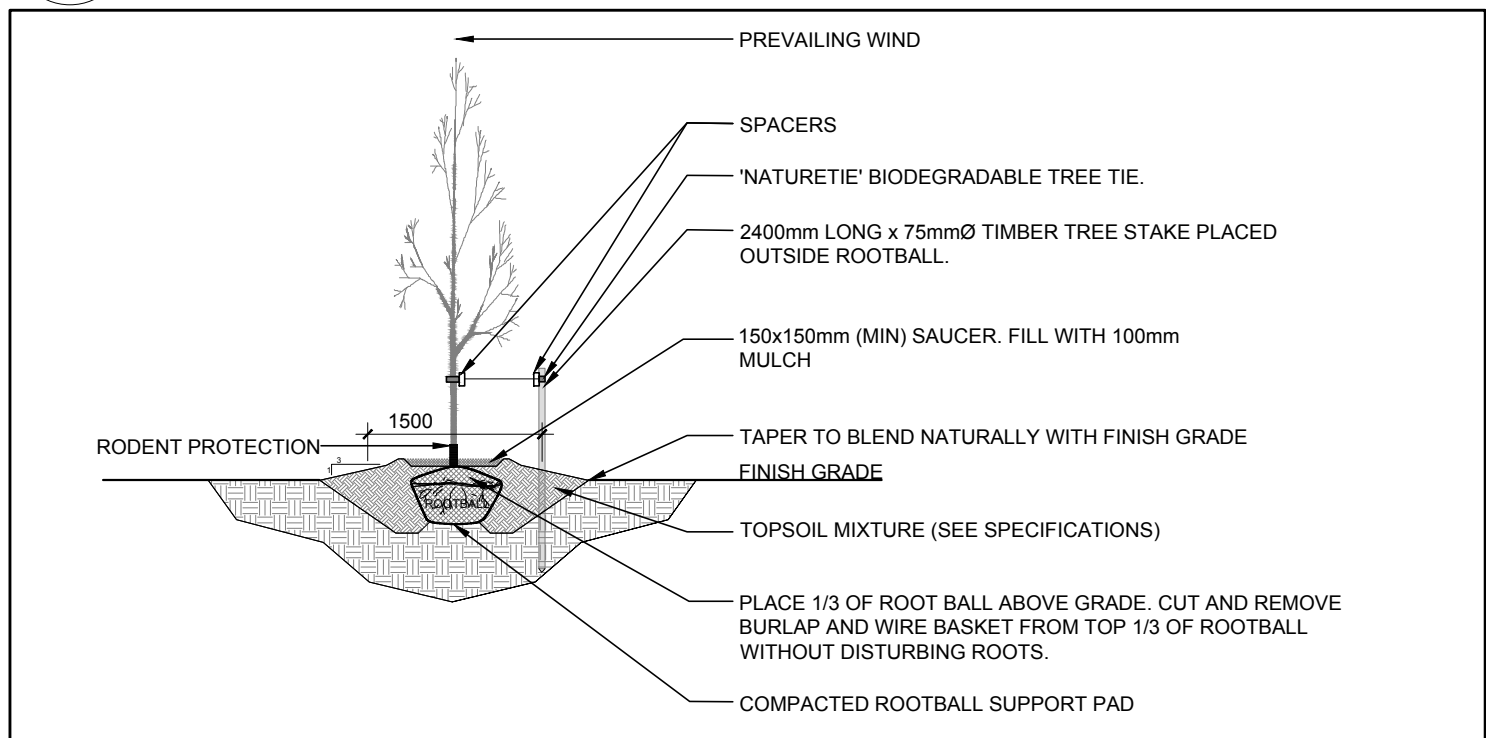


6 DECIDUOUS TREE PLANTING
SCALE: N.T.S.

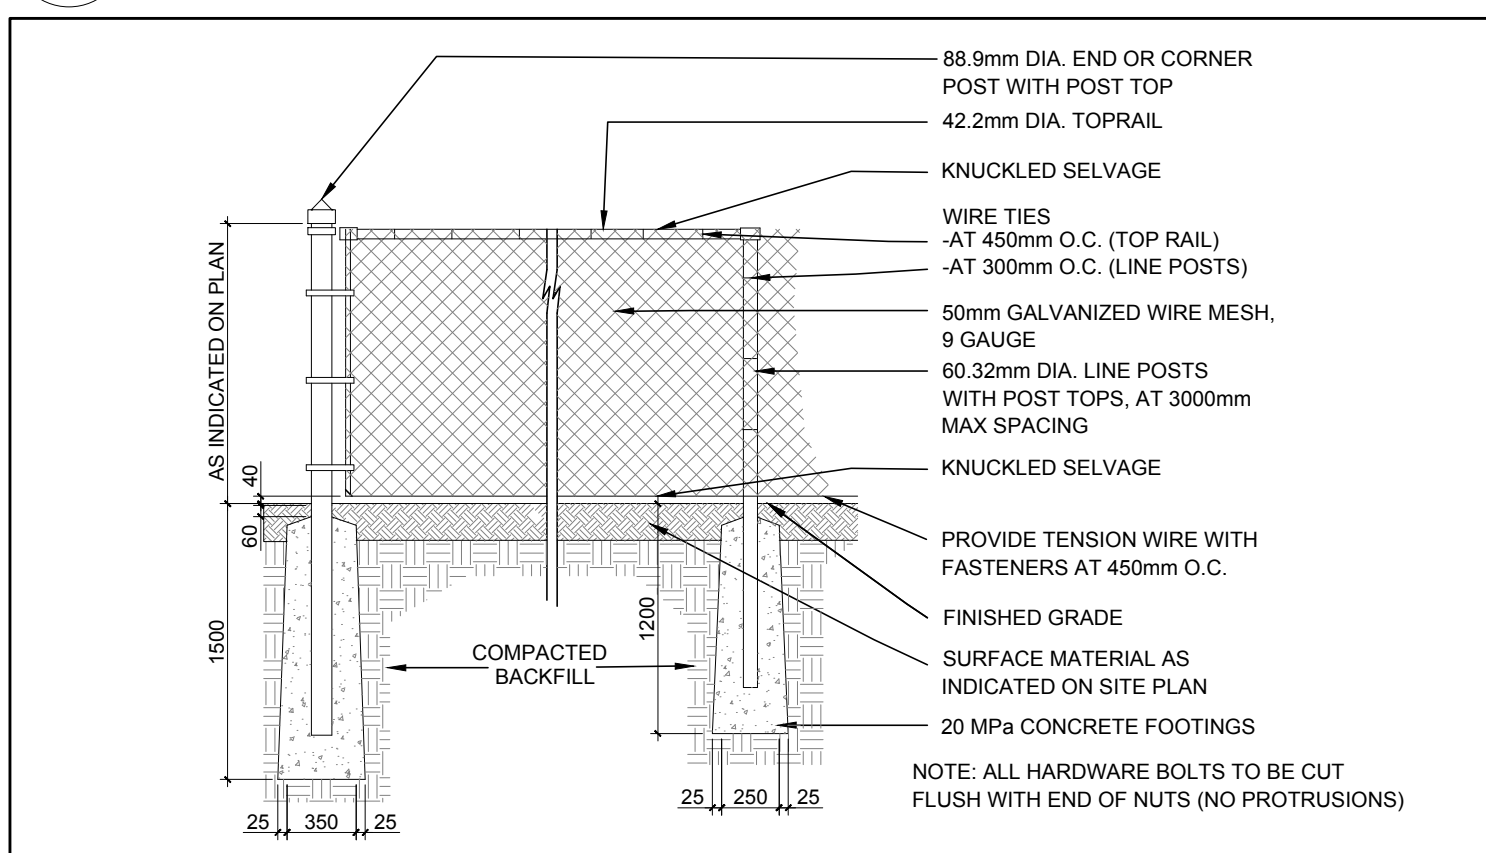

7 GALVANIZED CHAIN LINK FENCE
SCALE: N.T.S.

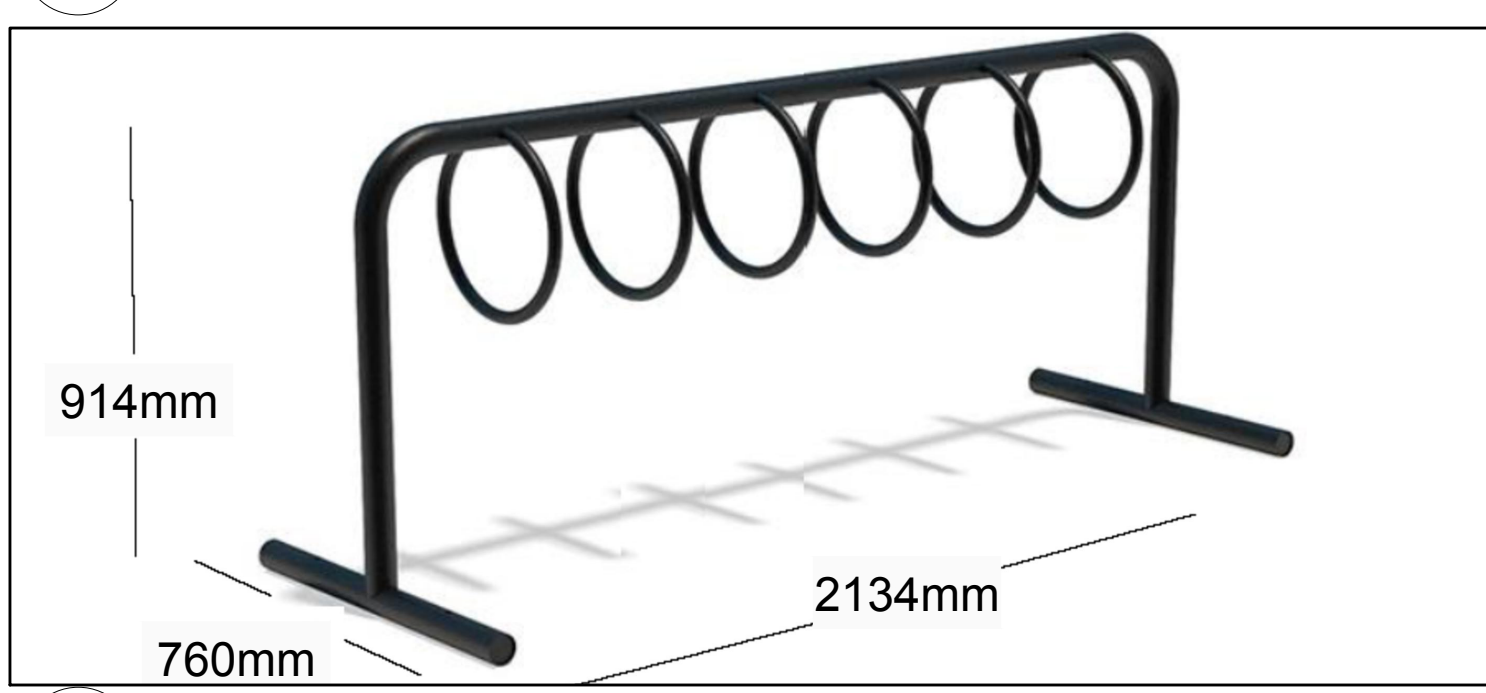



8 SIX (6) RING BIKE RACK FOR NINE (9) BIKES
SCALE: N.T.S.

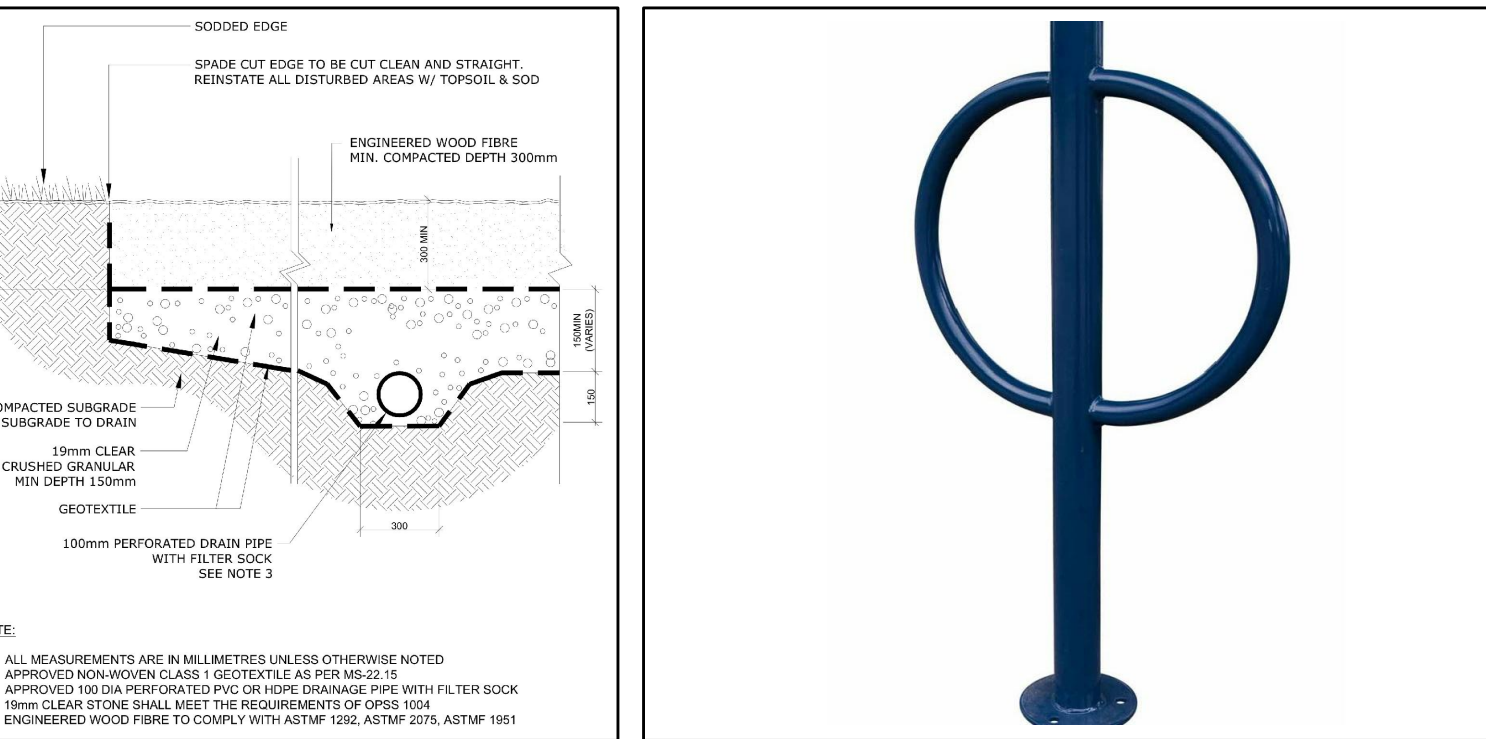


9 ENGINEERED WOOD FIBRE AREA WITH SPADE EDGE - N.T.S.

1 TREE CONSERVATION REPORT & LANDSCAPE PLAN
SCALE: 1:500


| KEY | QTY | BOTANICAL NAME | COMMON NAME | SIZE | CONDITION | REMARKS | HT. @ MATURITY |
|-------------------|-----|---|---------------------------|------------|-----------|---------------|----------------|
| TREES | | | | | | | |
| CS | 1 | <i>Picea pungens</i> | Colorado Spruce | 1800mm ht. | B&B | | 18m |
| FM | 5 | <i>Acer x freemanii</i> | Freeman's Maple | 60mm cal. | B&B | Male tree | 21m |
| GB | 5 | <i>Ginkgo biloba</i> | Maidenhair Tree | 60mm cal. | B&B | | 24m |
| HB | 4 | <i>Callis occidentalis</i> | Hackberry | 60mm cal. | B&B | | 12m |
| HL | 2 | <i>Gleditsia triacanthos 'Shademaster'</i> | Shademaster Honey Locust | 60mm cal. | B&B | | 21m |
| JL | 4 | <i>Syringa reticulata</i> | Japanese Tree Lilac | 60mm cal. | B&B | Single leader | 6m |
| LL | 2 | <i>Tilia cordata</i> | Littleleaf Linden | 60mm cal. | B&B | | 18m |
| PE | 3 | <i>Ulmus wilsoniana 'Prospector'</i> | Prospector Elm | 60mm cal. | B&B | | 13m |
| SK | 5 | <i>Gleditsia triacanthos 'Impicola'</i> | Imperial Honey Locust | 60mm cal. | B&B | | 11m |
| SM | 5 | <i>Acer saccharum</i> | Sugar Maple | 60mm cal. | B&B | | 22.5m |
| SHRUBS | | | | | | | |
| AC | 3 | <i>Ribes alpinum</i> | Alpine Currant | 800 mm ht. | Potted | 1200 mm o.c. | |
| DW | 7 | <i>Cornus sericea</i> | Red Osier Dogwood | 800 mm ht. | Potted | 1200 mm o.c. | |
| DN | 9 | <i>Physocarpus opulifolius 'Little Devil'</i> | Little Devil Ninebark | 800mm ht. | Potted | 1000 mm o.c. | |
| PF | 14 | <i>Potentilla fruticosa 'Goldfinger'</i> | Goldfinger Potentilla | 600mm ht. | Potted | 800 mm o.c. | |
| PO | 10 | <i>Potentilla fruticosa 'Red Ace'</i> | Red Ace Potentilla | 600mm ht. | Potted | 800 mm o.c. | |
| SF | 69 | <i>Sorbaria sorbifolia 'Sem'</i> | Sem False Spirea | 600mm ht. | Potted | 1000 mm o.c. | |
| PERENNIALS | | | | | | | |
| AJ | 13 | <i>Sedum 'Autumn Joy'</i> | Autumn Joy Sedum | 100mm pot | Potted | 400 mm o.c. | |
| BE | 17 | <i>Rutbeckia fulgida 'Goldsturm'</i> | Yellow Coneflower | 100mm pot | Potted | 400 mm o.c. | |
| KF | 20 | <i>Calamagrostis 'Karl Foerster'</i> | Karl Foerster Grass | 250mm pot | Potted | 800 mm o.c. | |
| MG | 15 | <i>Miscanthus sinensis 'Giganteus'</i> | Giant Chinese Silvergrass | 250mm pot | Potted | 1200 mm o.c. | |
| MS | 32 | <i>Miscanthus sinensis 'Strictus'</i> | Porcupine Grass | 250mm pot | Potted | 800 mm o.c. | |

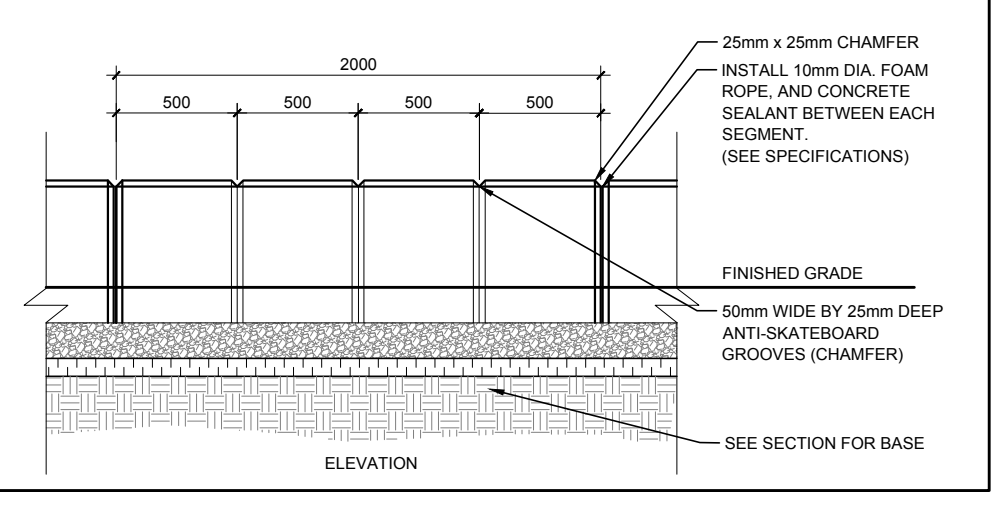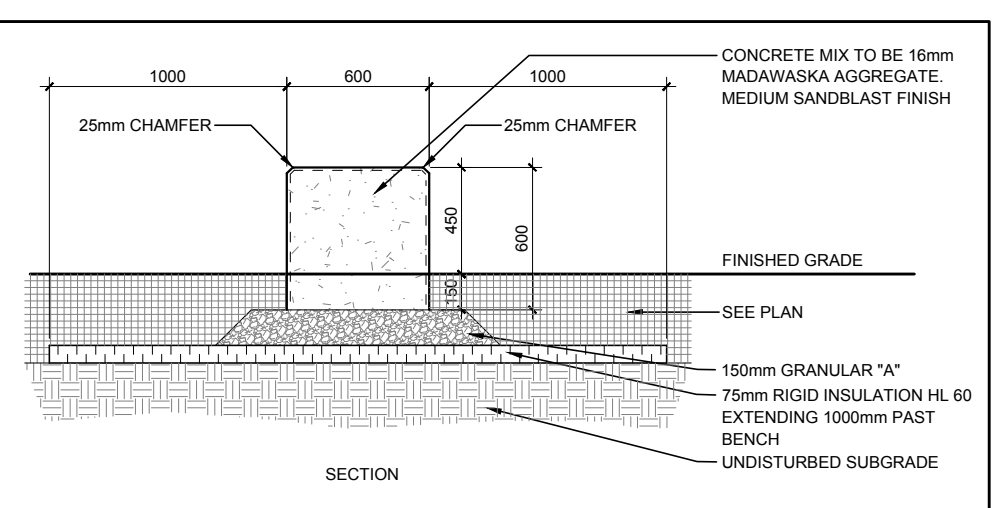

2 SEATING WALL
SCALE: N.T.S.

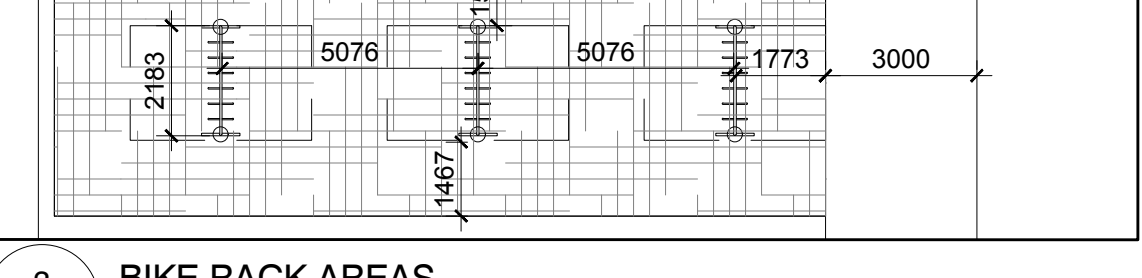

3 BIKE RACK AREAS
SCALE: N.T.S.

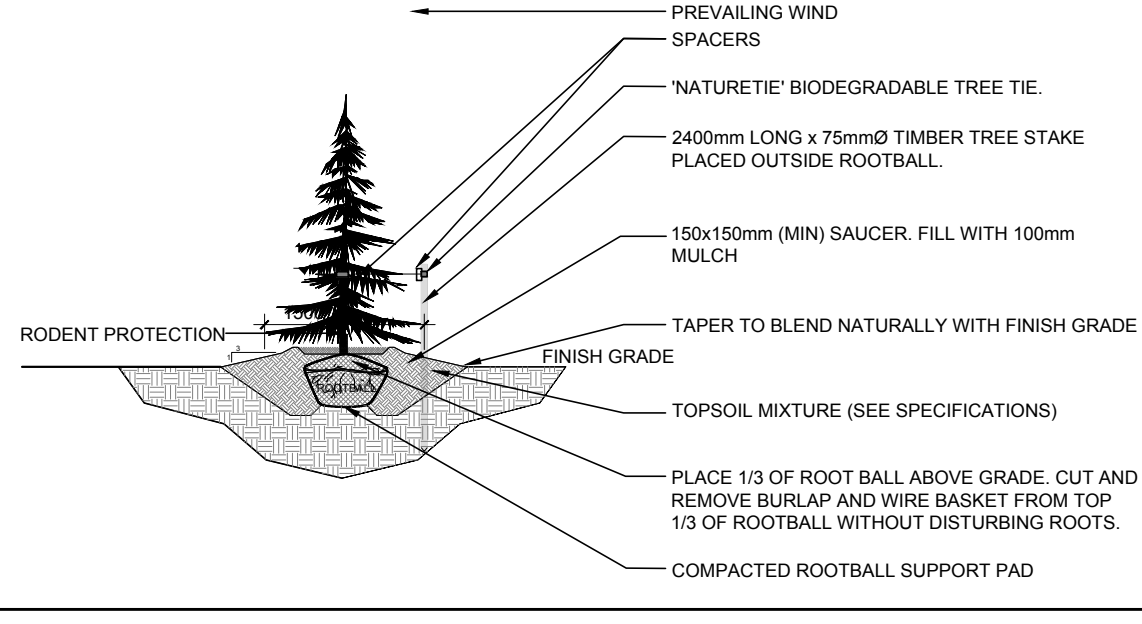

4 CONIFEROUS TREE PLANTING
SCALE: N.T.S.



OTTAWA CATHOLIC SCHOOL BOARD

CONSULTANTS

ARCHITECTS: **P R PYE & RICHARDS - TEMPRANO & YOUNG ARCHITECTS INC.**

824 Meath St. Suite 200 Ottawa, ON K1Z 6E8 613.724.7700 info@prty.ca

CIVIL ENGINEERS:

JP2g Consultants Inc.

1150 Morrison Dr., Suite 410 Ottawa, ON K2H 8S8 Tel: (613) 628-7800 EXISTING TREE TO BE REMOVED

- LEGEND**
- PROPOSED DECIDUOUS TREE
 - PROPOSED CONIFEROUS TREE
 - PROPOSED SHRUBS / PERENNIALS
 - PROPOSED TREES 'BY OTHERS'
 - PROPOSED ENGINEERED WOOD FIBRE
 - PROPOSED SOD
 - PROPOSED SOD 'BY OTHERS'
 - PROPOSED 1.8m H. GALVANIZED CHAIN LINK FENCE
 - PROPOSED 1.2m H. GALVANIZED CHAIN LINK FENCE
 - PROPOSED FENCE 'BY OTHERS'
 - PROPOSED ASPHALT ACCESS RAMP
 - EXISTING TREE TO REMAIN

| No. | Issue | Date | Author | Checked |
|-----|------------------------------|------------|--------|---------|
| 4 | REVISED PER CITY COMMENTS | 01/11/2023 | ML | JL |
| 3 | ISSUED FOR BUILDING PERMIT | 12/14/2022 | ML | JL |
| 2 | ISSUED FOR 85% REVIEW | 10/21/2022 | ML | JL |
| 1 | ISSUED FOR SITE PLAN CONTROL | 10/07/2022 | ML | JL |

JAMES B. LENNOX & ASSOCIATES INC. LANDSCAPE ARCHITECTS

3332 CARLING AVE. OTTAWA, ONTARIO K2H 5A8 Tel: (613) 722-5168 Fax: (1866) 343-3942

PROJECT

OCSB RIVERSIDE SOUTH ELEMENTARY SCHOOL

BRIAN GOOD & SOLARIUM AVE, OTTAWA ON

DRAWING

TREE CONSERVATION REPORT &

LANDSCAPE PLAN

SCALE

AS SHOWN

START DATE

AUGUST 2022

PROJECT NO.

22PRTY2720

PROJECT NORTH

DRAWING NO.

L.1

PLOT SIZE ARCH-D

D07-12-22-0145