

CARRUTHERS AVENUE DEVELOPMENT

266-268 CARRUTHERS AVENUE, OTTAWA, ON

ISSUED FOR RE-ZONING AND SPC

2022-11-07 11:46:29 AM

ARCHITECTURAL DRAWINGS



S.J. LAWRENCE ARCHITECT INC. 18 DEAKIN ST. SUITE 205 OTTAWA, ONTARIO K2E 8B7 (P) 613 739 7770 (F) 613 739 7703 MECHANICAL / ELECTRICAL DRAWINGS



QUADRANT ENGINEERING LIMITED, CONSULTING ENGINEERS 107 PRETORIA AVE. OTTAWA, ONTARIO, K1S 1WB (P) 613 567-1487 (F) 613 567-1493 PLANNER / LANDSCAPER

JAMES B. LENNOX & ASSOCIATES INC. LANDSCAPE ARCHITECTS

> JAMES LENNOX ASSOCIATES INC 3332 CARLING AVE. OTTAWA, ONTARIO, K2H 5A8 (P) (613) 722-5168 (F) 1 (866) 343-3942



Project Description:	Item	WINC		R DEVELOPN INCHESTER		4 LANCASTER IILDING B	LANE,			OBC Refer			
Change of	1	Project Descrip	tion:				□ Port 1	1	ПР	+ 2		Port 0	
2	ı	Project Descrip	uon.			Addition					/		.10.1.3.
3 Building Area (m²) Existing om² New 382m² Total 382m² 14.1.2 [A] 1.1.1.2 [A]	2	Major Occupan	cv (s)		<u> </u>				3.1.2.1.	(1)		9.10.2.	
4 Gross Area (m')			, , ,	<u> </u>		/ 382m² To	tal 382m	2		. ,	-/-		
Second Floor Store		Gross Area (m²	2)	Existing Or	n² New	/ 1,528m² To							
Height of Building (m)	5	Number of Stor	ies	Above Grade	9 3	Be	elow Grade	1					& 9.10.4.
Selected Compartments	6	Height of Buildi	ng (m)	+/-	11.1	8m							
Seliding Classification			- ,	ighter Access		1			3.2.2.10). & 3.2.5.		9.10.20.	
Sprinkler System Proposed	8				NTIAL O	BC			3.2.2.20)83		9.10.2.	
11 Fire Alarm Required	9	Sprinkler Syste	m Propose		Selected Selected Basemen	Compartments Floor Areas at ☐in lieu o	of roof rating	/	3.2.1.5. 3.2.2.17				
12 Water Service/ Supply is adequate	10	Standpipe Req	uired			□Yes	☑No		3.2.9.			N/A	
13	11	Fire Alarm Req	uired			□Yes	✓No		3.2.4.			9.10.18.	
Permitted Construction	12	Water Service/	Supply is a	adequate		√Yes	No		3.2.5.7.			N/A	
Actual Construction	13	High Building				□Yes	√No		3.2.6.			N/A	
16	14			_		/			3.2.2.20)83		9.10.6.	
1st and second Floor: Occupancy Group Basement (): Occupancy Group 4th floor (): Occupancy Group Ath floor (): Occupancy Group Load 21 Persons Load 21 Persons Total Occupant Load	15	Mezzanine(s) A	rea (m²)	0					3.2.1.1.	(3)-(8)		9.10.4.1.	
Hazardous Substances		Basement (4th floor ():):	Occupancy	Group	Load Load	Perso Perso	ns ns					
Required Fire Resistance Rating (FRR)	17	Barrier-free De	sign		es [√No			3.8.			9.5.2.	
Fire Resistance Resistance Resistance Resistance Rating Floors 45min / 1Hr Refer to Assemblies	18	Hazardous Sub	stances	Y,	es [√No			3.3.1.2.	& 3.3.1.19		9.10.1.3. (4)	
Wall Area of EBF (m²) L.D. (m) L/H or H/L Permitted Max % of openings FRR (Hours) Description Comb. NonComb. NonComb.	19	Fire Resistance Rating	Floors Roof Mezzan Exits Ff Floors Roof	FRR (Hours) 45min 0H nine n/s RR of Supporti Members 45min / 0H	/ 1Hr lir a a ing	or Descri Refer to Refer to Refer to Listed E or Descri Refer to	Assemblies Assemblies Assemblies Assemblies Assemblies Assemblies Design No. otion (SB-2) Assemblies Assemblies		3.2.2.20)83 & 3.2.1.4	i.		
Wall Area of EBF (m²) L.D. (m) L/H or H/L Permitted Max % of openings FRR (Hours) Description Comb. NonComb. NonComb. North na 100% OHr	20	Spatial Separat			7,0101 10			3.2.3			9 10 14		
North na 100% OHr □ □ □ □ □ □ □ □ □	/20	Wall A	rea of L.D. L/H		L/H or				sted Construction		ruction		
East na 100% 0Hr 🔽 🔽 🗸			. ("')	()			(1.15413)			Comb.	NonComb.	Comb.	NonComl
		North			na	100%	0Hr			<u>/</u>	<u></u>	<u></u>	<u></u>
South na 100% OHr □ □ □ □ □		East			na	100%	0Hr			√	√	√	✓
						1							

SB-12 COMPLIANCE PACKAGE = TABLE 3.1.1.2.A (IP) COMPLIANCE PACKAGE A5

3. REFER TO FINISH SCHEDULE IN ID PACKAGE. REPLACE GYPSUM BOARD WITH TILE BACKER IN ALL AREAS HAVING CERAMIC TILE WALL FINISH. ENSURE LISTED FIRE RATINGS ARE MAINTAINED.

PROVIDE TWO ROWS OF CONTINUOUS ACOUSTIC CAULKING AT STUD TRACK AT TOP OF SLAB, UNDERSIDE OF SLAB AND AT VERTICAL FACE WHERE STUDS ABUT STRUCTURE.

5. PIECEMEAL OF GYPSUM BOARD SHEETS IS NOT ACCEPTABLE. 6. JOINTS OF LAYERED GYPSUM BOARD SHOULD BE STAGGERED.

4. INTERIOR STUD WALLS:

7. CAULK AT TOP AND BOTTOM OF WALLS AT EDGE OF GYPSUM BOARD PANELS.

8. PROVIDE CAULKING ROD BACKUP AT ANY GAP OVER 1/4". 9. ELECTRICAL AND DEVICE BOXES ON OPPOSING FACES OF WALL SHALL BE LOCATED IN SEPARATE STUD CAVITIES.

10. RUN FIBERGLASS BATT/MINERAL WOOL (REFER TO WALL TYPE) INSULATION BEHIND AND AROUND ALL ELECTRICAL BOXES. - NO BACK TO

11. BACKING TO BE PROVIDED AT ALL MILLWORK LOCATIONS, COORDINATE ON SITE.

12. SEAL ALL PENETRATIONS THROUGH ACOUSTICAL RATED WALLS (PARTY WALLS AND CORRIDOR WALLS) TIGHT WITH A COMBINATION OF JOINT COMPOUND AND ACOUSTICAL CAULK.

13. SEAL ALL PENETRATIONS THROUGH FIRE RATED WALLS (PARTY WALLS, ĆORRIDOR WALLS, ETC) TIGHT WITH A COMBINATION OF JOINT COMPOUND AND FIRE CAULK, TO ENSURE A CONTINUOUS FIRE RATING. PRÓVIDE TESTED ASSÉMBLÍES FOR ALL FIRE STOPPING. 14. PROVIDE WOOD BLOCKING WITHIN WALL TO PROVIDE ANCHORAGE FOR CABINETS, WASHROOM ACCESSORIES, HAND RAILINGS, ETC. BLOCKING SHALL NOT LINK BOTH SIDES OF A WALL. PLYWOOD MAY BE USED AS BLOCKING ON THE INNER LAYER OF DOUBLE LAYER WALL

ASSEMBLIES. 18GA METAL STRIPS IN 6" IN WIDTH & CONTINUOUS THROUGHOUT LENGTH OF BLOCKING REQUIREMENT MAY ALSO BE USED. 15. PROVIDE 3/4" FIRE-RATED OUT TREATED PLYWOOD, GOOD ONE SIDE WITH FIRE RETARDANT PAINT, FOR MOUNTING OF ALL ELECTRICAL PANELS, CABLING, COMMUNICATION, BELL, AND SECURITY PANELS. REFER TO ELECTRICAL DRAWINGS FOR LOCATIONS.

16. THICKEN WALLS AS REQUIRED TO ACCOMMODATE ELECTRICAL PANELS & MECHANICAL ITEMS. CONTRACTOR TO CONFIRM CODE COMPLIANCE WITH ARCHITECT BEFORE SITE WORK BEGINS

17. ALL EXPOSED CONCRETE TO BE ENCLOSED WITH 12.7mm GYPSUM BOARD ON 41mm STEEL STUDS UNLESS NOTED OTHERWISE ON PLANS OR

18. FOR ASSEMBLIES REQUIRING TO CONFORM TO A LISTED ULC/UL RATING, MATERIALS WITHIN THE ASSEMBLY SHALL BE EXACTLY AS PER THE TESTED ASSEMBLY. ALL MATERIAL SHALL BE LABELED WITH ULC/UL IDENTIFICATION. 19. ALL ELECTRICAL SWITCHES ARE TO BE LOCATED BETWEEN 4"-8" FROM THE ENTRANCE DOOR TO A ROOM, LOCATE STUDS TO

ACCOMMODATE THE LOCATION OF SWITCHES SHOWN ON ELECTRICAL DRAWINGS AND SUIT THE APPROVED SUITE MOCK-UP. 20. PROVIDE SCUPPERS AT EDGES OF ROOF WHERE OVER FLOW CONTROL ROOF DRAINS ARE SPECIFIED. CONFIRM LOCATIONS WITH

21. ALL FIRE DAMPER INSTALLATION TO BE PER MANUFACTURER INSTRUCTIONS - HVAC CONTRACTOR TO COORDINATE ON SITE WITH DRYWALL/FRAMING CONTRACTOR TO ENSURE INSTALLATION INSTRUCTIONS ARE FOLLOWED EXACTLY AND ACCESS DOORS ARE PROVIDED. 22. PROVIDE ALL CLOSETS WITH MINIMUM 2 FULL WIDTH SHELF 12" DEEP AND WITH ONE FULL WIDTH HANGER ROD.

23. ANY WASHROOM WALLS ADJACENT TO LIVING SPACES/PUBLIC AREAS ARE TO HAVE SOUND ATTENUATING BATT INSULATION -ULC

APPROVED- IN THE STUD CAVITIES (TO FILL CAVITY). 24. ALL STEEL STUDS TO BE FRAMED @ 406mm o/c U.N.O ON PLAN.


25. ALL STEEL STUDS ARE TO EXTEND TO UNDERSIDE OF STRUCTURE U.N.O.

26. ALL GYPSUM BOARD IS TO EXTEND TO FULL HEIGHT OF PARTITION U.N.O.

27. INTERIOR DOORS TO BE INSTALLED 100mm FROM ADJACENT WALL U/N/O

28. INTERIOR FINISHES AS PER ID PACKAGE

30. FRAME DOOR OPENINGS SO THERE IS 100mm FROM EDGE OF DOOR FRAME TO PERPENDICULAR WALL

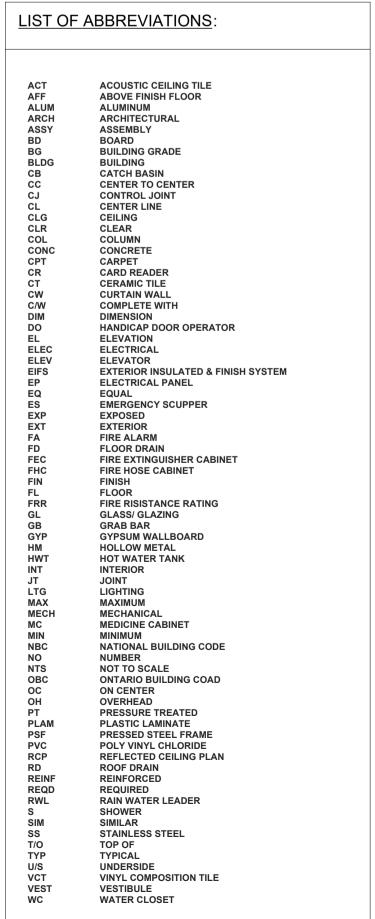

SECTION CUT		
· ·	DRAWING NUMBER	
A101	ROOM NUMBER	
ROOM TAG		
	ROOM NAME	
	ROOM NUMBER	
DOOR TAG		
1t	DOOR NUMBER	
WINDOW TAG		
	(B) -BASEMENT (#) -WINDOW No. (M) -MAIN FLOOR	
⟨W#⟩	(S) -SECOND FLOOR (T) -THIRD FLOOR	
CONSTRUCTION ASSEMBL	y	
- CONSTRUCTION ACCENIBE	(W) -WALL (#) -ASSEMBLY No.	
11 A1010 100	(EW) -EXISTING WALL (P) -PARTITION	
₩ 100	(F) -FLOOR (R) -ROOF	
POINT ELEVATION TAG		
1000		
	ELEVATION HEIGHT	
ELEVATION TAO		
ELEVATION TAG		
Elevation	ELEVATION HEIGHT	
Name	NAME OF ELEVATION	
REVISION		
DEV		
REV 1	REVISION LOCATION AND NUMBER	
GRID TAG		
0	GRID NUMBER	
CALLOUT TAG		
J. 1200 1 1/10		
1	DRAWING NUMBER	
(A101)	SHEET NUMBER	



1) ALL WORK TO BE IN COMPLIANCE WITH LOCAL BUILDING CODES, REGULATIONS AND BY-LAWS. 2) ADDITIONAL DRAWINGS MAY BE ISSUED FOR CLARIFICATION TO ASSIST PROPER EXECUTION OF WORK. SUCH DRAWINGS WILL HAVE THE SAME MEANING AND INTENT AS IF THEY WERE INCLUDED WITH PLANS IN

3) DO NOT SCALE DRAWINGS. 4) ALL SUB-CONTRACTORS TO TAKE THEIR OWN ON-MEASUREMENTS AND BE RESPONSIBLE FOR THEIR

5) NOTIFY SHAWN J. LAWRENCE ARCHITECT FOR ANY ERRORS AND/OR OMISSIONS PRIOR TO START OF WORK.

04 2022.11.07 ISSUED FOR RE-ZONING AND SPC 2022.11.01 ISSUED FOR COORDINATION 2022.08.16 ISSUED FOR COORDINATION

D ARCHITIECTS Z

SHAWN JAMES LAWBENCE LICENCE LICENCE 4442

NORTH ARROW:

No. DATE REVISION S.J.LAWRENCE 18 DEAKIN STREET SUITE 205 OTTAWA, ONTARIO K2E 8B7

2022.07.05 ISSUED FOR REVIEW

T: (613) 739.7770 F: (613) 739.7703 NCORPORATED

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CARRUTHERS AVENUE **DEVELOPMENT** 266-268 CARRUTHERS AVENUE, OTTAWA, ON


GENERAL NOTES AND SPECS


B.L. S.J.L. PLOT DATE: 2022-11-07 11:46:31 AM JOB NUMBER:


SL-1077-22


As indicated

A0.1

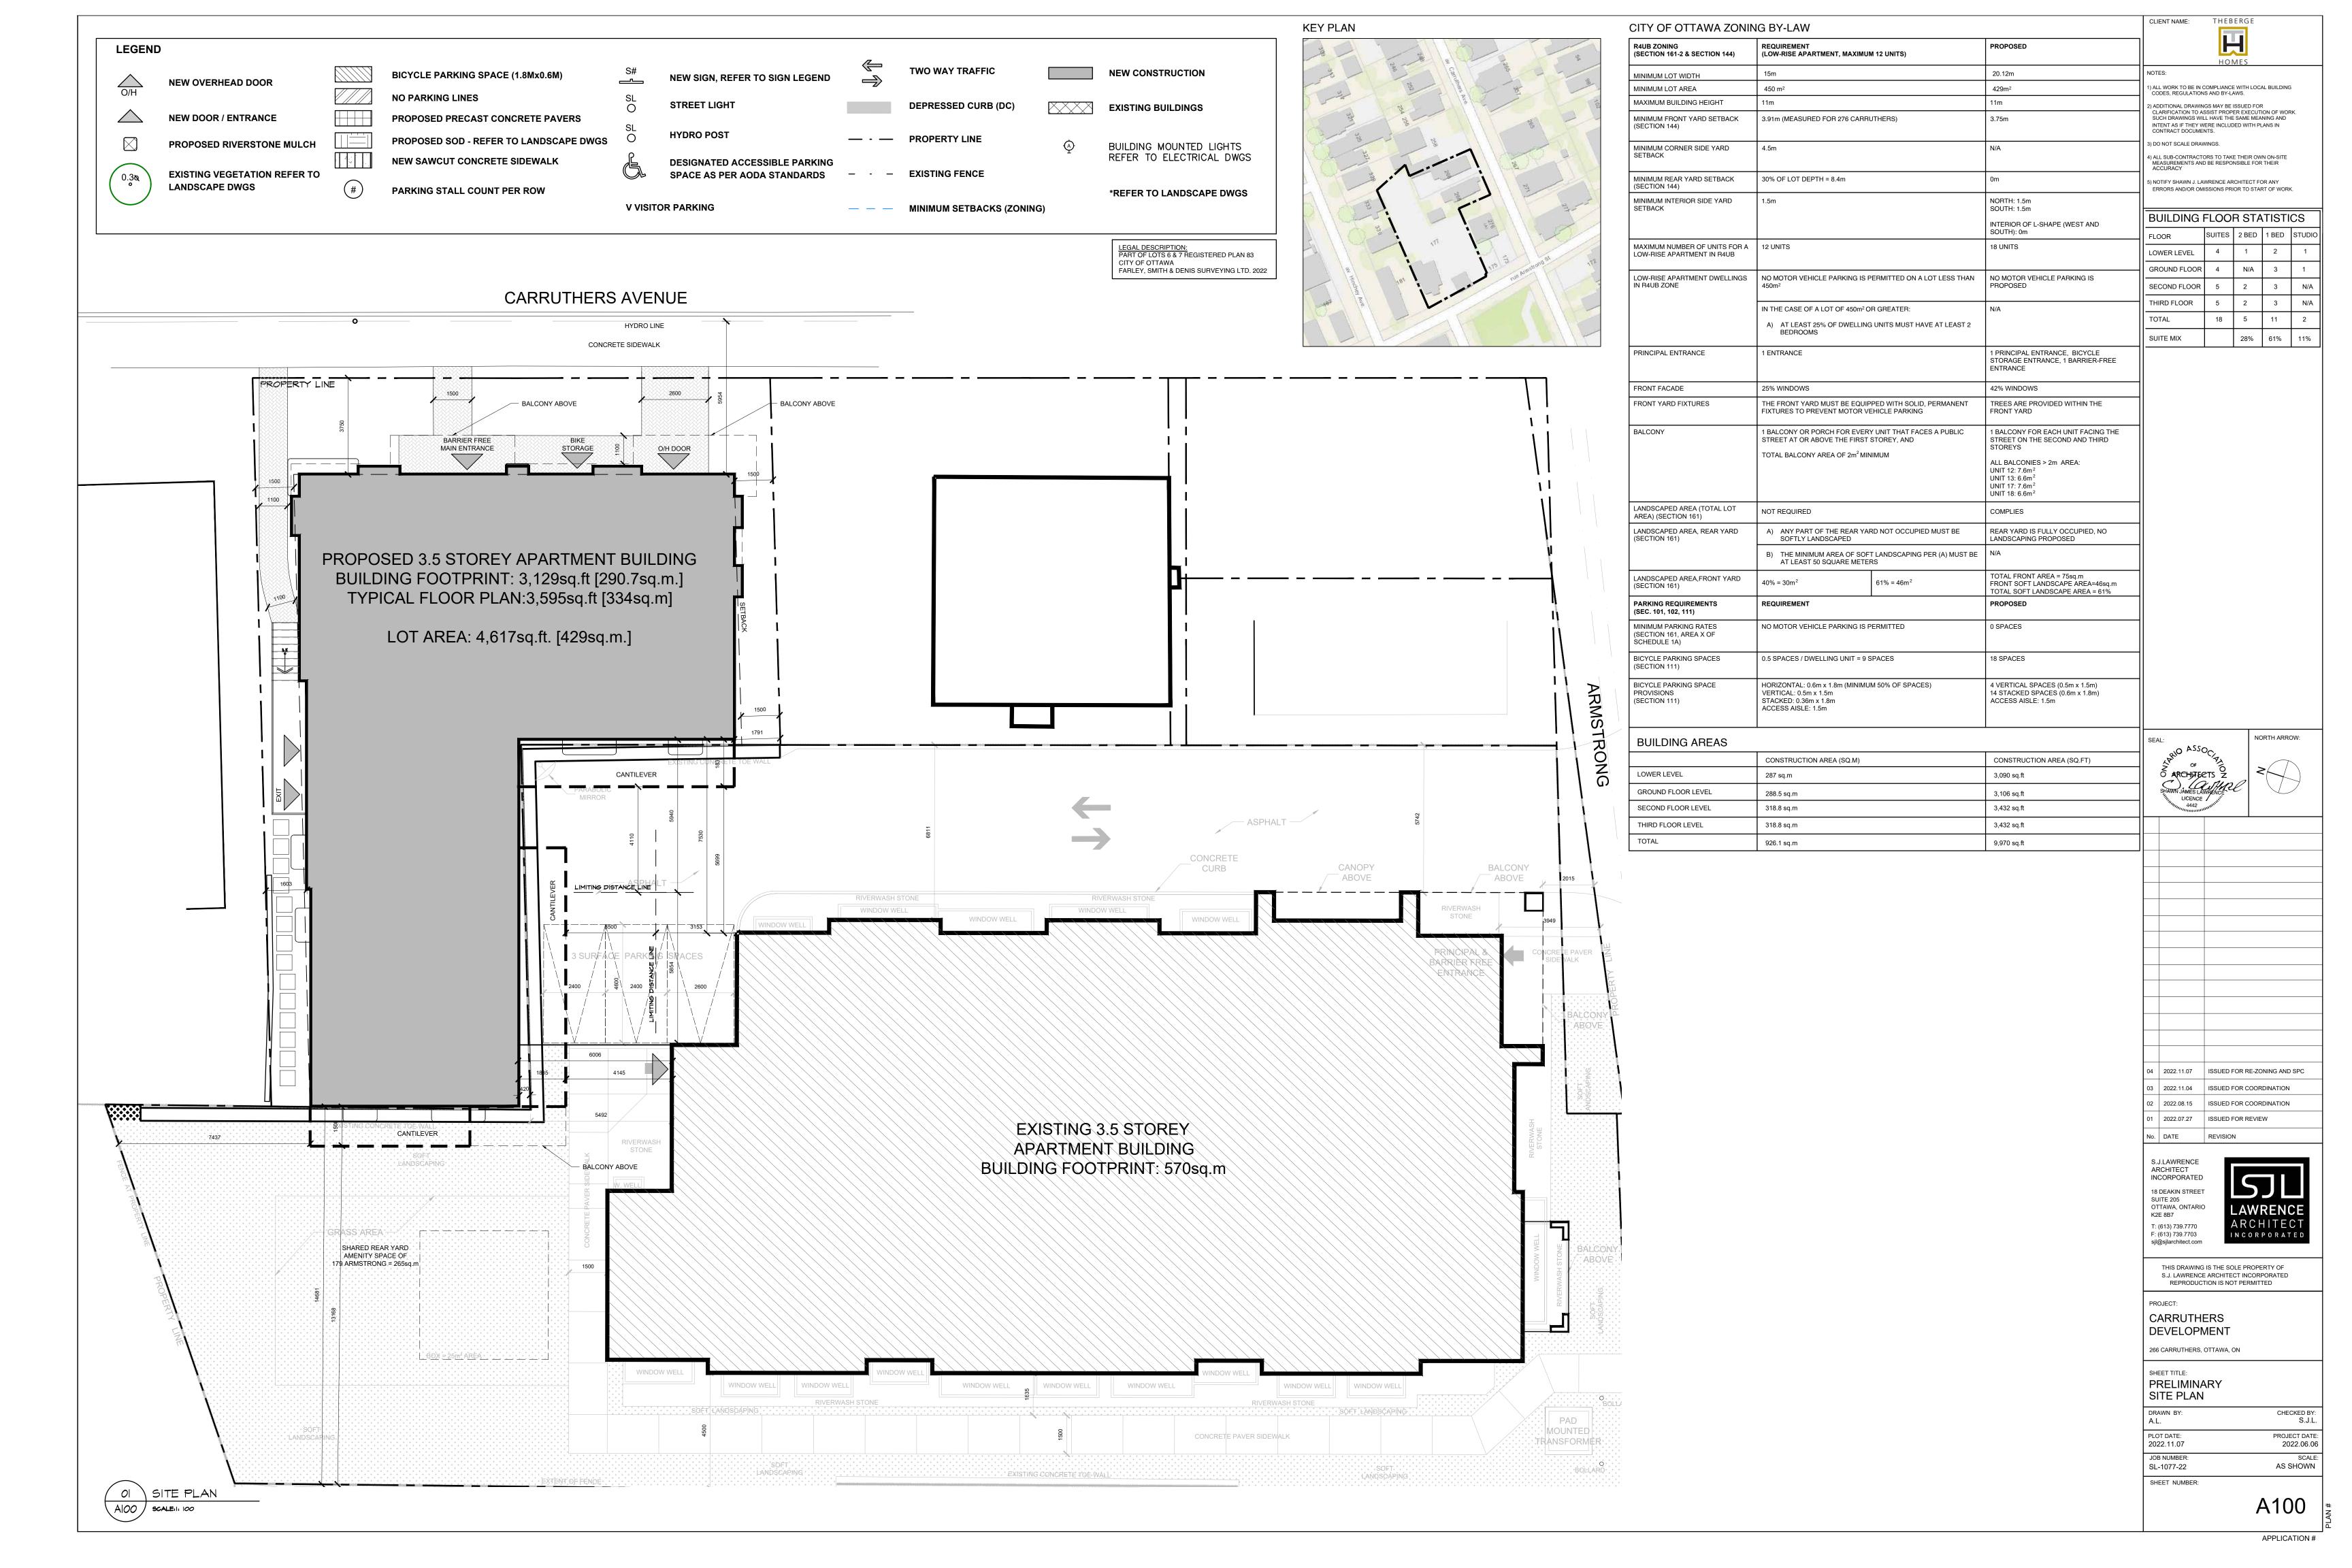


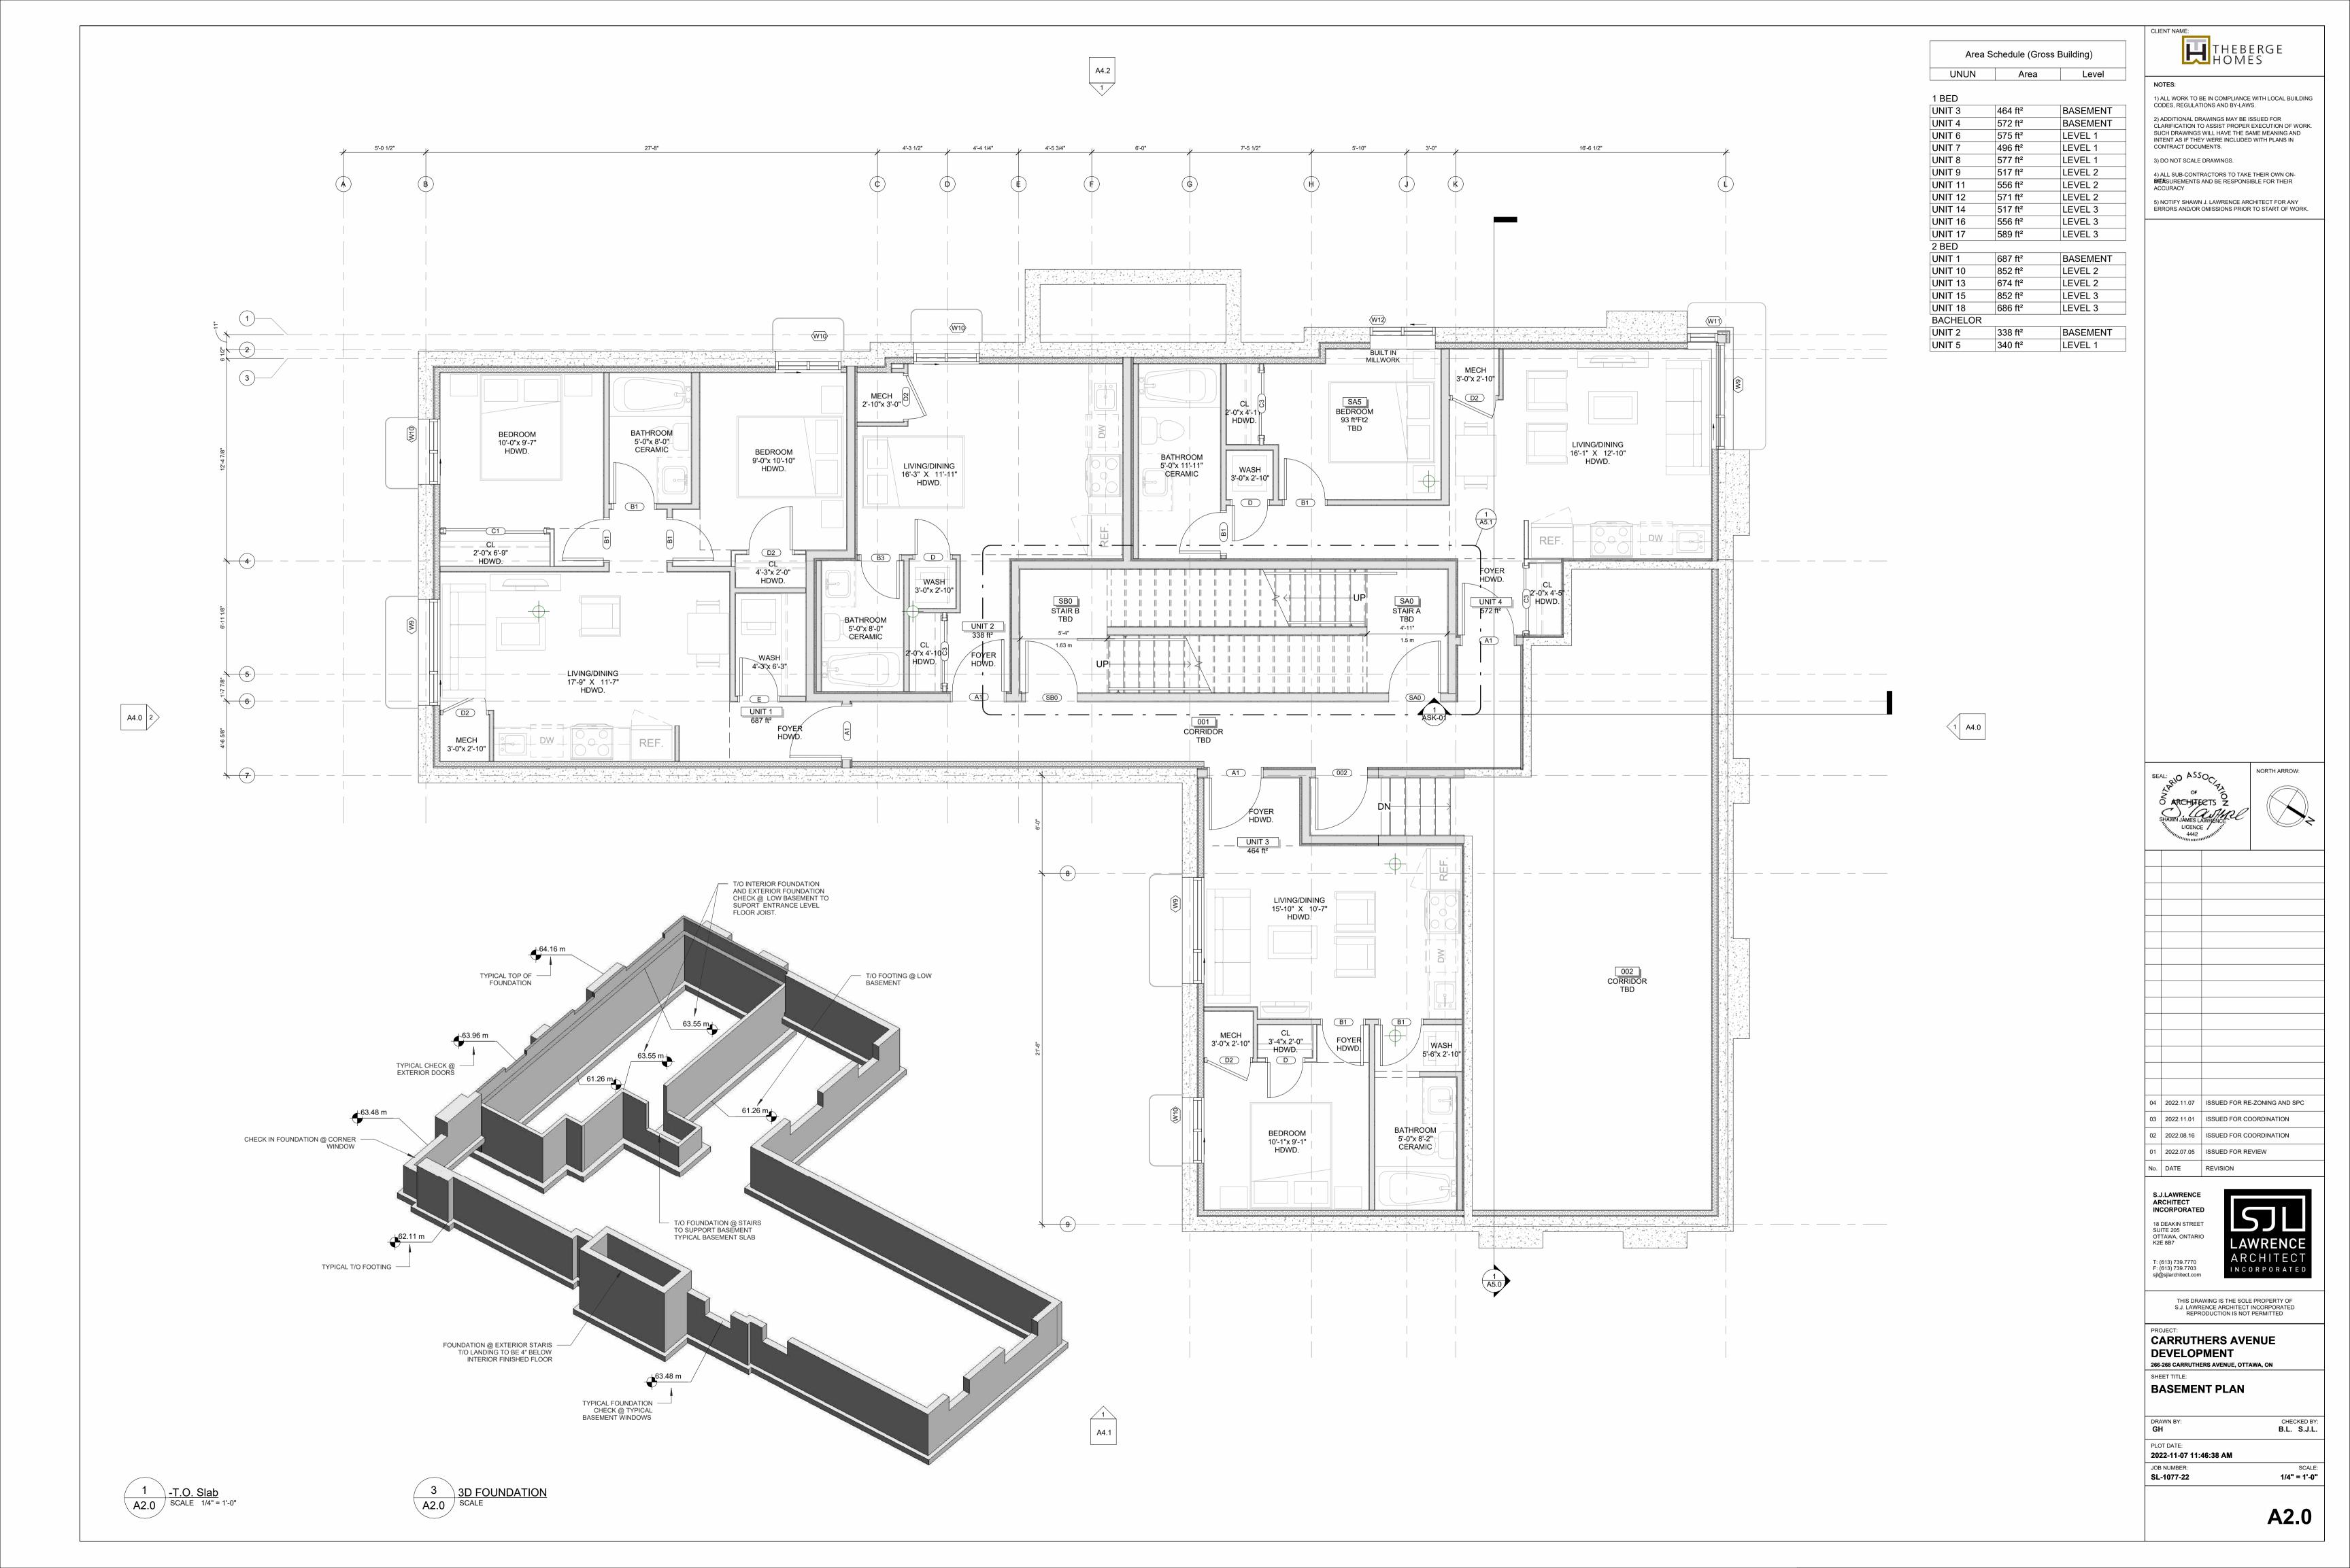

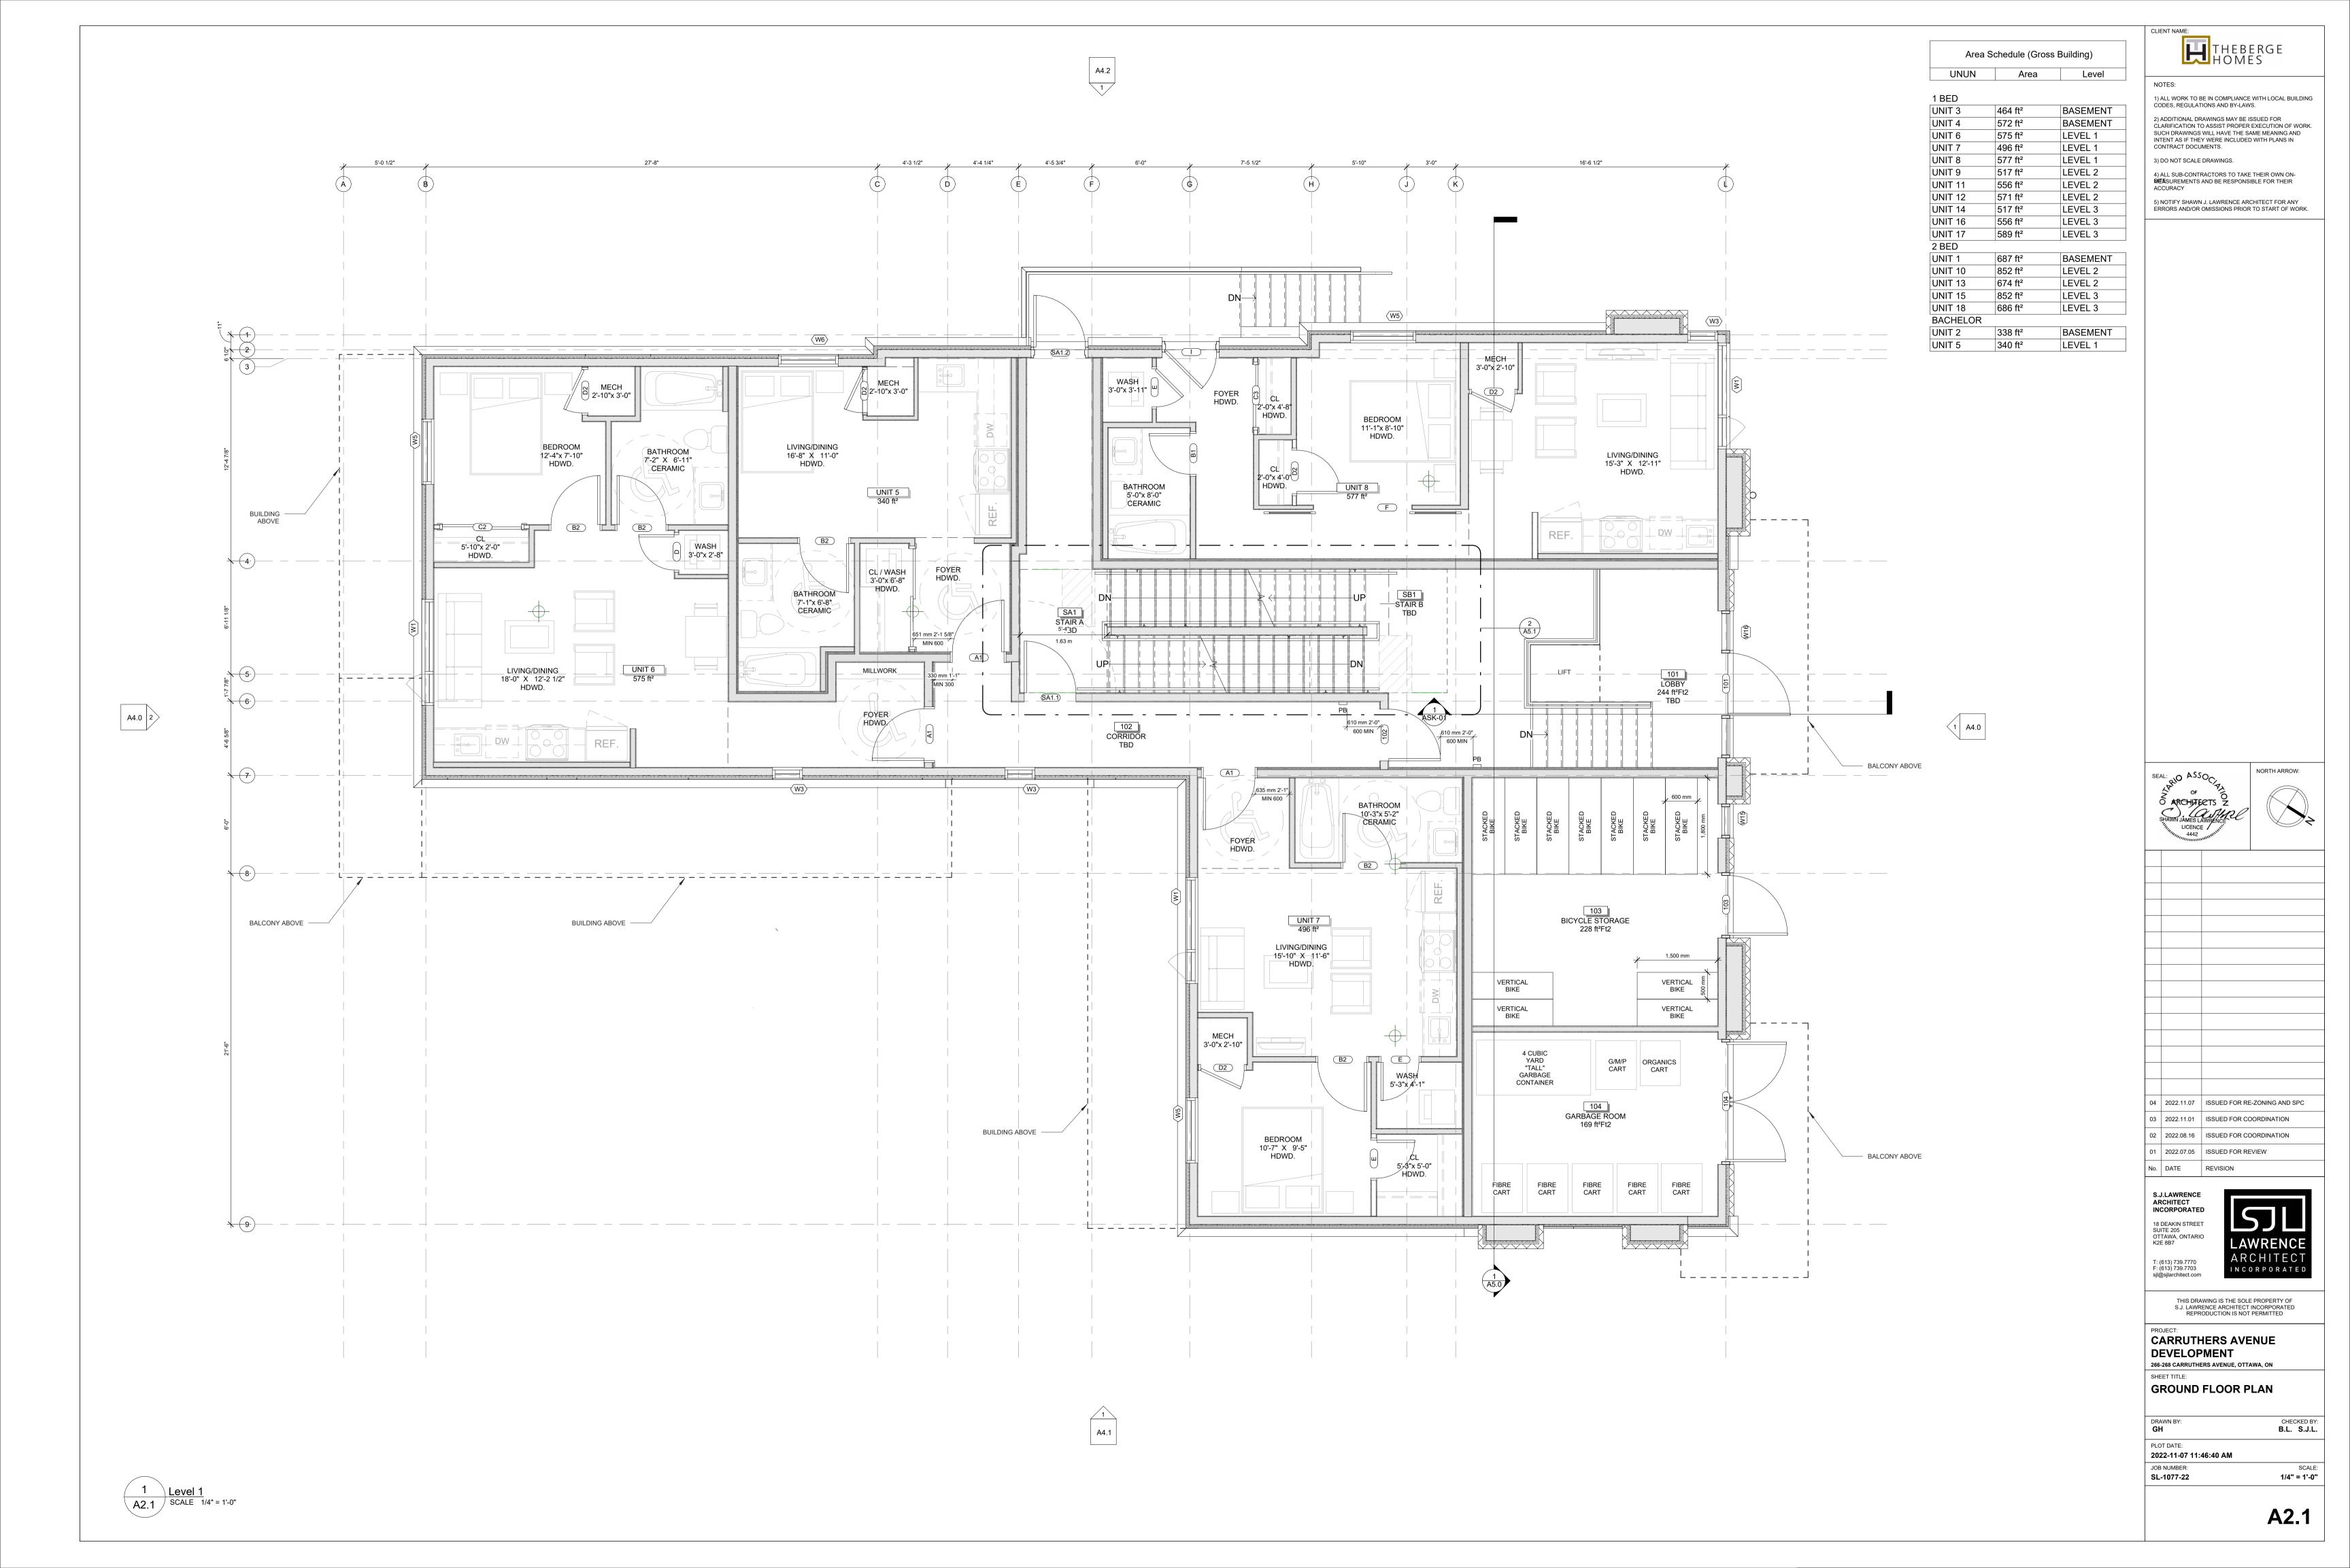

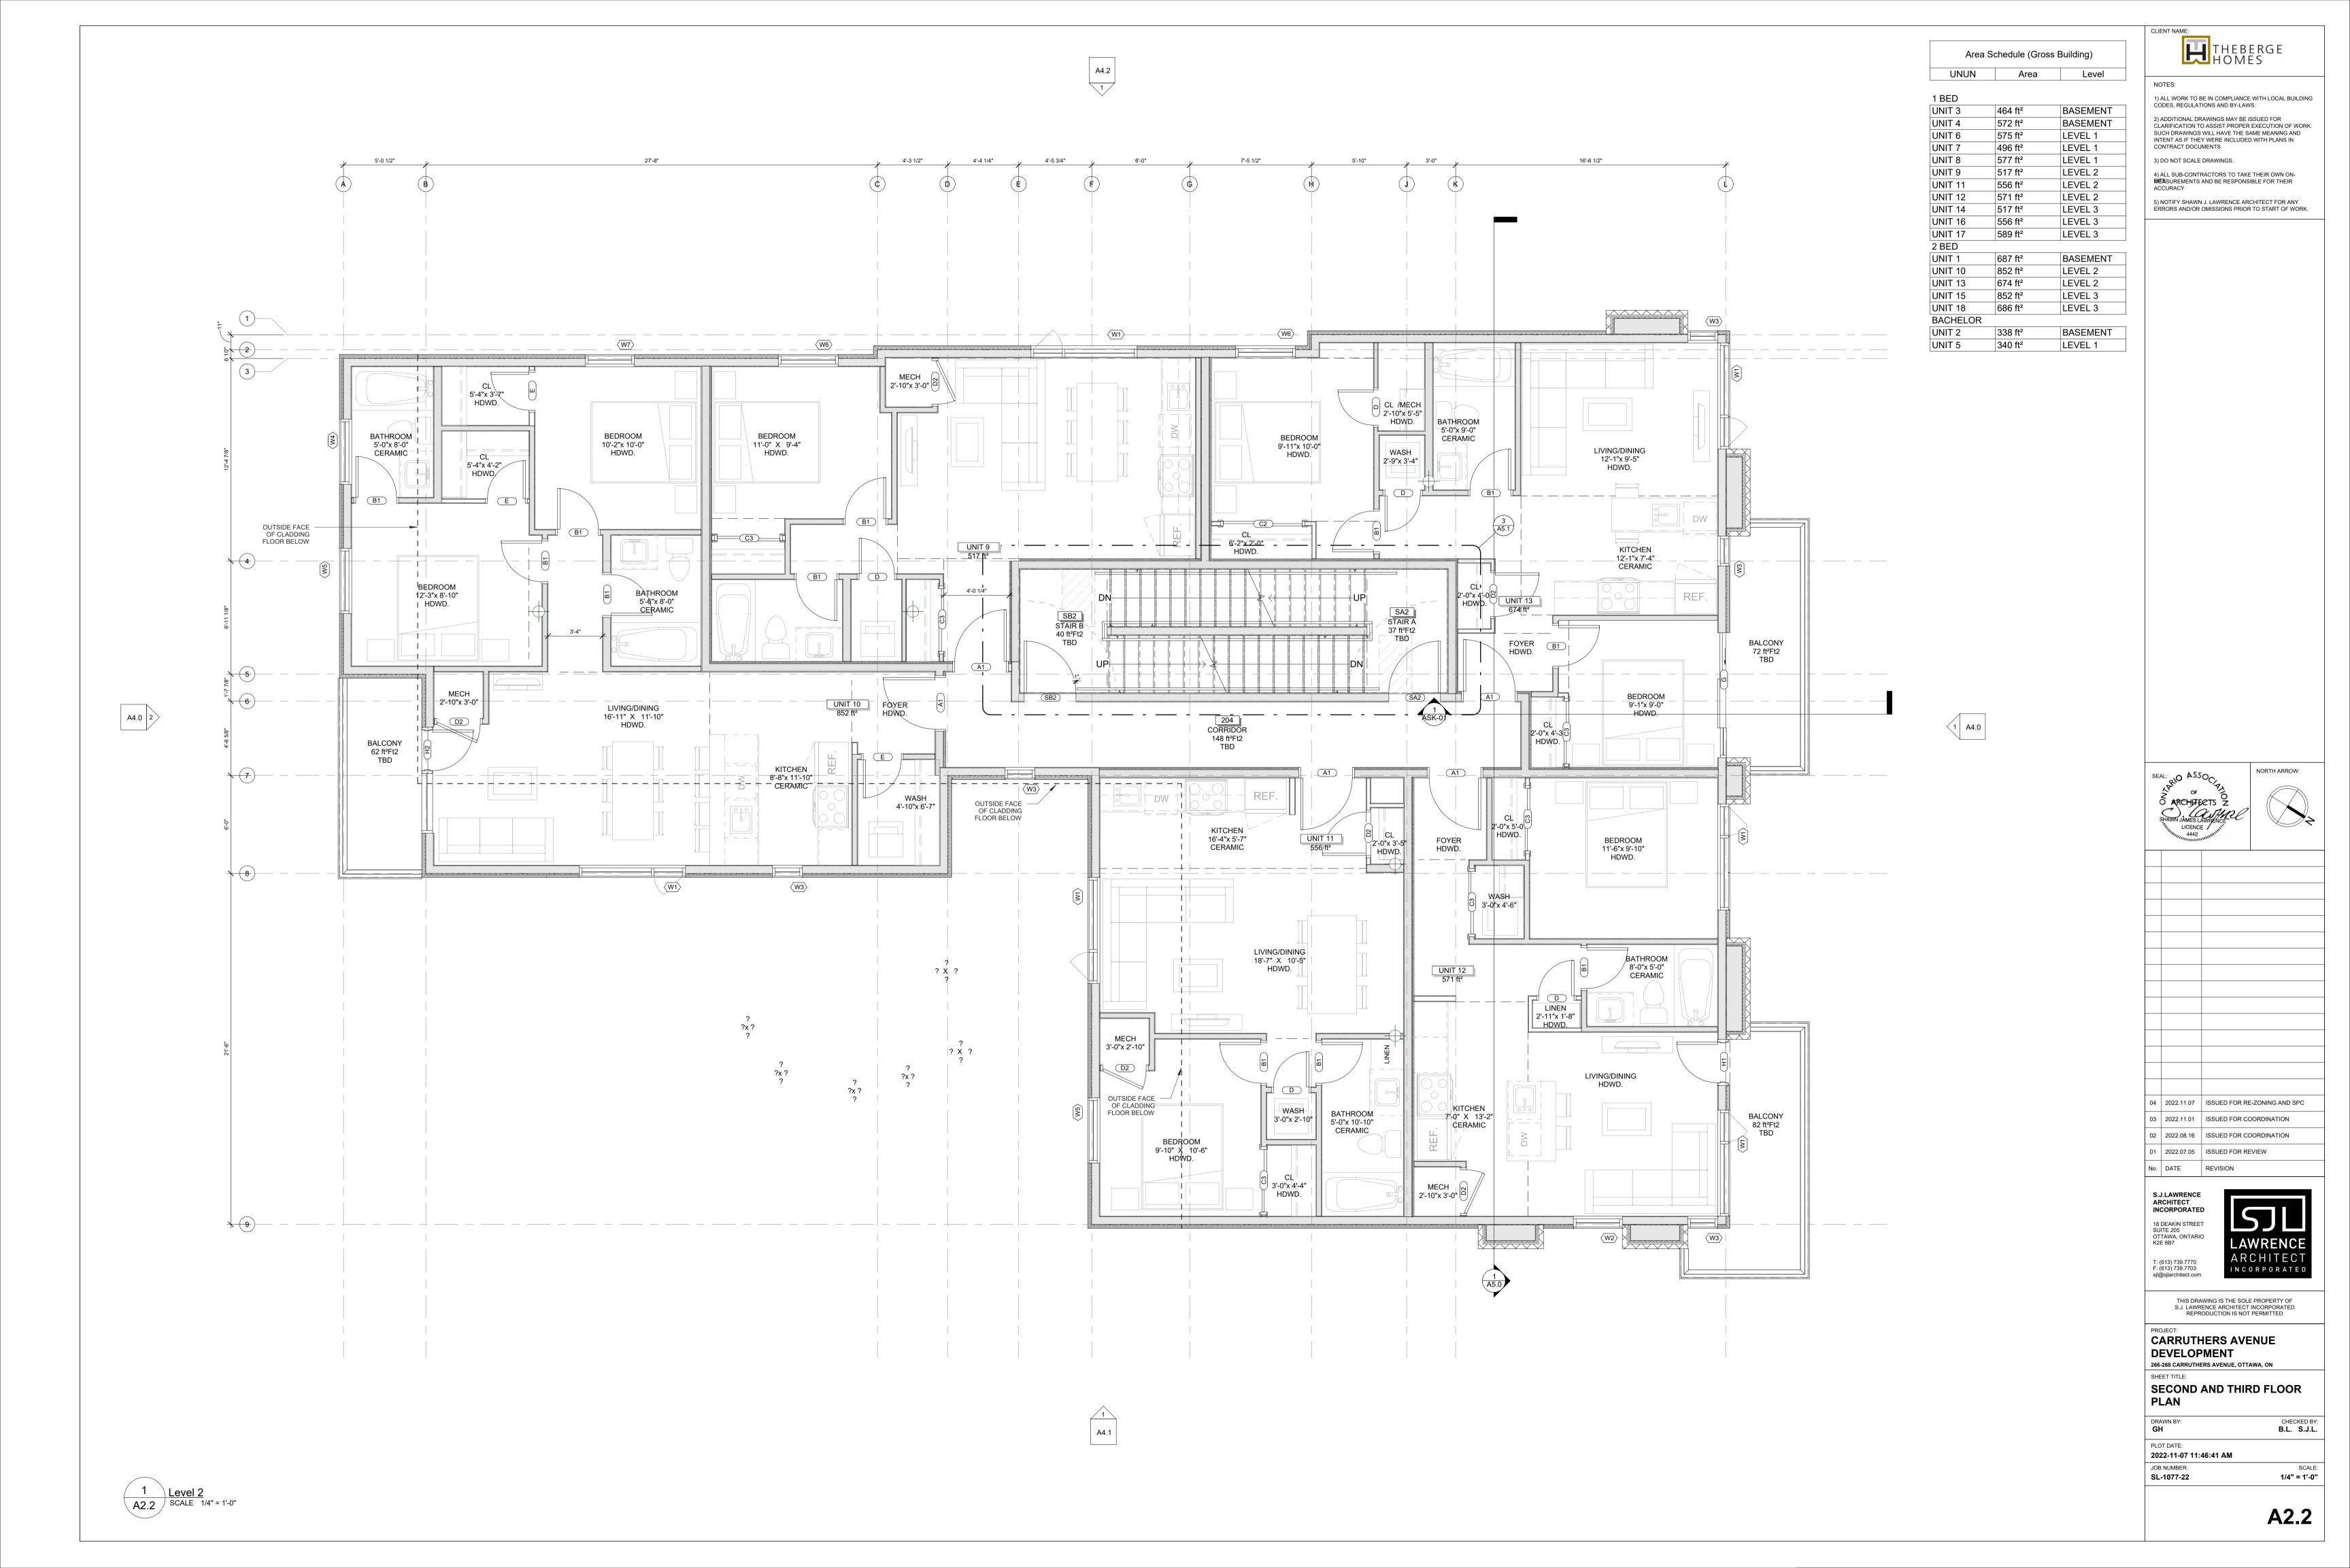



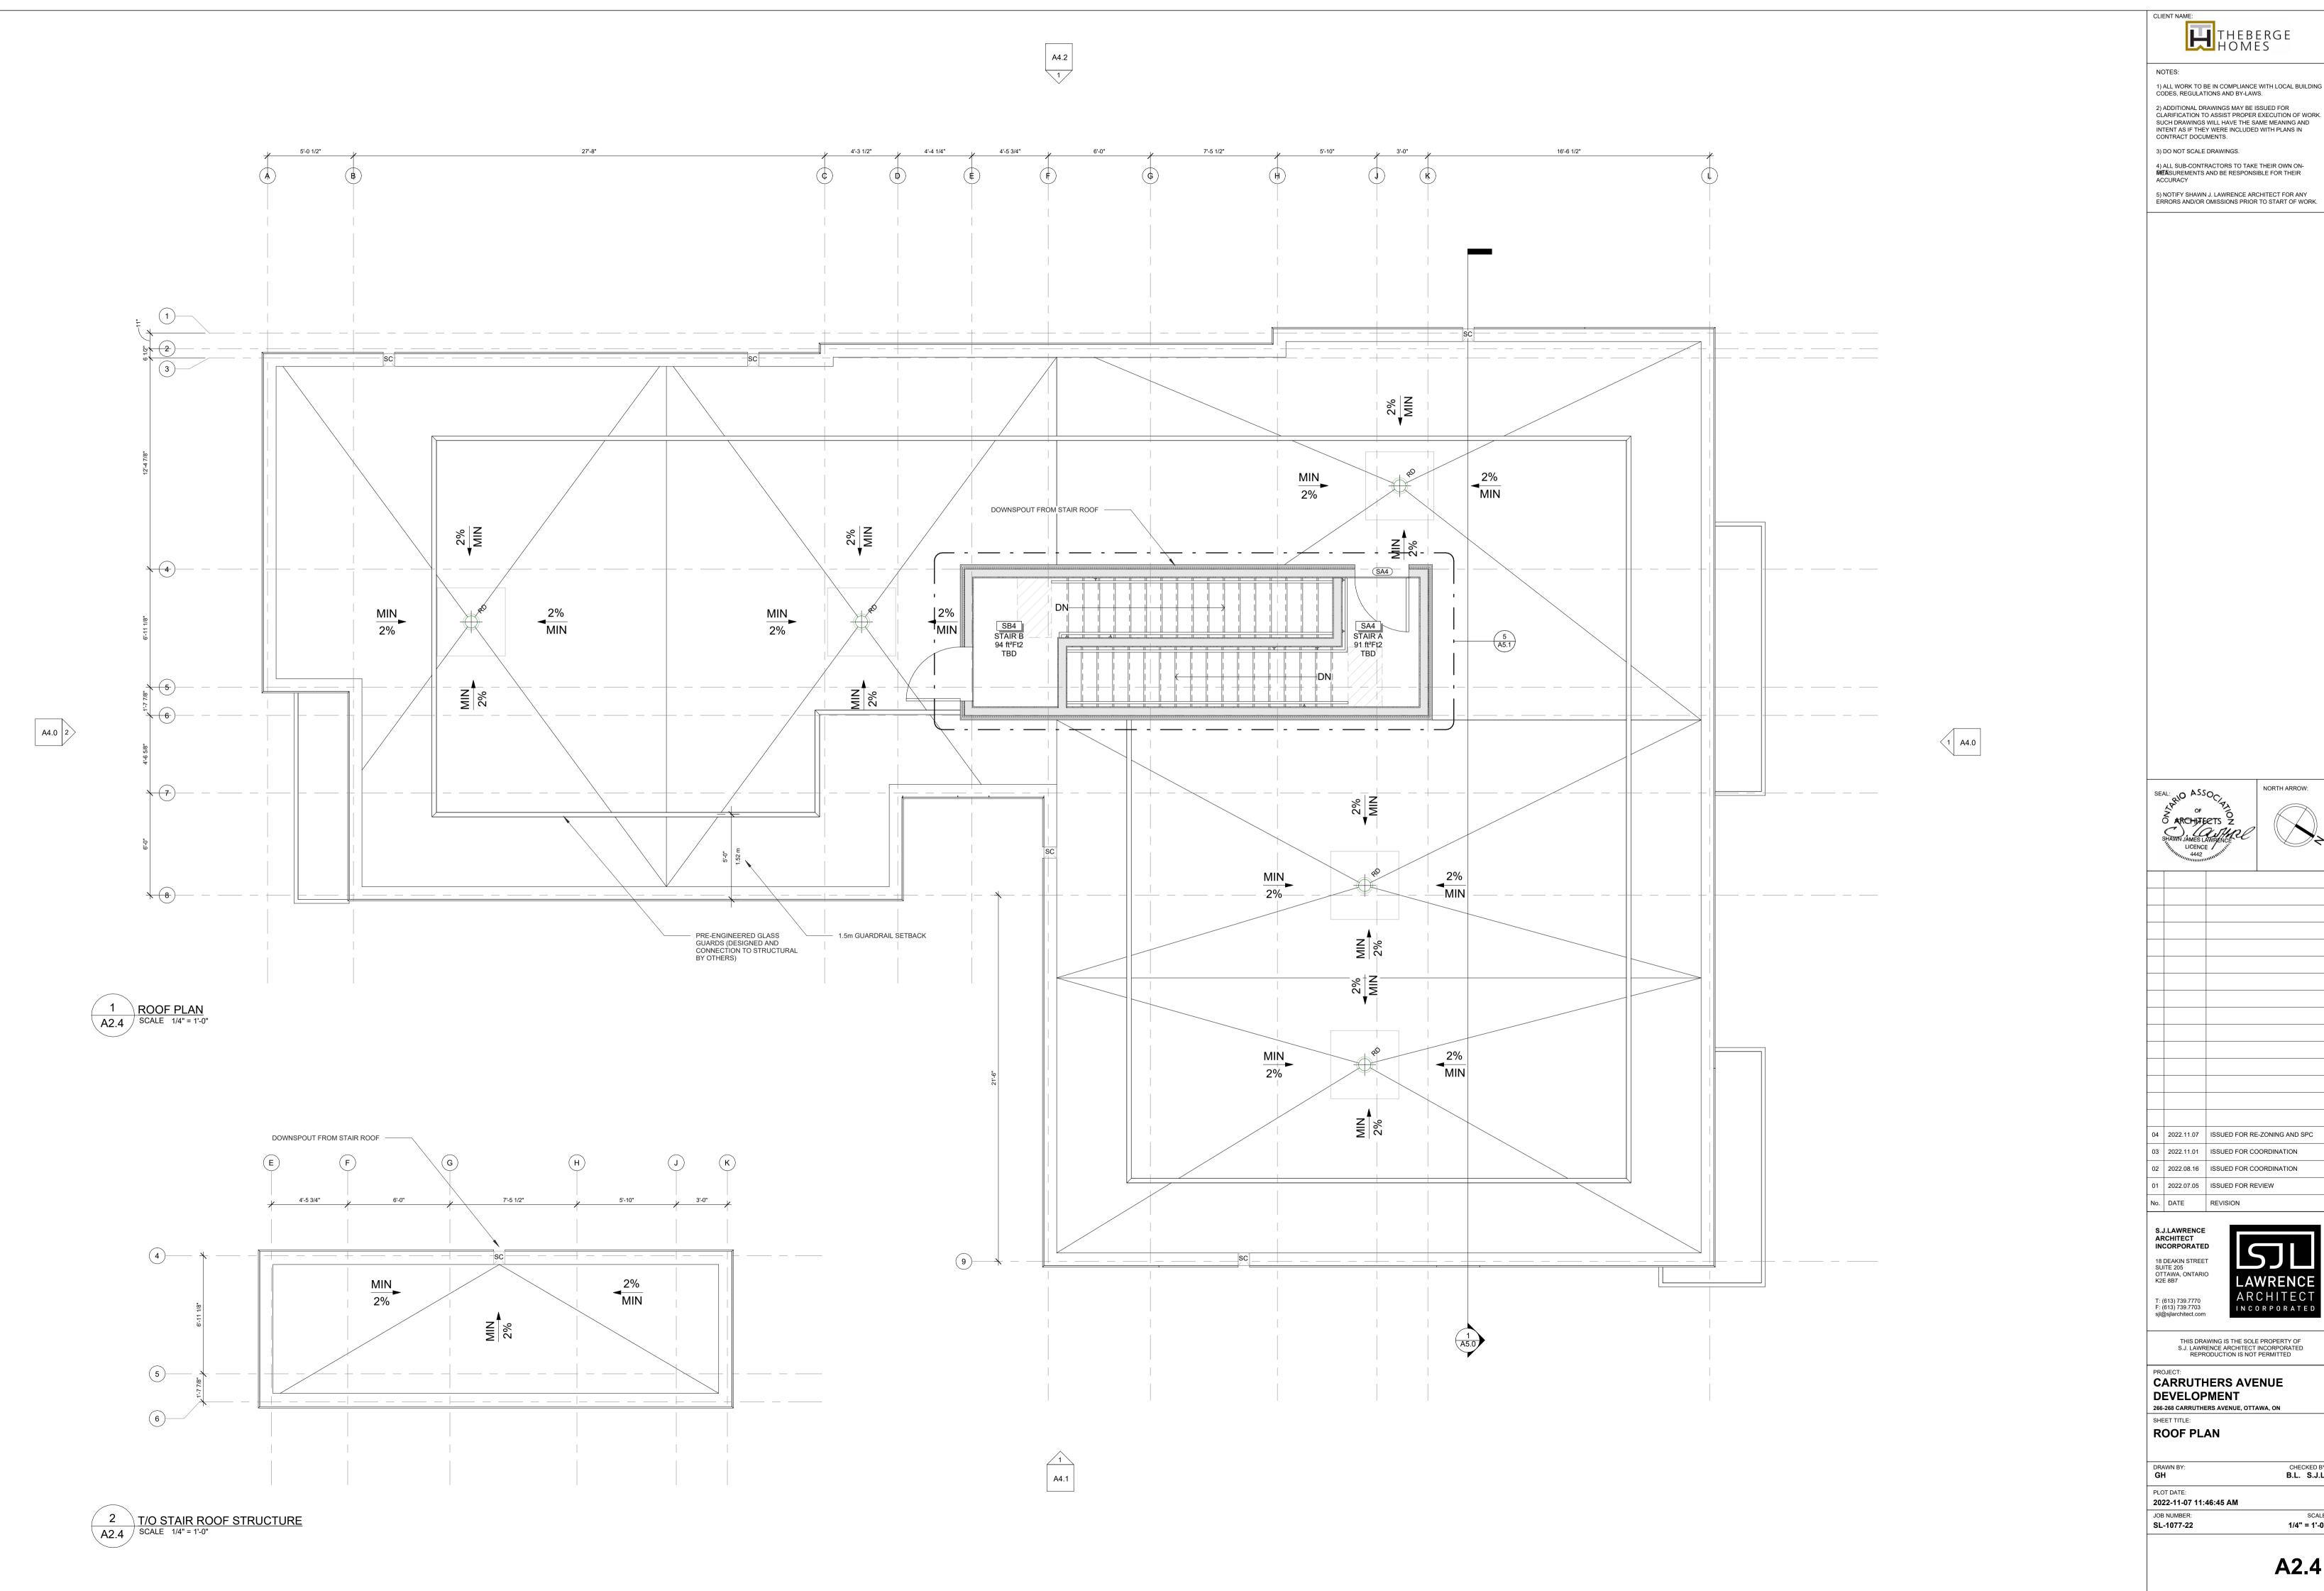

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03 2022.11.01 ISSUED FOR COORDINATION 02 2022.08.16 ISSUED FOR COORDINATION INCORPORATED

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CHECKED BY: B.L. S.J.L.

SCALE: 1/4" = 1'-0"

A2.4



THEBERGE

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04 2022.11.07 ISSUED FOR RE-ZONING AND SPC 03 2022.11.01 ISSUED FOR COORDINATION 02 2022.08.16 ISSUED FOR COORDINATION 2022.07.05 ISSUED FOR REVIEW No. DATE REVISION

SHAWN JAMES LAWRENCE
LICENCE
4442

18 DEAKIN STREET SUITE 205 OTTAWA, ONTARIO K2E 8B7 ARCHITECT T: (613) 739.7770 F: (613) 739.7703 sjl@sjlarchitect.com INCORPORATED

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CARRUTHERS AVENUE DEVELOPMENT
266-268 CARRUTHERS AVENUE, OTTAWA, ON

FRR PLANS


S.J.LAWRENCE

CHECKED BY: B.L. S.J.L.

PLOT DATE: 2022-11-07 11:46:49 AM JOB NUMBER: **SL-1077-22**

A2.5

SCALE: 1/8" = 1'-0"

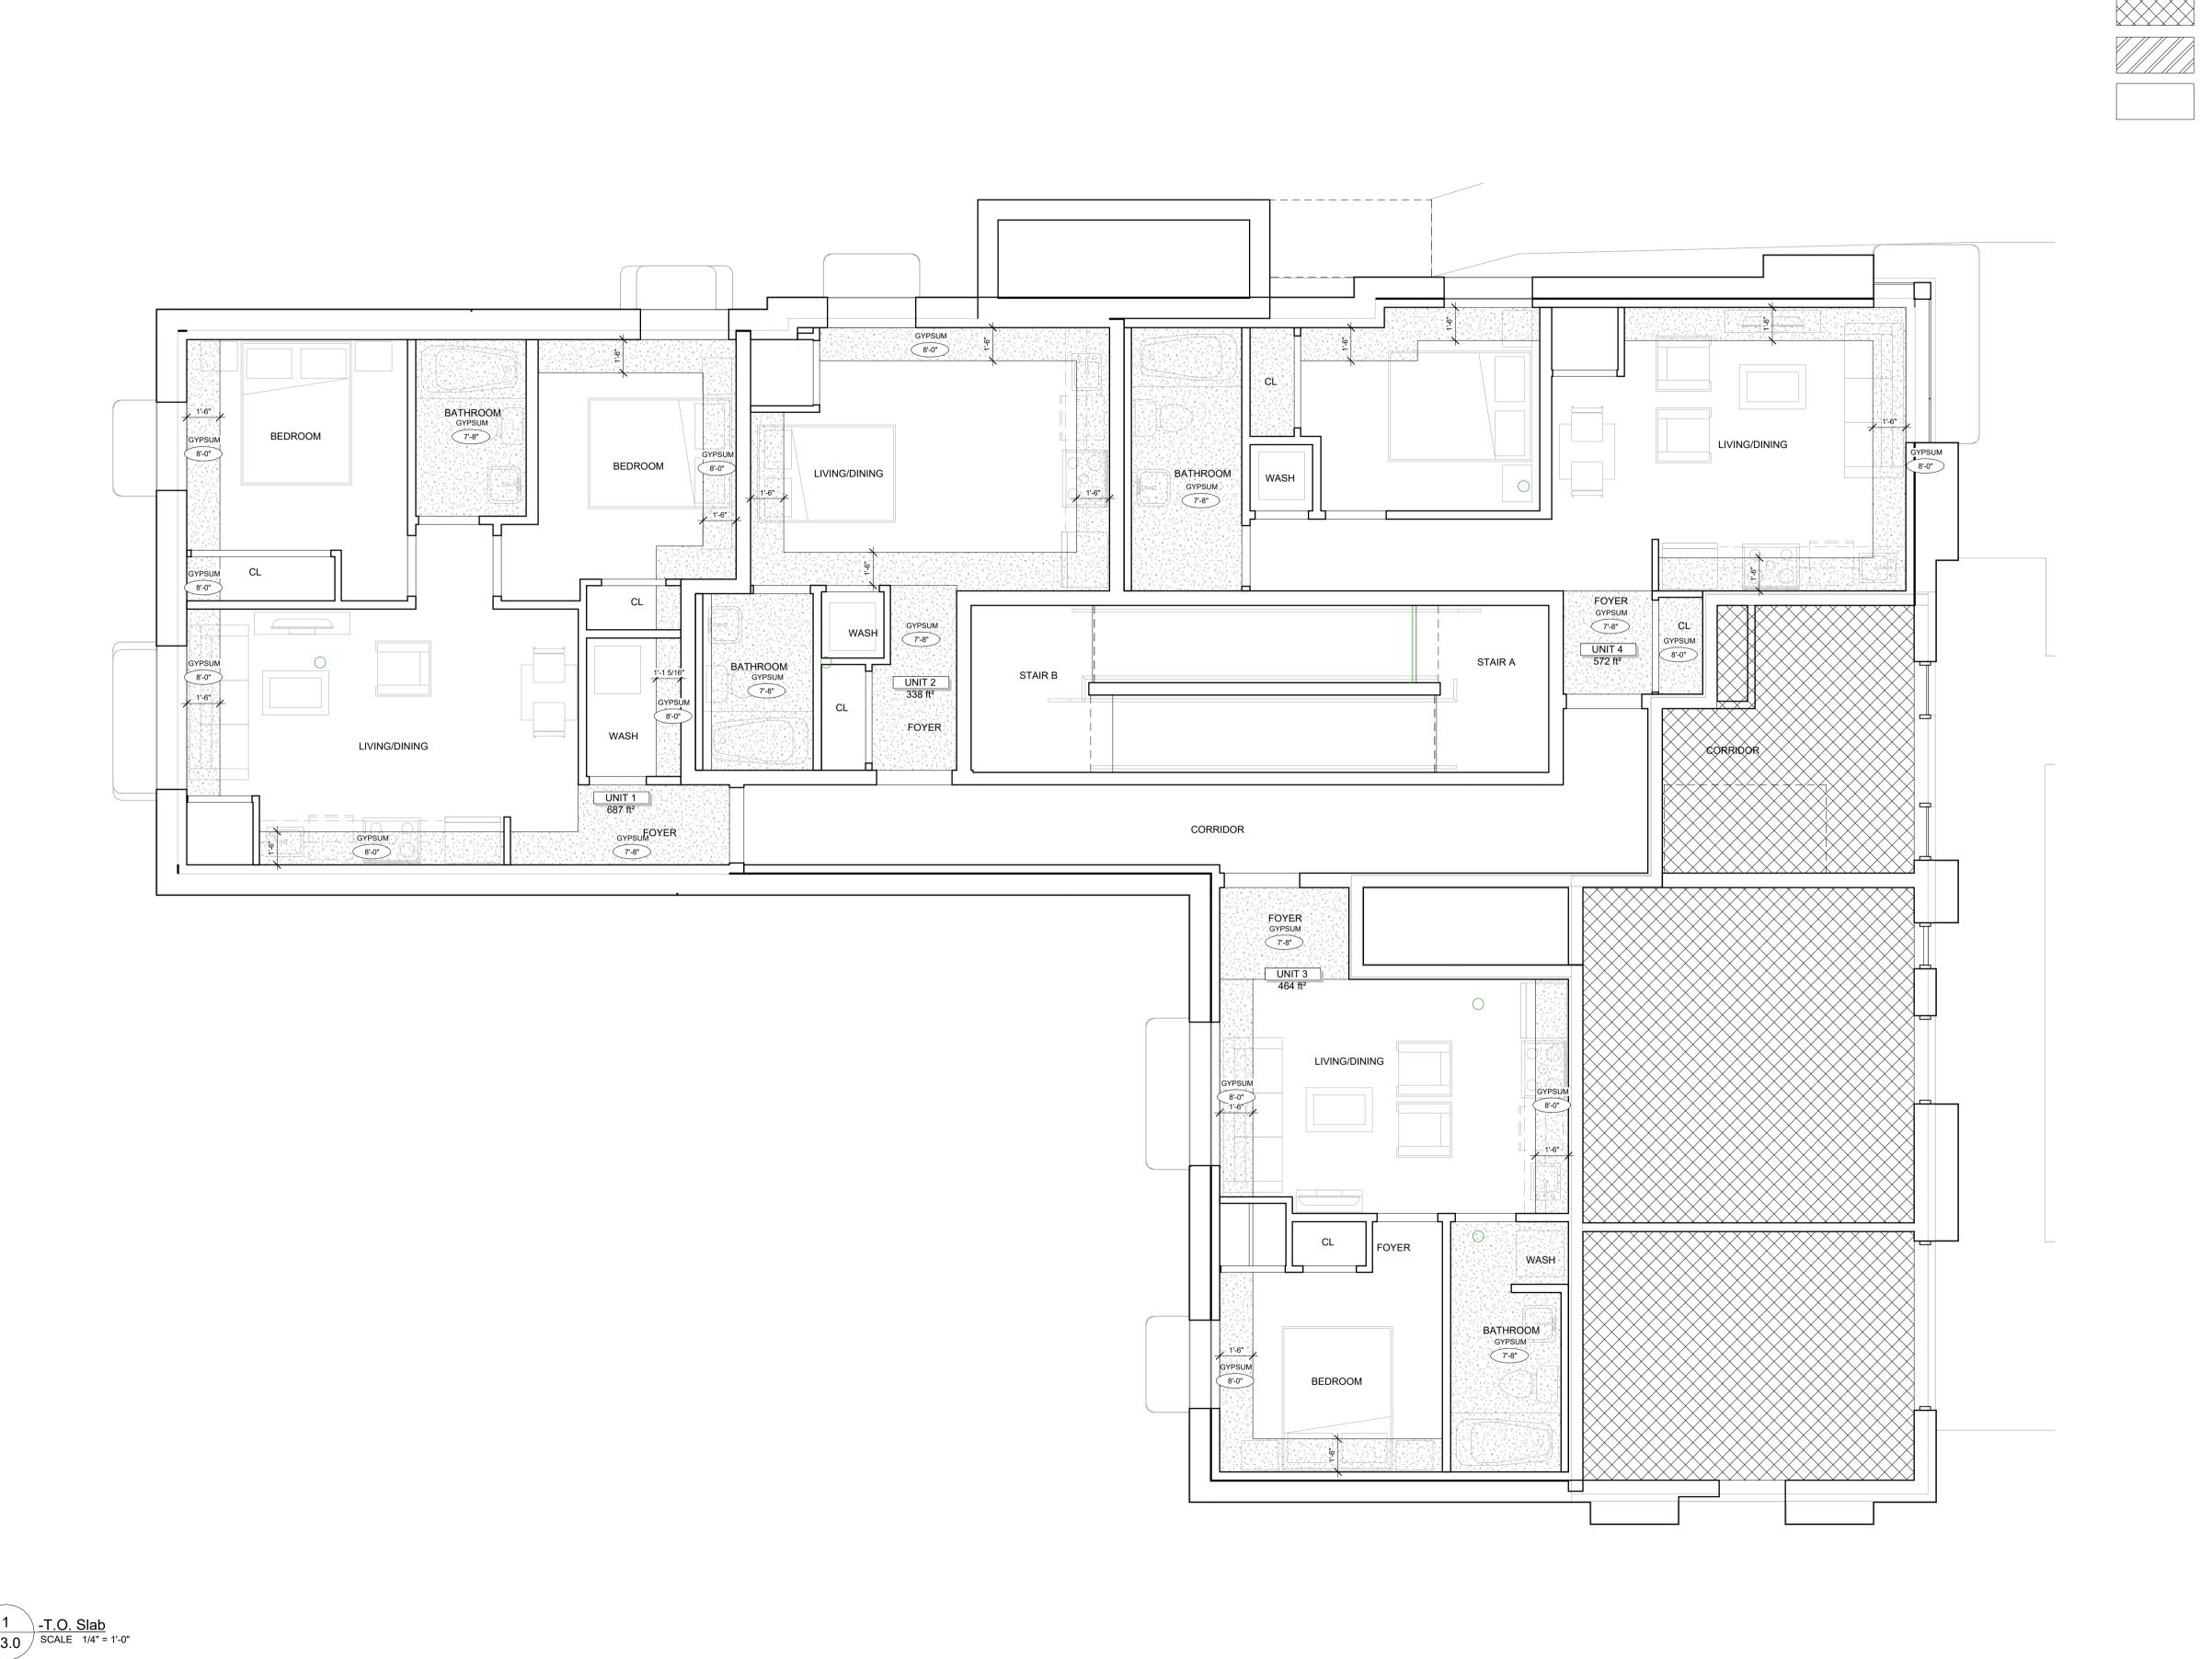

CEILING LEGEND

BULKHEAD - REFER TO RCP FOR HEIGHT

U/S OF ASSEMBLY - 7'-0"

U/S OF ASSEMBLY - 13'-9"

U/S OF ASSEMBLY - 9'-0"

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2022.07.05 ISSUED FOR REVIEW

No. DATE REVISION

CARRUTHERS AVENUE

DEVELOPMENT
266-268 CARRUTHERS AVENUE, OTTAWA, ON

REFLECTED CEILING PLANS

PLOT DATE: 2022-11-07 11:46:51 AM

JOB NUMBER: **SL-1077-22**

A3.0

CHECKED BY: B.L. S.J.L.

SCALE: As indicated



CLIENT NAME:

THEBERGE
HOMES

NOTES:

CEILING LEGEND

BULKHEAD - REFER TO RCP FOR HEIGHT

U/S OF ASSEMBLY - 7'-0"

U/S OF ASSEMBLY - 13'-9"

U/S OF ASSEMBLY - 9'-0"

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OF ARCHITECTS Z
SHAWN JAMES LAWRENCE
LICENCE
4442
4442
4442

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03 2022.11.01 ISSUED FOR COORDINATION
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CARRUTHERS AVENUE
DEVELOPMENT
266-268 CARRUTHERS AVENUE, OTTAWA, ON

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18 DEAKIN STREET SUITE 205 OTTAWA, ONTARIO K2E 8B7

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SHEET TITLE:

REFLECTED CEILING PLANS


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PLOT DATE: 2022-11-07 11:46:52 AM JOB NUMBER: SL-1077-22

A3.1

SCALE: As indicated

INCORPORATED



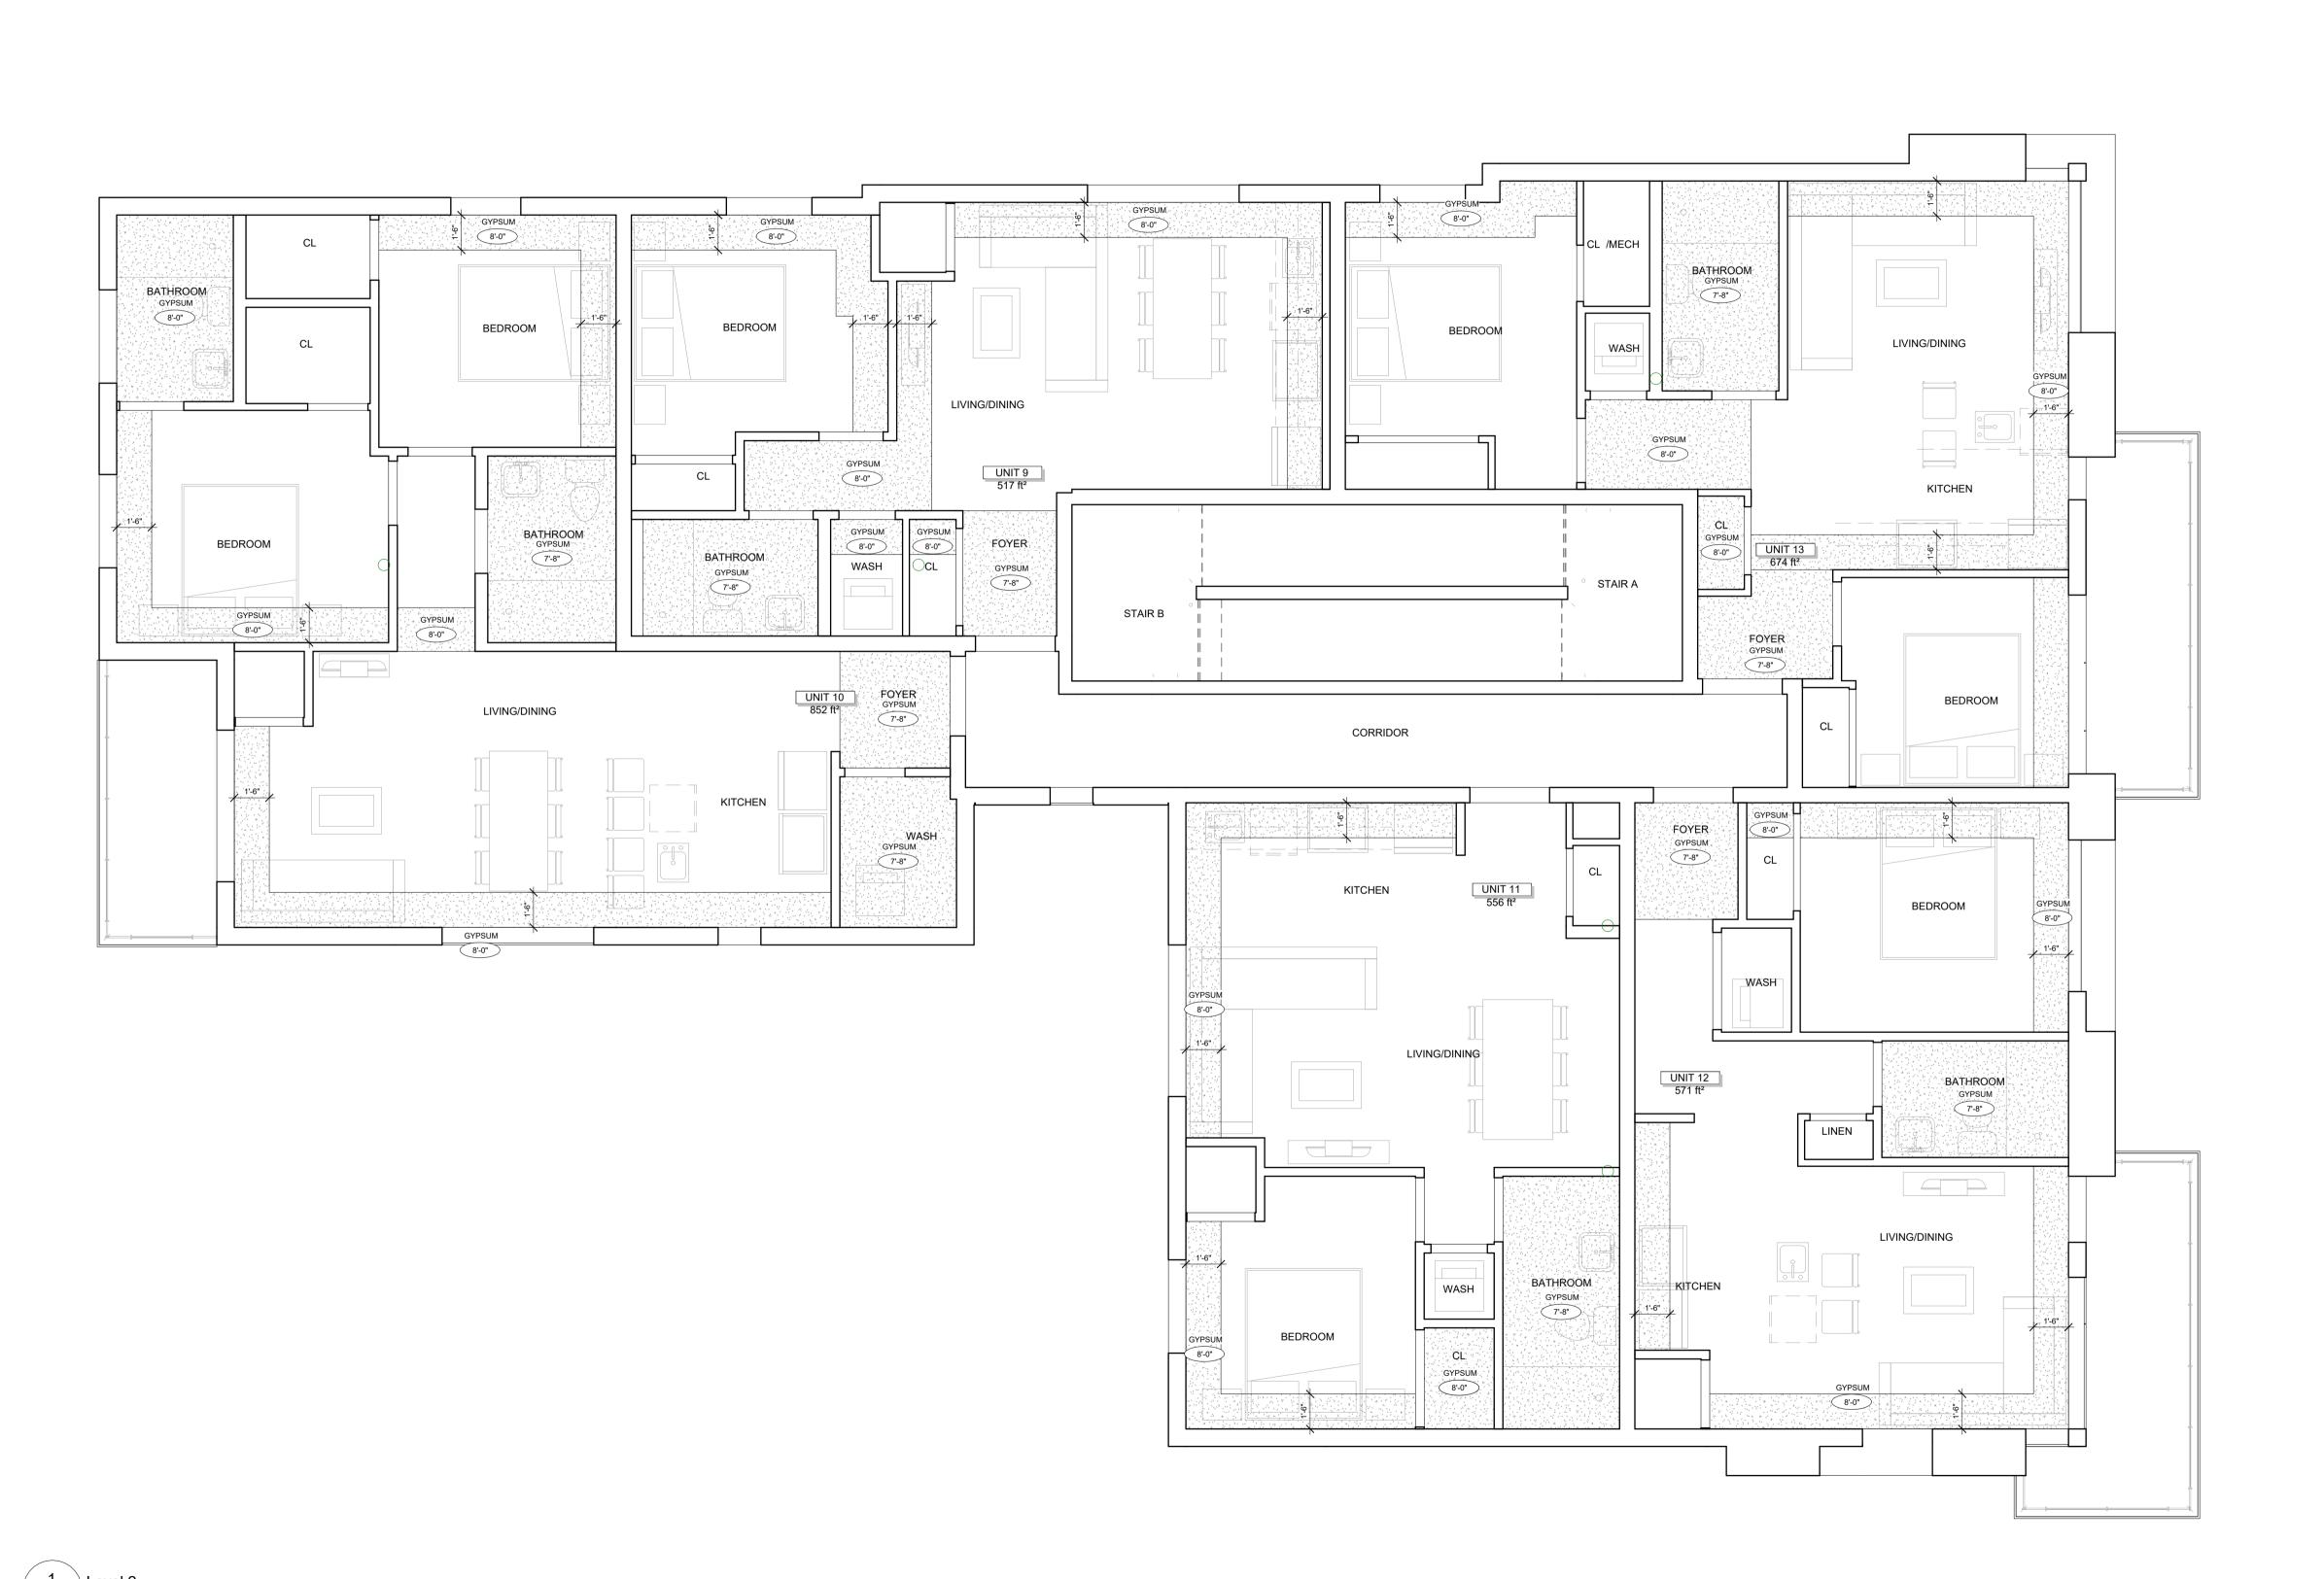

NOTES:

CEILING LEGEND

BULKHEAD

U/S OF ASSEMBLY - 7'-0"

U/S OF ASSEMBLY - 13'-9"

U/S OF ASSEMBLY - 9'-0"

- REFER TO RCP FOR HEIGHT

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A3.2

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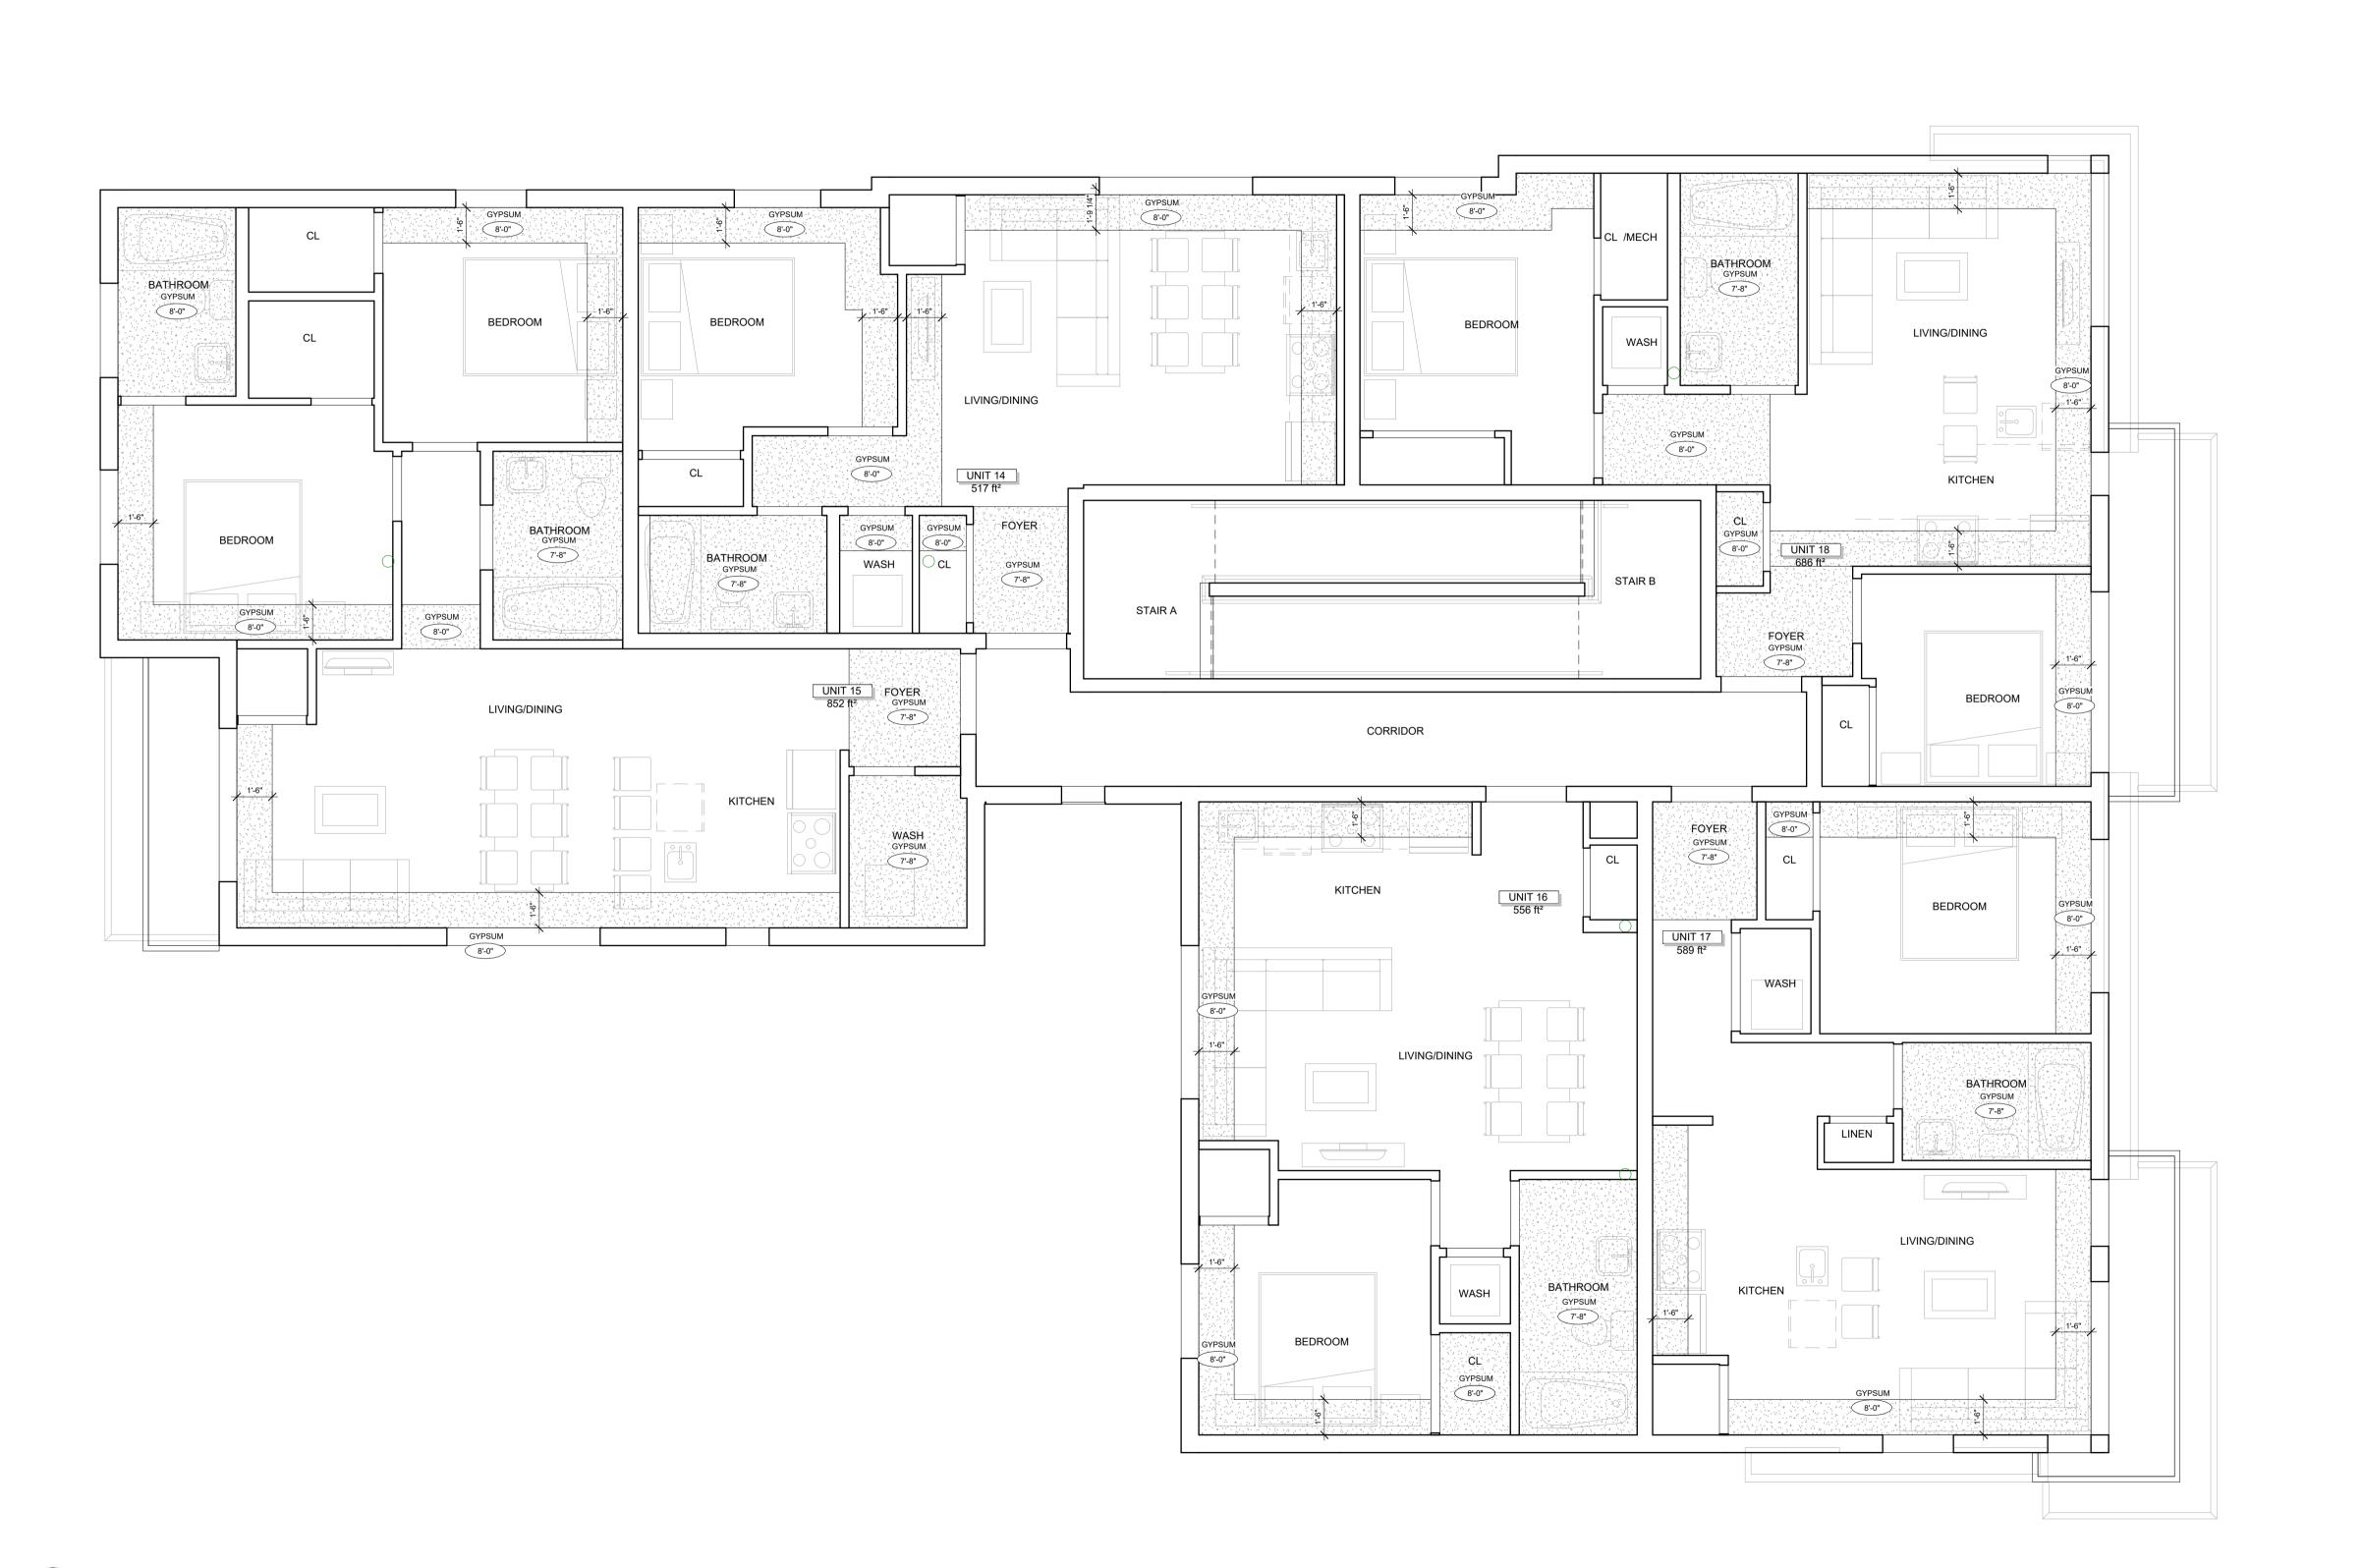
CARRUTHERS AVENUE

DEVELOPMENT
266-268 CARRUTHERS AVENUE, OTTAWA, ON

PLOT DATE: 2022-11-07 11:46:54 AM

JOB NUMBER: **SL-1077-22**

REFLECTED CEILING PLANS



THEBERGE HOMES

NOTES:

CEILING LEGEND

BULKHEAD

U/S OF ASSEMBLY - 7'-0"

U/S OF ASSEMBLY - 13'-9"

U/S OF ASSEMBLY - 9'-0"

- REFER TO RCP FOR HEIGHT


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A3.3

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INCORPORATED

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CARRUTHERS AVENUE


DEVELOPMENT
266-268 CARRUTHERS AVENUE, OTTAWA, ON


PLOT DATE: 2022-11-07 11:46:56 AM

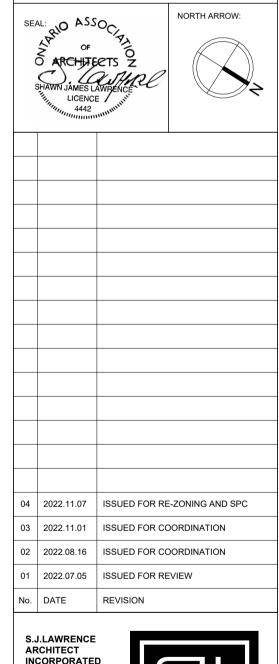JOB NUMBER: **SL-1077-22**

REFLECTED CEILING PLANS



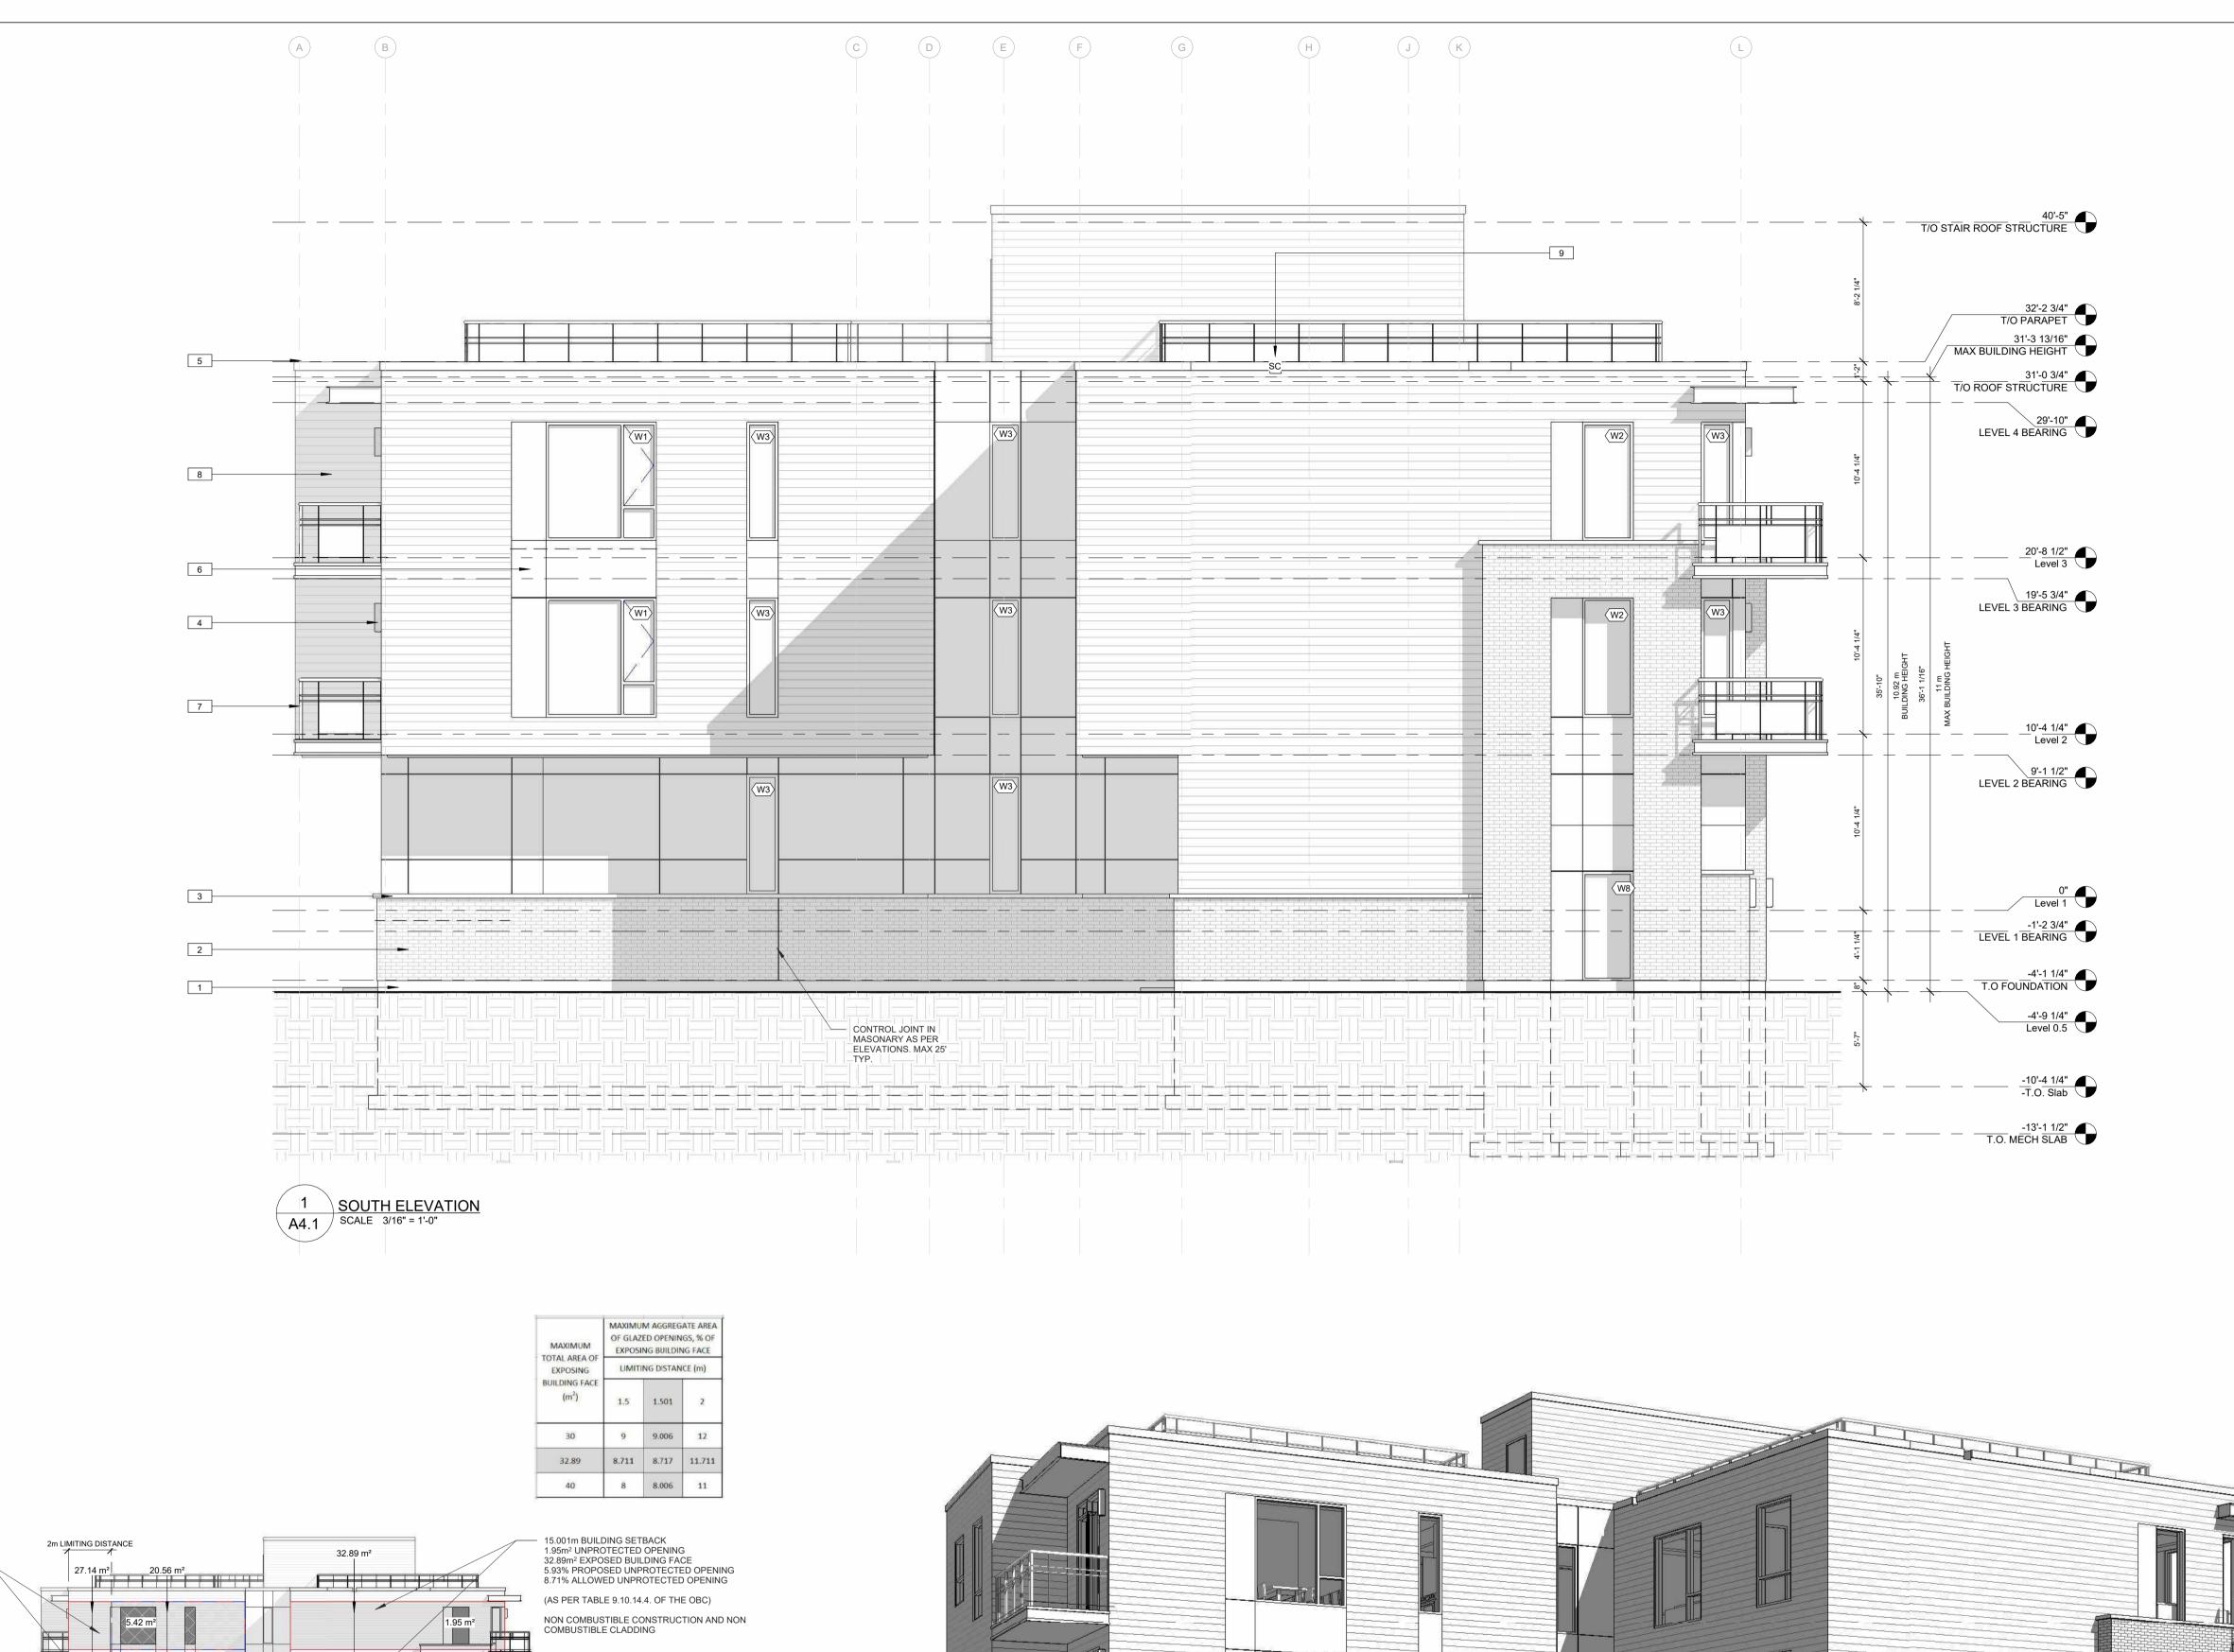

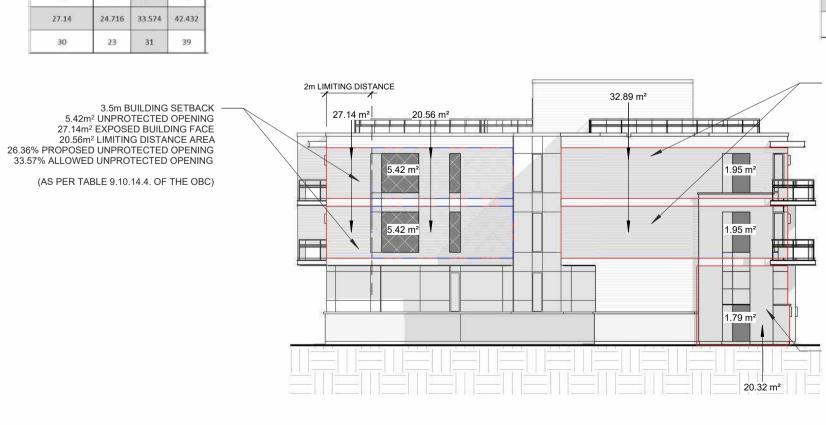

MAXIMUM AGGREGATE AREA

TOTAL AREA OF EXPOSING BUILDING FACE

(m²)

EXPOSING LIMITING DISTANCE (m) BUILDING FACE

25 26 35.5 45

OF GLAZED OPENINGS, % OF

2 SOUTH ELEVATION LIMITING DISTANCE CALCS
A4.1 SCALE 1: 200

1.501m BUILDING SETBACK 1.79m² UNPROTECTED OPENING 20.32m² EXPOSED BUILDING FACE 8.81% PROPOSED UNPROTECTED OPENING
9.93% ALLOWED UNPROTECTED OPENING (AS PER TABLE 9.10.14.4. OF THE OBC) NON COMBUSTIBLE CONSTRUCTION AND NON COMBUSTIBLE CLADDING Transcription of the property of the property

MAXIMUM FOTAL AREA OF	MAXIMUM AGGREGATE AREA OF GLAZED OPENINGS, % OF EXPOSING BUILDING FACE						
EXPOSING	LIMIT	LIMITING DISTANCE (m)					
(m ²)	1,5	1.501	3				
20	10	10.0033	15				
20.32	9.936	9,93929	14.872				
25	9	9.00267	13				



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	KEYNOTES-ELEVATION
NOTE NUMBER	NOTE TEXT
1	CEMENT PARGING ON ALL EXPOSED FOUNDATION TO 8" BELOW GRADE
2	STONE VENEER A
3	4" PRECAST CONCRETE SILL
4	WALL SCONCE
5	PRE-FINISHED METAL FASCIA
6	FIBER CEMENT COMPOSITE PANEL - COLOUR TBD BY OWNER
7	PRE-FINISHED METAL GUARD RAIL (3'-6" TALL)
8	FIBER CEMENT LAP SIDING - COLOUR TBD BY OWNER
9	OVERFLOW SCUPPER, REFER TO ROOF PLAN



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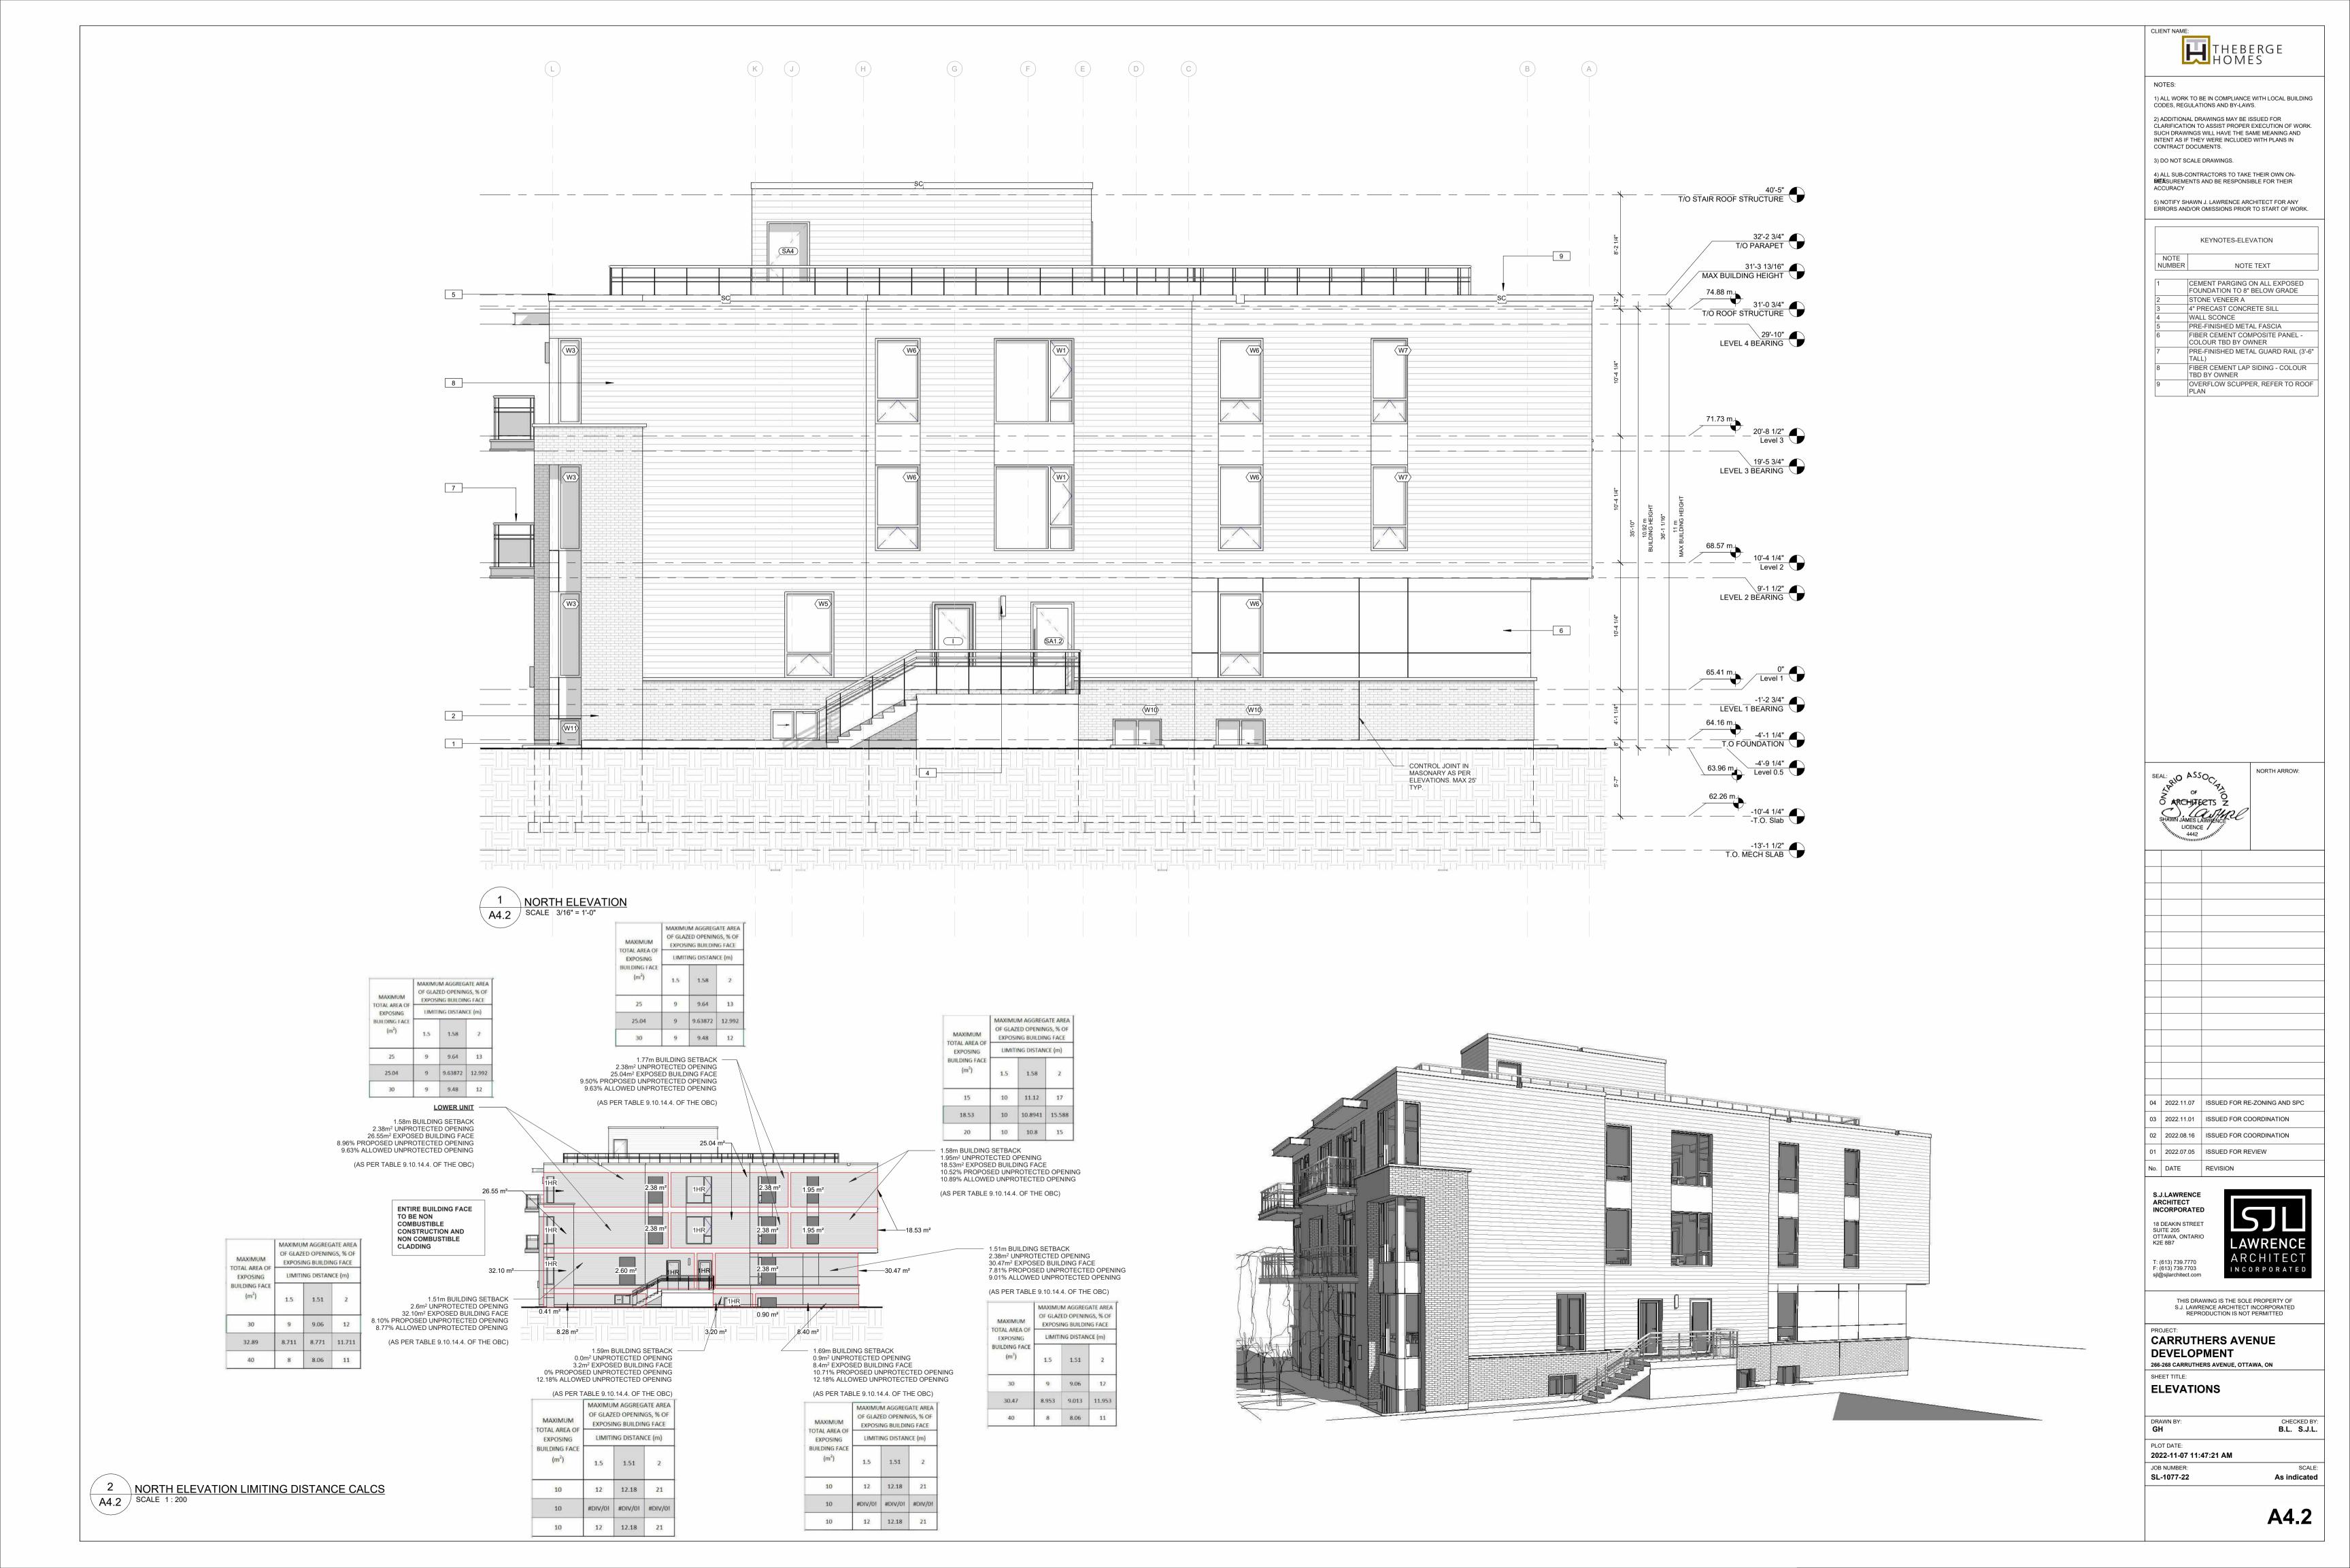
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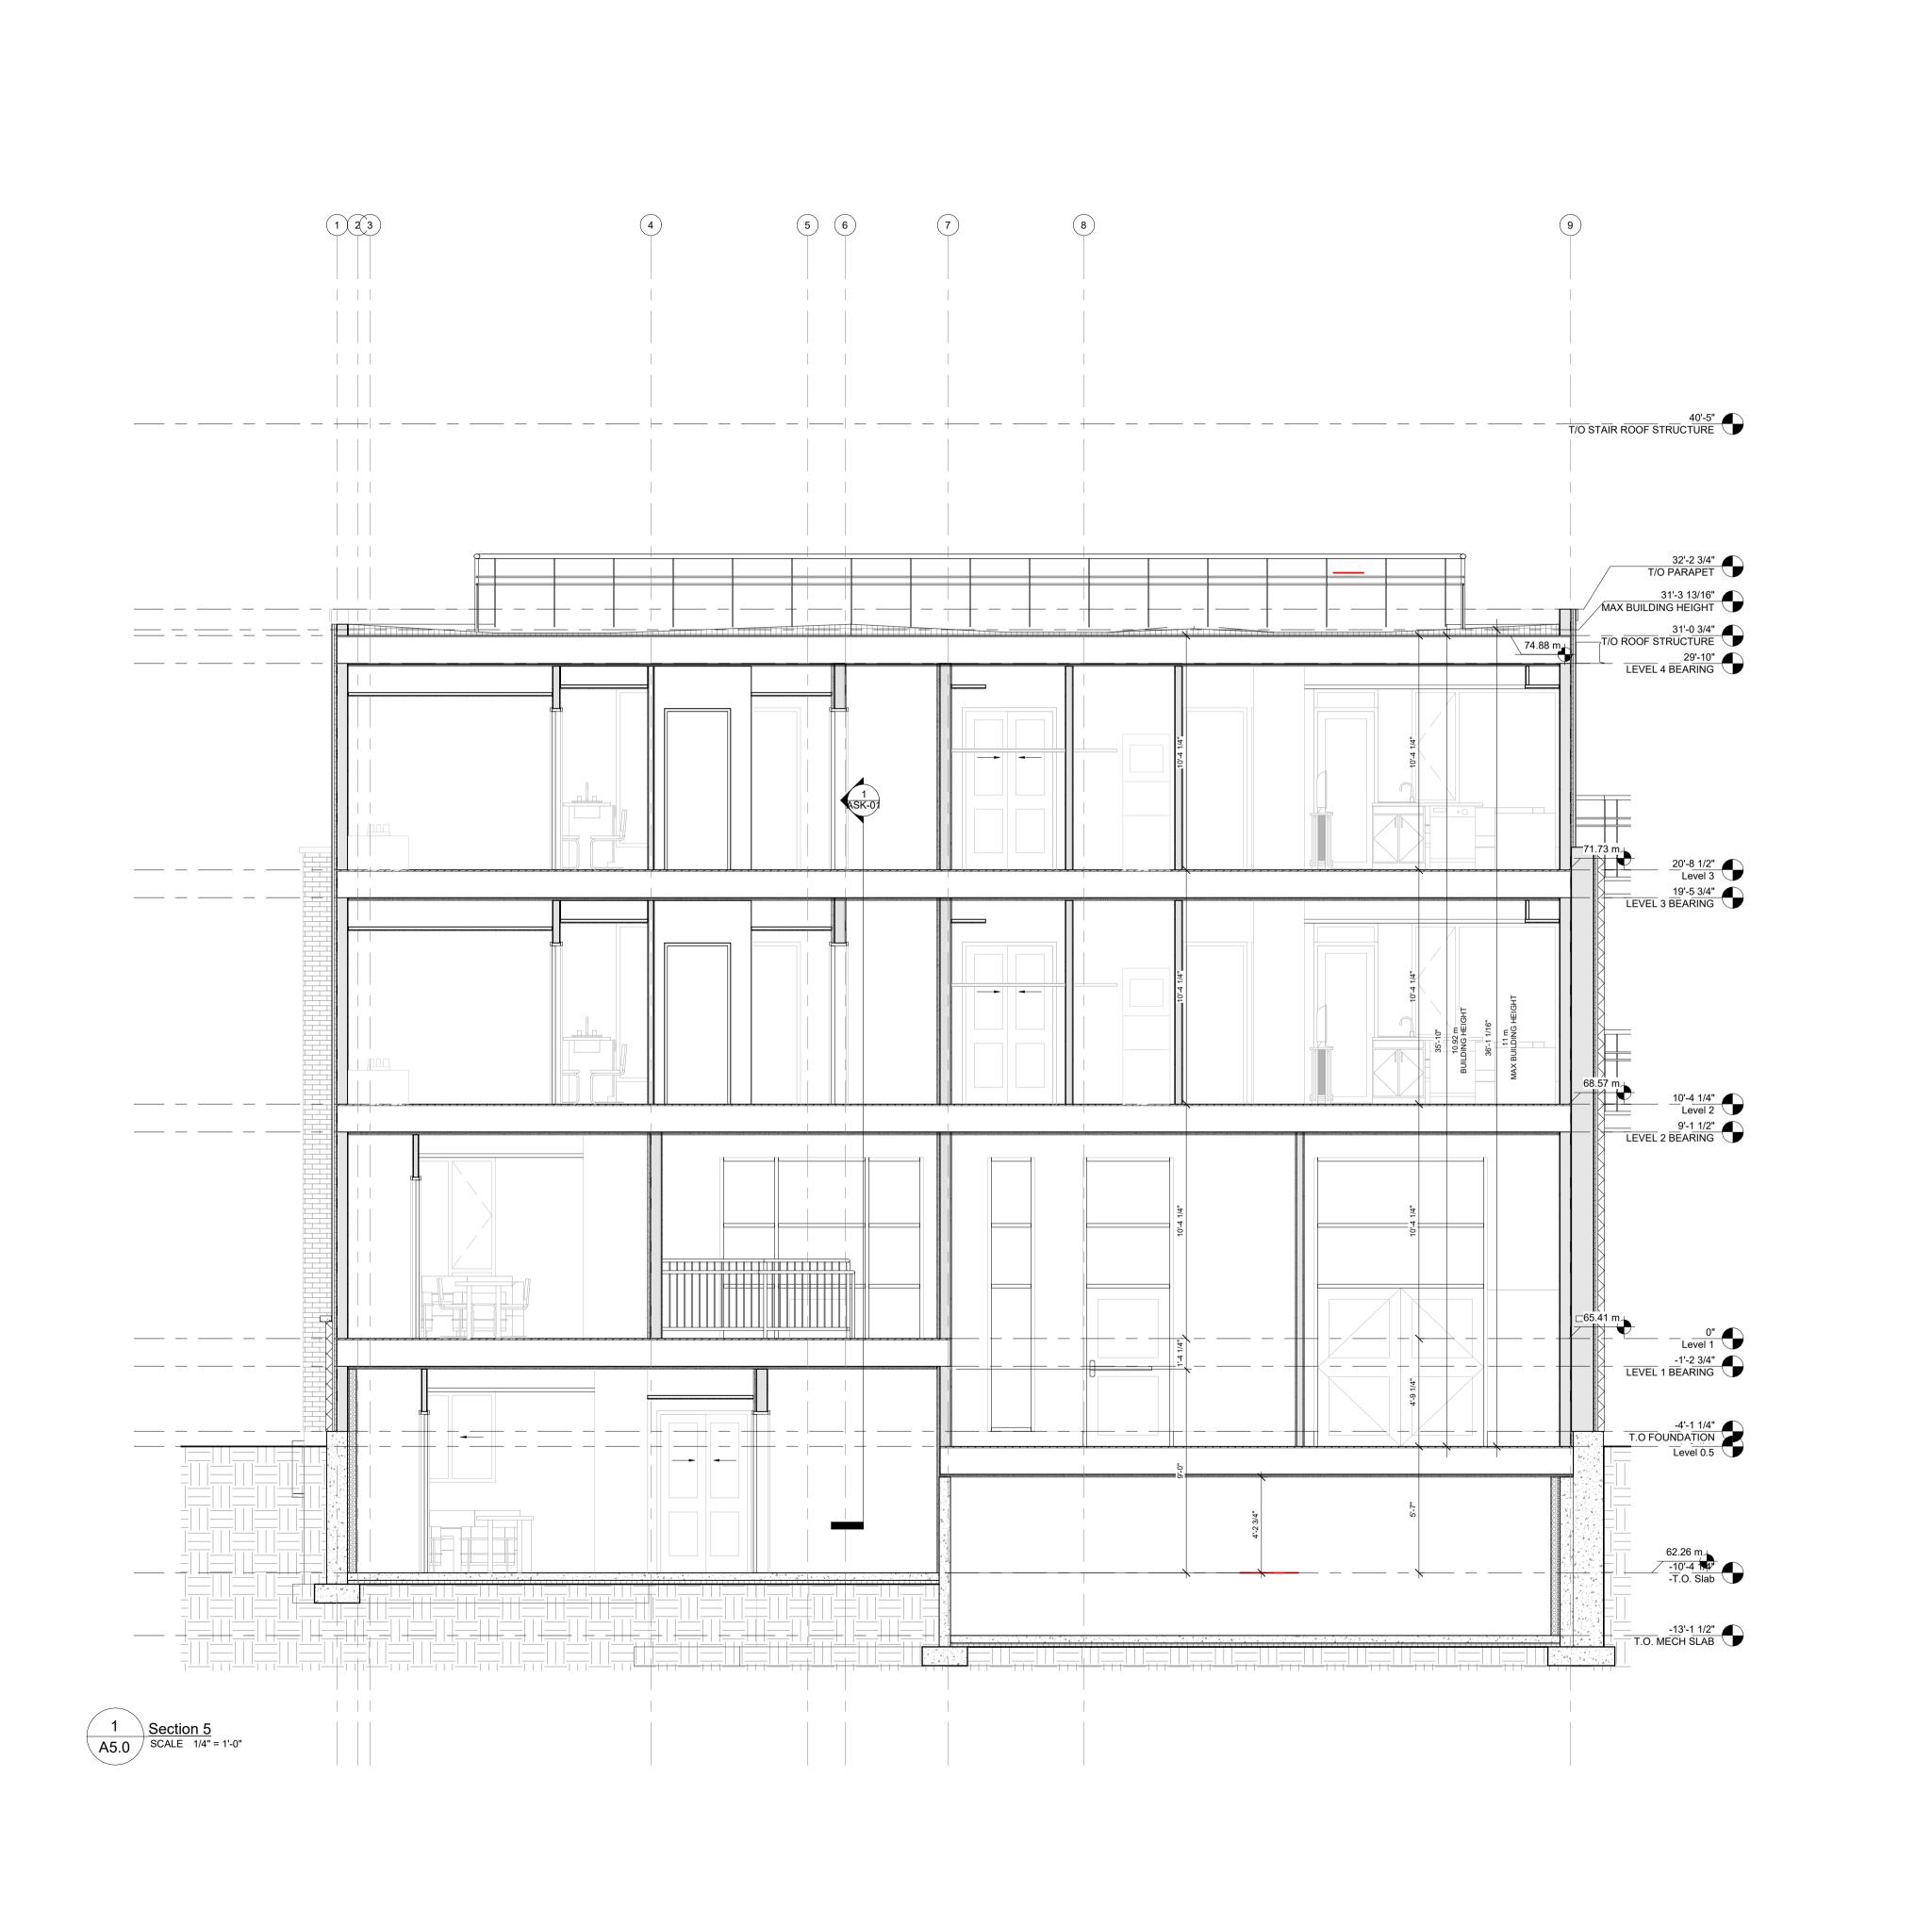
CARRUTHERS AVENUE DEVELOPMENT

266-268 CARRUTHERS AVENUE, OTTAWA, ON SHEET TITLE: **ELEVATIONS**

DRAWN BY: CHECKED BY: **B.L. S.J.L.** PLOT DATE: 2022-11-07 11:47:13 AM JOB NUMBER: SCALE: SL-1077-22 As indicated

A4.1





THEBERGE

1) ALL WORK TO BE IN COMPLIANCE WITH LOCAL BUILDING CODES, REGULATIONS AND BY-LAWS. 2) ADDITIONAL DRAWINGS MAY BE ISSUED FOR CLARIFICATION TO ASSIST PROPER EXECUTION OF WORK. SUCH DRAWINGS WILL HAVE THE SAME MEANING AND INTENT AS IF THEY WERE INCLUDED WITH PLANS IN

5) NOTIFY SHAWN J. LAWRENCE ARCHITECT FOR ANY ERRORS AND/OR OMISSIONS PRIOR TO START OF WORK.

3) DO NOT SCALE DRAWINGS. 4) ALL SUB-CONTRACTORS TO TAKE THEIR OWN ON-MEASUREMENTS AND BE RESPONSIBLE FOR THEIR ACCURACY

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NORTH ARROW:

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DEVELOPMENT
266-268 CARRUTHERS AVENUE, OTTAWA, ON

CARRUTHERS AVENUE


BUILDING SECTIONS

PLOT DATE: 2022-11-07 11:47:22 AM JOB NUMBER: **SL-1077-22**


A5.0


CHECKED BY: B.L. S.J.L.

SCALE: 1/4" = 1'-0"

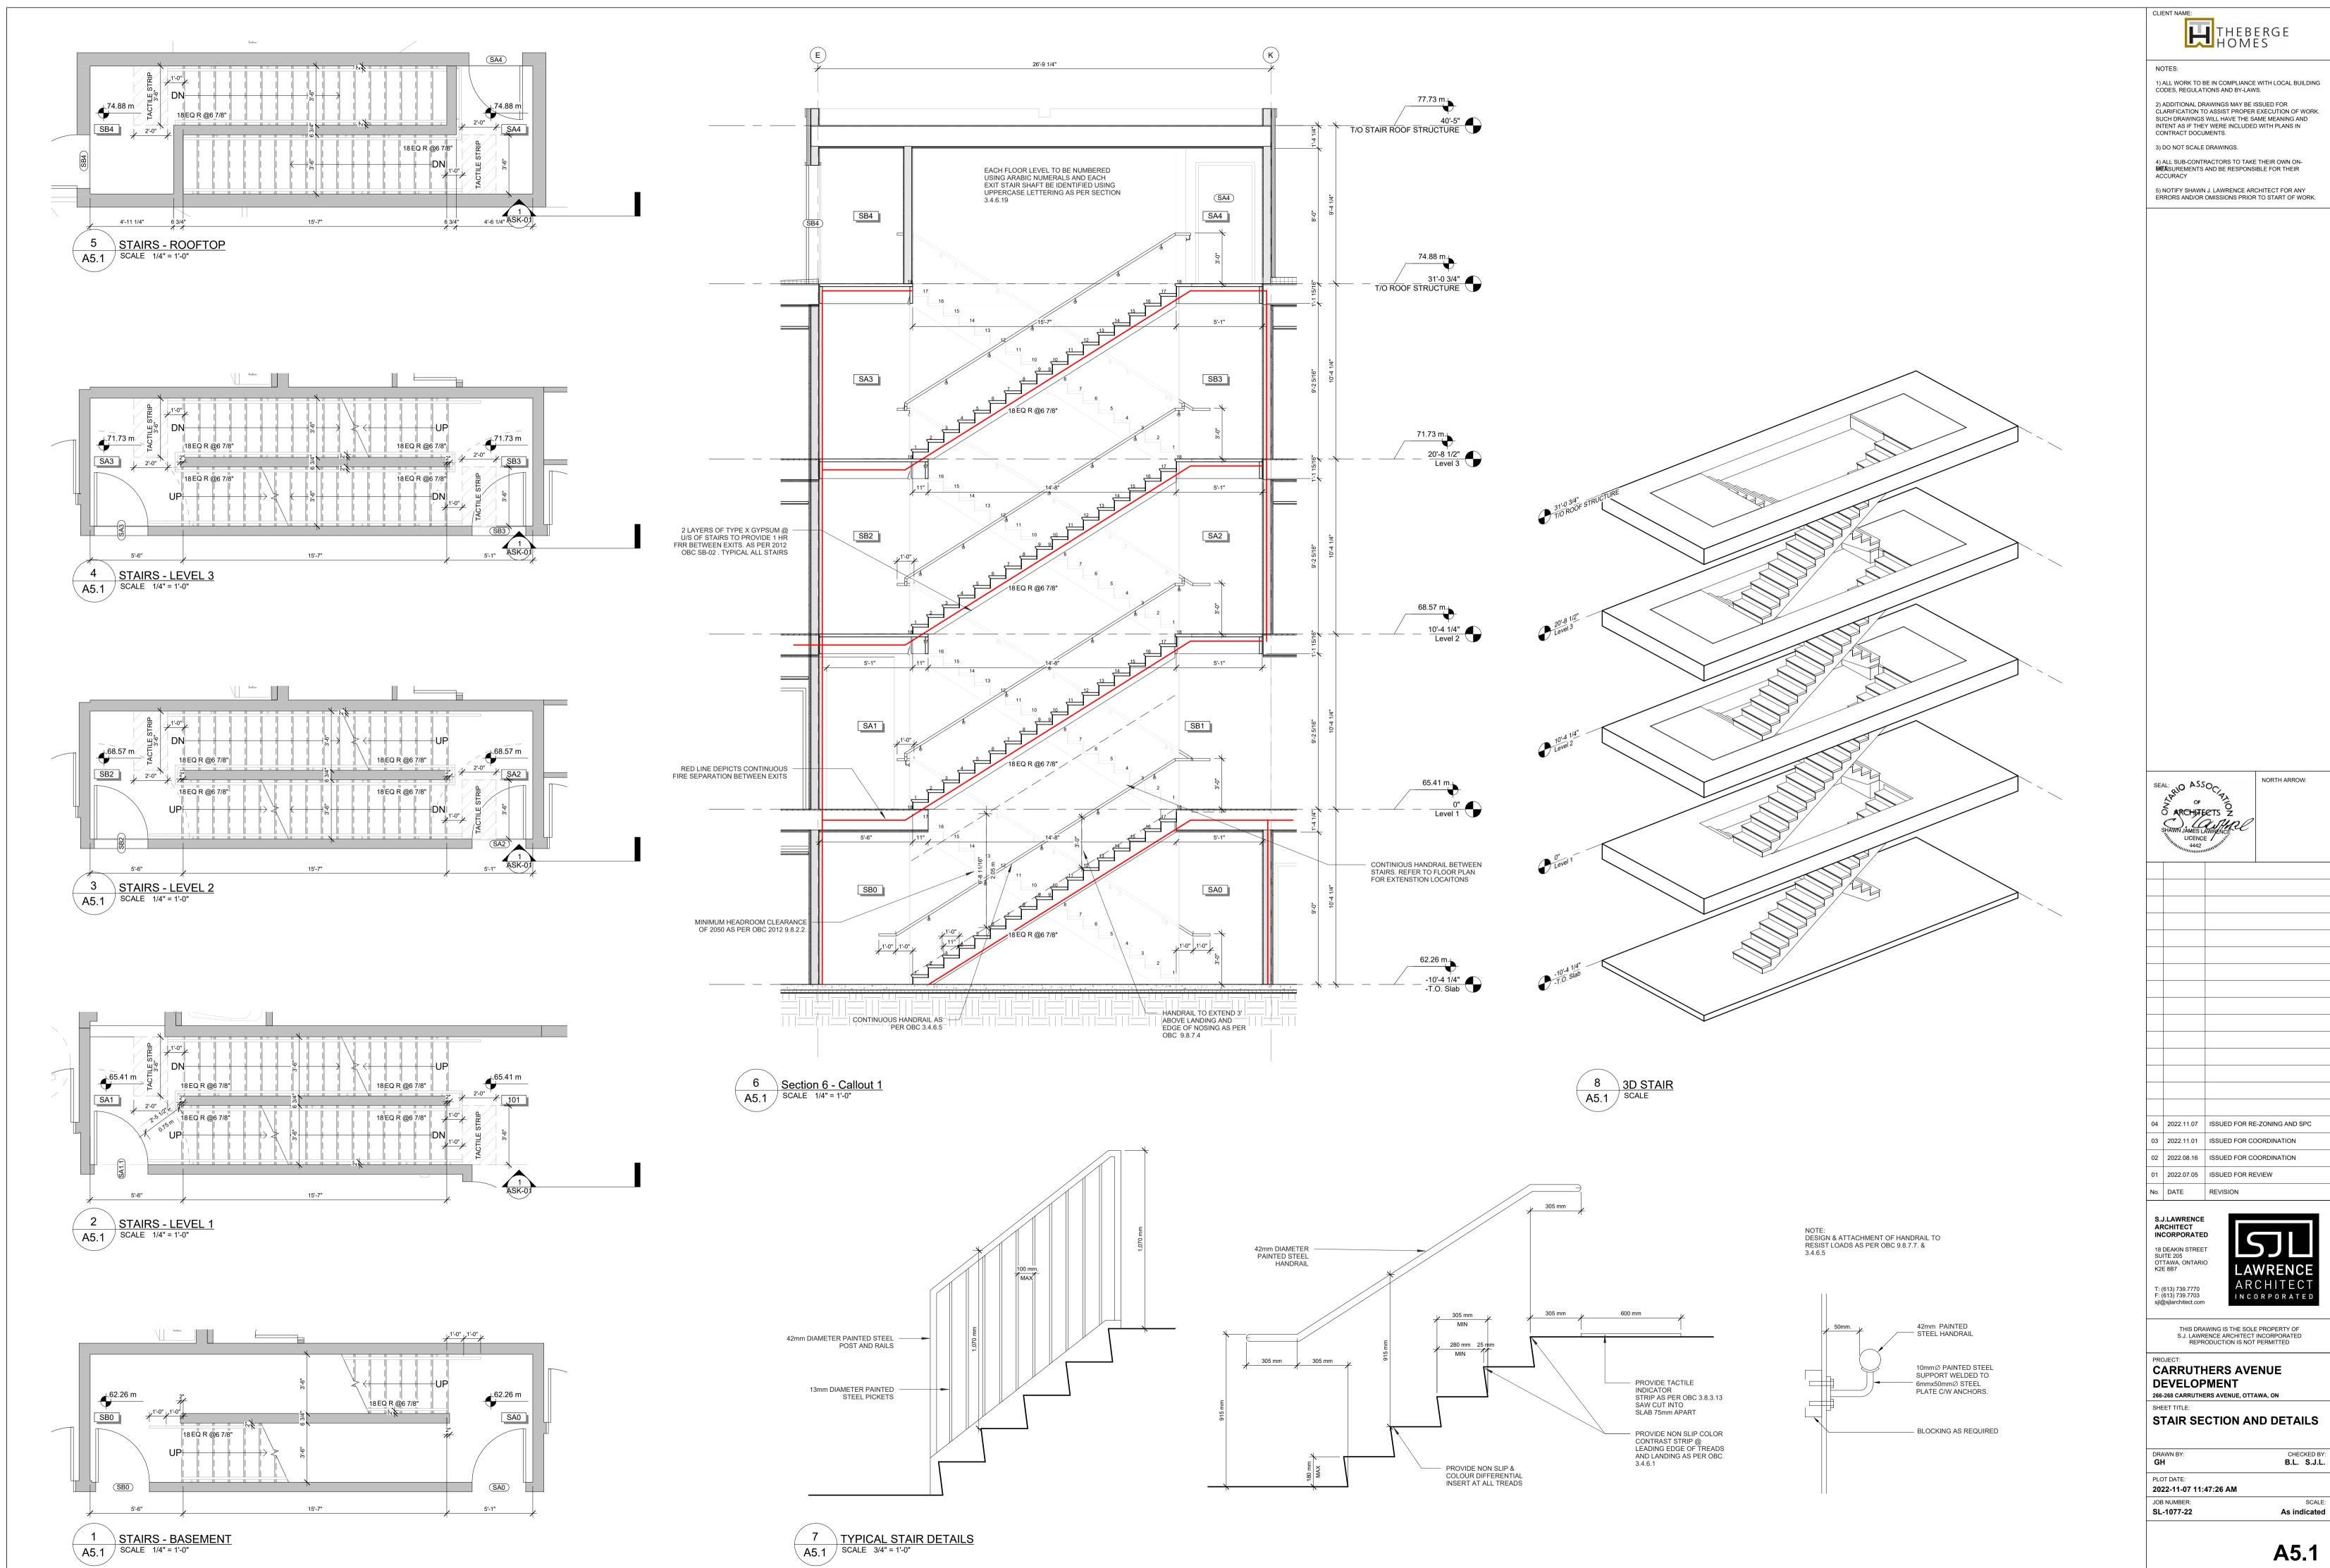


CHECKED BY: B.L. S.J.L.

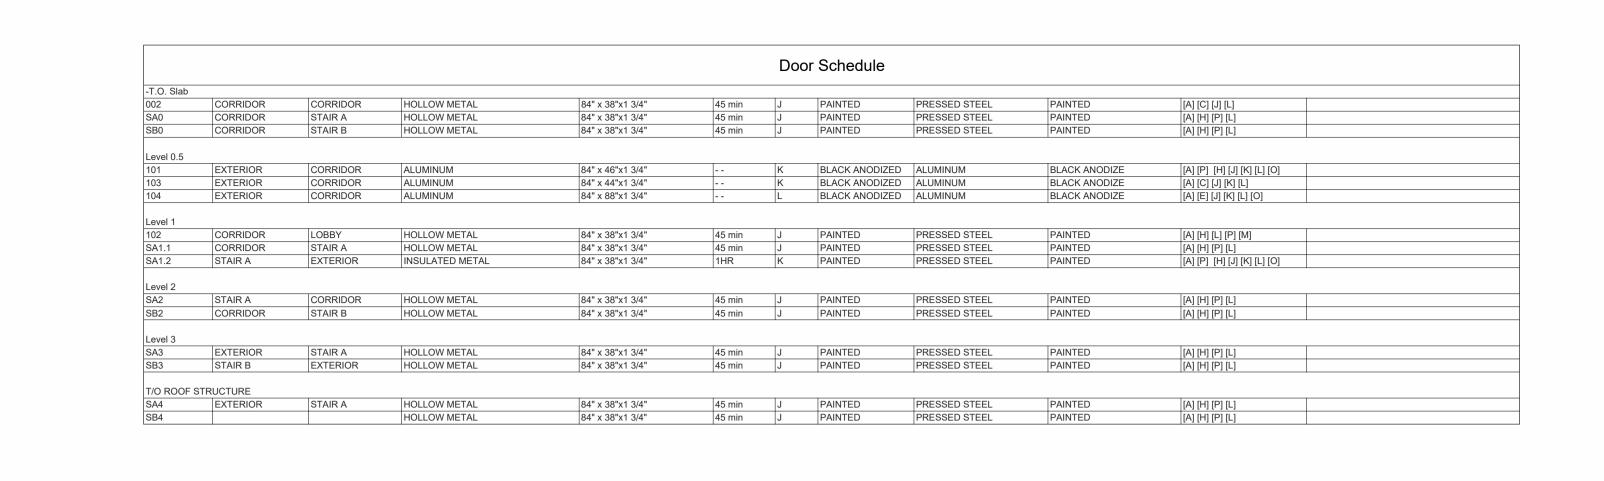

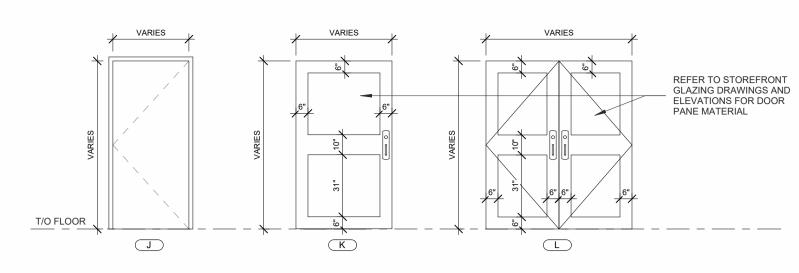



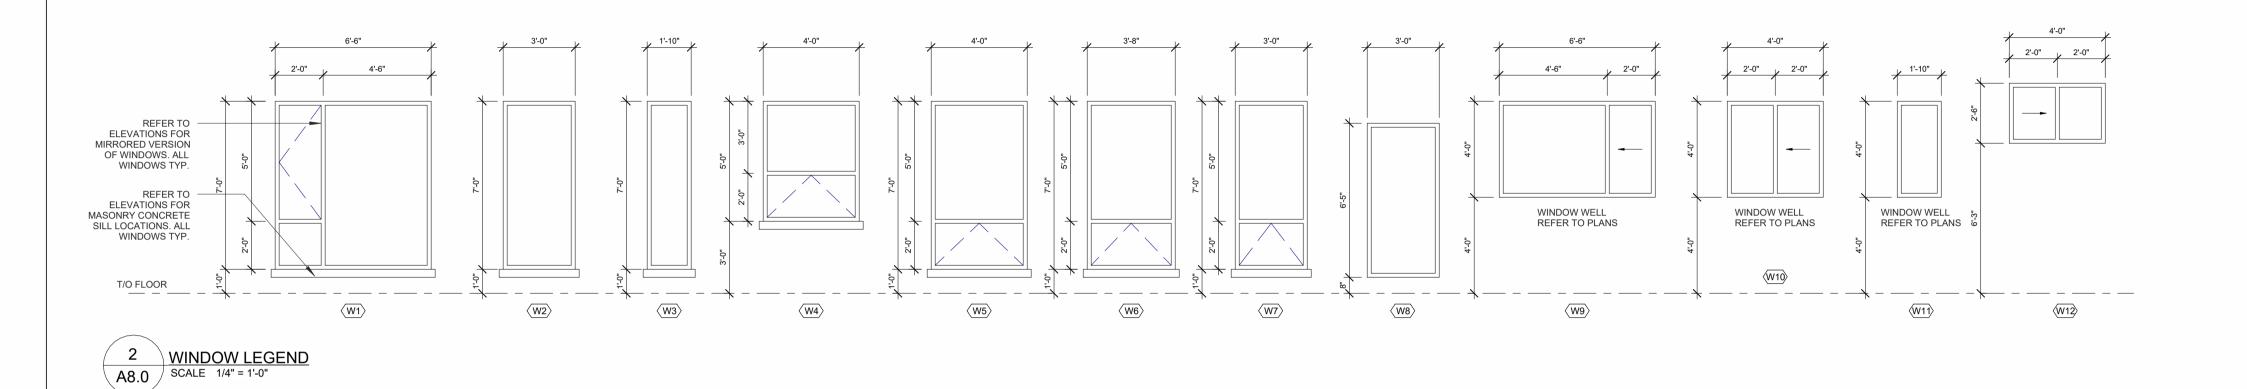

NOTES:

= INSULATED SPANDREL PANEL = GLAZING = FIRE RATED GLASS "FIRELITE" = GEORGIAN WIRE GLASS = TEMPERED GLASS = FROSTED GLASS GWG TG

** REFER TO ELEVATIONS FOR FROSTED GLASS LOCATION AND OPERATOR DIRECTION FOR WALL WINDOWS AND DOORS

GENERAL NOTES:

 - ALL EXTERIOR WINDOW/DOOR FRAMES TO BE TIED INTO CONTINUOUS AIR BARRIER
AS INDICATED ON THE ARCHITECTURAL DETAILS.

 - ALL WINDOW AND DOOR FRAMES TO HAVE GYPSUM BOARD RETURNS U/N - ALL INTERIOR / EXTERIOR FRAMES TO BE CAULKED TO ADJACENT MATERIALS USING APPROPRIATE CAULKING AS INDICATED IN DETAILS [A] - HINGES

[C] - LOCKSET

[D] - PRIVACY SET

[E] - PASSAGE SET

[G] - FLUSH BOLT

[K] - THRESHOLD

[L] - SELF CLOSER

[N] - ROLLER CATCH

[H] - PULL

[I] - PUSH

[O] - FOB [P] - PANIC BAR

[F] - DUMMY SET/BALL CATCH

[J] - WEATHER STRIPPING

[M] - PUSH BUTTON / ELEC. OPERATOR

[B] - DEADBOLT LOCK

GENERAL WINDOW NOTES

- 1. ALL WINDOWS BLACK ALUMINUM
 2. ALL SIDE LIGHTS SAME AS ADJACENT DOOR MATERIAL
 3. NO BRICK MOULDING FOR BASEMENT WINDOWS
 4. SEE ELEVATIONS FOR OPERABLE DIRECTION
 5. ALL WINDOWS TO BE RESIST FORCED ENTRY AS PER O.B.C. 9.7.6
 6. ALL WINDOWS/ SLIDING GLASS DOORS SHALL HAVE A MAXIMUM U-VALUE OF 1.4

- OF 1.4

 CONFIRM ROUGH OPENING WITH MANUFACTURER

 ALL OPERABLE WINDOWS WITH A SILL HEIGHT GREATER THAN 480mm TO BE INSTALLED WITH A MECHANISM THAT WILL LIMIT THE OPENING TO LESS THAN 100mm, IN ACCORDANCE WITH OBC 2012 9.8.8

 SITE MEASURE WINDOW SCREENS TO CONFIRM OVERALL DIMENSIONS

GENERAL DOOR NOTES


- 1. ALL EXT. DOORS TO RESIST FORCED ENTRY AS PER OBC 9.6.8

- 2. THERMAL RESISTANCE FOR EXT. DOORS TO BE NOT LESS THAN R4 AS PER SB-12 2.1.19 (1)

 3. ALL EXTERIOR DOORS TO BE WEATHER-STRIPPED

 4. CONFIRM ROUGH OPENING WITH MANUFACTURER

T/O FLOOR	38"	30"	36"	28"	72"	58"	46"	32"	28"	38" DOOR SIZE 72" OPENING SIZE 38" A B B B B B B B B B B B B B B B B B B	92"	8.0"	30"	38"
	A1	B1	B2		C1	C2	<u>C3</u>	D2	E	F	G	H1	H2	
/ 3	SUITE DOOPS													

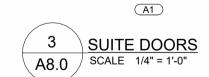

88"	44"	25"	108"	
			31" 46" 31"	7
GL GL	GL	GL	GL GL G	
88 F.	GL	GL	GL GI	-
GL	FR	FR	GL GL G	
GL 104 GL	FR (103)		GL (101)	
W13	W14	₩15	(W16)	4'-9 1/4" Level 0.5

	Fire		DOOR		FF	RAME		
Door Type	Rating	SIZE (WxHxT)	Description	DOOR FINISH	Frame Type	FRAME FINISH	NOTES	DOOR HARDWARE
A 4	00!	000 040 4 750	METAL	DDE EINIOUED	DDECOED OTEE	DAINITED		[A] [D] [E] [[] [
A1	20 min	38" x 84" x 1.75"	METAL	PRE-FINISHED	PRESSED STEEL	PAINTED		[A] [B] [E] [J] [L]
B1		30" x 84" x 1.75"	HOLLOW CORE WD	PAINTED/STAIN	TBD	PAINTED		[A] [D]
B2		36" x 84" x 1.75"	HOLLOW CORE WD	PAINTED/STAIN	TBD	PAINTED		[A] [D]
B3		28" x 84" x 1.75"	HOLLOW CORE WD	PAINTED/STAIN	TBD	PAINTED		[A] [D]
C1		72" x 84" x 1.75"	HOLLOW CORE WD. (x2) SLIDING	PAINTED/STAIN			DOUBLE SLIDING DOOR	SLIDING DOOR HARDWARE
C2		58" x 84" x 1.75"	HOLLOW CORE WD. (x2) SLIDING	PAINTED/STAIN			DOUBLE SLIDING DOOR	SLIDING DOOR HARDWARE
C3		46" x 84" x 1.75"	HOLLOW CORE WD. (x2) SLIDING	PAINTED/STAIN			DOUBLE SLIDING DOOR	SLIDING DOOR HARDWARE
D		26" x 84" x 1.75"	HOLLOW CORE WD	PAINTED/STAIN	TBD	PAINTED		[A] [F] [H]
D2		32" x 84" x 1.75"	HOLLOW CORE WD	PAINTED/STAIN	TBD	PAINTED		[A] [F] [H]
E		28" x 84" x 1.75"	HOLLOW CORE WD	PAINTED/STAIN	TBD	PAINTED		[A] [E]
F		38" x 84" x 1.00"	WOOD	STAINED			BARN DOOR	BARN DOOR HARDWARE
G		70" x 86" x 1.75"	INSULATED ALUMINUM	BLACK ANODIZED	INSULATED ALUMINUM	BLACK ANODIZED	SLIDING DOOR	SLIDING GLASS DORR HARDWARE
H1		30" x 84" x 1.75"	INSULATED ALUMINUM	BLACK ANODIZED	INSULATED ALUMINUM	BLACK ANODIZED		[A] [C] [J] [K]
H2		30" x 84" x 1.75"	INSULATED ALUMINUM	BLACK ANODIZED	INSULATED ALUMINUM	BLACK ANODIZED		[A] [C] [J] [K]
I	1HR	38" x 84" x 1.75"	INSULATED METAL	PRE-FINISHED	PRESSED STEEL	PAINTED		[A] [B] [E] [J] [K]

4 STORFRONT GLAZING - FRONT A8.0 SCALE 1/4" = 1'-0"

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NORTH ARROW: S ARCHITECTS Z SHAWN JAMES LAWRENCE LICENCE LICENCE 4442

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DEVELOPMENT 266-268 CARRUTHERS AVENUE, OTTAWA, ON

CARRUTHERS AVENUE

SHEET TITLE: BUILDING SCHEDULES

DRAWN BY: **GH**

CHECKED BY: **B.L. S.J.L.** PLOT DATE: 2022-11-07 11:47:31 AM JOB NUMBER: SL-1077-22 1/4" = 1'-0"

A8.0