178 NEPEAN STREET, 219/ 223 BANK STREET, OTTAWA, ONTARIO

LIST OF DRAWINGS				
DWG NO.	DWG TITLE	DATE		
	COVER SHEET	DECEMBER 2023		
C002	EXISTING CONDITIONS AND REMOVALS PLAN	DECEMBER 2023		
C100	SITE SERVICING PLAN	DECEMBER 2023		
C200	SITE GRADING PLAN	DECEMBER 2023		
C300	EROSION AND SEDIMENT CONTROL PLAN	DECEMBER 2023		
C400	STORMWATER MANAGEMENT PLAN	DECEMBER 2023		
C401	ROOF DRAINAGE PLAN	DECEMBER 2023		


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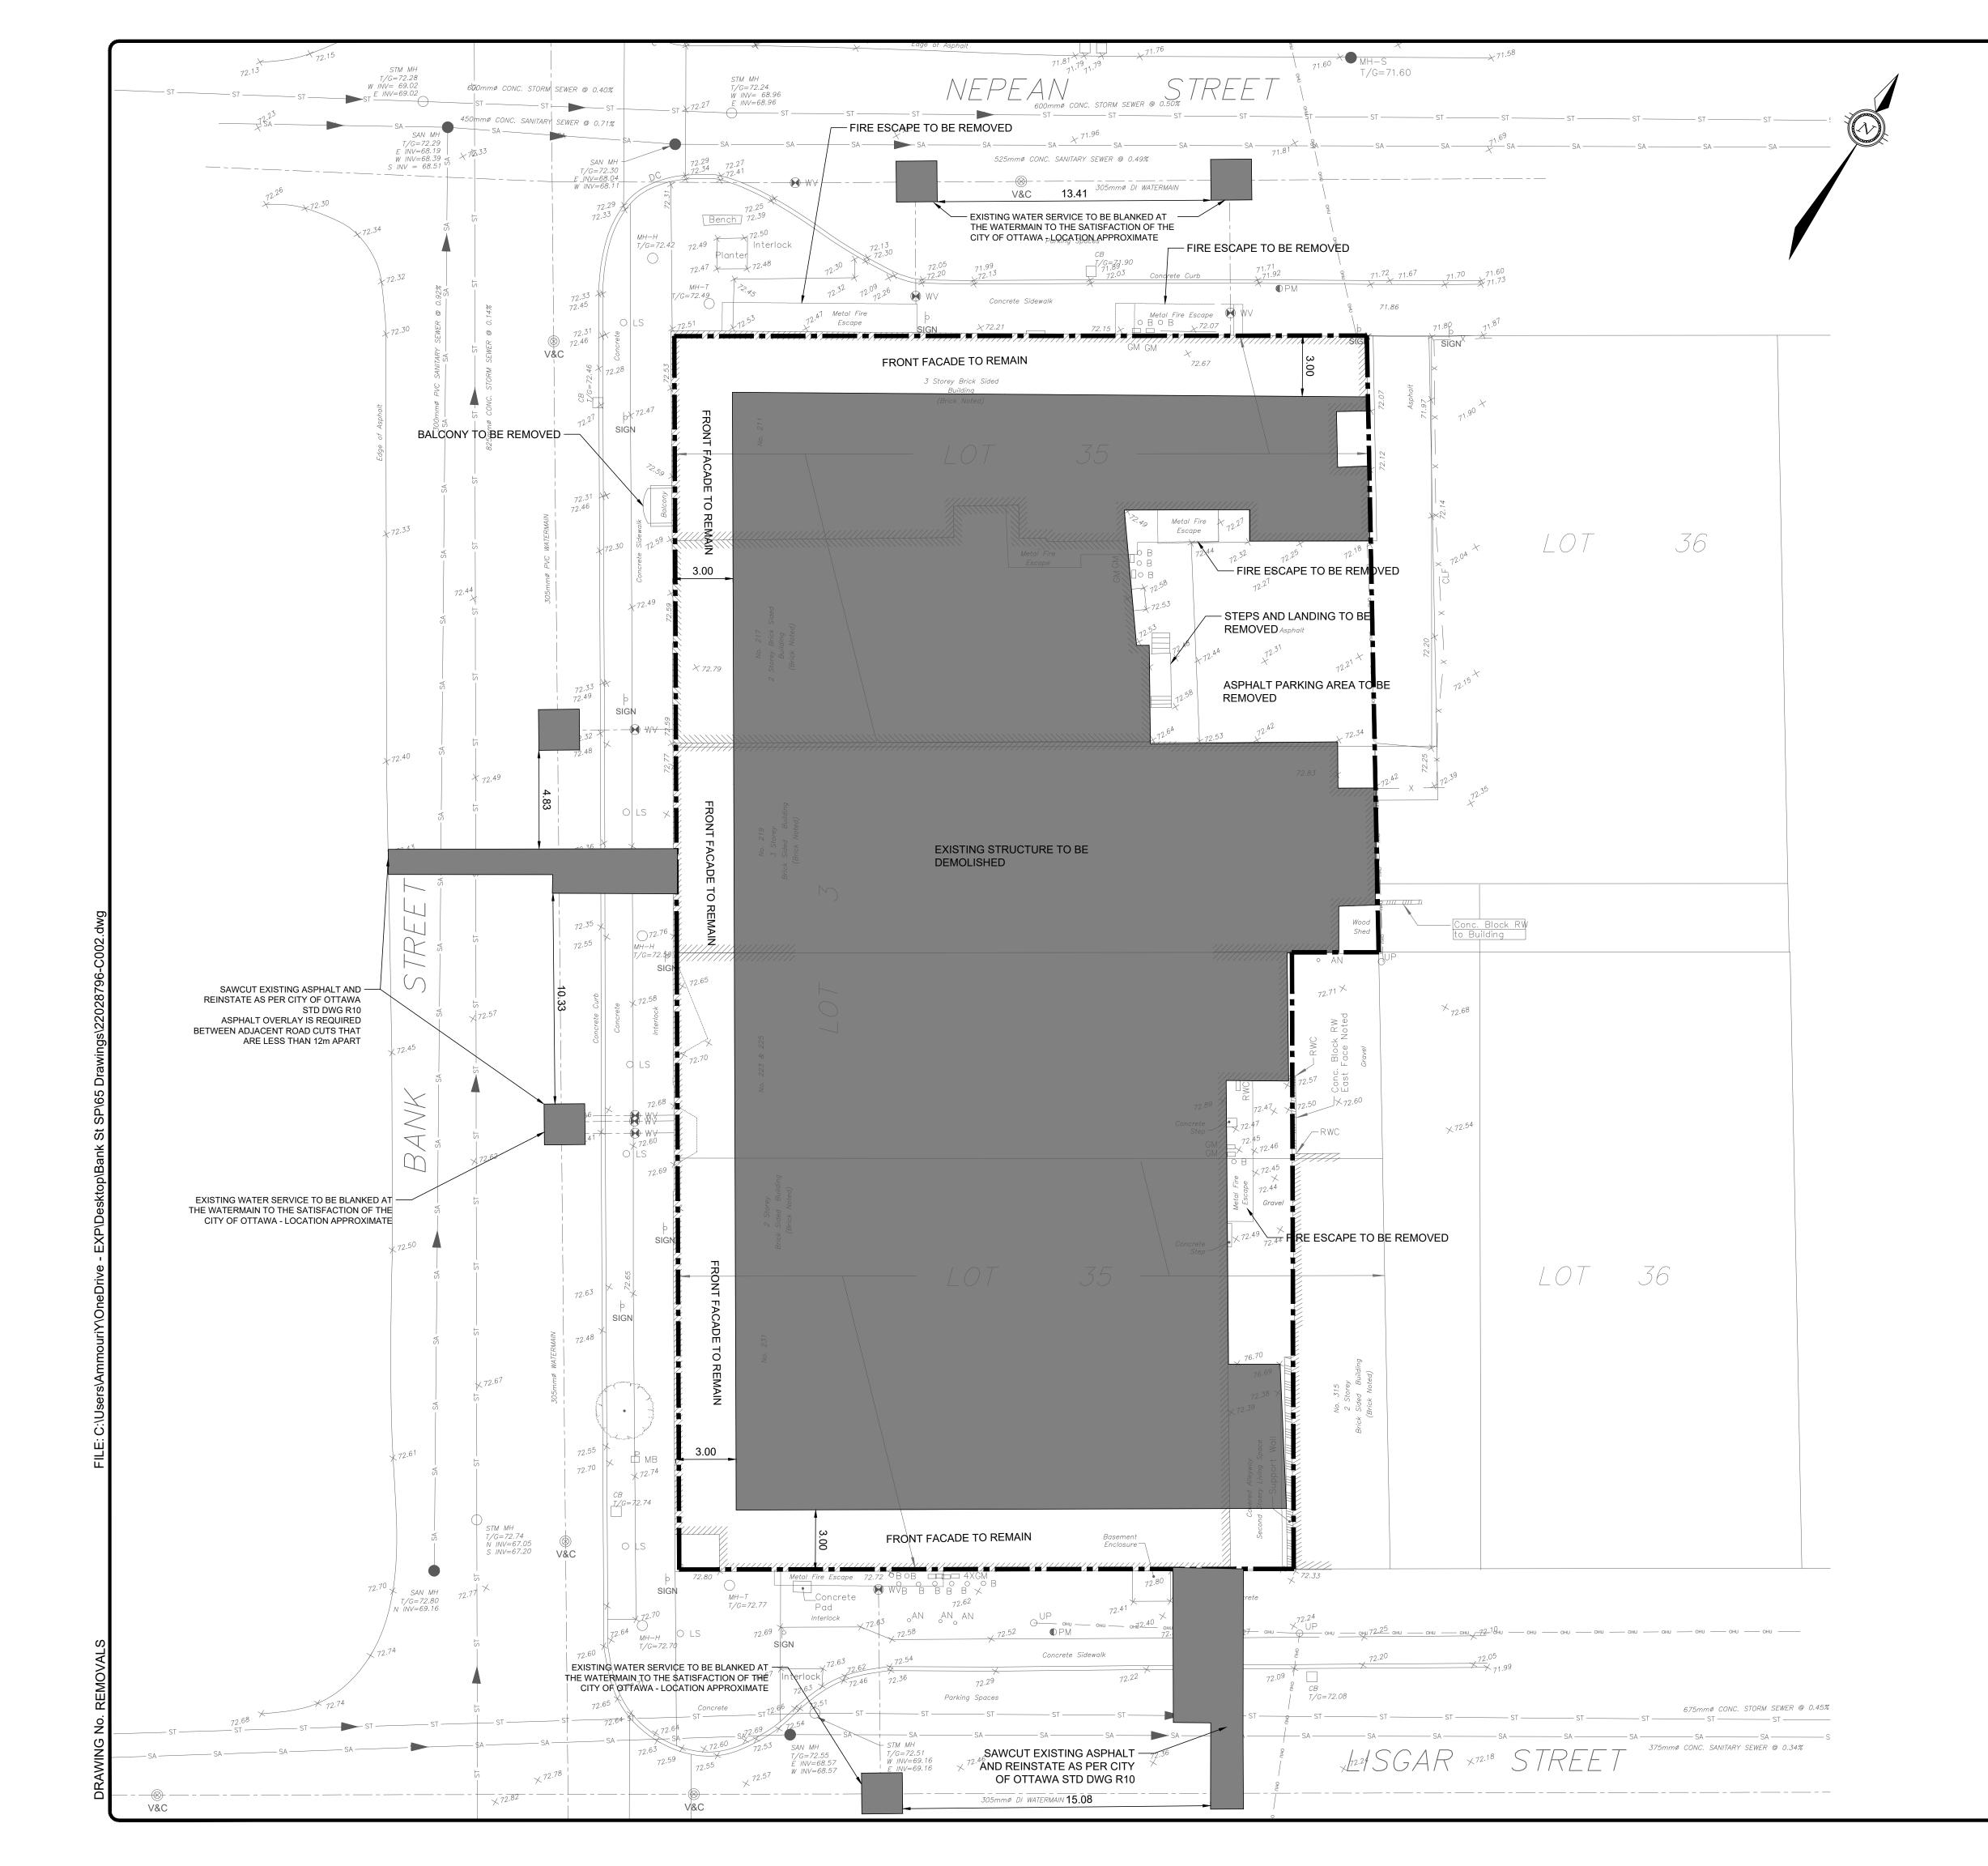
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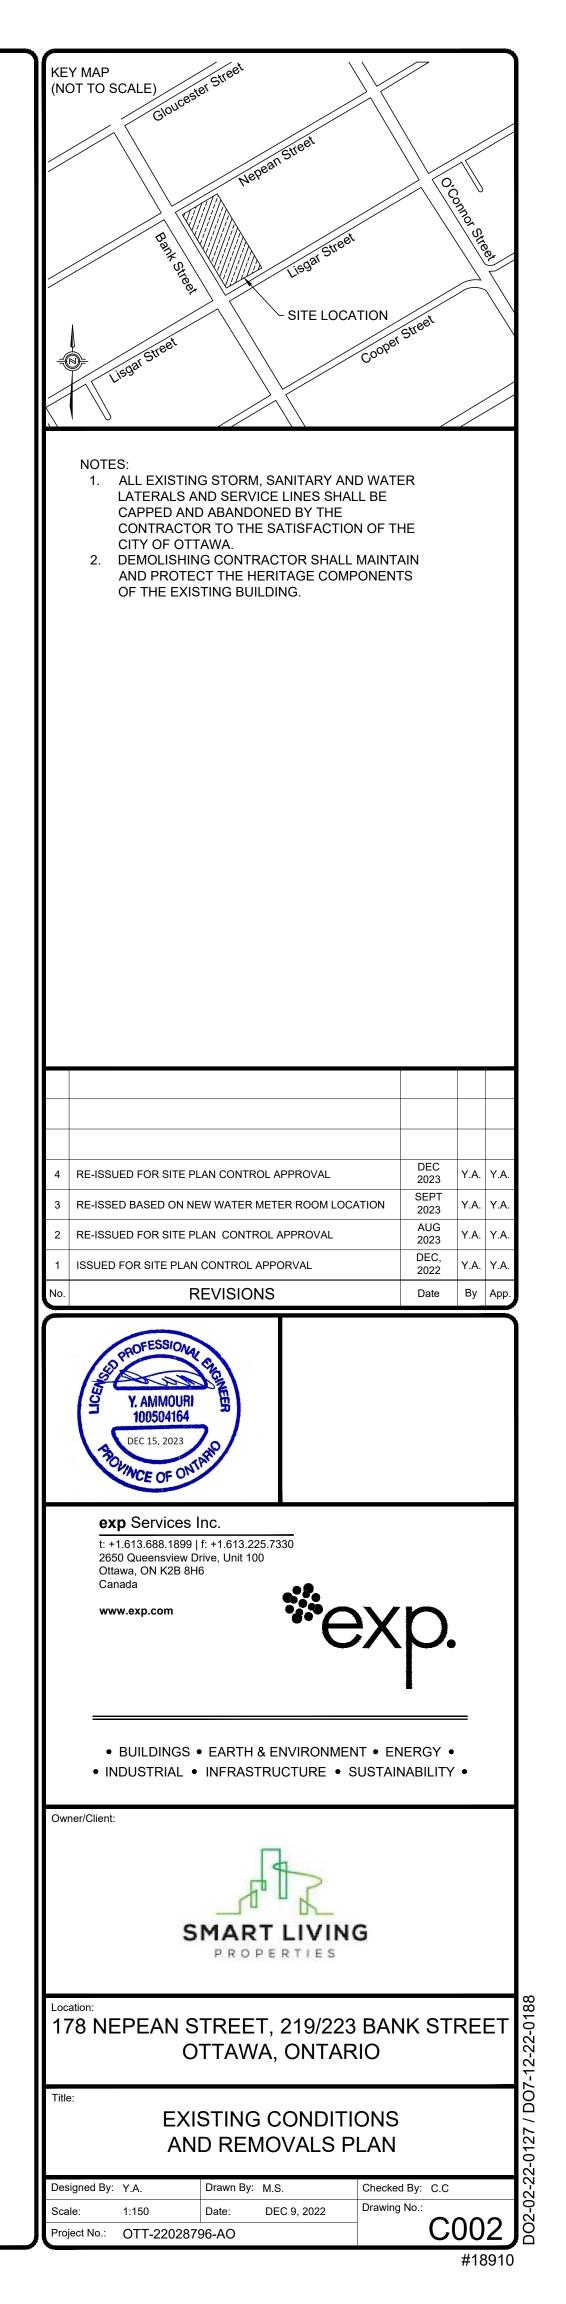



KEY PLAN

PROJECT No.OTT-22028796-A0 DECEMBER, 2023

SMART LIVING PROPERTIES 226 ARGYLE AVENUE, OTTAWA, ONTARIO



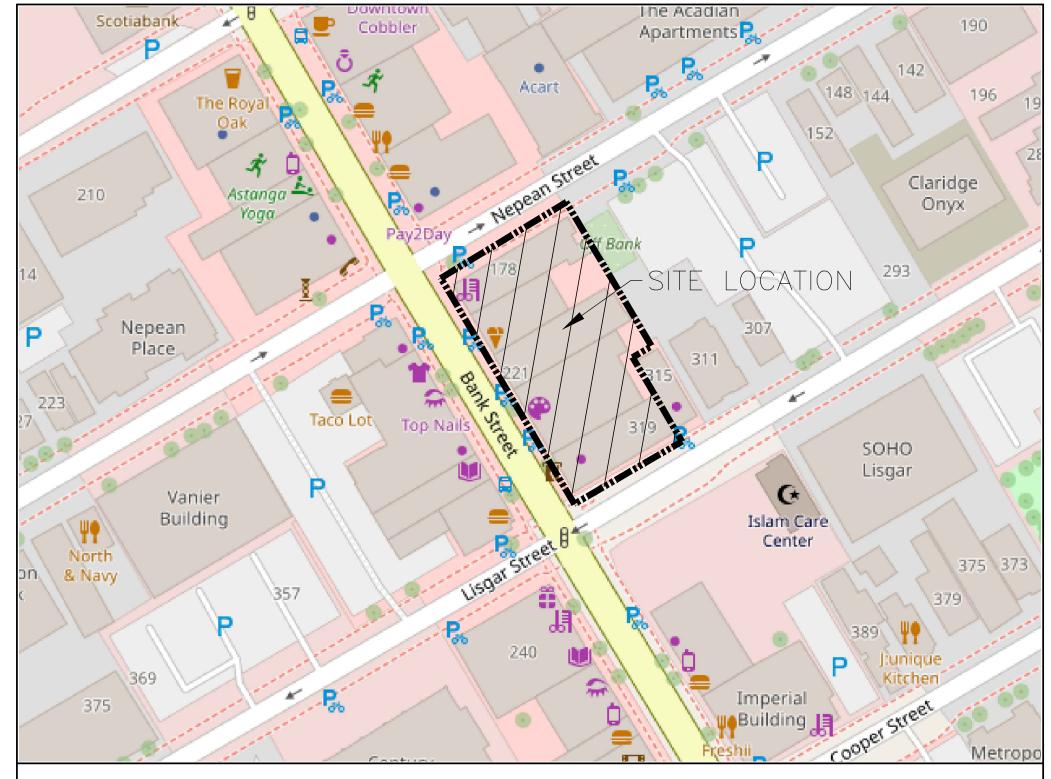

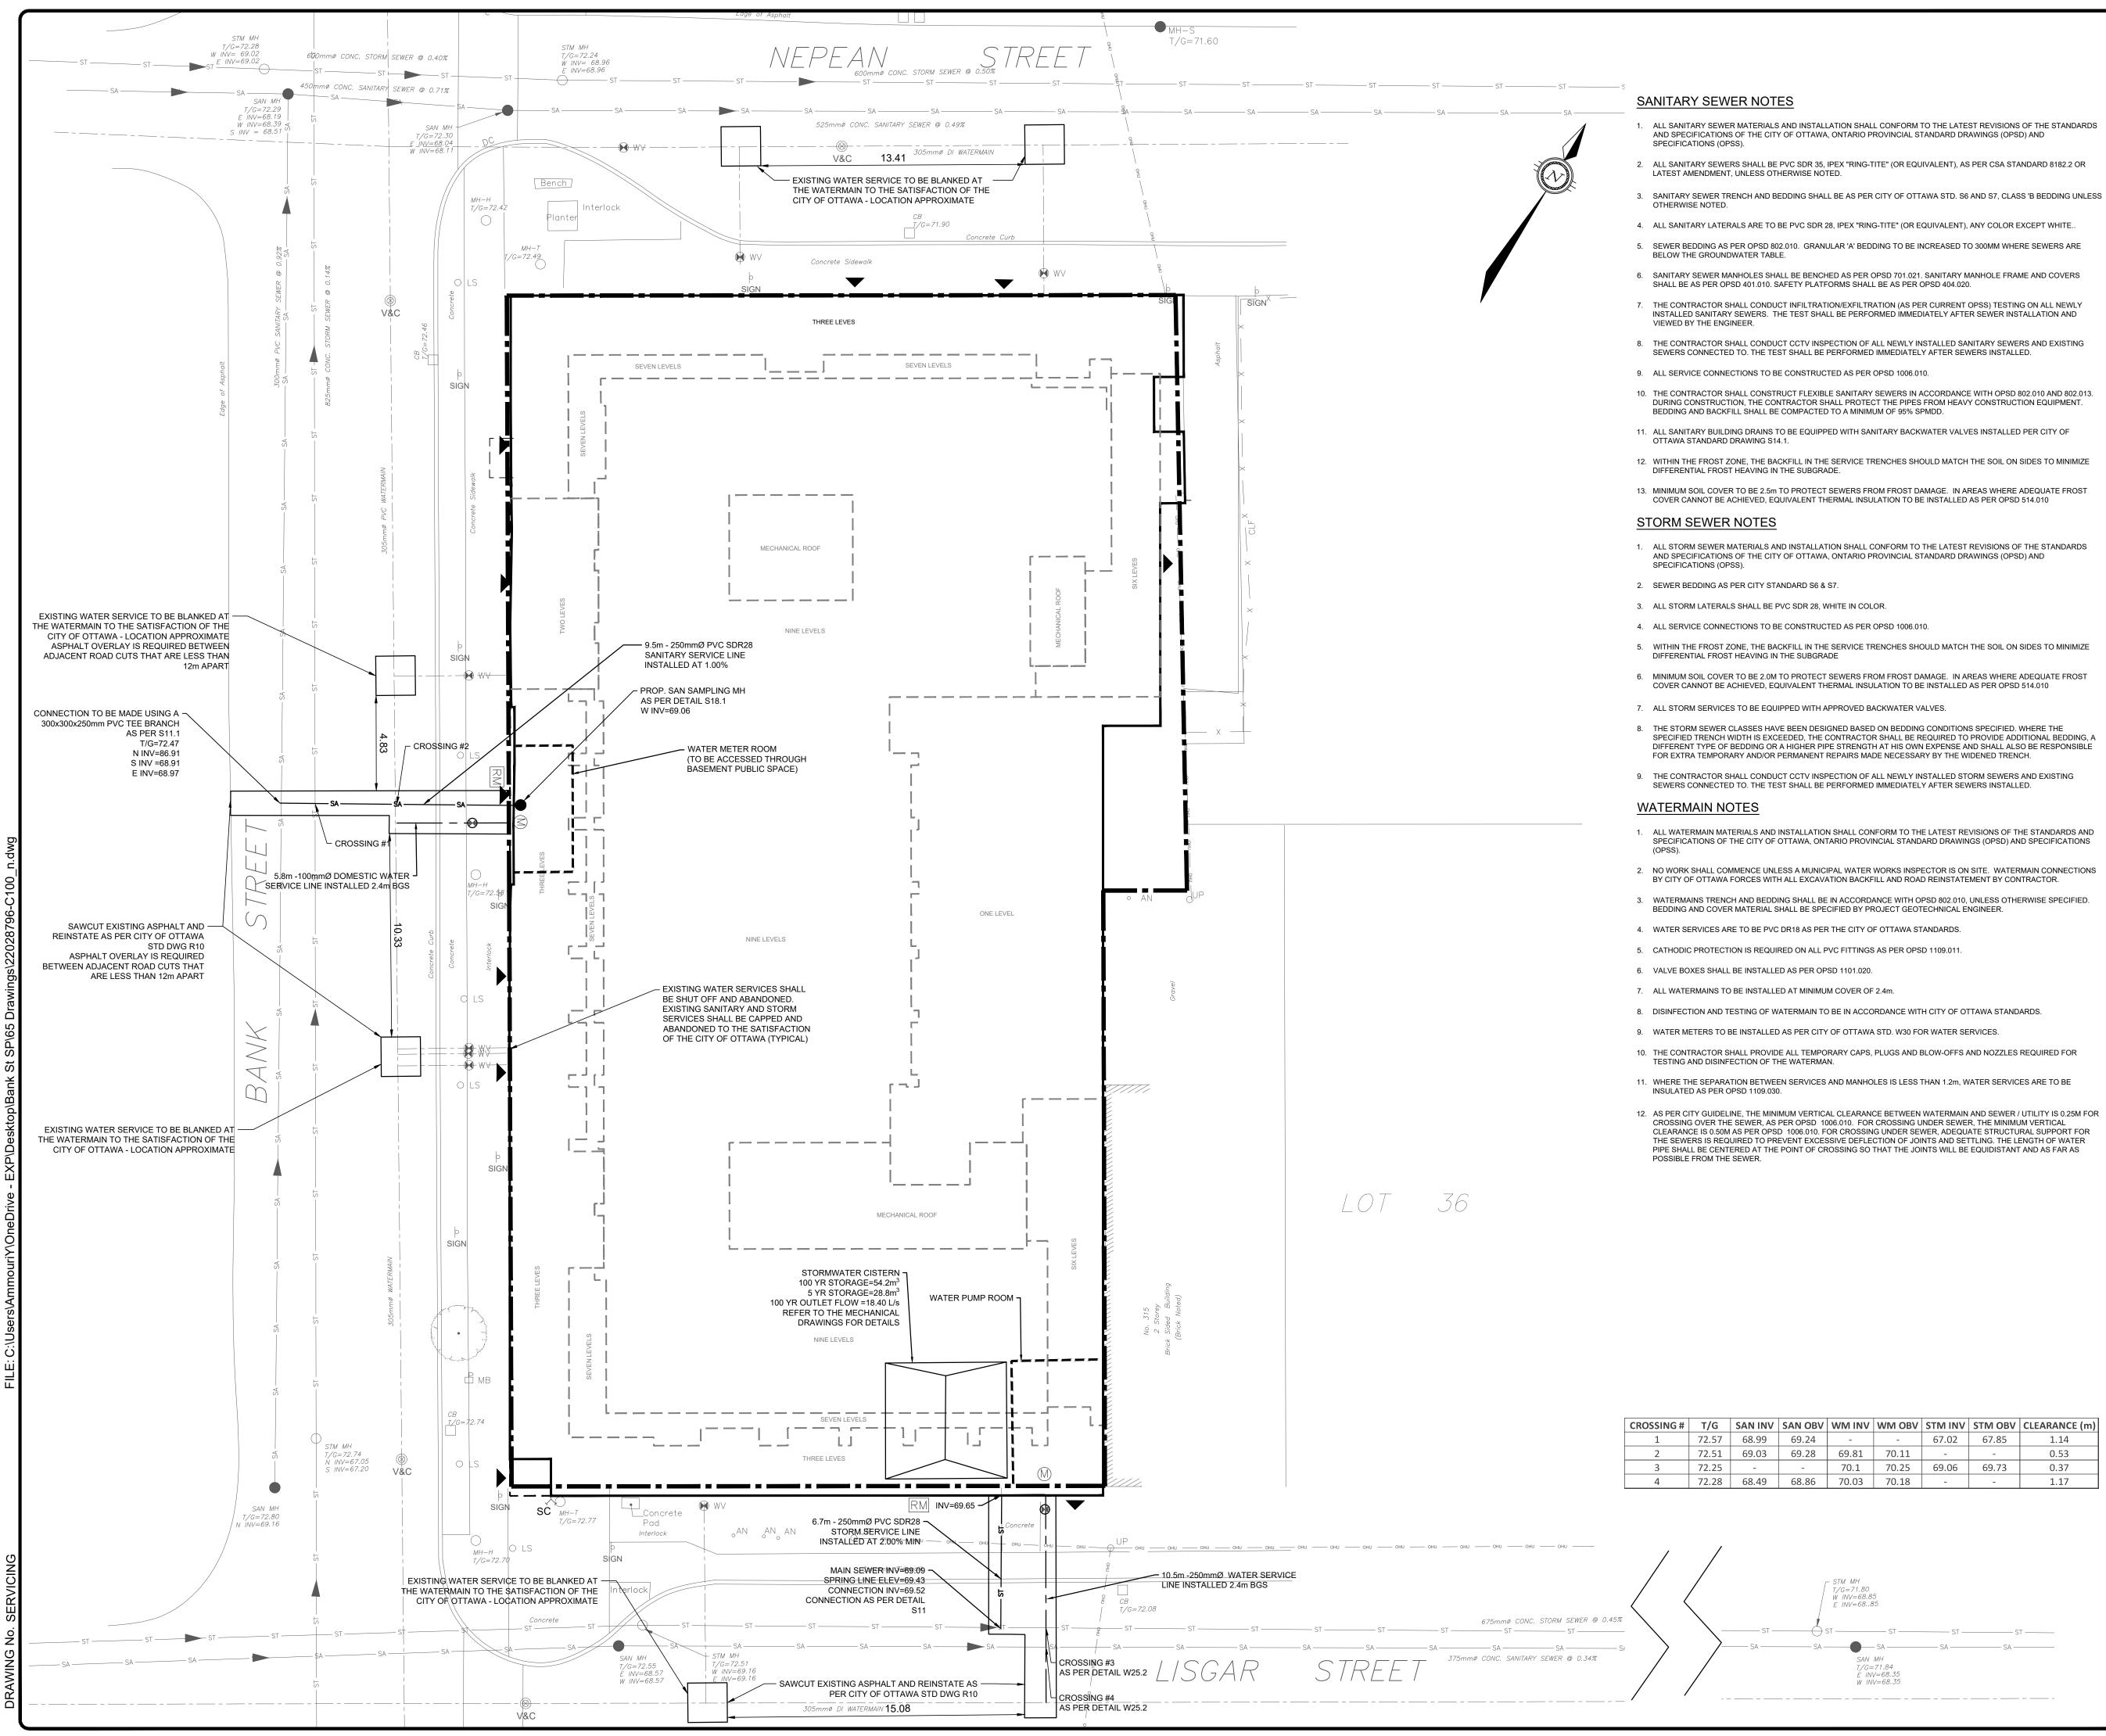

UIRED ON ALL PVC FITTINGS AS PER OPSD 1109.011
LED AS PER OPSD 1101.020.
LED AT MINIMUM COVER OF 2.4m.

– STM MH

T/G=71.80 W INV=68.85 E INV=68..85

SAN MH

T/G=71.84

E INV=68.35 W INV=68.35

8. DISINFECTION AND TESTING OF WATERMAIN TO BE IN ACCORDANCE WITH CITY OF OTTAWA STANDARDS.

9. WATER METERS TO BE INSTALLED AS PER CITY OF OTTAWA STD. W30 FOR WATER SERVICES.

10. THE CONTRACTOR SHALL PROVIDE ALL TEMPORARY CAPS, PLUGS AND BLOW-OFFS AND NOZZLES REQUIRED FC

11. WHERE THE SEPARATION BETWEEN SERVICES AND MANHOLES IS LESS THAN 1.2m, WATER SERVICES ARE TO BE

12. AS PER CITY GUIDELINE, THE MINIMUM VERTICAL CLEARANCE BETWEEN WATERMAIN AND SEWER / UTILITY IS 0.2 CROSSING OVER THE SEWER, AS PER OPSD 1006.010. FOR CROSSING UNDER SEWER, THE MINIMUM VERTICAL CLEARANCE IS 0.50M AS PER OPSD 1006.010. FOR CROSSING UNDER SEWER, ADEQUATE STRUCTURAL SUPPOR THE SEWERS IS REQUIRED TO PREVENT EXCESSIVE DEFLECTION OF JOINTS AND SETTLING. THE LENGTH OF WA PIPE SHALL BE CENTERED AT THE POINT OF CROSSING SO THAT THE JOINTS WILL BE EQUIDISTANT AND AS FAR

	No. REVISIONS	Date by Ap
RED FOR E TO BE TY IS 0.25M FOR RTICAL JPPORT FOR I OF WATER	Y. AMMOURI 100504164 DEC 15, 2023	
AS FAR AS	exp Services Inc. t: +1.613.688.1899 f: +1.613.225.7330 2650 Queensview Drive, Unit 100 Ottawa, ON K2B 8H6 Canada www.exp.com	exp.
	BUILDINGS • EARTH & ENVIRONMEN INDUSTRIAL • INFRASTRUCTURE • S Owner/Client:	
ARANCE (m) 1.14 0.53 0.37 1.17		G
	178 NEPEAN STREET, 219/223 OTTAWA, ONTAR	
	Title: SITE SERVICING P	LAN
	Designed By: Y.A. Drawn By: M.S.	Checked By: C.C
	Scale: 1:150 Date: DEC 9, 2022 Project No.: OTT-22028796-AO	Drawing No.:

No.	REVISIONS	Date	Ву	App.
1	ISSUED FOR SITE PLAN CONTROL APPORVAL	DEC, 2022	Y.A.	Y.A.
2	RE-ISSUED FOR SITE PLAN CONTROL APPROVAL	AUG, 2023	Y.A.	Y.A.
3	RE-ISSED BASED ON NEW WATER METER ROOM LOCATION	SEPT 2023	Y.A.	Y.A.
4	RE-ISSUED FOR SITE PLAN CONTROL APPROVAL	DEC 2023	Y.A.	Y.A.
	SC PROPOSED SIAMESE CONN	ECTION		


E Lisgar Street	SITE LOCATION Cooper Street
LEGEND	
	PROPERTY LINE
ОНИ ОНИ	EXISTING OVERHEAD UTILITY
	EXISTING WATERMAIN
	PROPOSED WATERMAIN
ST	PROPOSED STORM SEWER
SA	PROPOSED SANITARY SEWER
ST	EXISTING STORM SEWER
SA	EXISTING SANITARY SEWER
ullet	PROPOSED SANITARY MAINTENANCE HOLE
⊗ V&B	PROPOSED VALVE AND VALVE BOX
₩V	EXISTING WATER VALVE
Θ	PROPOSED WATER VALVE
\otimes	EXISTING VALVE CHAMBER
V&C O LS	EXISTING LIGHT STANDARD
OUP	EXISTING UTILITY POLE
ام SIGN	EXISTING SIGN
₫ мв	EXISTING MAIL BOX
BM	SITE BENCHMARK
Ĭ	PROPOSED BUILDING ENTRANCE
SC	PROPOSED SIAMESE CONNECTION

KEY MAP

(NOT TO SCALE)

AND SPECIFICATIONS OF THE CITY OF OTTAWA, ONTARIO PROVINCIAL STANDARD DRAWINGS (OPSD) AND

1. ALL SANITARY SEWER MATERIALS AND INSTALLATION SHALL CONFORM TO THE LATEST REVISIONS OF THE STANDARDS

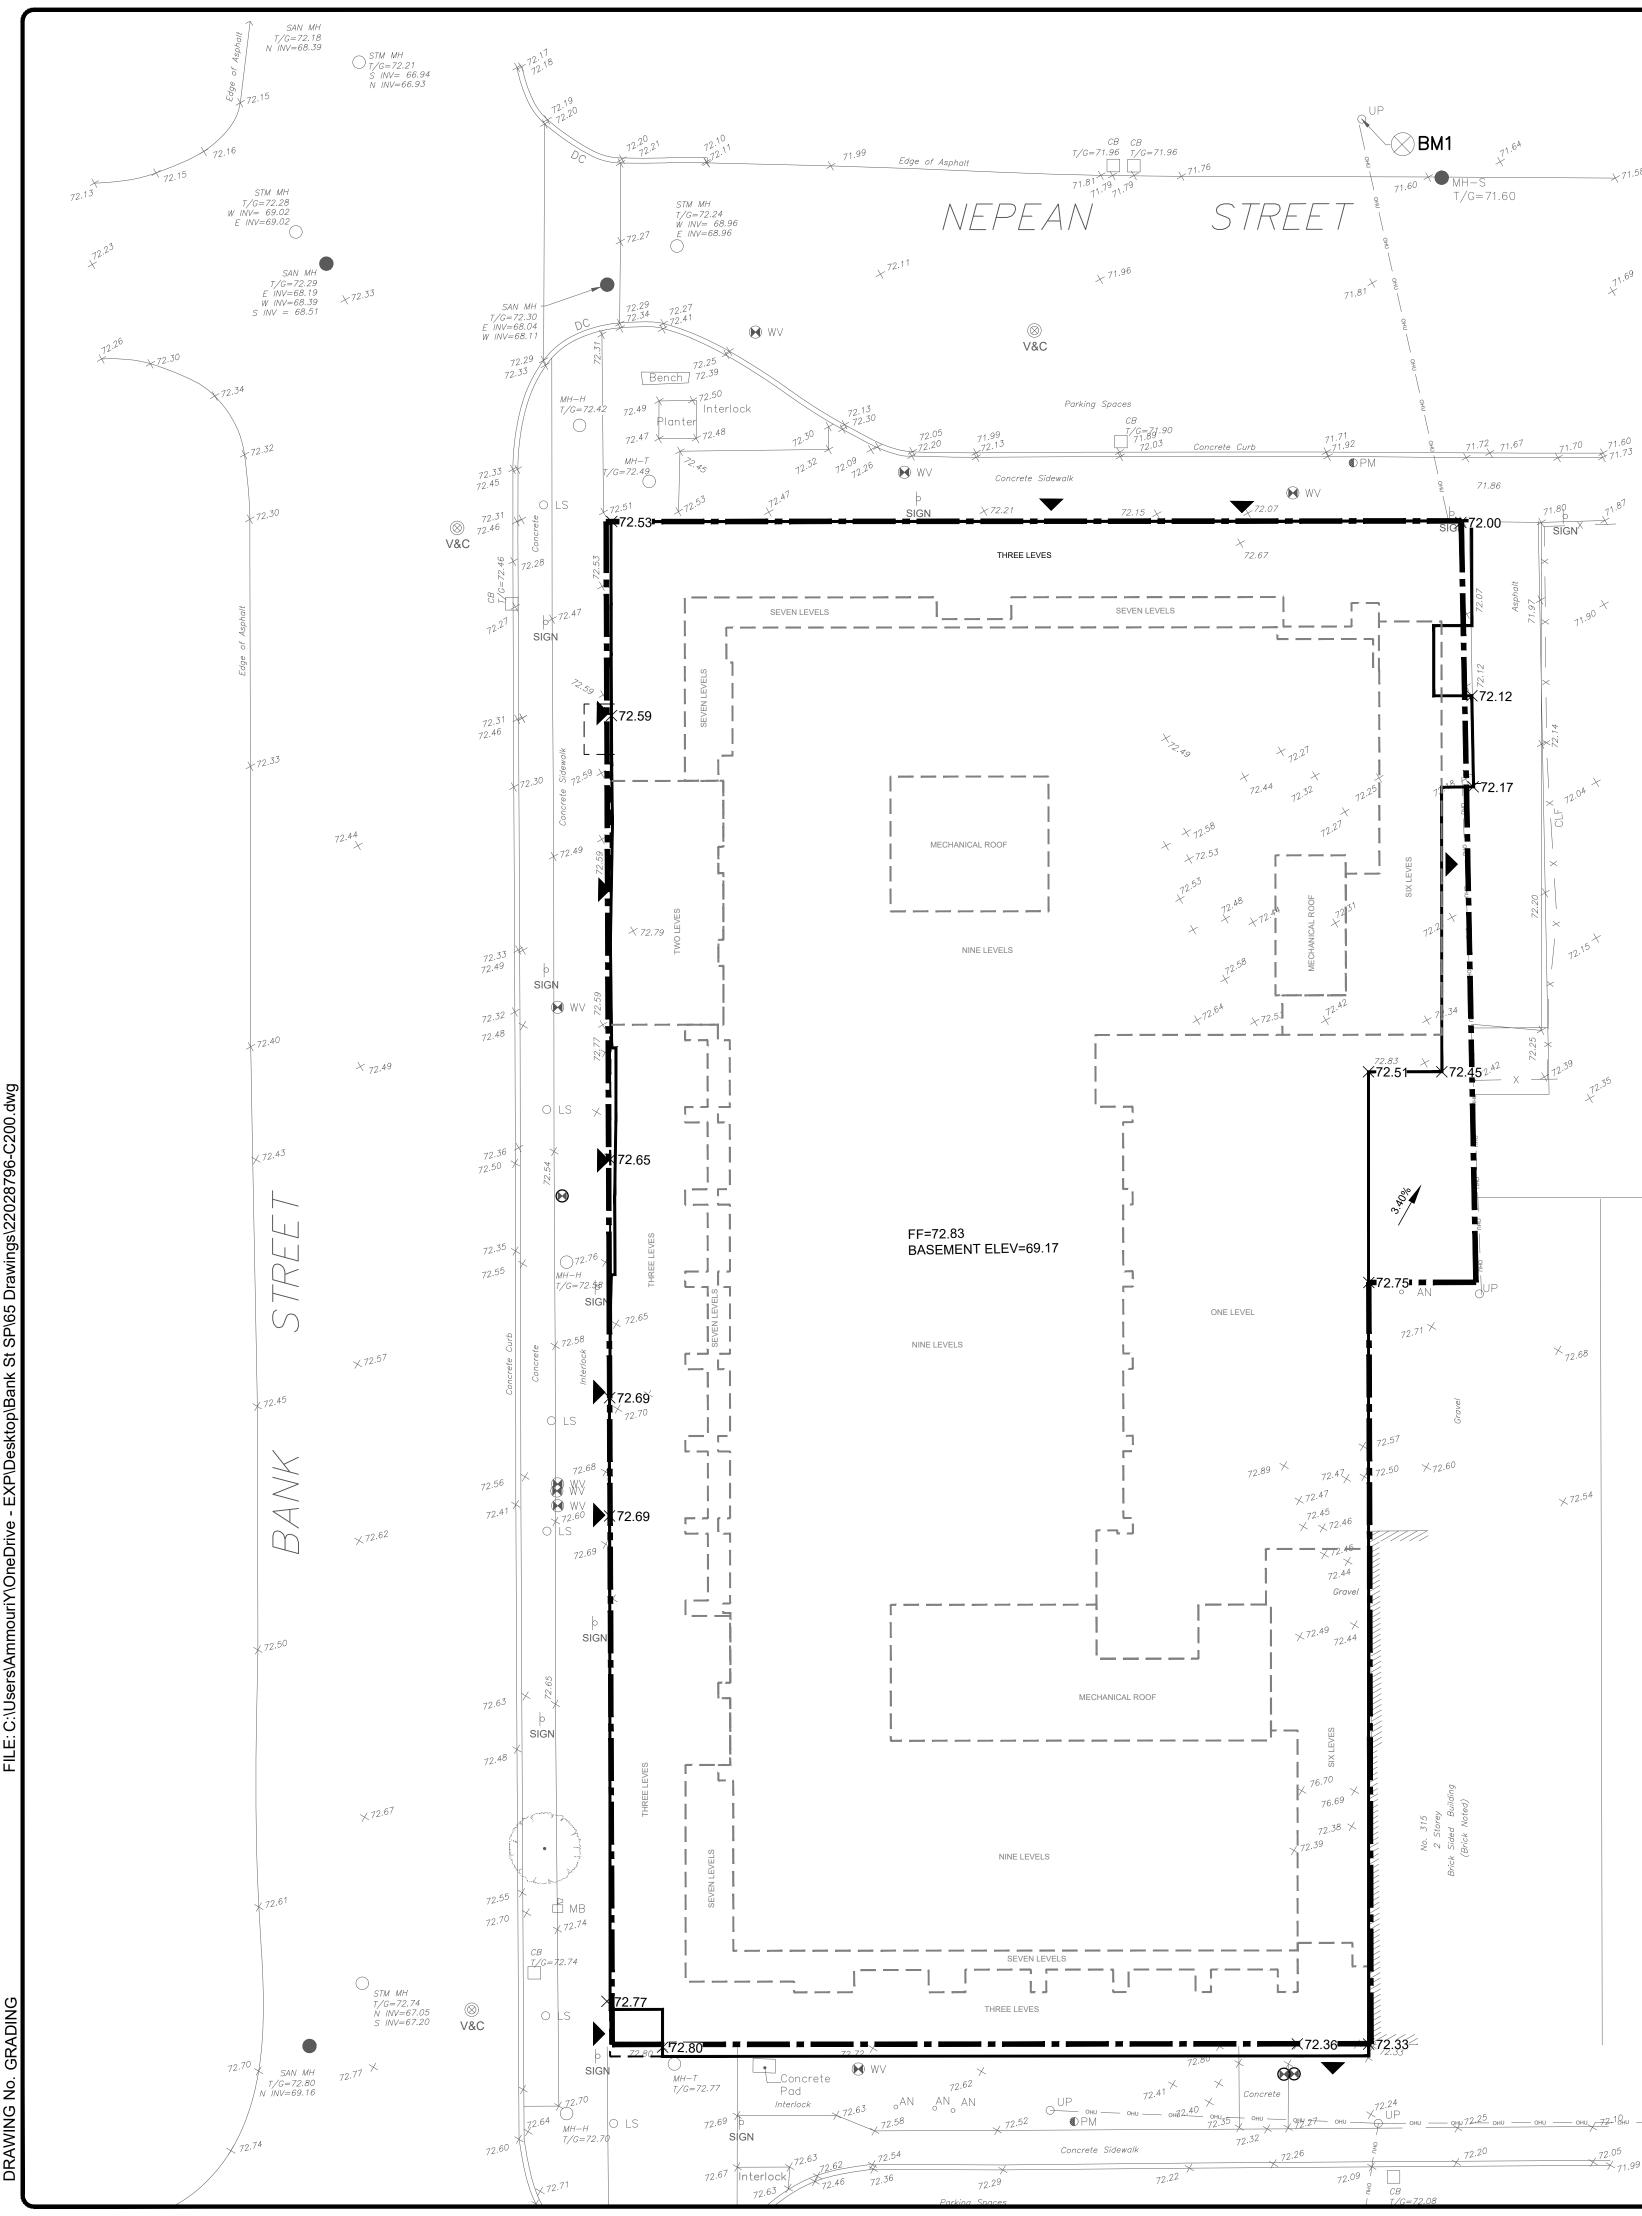

GENERAL NOTES:

- APPLICABLE.
- JURISDICTION.
- 3. THE CONTRACTOR SHALL VERIFY THE LOCATION AND ELEVATION OF EXISTING SERVICES PRIOR TO ANY IN AREAS WHERE DISCREPANCIES APPEAR UNTIL SUCH DISCREPANCIES HAVE BEEN RESOLVED.
- DIMENSIONS ARE TO BE CONFIRMED WITH THE ENGINEER IN WRITING.
- REGULATIONS FOR CONSTRUCTION PROJECTS", THE GENERAL CONTRACTOR SHALL BE DEEMED TO BE THE CONSTRUCTOR AS DEFINED IN THE ACT.
- DISTURBED DURING CONSTRUCTION TO THE SATISFACTION OF THE ENGINEER, THE CITY OF OTTAWA AND THE AUTHORITY HAVING JURISDICTION.
- CONDITION OR BETTER TO THE SATISFACTION OF THE AUTHORITY HAVING JURISDICTION AT THE CONTRACTOR'S EXPENSE.
- UNIFORM TRAFFIC CONTROL DEVICES (LATEST AMENDMENT).
- JURISDICTION.
- 12. EXCESS EXCAVATED MATERIAL SHALL BE REMOVED FROM THE SITE.
- SHALL BE MAINTAINED ON SITE BY THE CONTRACTOR.
- THE CITY OF OTTAWA PRIOR TO ANY TREE CUTTING.

PAVEMENT.

- 17. THE CONTRACTOR SHALL APPRAISE HIS/HER SELF OF ALL SURFACE AND SUBSURFACE CONDITIONS TO BE ANY SUCH GROUND CONDITIONS VARYING FROM THOSE ANTICIPATED BY THE CONTRACTOR.
- 18. DO NOT CONSTRUCT USING DRAWINGS THAT ARE NOT MARKED "ISSUED FOR CONSTRUCTION".
- 2022.
- ADMINISTRATOR AND THE CITY OF OTTAWA PRIOR TO ANY TREE CUTTING.

LOT 36

_____ OHU ______ OHU ______

BENCHMARK #1 Cut Cross on Concrete Utility Pole Base Elevation = 72.62

1. ALL WORKS AND MATERIALS SHALL CONFORM TO THE LATEST REVISIONS OF THE STANDARDS AND SPECIFICATIONS OF THE CITY OF OTTAWA, ONTARIO PROVINCIAL STANDARD DRAWINGS (OPSD) AND SPECIFICATIONS (OPSS), WHERE

2. THE LOCATION OF UTILITIES IS APPROXIMATE ONLY, AND THE EXACT LOCATION SHOULD BE DETERMINED BY CONSULTING THE MUNICIPAL AUTHORITIES AND UTILITY COMPANIES CONCERNED. THE CONTRACTOR IS RESPONSIBLE TO PROVIDE THE LOCATION AND STATUS OF UTILITIES AND SHALL BE RESPONSIBLE FOR ADEQUATE PROTECTION OF PLANT AND EQUIPMENT FROM DAMAGE. THE CONTRACTOR SHALL BE RESPONSIBLE FOR REPAIR OR REPLACEMENT OF ANY SERVICES OR UTILITIES DISTURBED DURING CONSTRUCTION, TO THE SATISFACTION OF THE AUTHORITY HAVING

CONSTRUCTION THE CONTRACTOR SHALL CONFIRM LOCATIONS AND ELEVATIONS OF EXISTING SERVICES AND STRUCTURES TO BE CONNECTED TO AND EXISTING SERVICES THAT MAY BE DAMAGED OR CAUSE CONFLICTS PRIOR TO CONSTRUCTION OF ANY NEW SEWER, WATER AND/OR STORM WATER WORKS. ALL DIMENSIONS SHALL BE CHECKED AND VERIFIED IN THE FIELD BY THE CONTRACTOR PRIOR TO THE START OF CONSTRUCTION. ANY DISCREPANCIES, INTERPRETATIONS, CHANGES AND ADDITIONS TO THESE DRAWINGS MUST BE BROUGHT TO THE ATTENTION OF THE ENGINEER, WHEN NOTED AND BEFORE PROCEEDING WITH CONSTRUCTION WORKS. DO NOT CONTINUE CONSTRUCTION

4. ALL ELEVATIONS ARE GEODETIC AND UTILIZE METRIC UNITS. ALL DIMENSIONS ARE IN METRES UNLESS OTHERWISE SPECIFIED. ALL DRAWINGS SHOULD NOT BE SCALED BY THE CONTRACTOR. ANY MISSING OR QUESTIONABLE

5. THE CONTRACTOR SHALL BE RESPONSIBLE FOR OBTAINING ALL PERMITS REQUIRED AND BEAR COST OF THE SAME. 6. ALL WORK SHALL BE COMPLETED IN ACCORDANCE WITH THE "OCCUPATIONAL HEALTH AND SAFETY ACT AND

7. CONTRACTOR SHALL BE RESPONSIBLE FOR ALL EXCAVATION, BACKFILL AND REINSTATEMENT OF ALL AREAS

8. ANY AREAS BEYOND THE LIMIT OF THE SITE DISTURBED DURING CONSTRUCTION SHALL BE RESTORED TO ORIGINAL

9. THE CONTRACTOR SHALL COMPLY WITH THE CITY OF OTTAWA REQUIREMENTS FOR TRAFFIC CONTROL WHEN WORKING ON CITY STREETS. ALL CONSTRUCTION SIGNAGE MUST CONFORM TO THE M.T.O. BOOK 7 AND T.A.C MANUAL OF

10. THE SUPPORT OF ALL UTILITIES SHALL BE IN ACCORDANCE WITH THE REQUIREMENTS OF THE AUTHORITY HAVING

11. THERE WILL BE NO SUBSTITUTION OF MATERIALS UNLESS WRITTEN APPROVAL BY THE ENGINEER HAS BEEN OBTAINED.

13. THE SITE LAYOUT IS THE RESPONSIBILITY OF THE CONTRACTOR. AS-BUILT SITE SERVICING & GRADING DRAWINGS

14. THE CONTRACTOR WILL BE RESPONSIBLE FOR ADDITIONAL BEDDING OR ADDITIONAL STRENGTH PIPE IF THE MAXIMUM TRENCH WIDTH, AS SPECIFIED BY OPSD, IS EXCEEDED.

15. ALL NECESSARY CLEARING AND GRUBBING SHALL BE COMPLETED AY THE CONTRACTOR. REVIEW WITH ENGINEER AND

16. ALL EDGES OF DISTURBED PAVEMENT SHALL BE SAW CUT TO FORM A NEAT AND STRAIGHT LINE PRIOR TO PLACING NEW

ENCOUNTERED AND SHALL CARRY OUT THEIR OWN TEST PITS AS REQUIRED TO MAKE THEIR OWN INDEPENDENT ASSESSMENT OF GROUND CONDITIONS. THE CONTRACTOR SHALL NOT MAKE ANY CLAIM FOR ANY EXTRA COST DUE TO

19. FOR TOPOGRAPHICAL INFORMATION REFER TO PLAN PREPARED BY ANNIS, O'SULLIVAN, VOLLEBEKK. DATED AUGUST 24,

20. CIVIL DRAWINGS TO BE READ IN CONJUNCTION WITH ARCHITECTURAL, LANDSCAPE AND LEGAL DRAWINGS.

21. ALL NECESSARY CLEARING AND GRUBBING SHALL BE COMPLETED BY THE CONTRACTOR. REVIEW WITH CONTRACT

KEY MAP (NOT TO SCALE) SITE LOCATION <u>LEGEND</u> PROPERTY LINE — они — они — OHU — EXISTING OVERHEAD UTILITY PROPOSED SLOPE EXISTING ELEVATION imes X.XX imes X.XX PROPOSED ELEVATION PROPOSED SANITARY MAINTENANCE HOLE PROPOSED VALVE AND VALVE BOX V&B WV 闽 EXISTING WATER VALVE PROPOSED WATER VALVE **₩** EXISTING VALVE CHAMBER V&C EXISTING LIGHT STANDARD O LS OUP EXISTING UTILITY POLE EXISTING SIGN SIGN 🖞 МВ EXISTING MAIL BOX BM SITE BENCHMARK PROPOSED BUILDING ENTRANCE FF PROPOSED FINISH FLOOR ELEVATION DEC RE-ISSUED FOR SITE PLAN CONTROL APPROVAL Y.A. Y.A 2023 SEPT RE-ISSED BASED ON NEW WATER METER ROOM LOCATION Y.A. 2023 AUG 2023 RE-ISSUED FOR SITE PLAN CONTROL APPROVAL Y.A. Y./ DEC, 2022 Y.A. Y.A ISSUED FOR SITE PLAN CONTROL APPORVAL REVISIONS Date By Ap 100504164 EC 15, 202 **exp** Services Inc. t: +1.613.688.1899 | f: +1.613.225.7330 2650 Queensview Drive, Unit 100 Ottawa, ON K2B 8H6 Canada www.exp.com BUILDINGS • EARTH & ENVIRONMENT • ENERGY • • INDUSTRIAL • INFRASTRUCTURE • SUSTAINABILITY • Owner/Client:



178 NEPEAN STREET, 219/223 BANK STREET OTTAWA, ONTARIO

GRADING PLAN

Drawn By: M.S. Checked By: C.C esigned By: Y.A. Drawing No.: Date: DEC 9, 2022 1:150 Scale: C200 Project No.: OTT-22028796-AO #18910

