



192.35 TOP OF MECHANICAL / AMENITY
 5.70 m
 186.65 MECHANICAL / AMENITY
 183.65 LEVEL 40
 180.65 LEVEL 39
 177.65 LEVEL 38
 174.65 LEVEL 37
 171.65 LEVEL 36
 168.65 LEVEL 35
 165.65 LEVEL 34
 162.65 LEVEL 33
 159.65 LEVEL 32
 156.65 LEVEL 31
 153.65 LEVEL 30
 150.65 LEVEL 29
 147.65 LEVEL 28
 144.65 LEVEL 27
 141.65 LEVEL 26
 138.65 LEVEL 25
 135.65 LEVEL 24
 132.65 LEVEL 23
 129.65 LEVEL 22
 126.65 LEVEL 21
 123.65 LEVEL 20
 120.65 LEVEL 19
 117.65 LEVEL 18
 114.65 LEVEL 17
 111.65 LEVEL 16
 108.65 LEVEL 15
 105.65 LEVEL 14
 102.65 LEVEL 13
 99.65 LEVEL 12
 96.65 LEVEL 11
 93.65 LEVEL 10
 90.65 LEVEL 9
 87.65 LEVEL 8
 84.65 LEVEL 7
 81.65 LEVEL 6
 78.65 LEVEL 5
 75.65 LEVEL 4
 72.65 LEVEL 3
 69.65 LEVEL 2
 6.00 m
 63.65 GROUND LEVEL

VG GR AP-1 AP-1 SP PC-1 GR VG VG GR SP PC-1 GR AP-1 VG AP-1

MS-1 VG SP VG MP-2 MG SV MP-1 VG MS-2 VG MS-2 SP AP-1 MP-2 GR MG VG VG MS-1

1 NORTH ELEVATION
 A3.01 Scale: 1: 250



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WIND FRIENDLY GLASS: AS PER CITY WIND SAFETY GUIDELINES OUTLINE 2, TOWER 1 & 2, MARK 1 & 2
 1) GLASS PROVIDED FOR LOW WIND VELOCITY ONLY 1-4
 2) GLASS PROVIDED FOR BALCONY RAILINGS ONLY 1-4
 3) GLASS PROVIDED FOR ALL BALCONY RAILINGS ON ROOF TERRACE LEVELS

no.	date	revision
1	23-02-22	ISSUED FOR SPC
1	22-04-07	ISSUED FOR REZONING

It is the responsibility of the appropriate contractor to check and verify all dimensions on site and report all errors and/or omissions to the architect.

All contractors must comply with all pertinent codes and by-laws.

Do not scale drawings.

This drawing may not be used for construction until signed.

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LEGEND:

AP-1	ALUMINUM PANEL 1
MS-1	MASONRY 1
MS-2	MASONRY 2
MS-3	MASONRY 3
PC-1	PRE-CAST MASONRY PANEL 1
GR	GLASS RAILING
MS	METAL GUARD
MP-1	METAL PANEL 1
MP-2	METAL PANEL 2
SP	SPANDREL PANEL
VG	VISION GLASS
BV	STONE VENEER

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PROJECT/LOCATION:
 314 & 318 ATHLONE AVE.,
 2006, 2020 & 2026 SCOTT STREET

DRAWING TITLE:
 BUILDINGS 1 + 2 - NORTH ELEVATION

DRAWN BY: PB/KM DATE: 230222 SCALE: 1:250

PROJECT: 1937
 DRAWING NO.: A3-00
 REVISION NO.:



192.35 TOP OF MECHANICAL / AMENITY
 186.65 MECHANICAL / AMENITY
 183.65 LEVEL 40
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 81.65 LEVEL 6
 78.65 LEVEL 5
 75.65 LEVEL 4
 72.65 LEVEL 3
 69.65 LEVEL 2
 6.00 m
 63.65 GROUND LEVEL

AP-1 PC-1 VG PC-1 SP GR

VG GR PC-1 SP PC-1 GR

VG GR MS-1 MS-3 AP-1 MG SP VG MS-2 VG MS-1 VG MS-3 GR AP-1 AP-1 MG SP MS-1

1 SOUTH ELEVATION
A3.01 Scale: 1: 250



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WIND FRIENDLY GLASS: AS PER CITY OF TORONTO SAFETY GLASS OUTLINE 2, TORONTO 3.0 MARK 2 & 3
 1. GLASS PROVIDED FOR LOW RISE STRUCTURES ONLY 1.4
 2. GLASS PROVIDED FOR BALCONY RAILINGS ONLY 1.4
 3. GLASS PROVIDED FOR ALL BALCONY RAILINGS ON ROOF TERRACE LEVELS

no.	date	revision
1	23-02-22	ISSUED FOR SPC
1	22-04-07	ISSUED FOR REZONING

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LEGEND:

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MS-1	MASONRY 1
MS-2	MASONRY 2
MS-3	MASONRY 3
PC-1	PRE-CAST MASONRY PANEL 1
GR	GLASS RAILING
MS	METAL GUARD
MP-1	METAL PANEL 1
MP-2	METAL PANEL 2
SP	SPANDREL PANEL
VG	VISION GLASS
SV	STONE VENEER


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PROJECT/LOCATION:
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 2006, 2020 & 2026 SCOTT STREET

DRAWING TITLE:
 BUILDINGS 1 + 2 - SOUTH ELEVATION

DRAWN BY: PB/KM **DATE:** 230222 **SCALE:** 1:250

PROJECT: 1937
DRAWING NO.: A3-01
REVISION NO.:

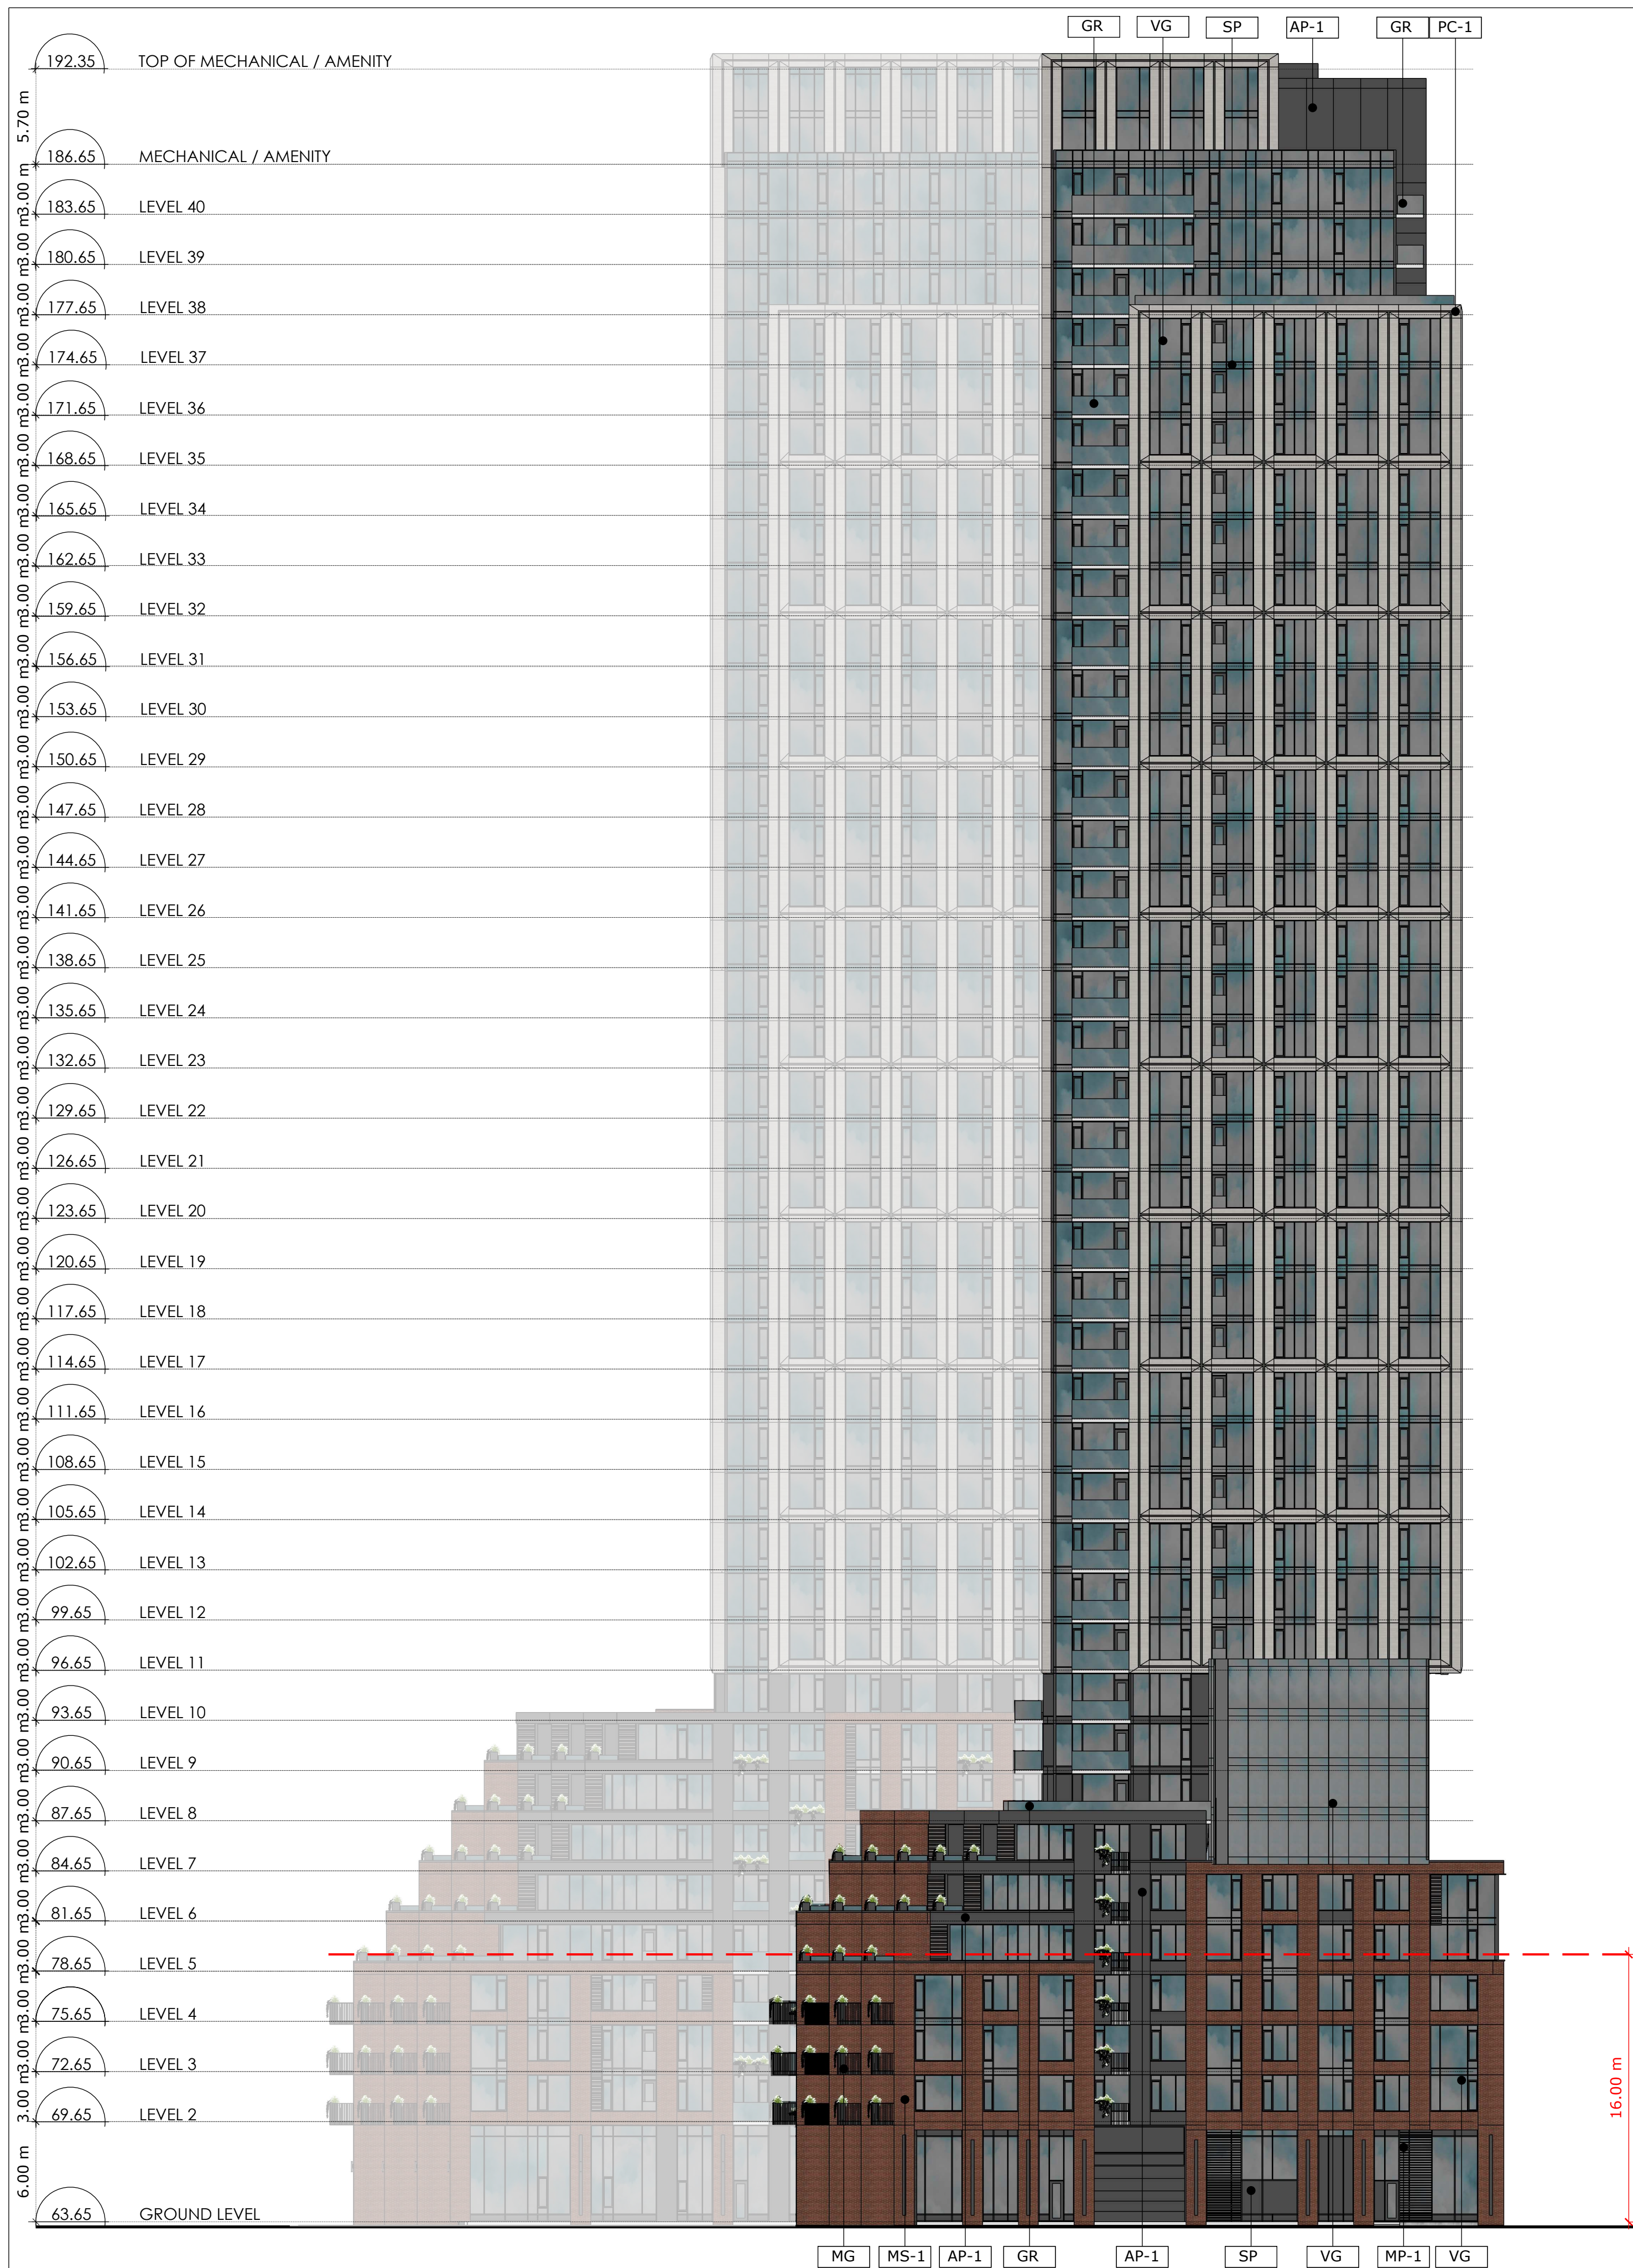

1 EAST ELEVATION - EAST BUILDING
A3.00 Scale: 1: 250

2 WEST ELEVATION - WEST BUILDING
A3.00 Scale: 1: 250



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WIND FRIENDLY GLASS: AS PER CITY OF OTTAWA SAFETY REGULATIONS OUTLINE 2, TYPING IS AS SHOWN. A. GLASS PROVIDED FOR ALL BALCONY RAILINGS ON LEVEL 4. B. GLASS PROVIDED FOR ALL BALCONY RAILINGS ON LEVEL 5. C. GLASS PROVIDED FOR ALL BALCONY RAILINGS ON ROOF TERRACE LEVELS.

no.	date	revision
1	23-02-22	ISSUED FOR SPC
1	22-04-07	ISSUED FOR REZONING

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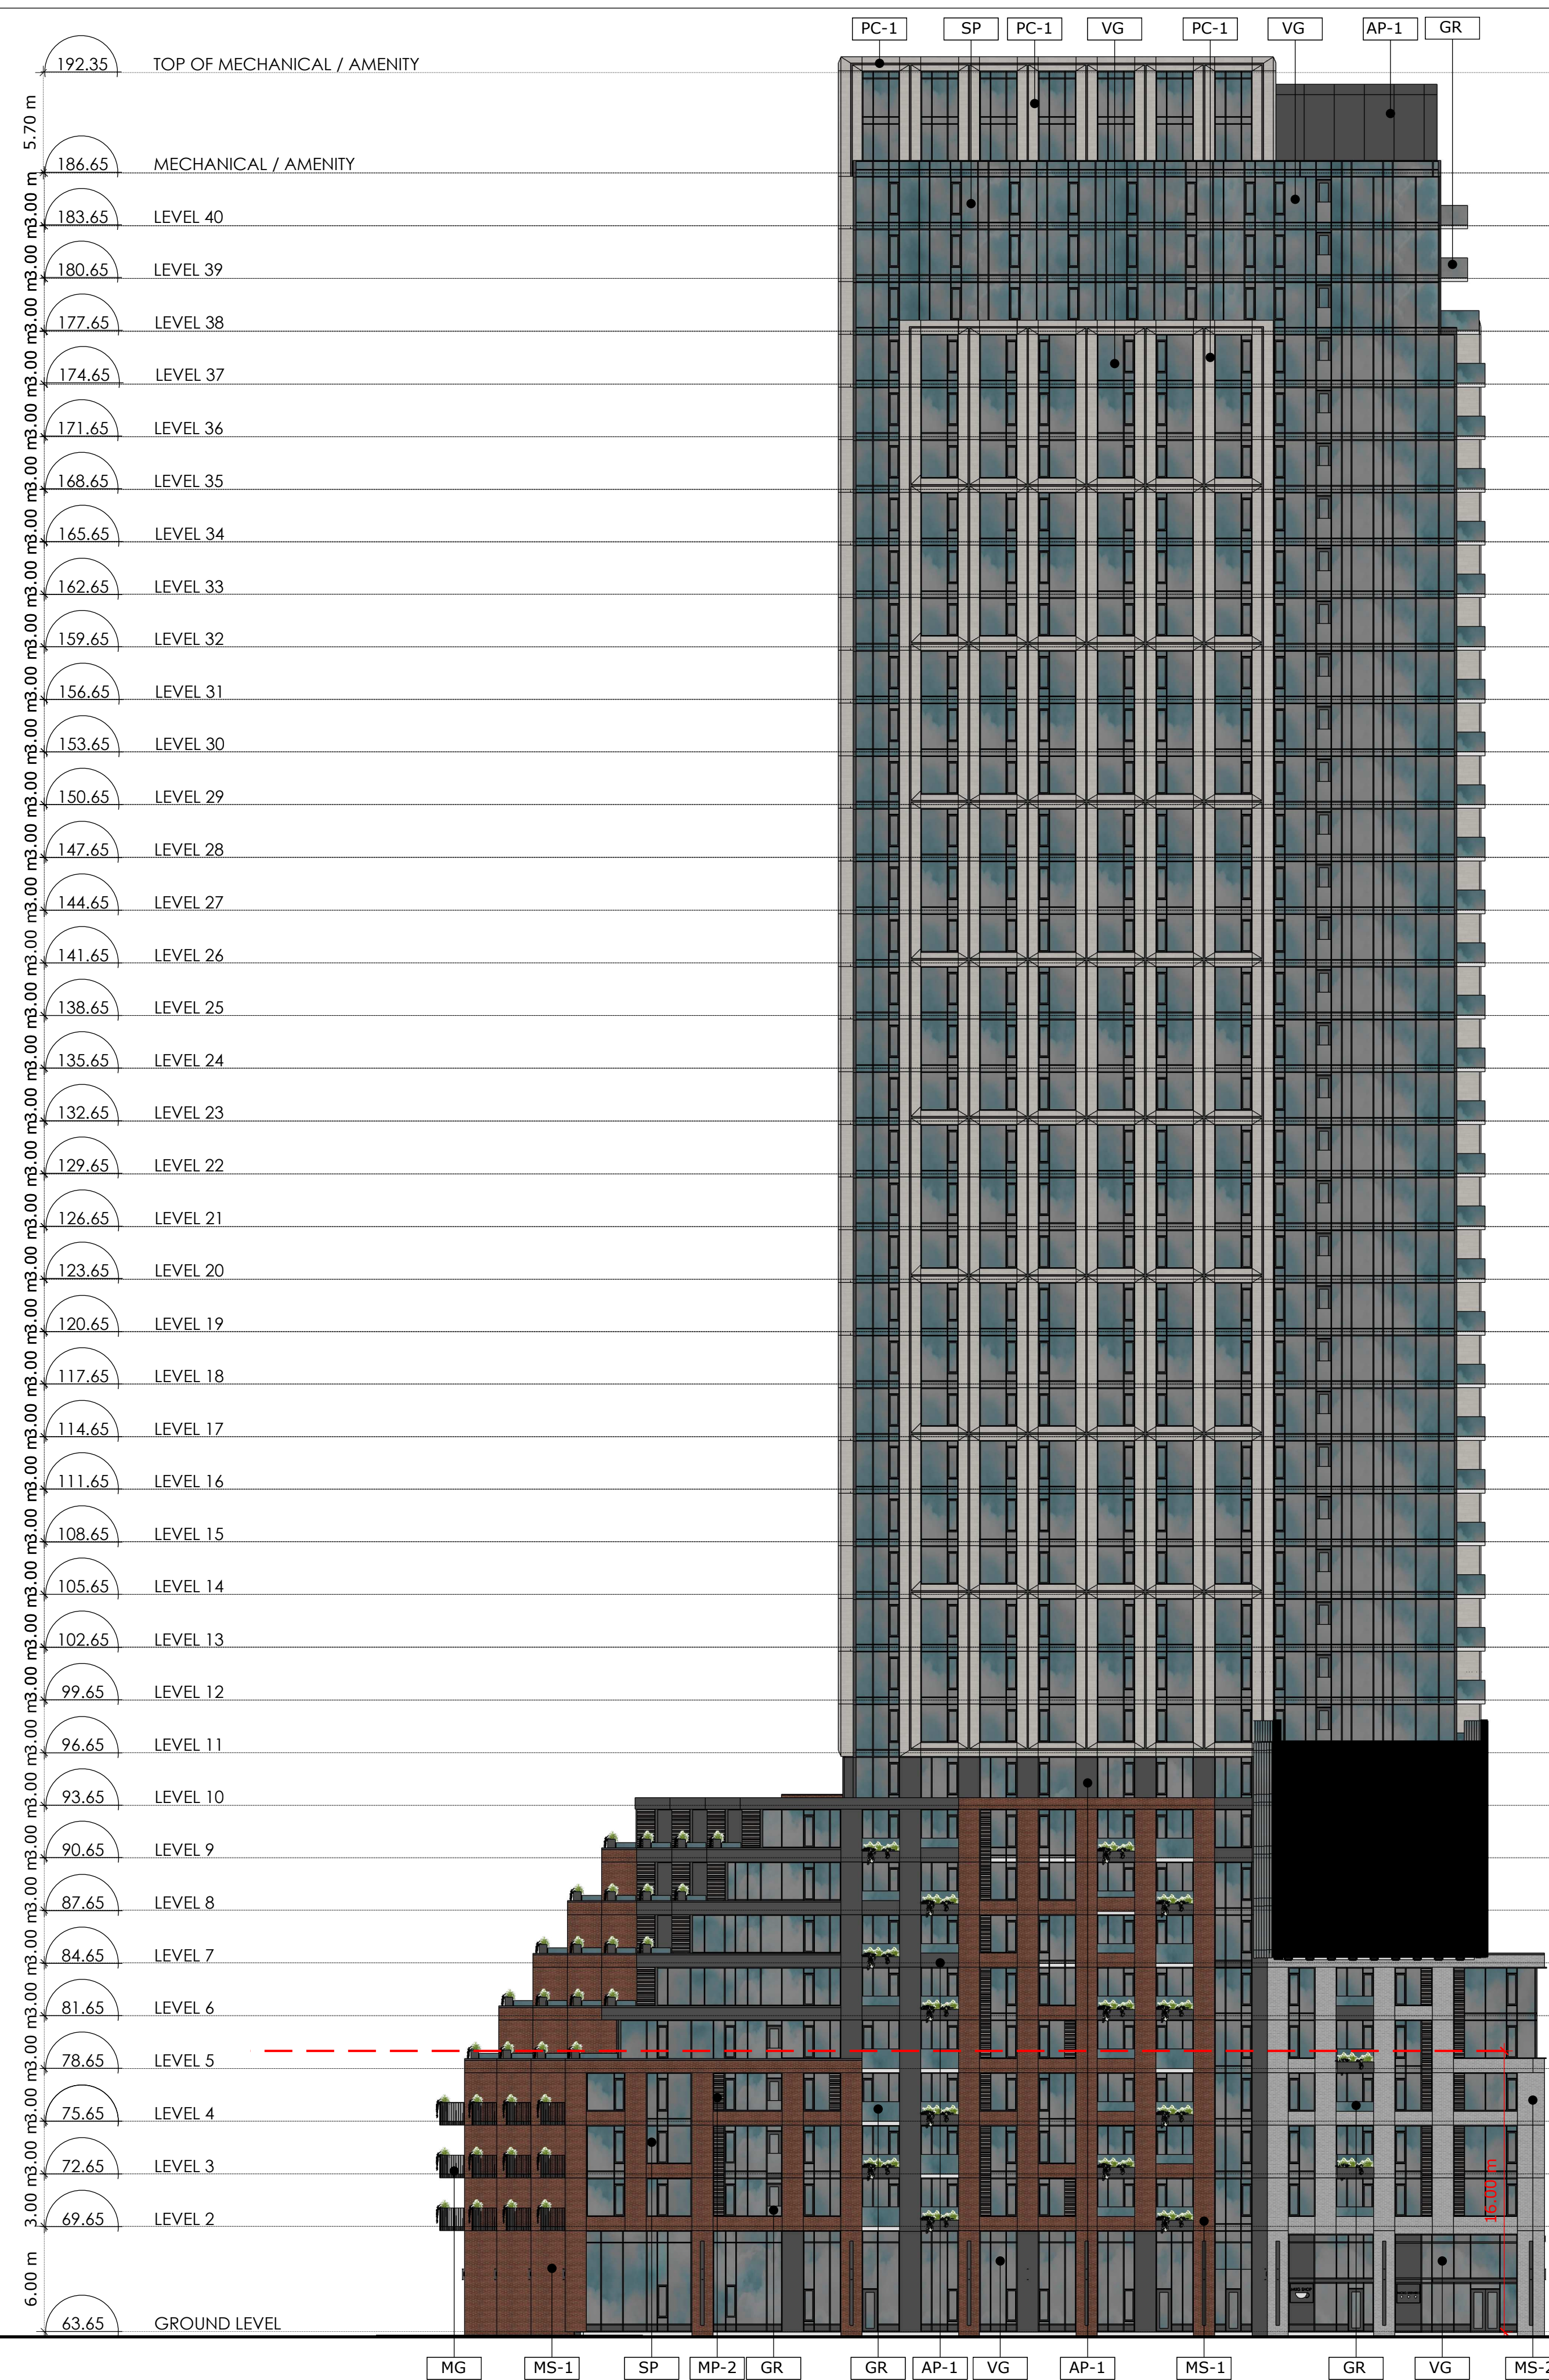
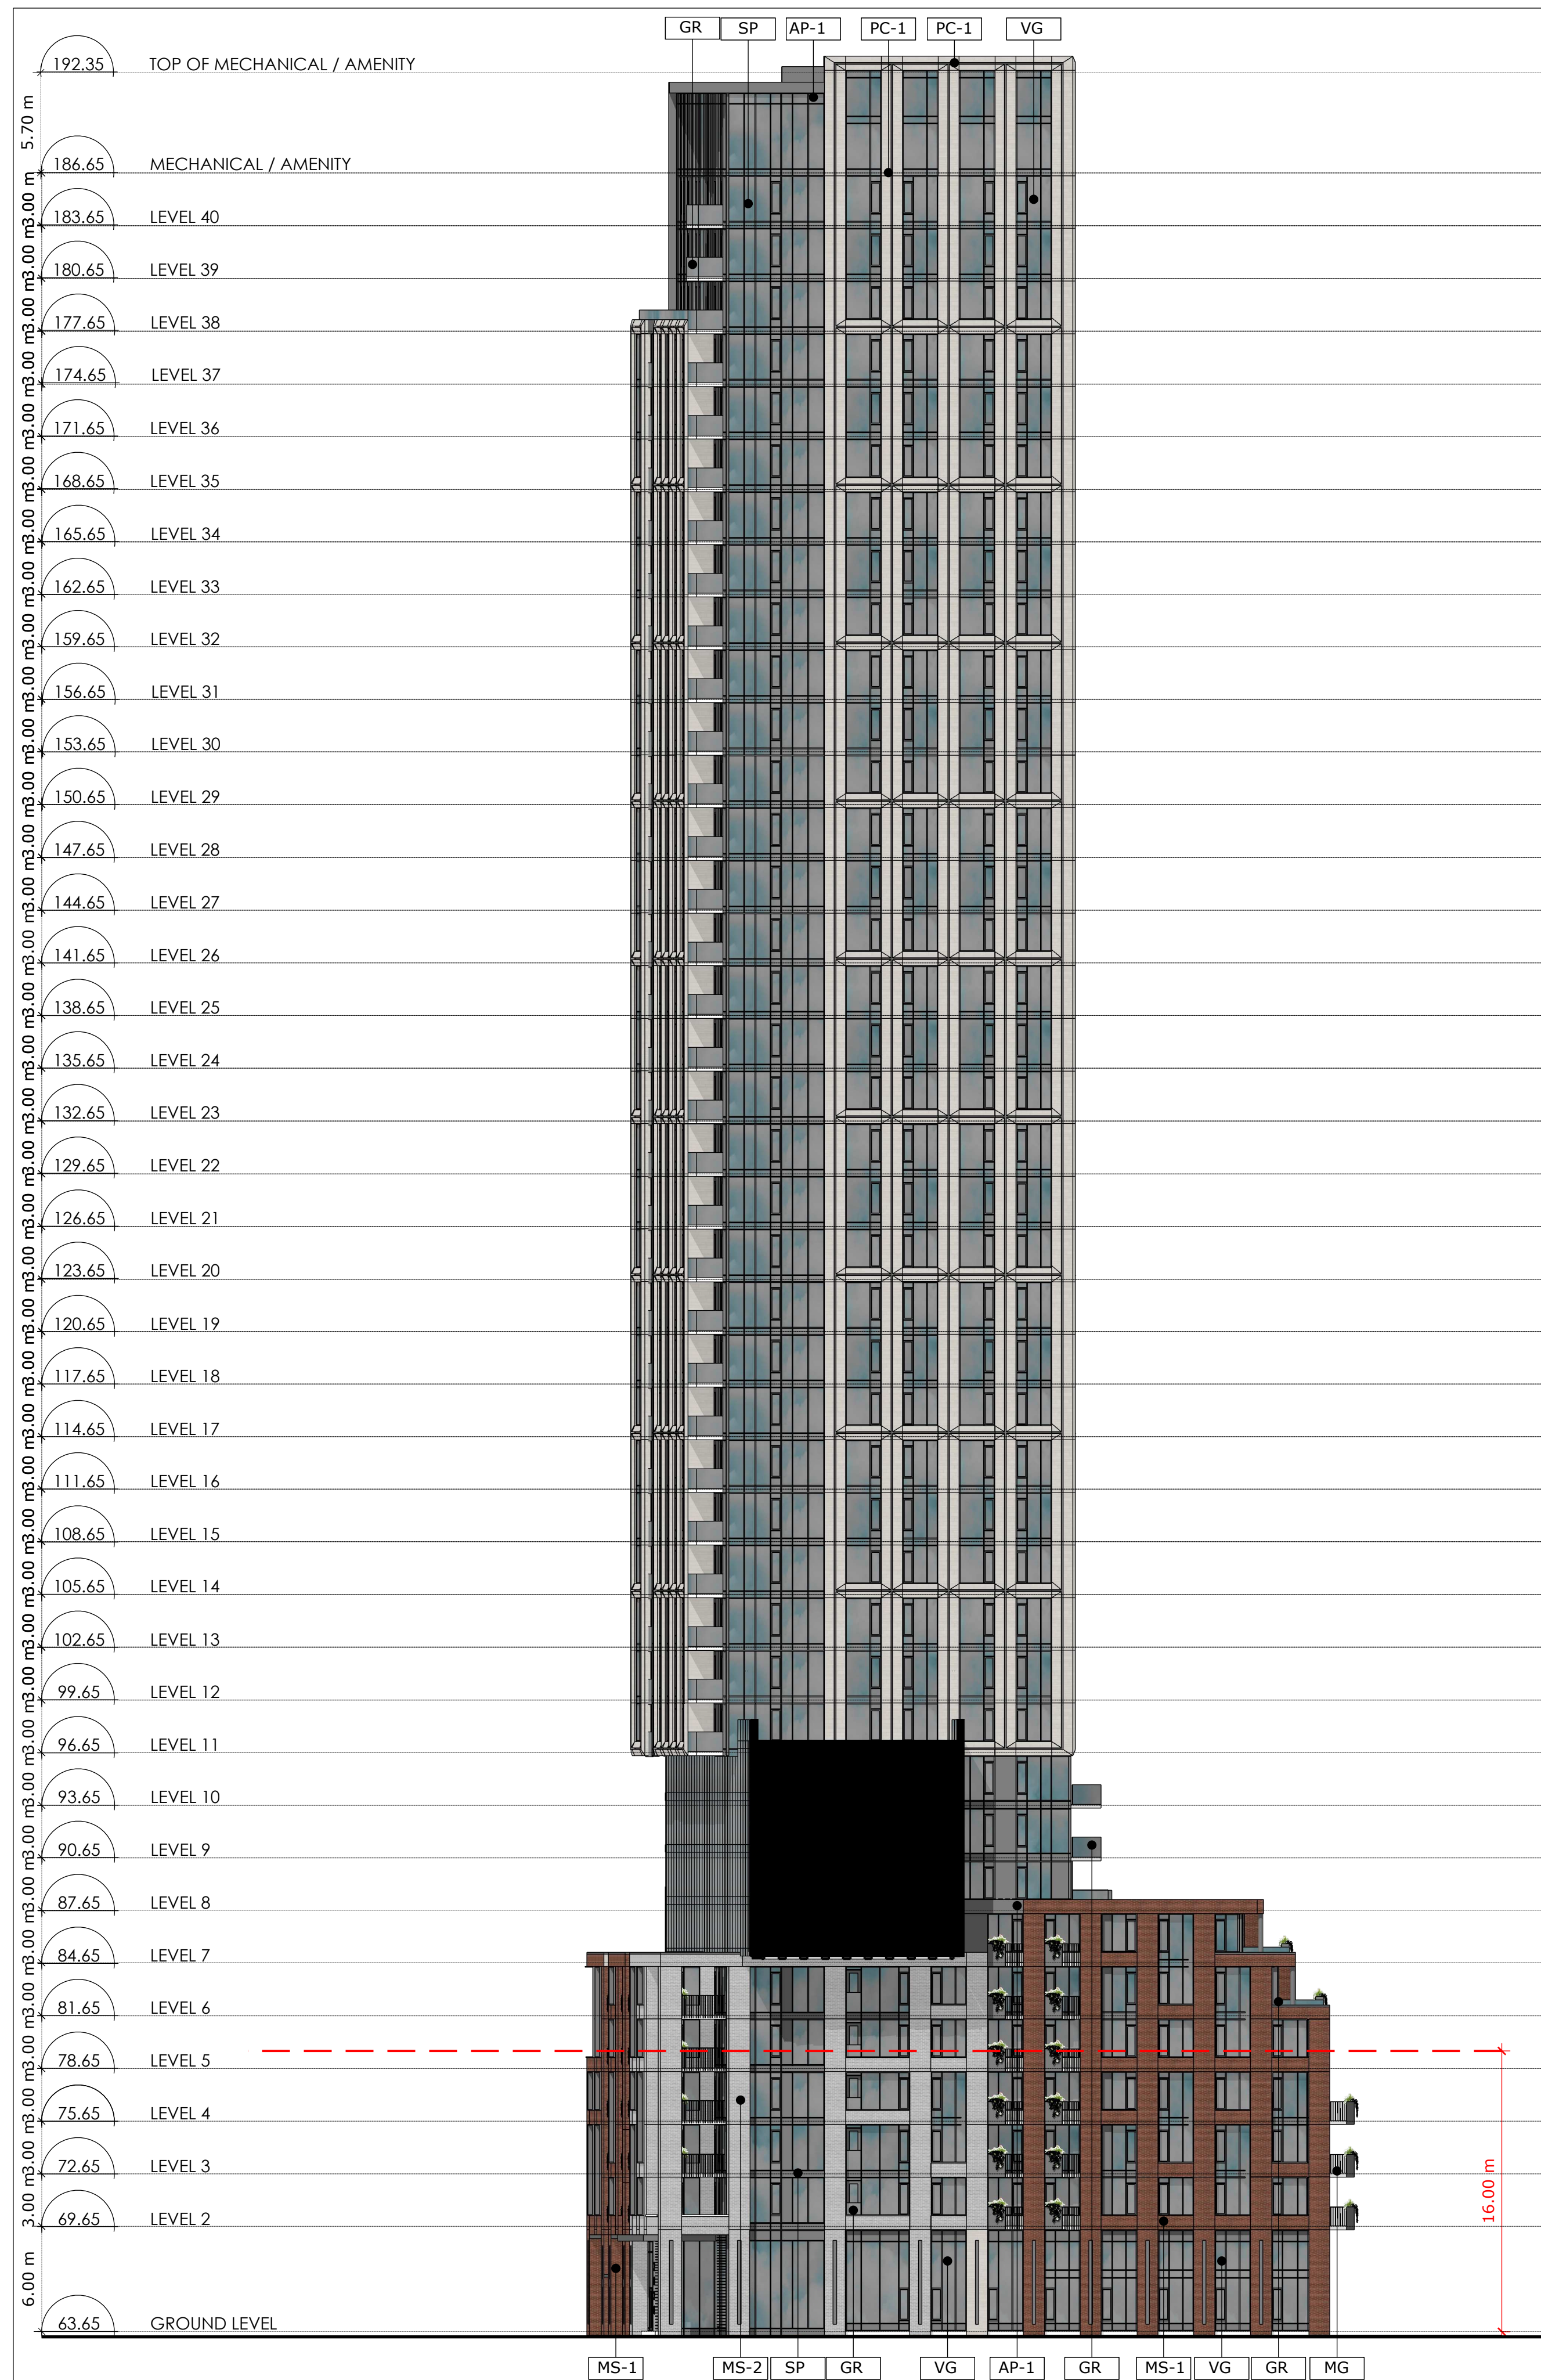
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PROJECT/LOCATION:
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 2006, 2020 & 2026 SCOTT STREET

DRAWING TITLE:
 EAST ELEVATION - EAST BUILDING
 WEST ELEVATION - WEST BUILDING

DRAWN BY: PB/KM **DATE:** 230222 **SCALE:** 1:250

PROJECT: 1937
DRAWING NO.: A3-02
REVISION NO.:



1 WEST ELEVATION - EAST BUILDING
A3.00 Scale: 1: 250

2 EAST ELEVATION - WEST BUILDING
A3.00 Scale: 1: 250



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WIND FRIENDLY GLASS: AS PER CITY WIND SAFETY GUIDELINES OUTLINE 2, TYPING IN 30 MINUTE CLASSIFICATION FOR WIND SPEEDS UP TO 100 KM/H. GLASS PROVIDED FOR LOW RISE STRUCTURES ONLY. 1.4 GLASS PROVIDED FOR BALCONY RAILINGS ON LEVEL 4. 2. GLASS PROVIDED FOR ALL BALCONY RAILINGS ON ROOF TERRACE LEVELS.

no.	date	revision
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1	22-04-07	ISSUED FOR REZONING

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PROJECT/LOCATION:
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2006, 2020 & 2026 SCOTT STREET

DRAWING TITLE:
WEST ELEVATION - EAST BUILDING
EAST ELEVATION - WEST BUILDING

DRAWN BY: DATE: SCALE:
PB/KM 230222 1:250

PROJECT:
1937

DRAWING NO.:
A3-03

REVISION NO.:

