
# 200/201 FRIEL STREET

200/201, FRIEL STREET OTTAWA, ONTARIO **ISSUED FOR** Rezoning and Site Plan Control - Resubmission #1 18 MAY 2023

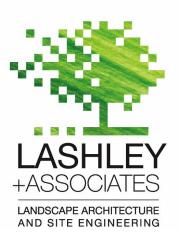


202-950 GLADSTONE AVENUE OTTAWA, ON K1Y 3E6 T 613 233 8579 F 613 233 4051 W LashleyLA.com E Mail@LashleyLA.c



# DRAWING INDEX

**TREE PROTECTION PLAN TP -1 DEMOLITION PLAN D1-1** LANDSCAPE PLAN L1-1 LANDSCAPE PLAN POPS AREA L1-2 PLANTING PLAN L1-3 DETAILS L2-1 DETAILS L2-2

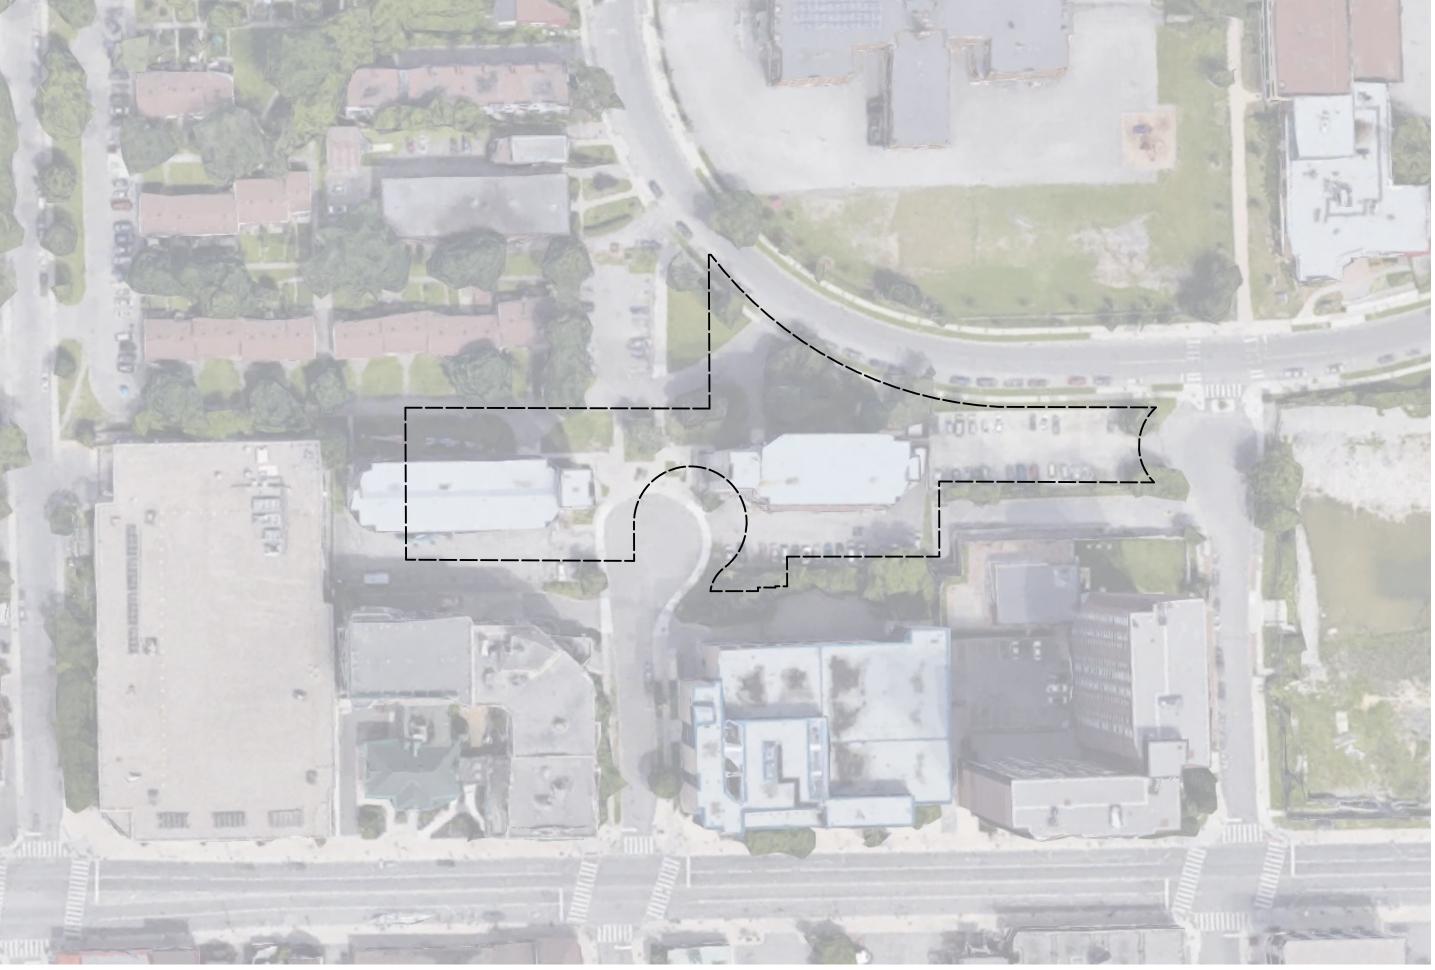

KEY PLAN






1 TREE PROTECTION PLAN
TP-01 Scale: 1:150
LEGEND
PropertyLine
Building Line
———— — Tree Protection Line
ID: Multiple values
Action: Remove
ID: Multiple values
Action: Retain


			1				
ID	Botanical Name	Common Name	DBH	Condition	Action	Location	Notes
E01	Ulmus pumila	Siberian Elm	0.424	Average	Remove	Project Property	
E02	Ulmus pumila	Siberian Elm	0.418	Poor	Remove	Project Property	
E03	Ulmus pumila	Siberian Elm	0.205	Poor	Remove	Project Property	Entwined in fence
E04	Acer negundo	Manitoba Maple	0.3	Poor	Remove	Adjacent Property	Entwined in fence
E05	Acer negundo	Manitoba Maple	0.22	Poor	Remove	Adjacent Property	Entwined in fence
E06	Acer negundo	Manitoba Maple	0.17	Good	Remove	Adjacent Property	
E07	Celtis occidentalis	Hackberry	0.11	Good	Remove	Project Property	
E08	Celtis occidentalis	Hackberry	0.19	Good	Remove	City of Ottawa Property	
E09	Pinus nigra	Austrian Pine	0.46	Good	Remove	Project Property	
E10	Pinus nigra	Austrian Pine	0.43	Good	Remove	Project Property	
E11	Tilia cordata	Little Leaf Linden	0.33	Good	Retain	Project Property	
E12	Ulmus americana	American Elm	0.45	Good	Retain	Project Property	
E13	Celtis occidentalis	Hackberry	0.14	Poor	Remove	Project Property	
E14	Pinus nigra	Austrian Pine	0.34	Good	Retain	Project Property	
E15	Pinus nigra	Austrian Pine	0.42	Average	Retain	Project Property	
E16	Pinus nigra	Austrian Pine		Good	Retain	Project Property	
E17	Pinus nigra	Austrian Pine	0.379	Average	Retain	Project Property	
E18	Acer negundo	Manitoba Maple	0.266	Average	Remove	City of Ottawa Property	
E19	Tilia cordata	Little Leaf Linden	0.32	Good	Retain	City of Ottawa Property	

UNDISTUR <u>NOTES</u>: THE FOL BOTH 1. UND ROC CEN BRE 2. TRE BET 3. TUN 4. ENS OR T 5. ENS TRE 6. FLOU LOC 7. ALL CON 8. EXP 9. REM 10. THE ALL

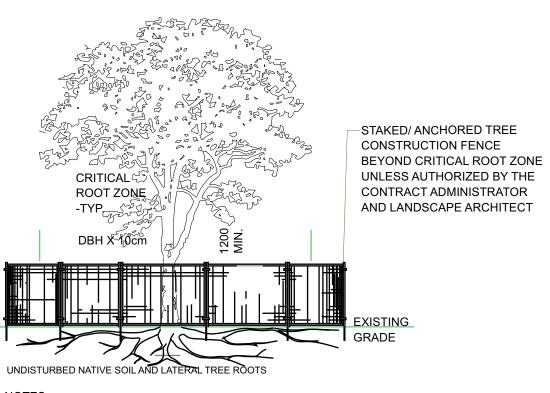

THE FOLLOWING PROTECTION MEASURES MUST BE IMPLEMENTED FOR RETAINED TREES, BOTH WITHIN THE WORK AREA AND ON ADJACENT PARCELS.

- UNDER THE GUIDANCE OF AN ARBORIST, ERECT A MODULAR FENCE AT THE CRITICAL ROOT ZONE (CRZ) OF TREES WHERE THE CRZ IS ESTABLISHED AS BEING 10 CENTIMETERS FROM THE TRUNK FOR EVERY CENTIMETER OF TRUNK DIAMETER AT BREAST HEIGHT.
- TREE PROTECTION SHALL BE ERECTED TO PROVIDE A CONTINUOUS BARRICADE BETWEEN DESIGNATED TREES AND THE WORK AREA PRIOR TO CONSTRUCTION.
   TUNNEL OR BORE WHEN DIGGING WITHIN THE CRZ OF A TREE.
   ENSURE ALL EQUIPMENT AND CONSTRUCTION RELATED MATERIAL ARE NOT PLACED
- OR TEMPORARILY STORED WITHIN THE CRZ.
  5. ENSURE EXHAUST FUMES FROM ALL EQUIPMENT ARE NOT DIRECTED TOWARDS ANY TREE'S CANOPY.
- FLOODING OR DEPOSITION OF SEDIMENT SHALL BE PREVENTED WHERE TREES ARE LOCATED.
   ALL DISTURBED ROOT SYSTEMS SHALL BE EXPOSED AND BACKFILLED IN ONE
- CONTINUOUS OPERATION TO MINIMIZE DESICCATION.
  8. EXPOSED ROOTS SHALL BE KEPT CONTINUOUSLY MOIST DURING EXCAVATION.
  9. REMOVE BROKEN AND DAMAGED ROOTS WITH SHARP PRUNING SHEARS.
  10. THE TREE PROTECTION MODULAR FENCE IS TEMPORARY, SHALL BE MAINTAINED AT ALL TIMES DURING
- CONSTRUCTION OPERATIONS, AND SHALL BE REMOVED UPON COMPLETION OF WORK WHEN AGREED TO BY THE CONTRACT ADMINISTRATOR AND LANDSCAPE ARCHITECT.

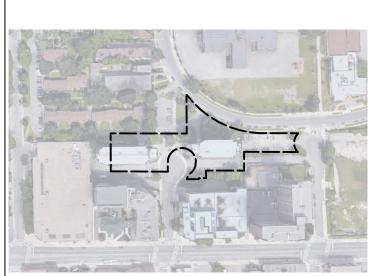

KEY PLAN, NTS

## LANDSCAPE NOTES

 All general site information and conditions compiled from architect's and engineer's plans and surveys.
 Do not scale this drawing.

3. Report any discrepancies prior to commencing work. No responsibility is born by the Landscape Architect for unknown subsurface conditions.

 Reinstate all areas and items damaged as a result of construction activities to the satisfaction of the Landscape Architect.

5. Drawing may not be used for construction until signed by Landscape Architect as issued for construction.

The accuracy of the position of utilities is not guaranteed.
 Individual utility co. must be contacted for confirmation of

utility existence and location prior to digging.

8. This drawing is an instrument of service and requires the permission of the Landscape Architect for use. Copyright is reserved by the Landscape Architect, David M. Lashley.


9. Plant material shall be No.1 Grade and shall comply with the Metric Guide Specifications for Nursery stock (latest edition), published by Canadian Nursery Trades Association.

10. Plant substitutions shall not be permitted unless approved by the Landscape Architect.

11. Obtain approval of planting prior to digging.

12. Topsoil shall be garden sirl mixture sandy loam with min.
5% organic matter and peat moss added at ratio of 1:10, topsoil to be approved by Landscape Architect.

CLIENT:

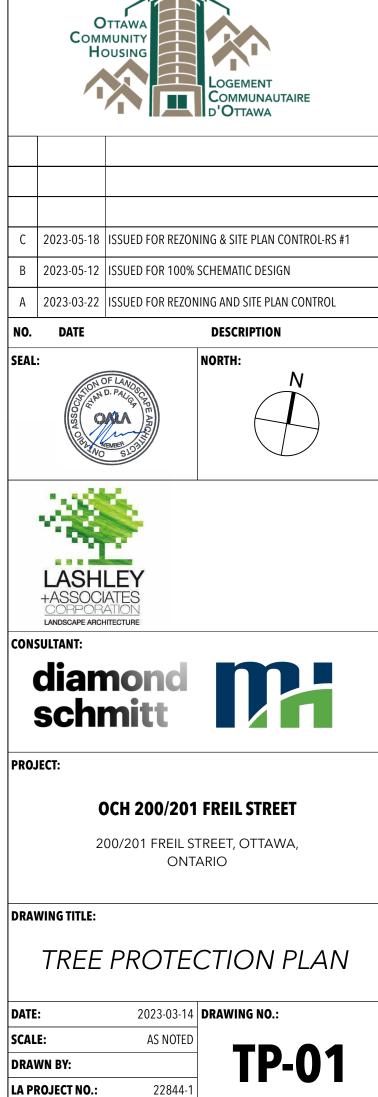

D07-12-23-0034




$\begin{pmatrix} 1 \end{pmatrix}$	DEMOLITION PLAN
D1-1	Scale: 1:150

LEGEND

PropertyLine
Building Line
Fence Line
ID: Multiple values Action: Remove

ID: Multiple values Action: Retain

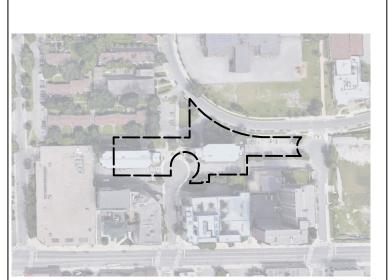

KEY PLAN, NTS

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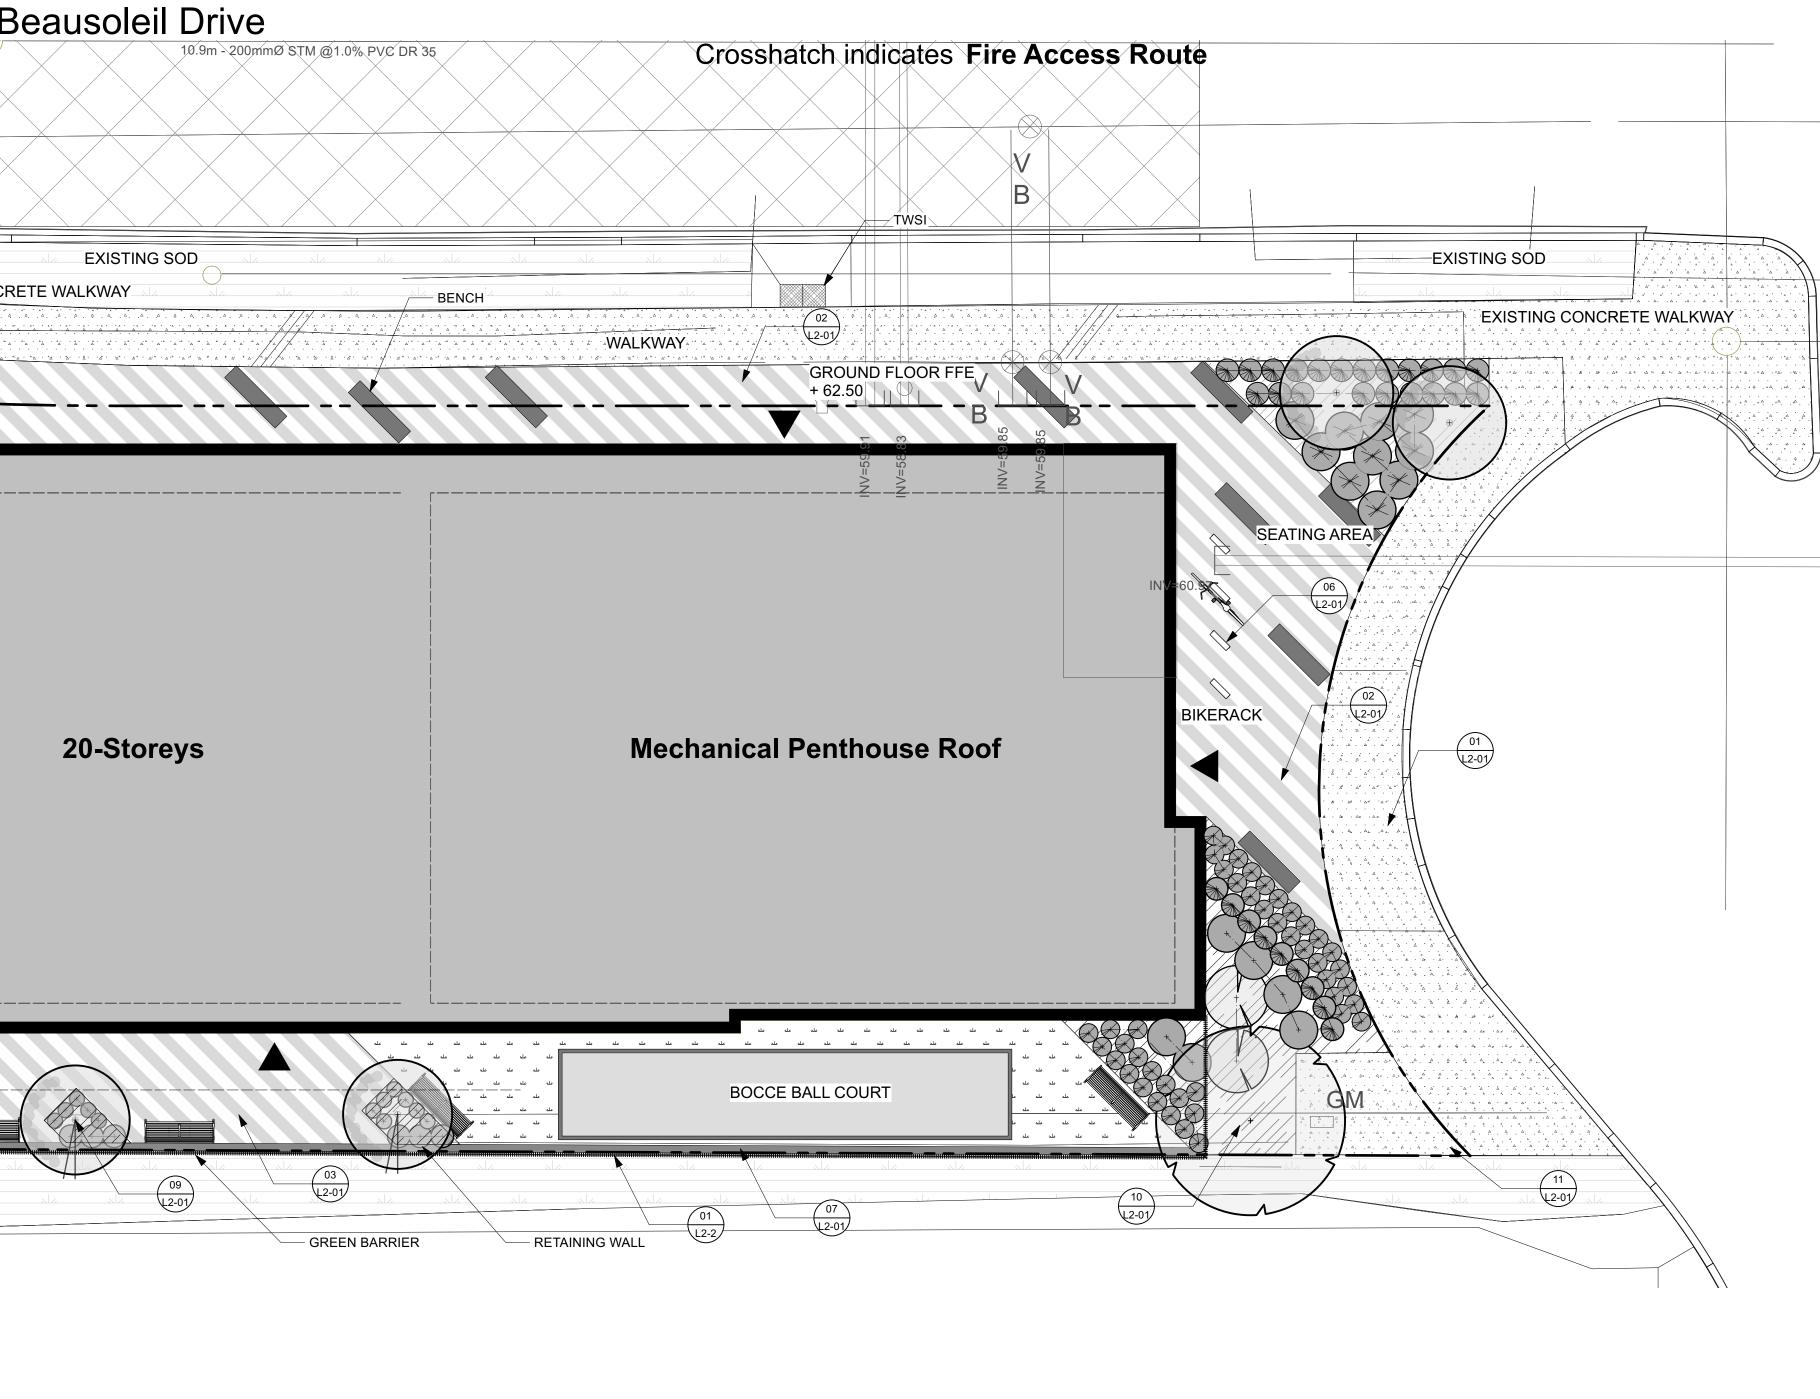
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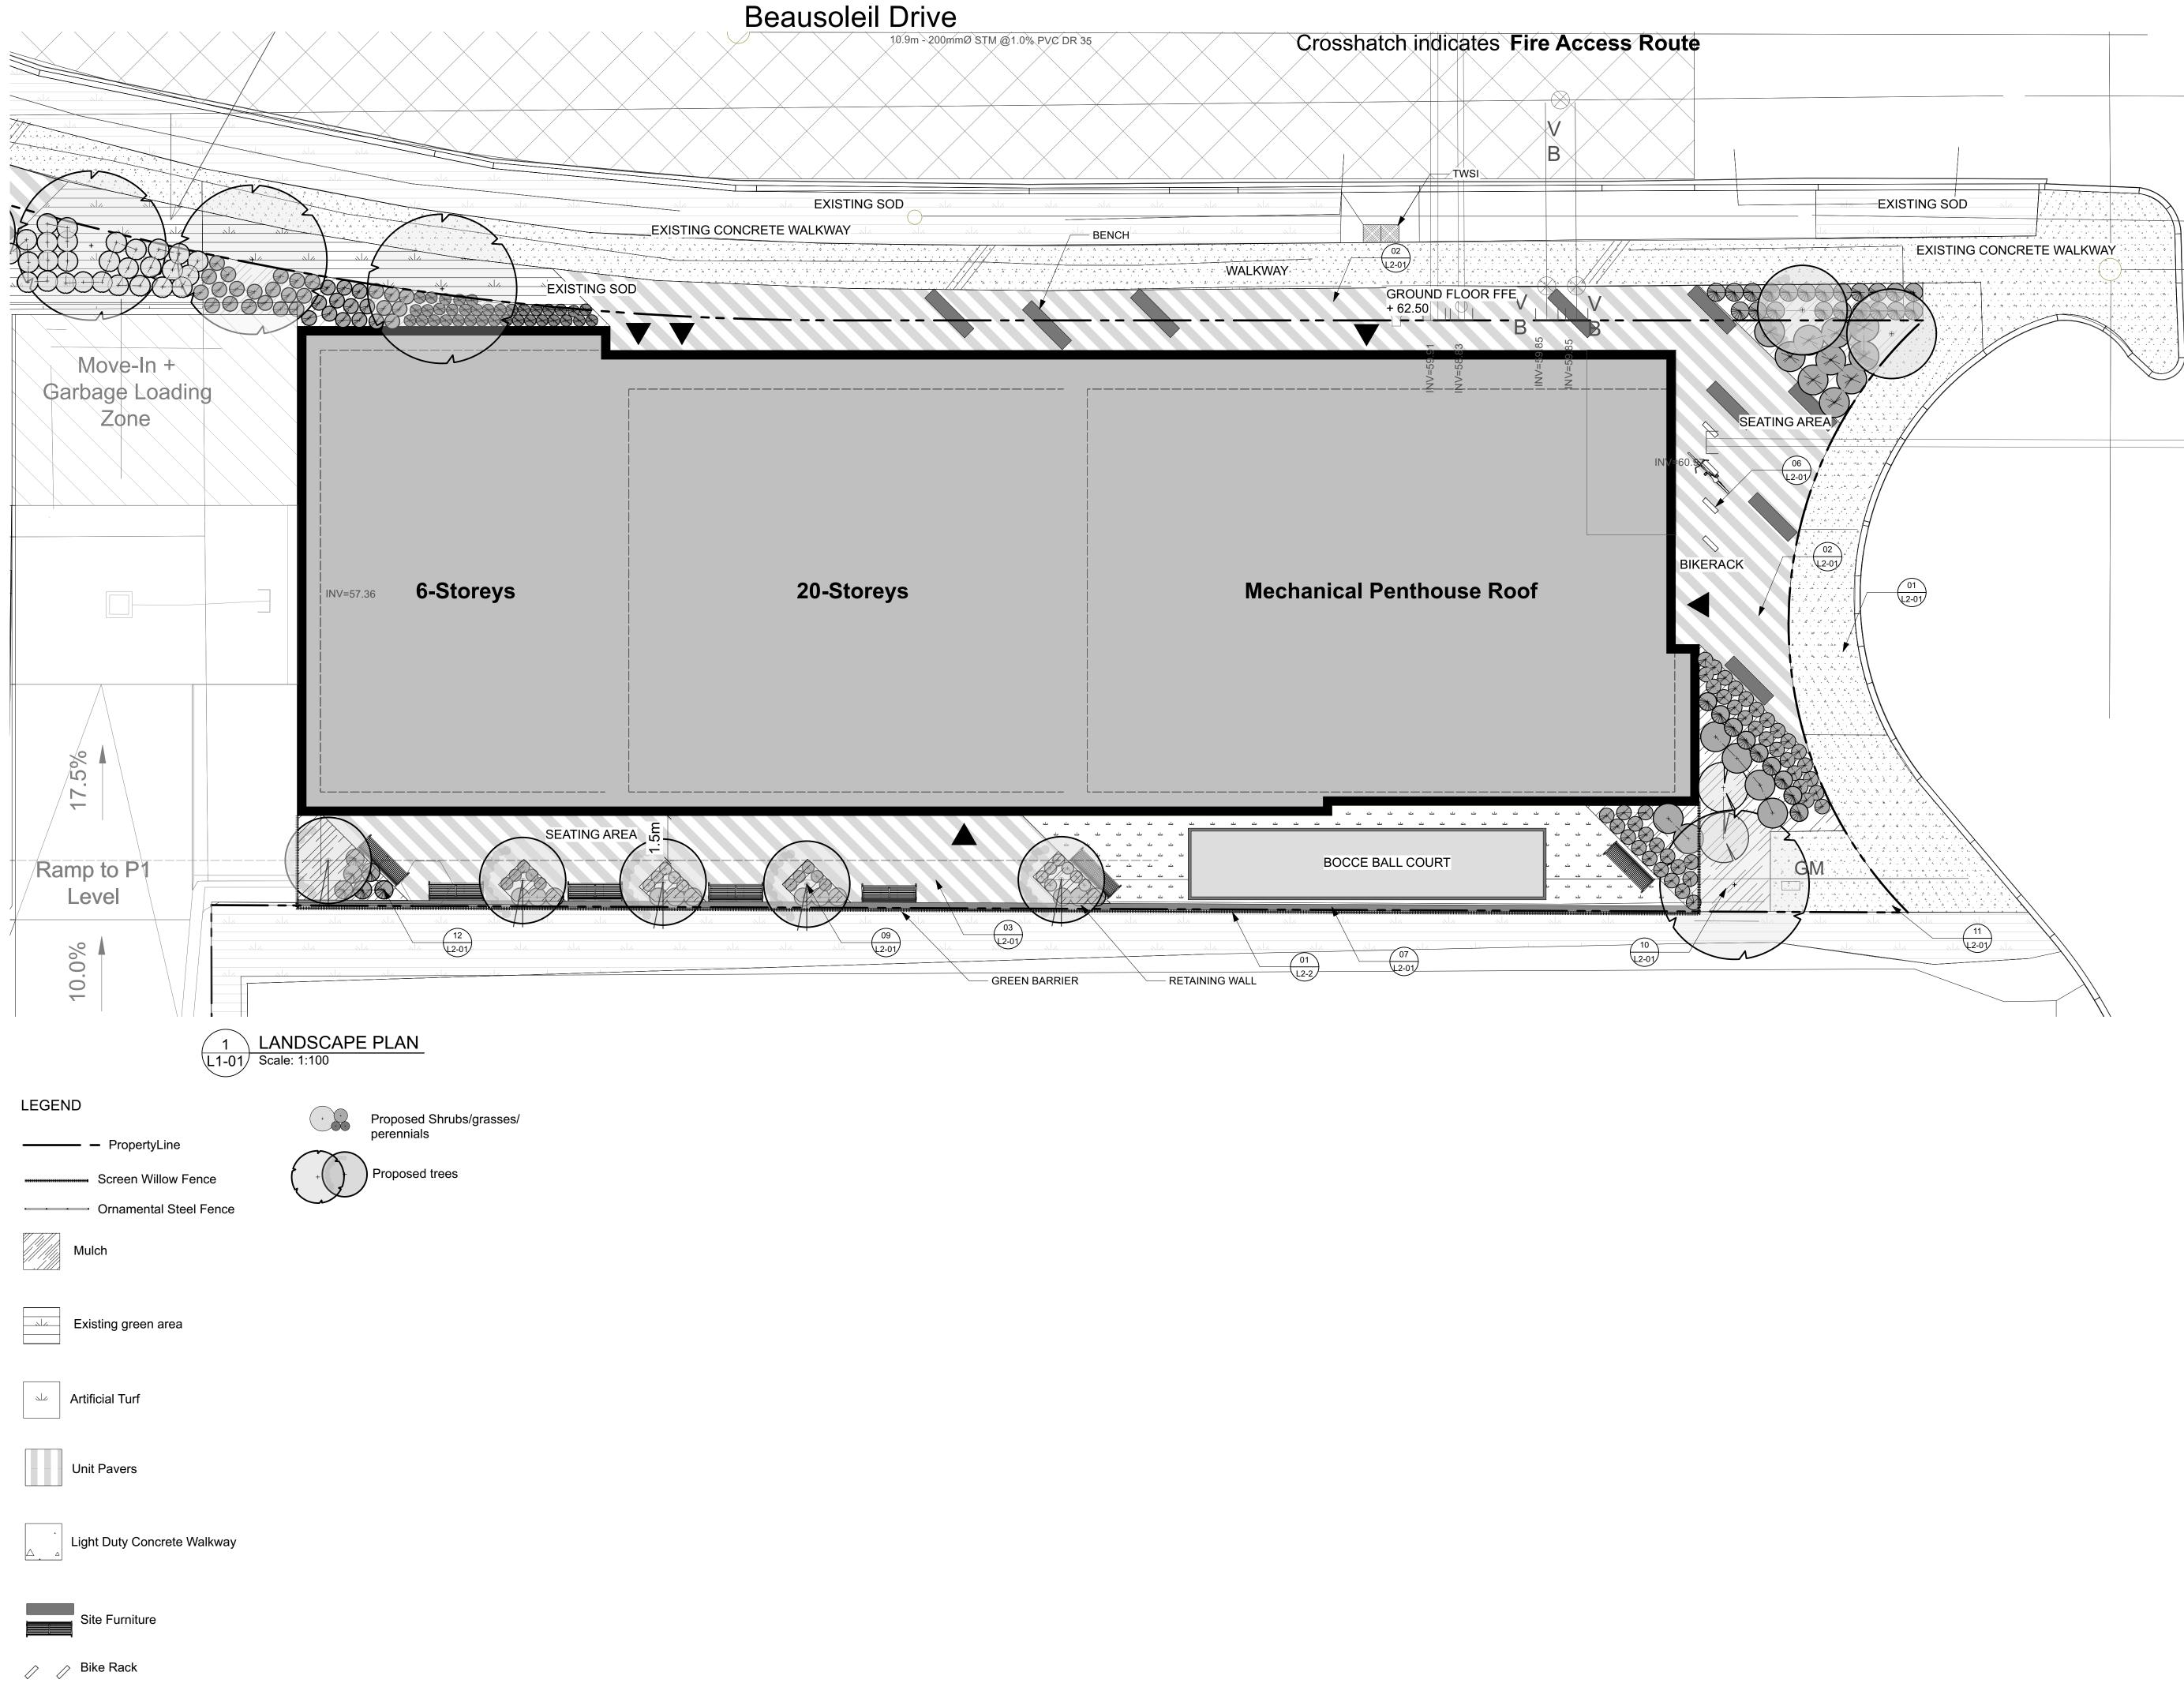
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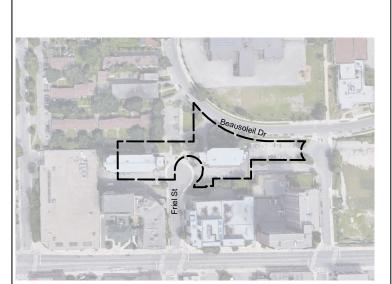
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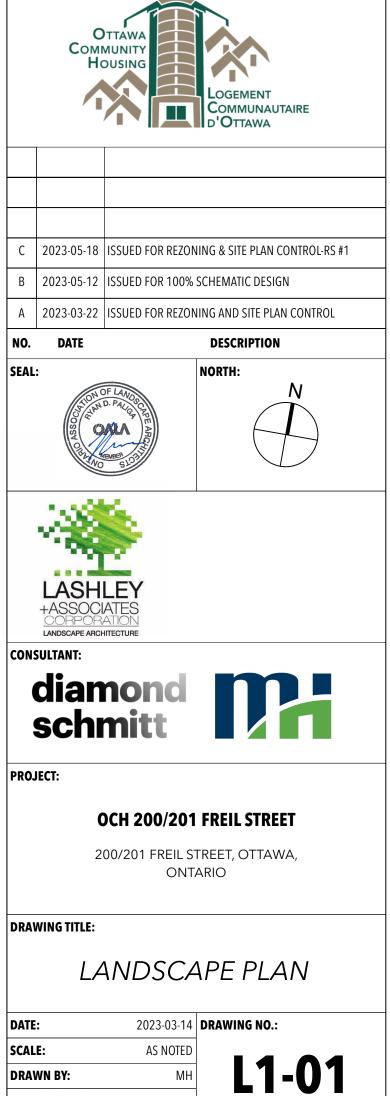
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CLIENT:

**DRAWN BY:** 


LA PROJECT NO.:



MH

D07-12-23-0034


22844-1

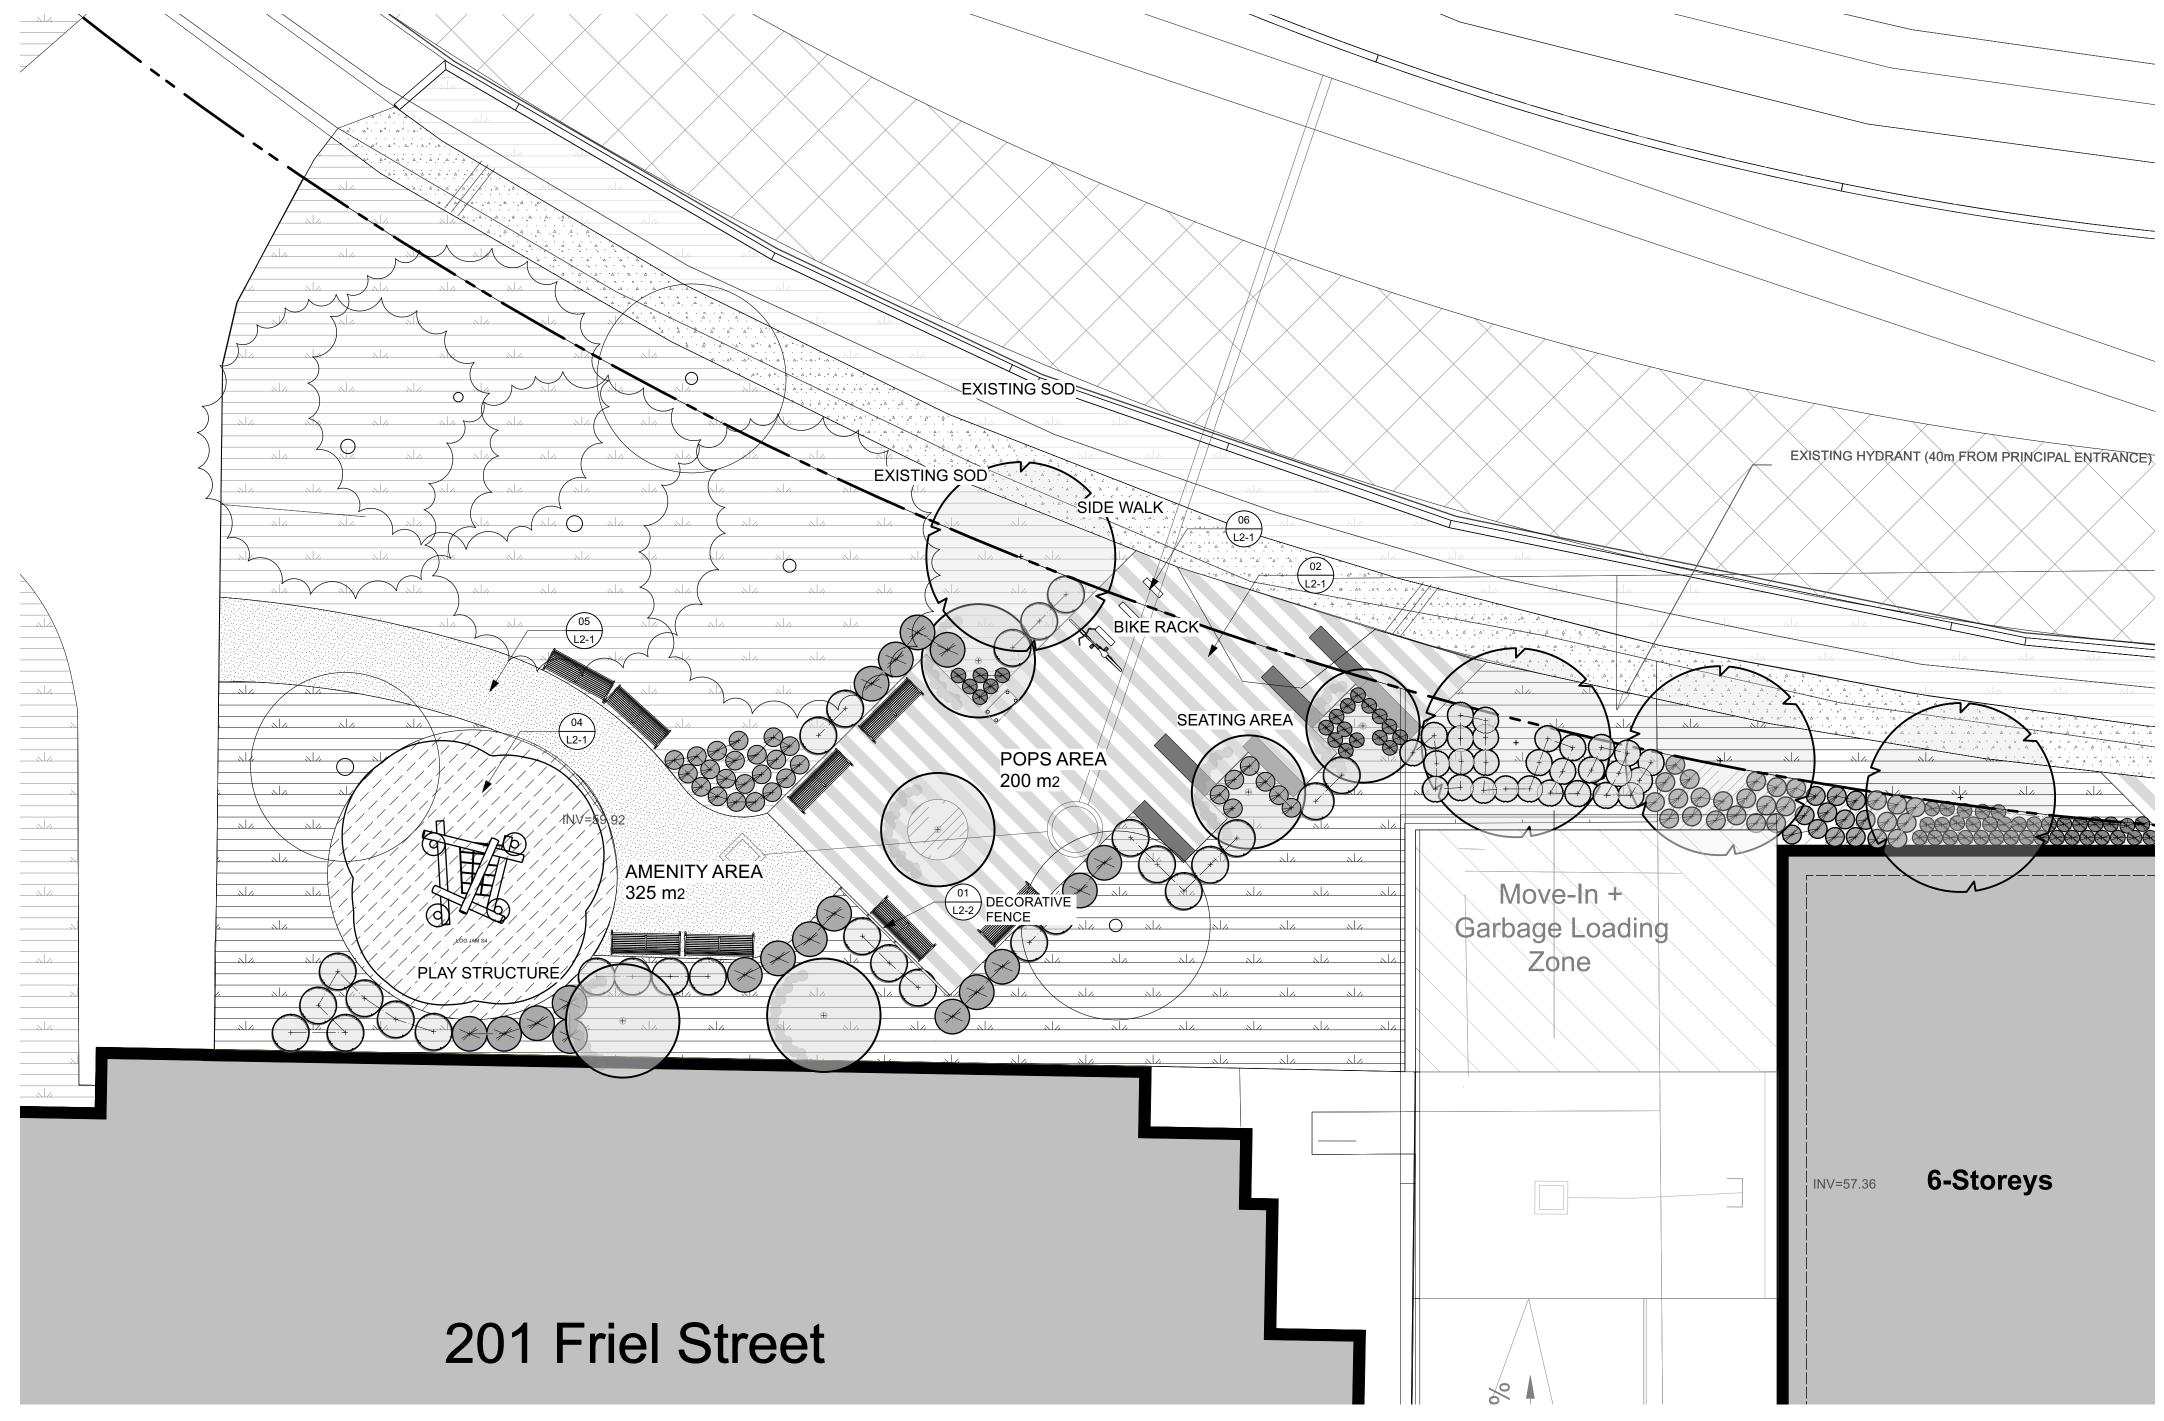







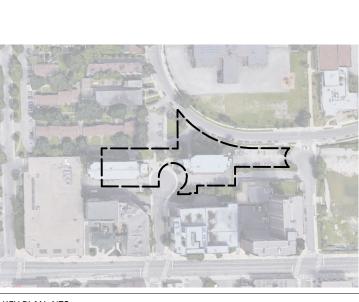

KEY PLAN, NTS

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CLIENT:



2023-05-18 ISSUED FOR REZONING & SITE PLAN CONTROL-RS #1

B 2023-05-12 ISSUED FOR 100% SCHEMATIC DESIGN

A 2023-03-22 ISSUED FOR REZONING AND SITE PLAN CONTROL

DESCRIPTION

NORTH:

NO. DATE







PROJECT:


# OCH 200/201 FREIL STREET

200/201 FREIL STREET, OTTAWA, ONTARIO

DRAWING TITLE:


LANDSCAPE PLAN-POPS 2023-03-14 **DRAWING NO.:** DATE: SCALE: AS NOTED L1-02 **DRAWN BY:** MH LA PROJECT NO.: 22844-1

D07-12-23-0034

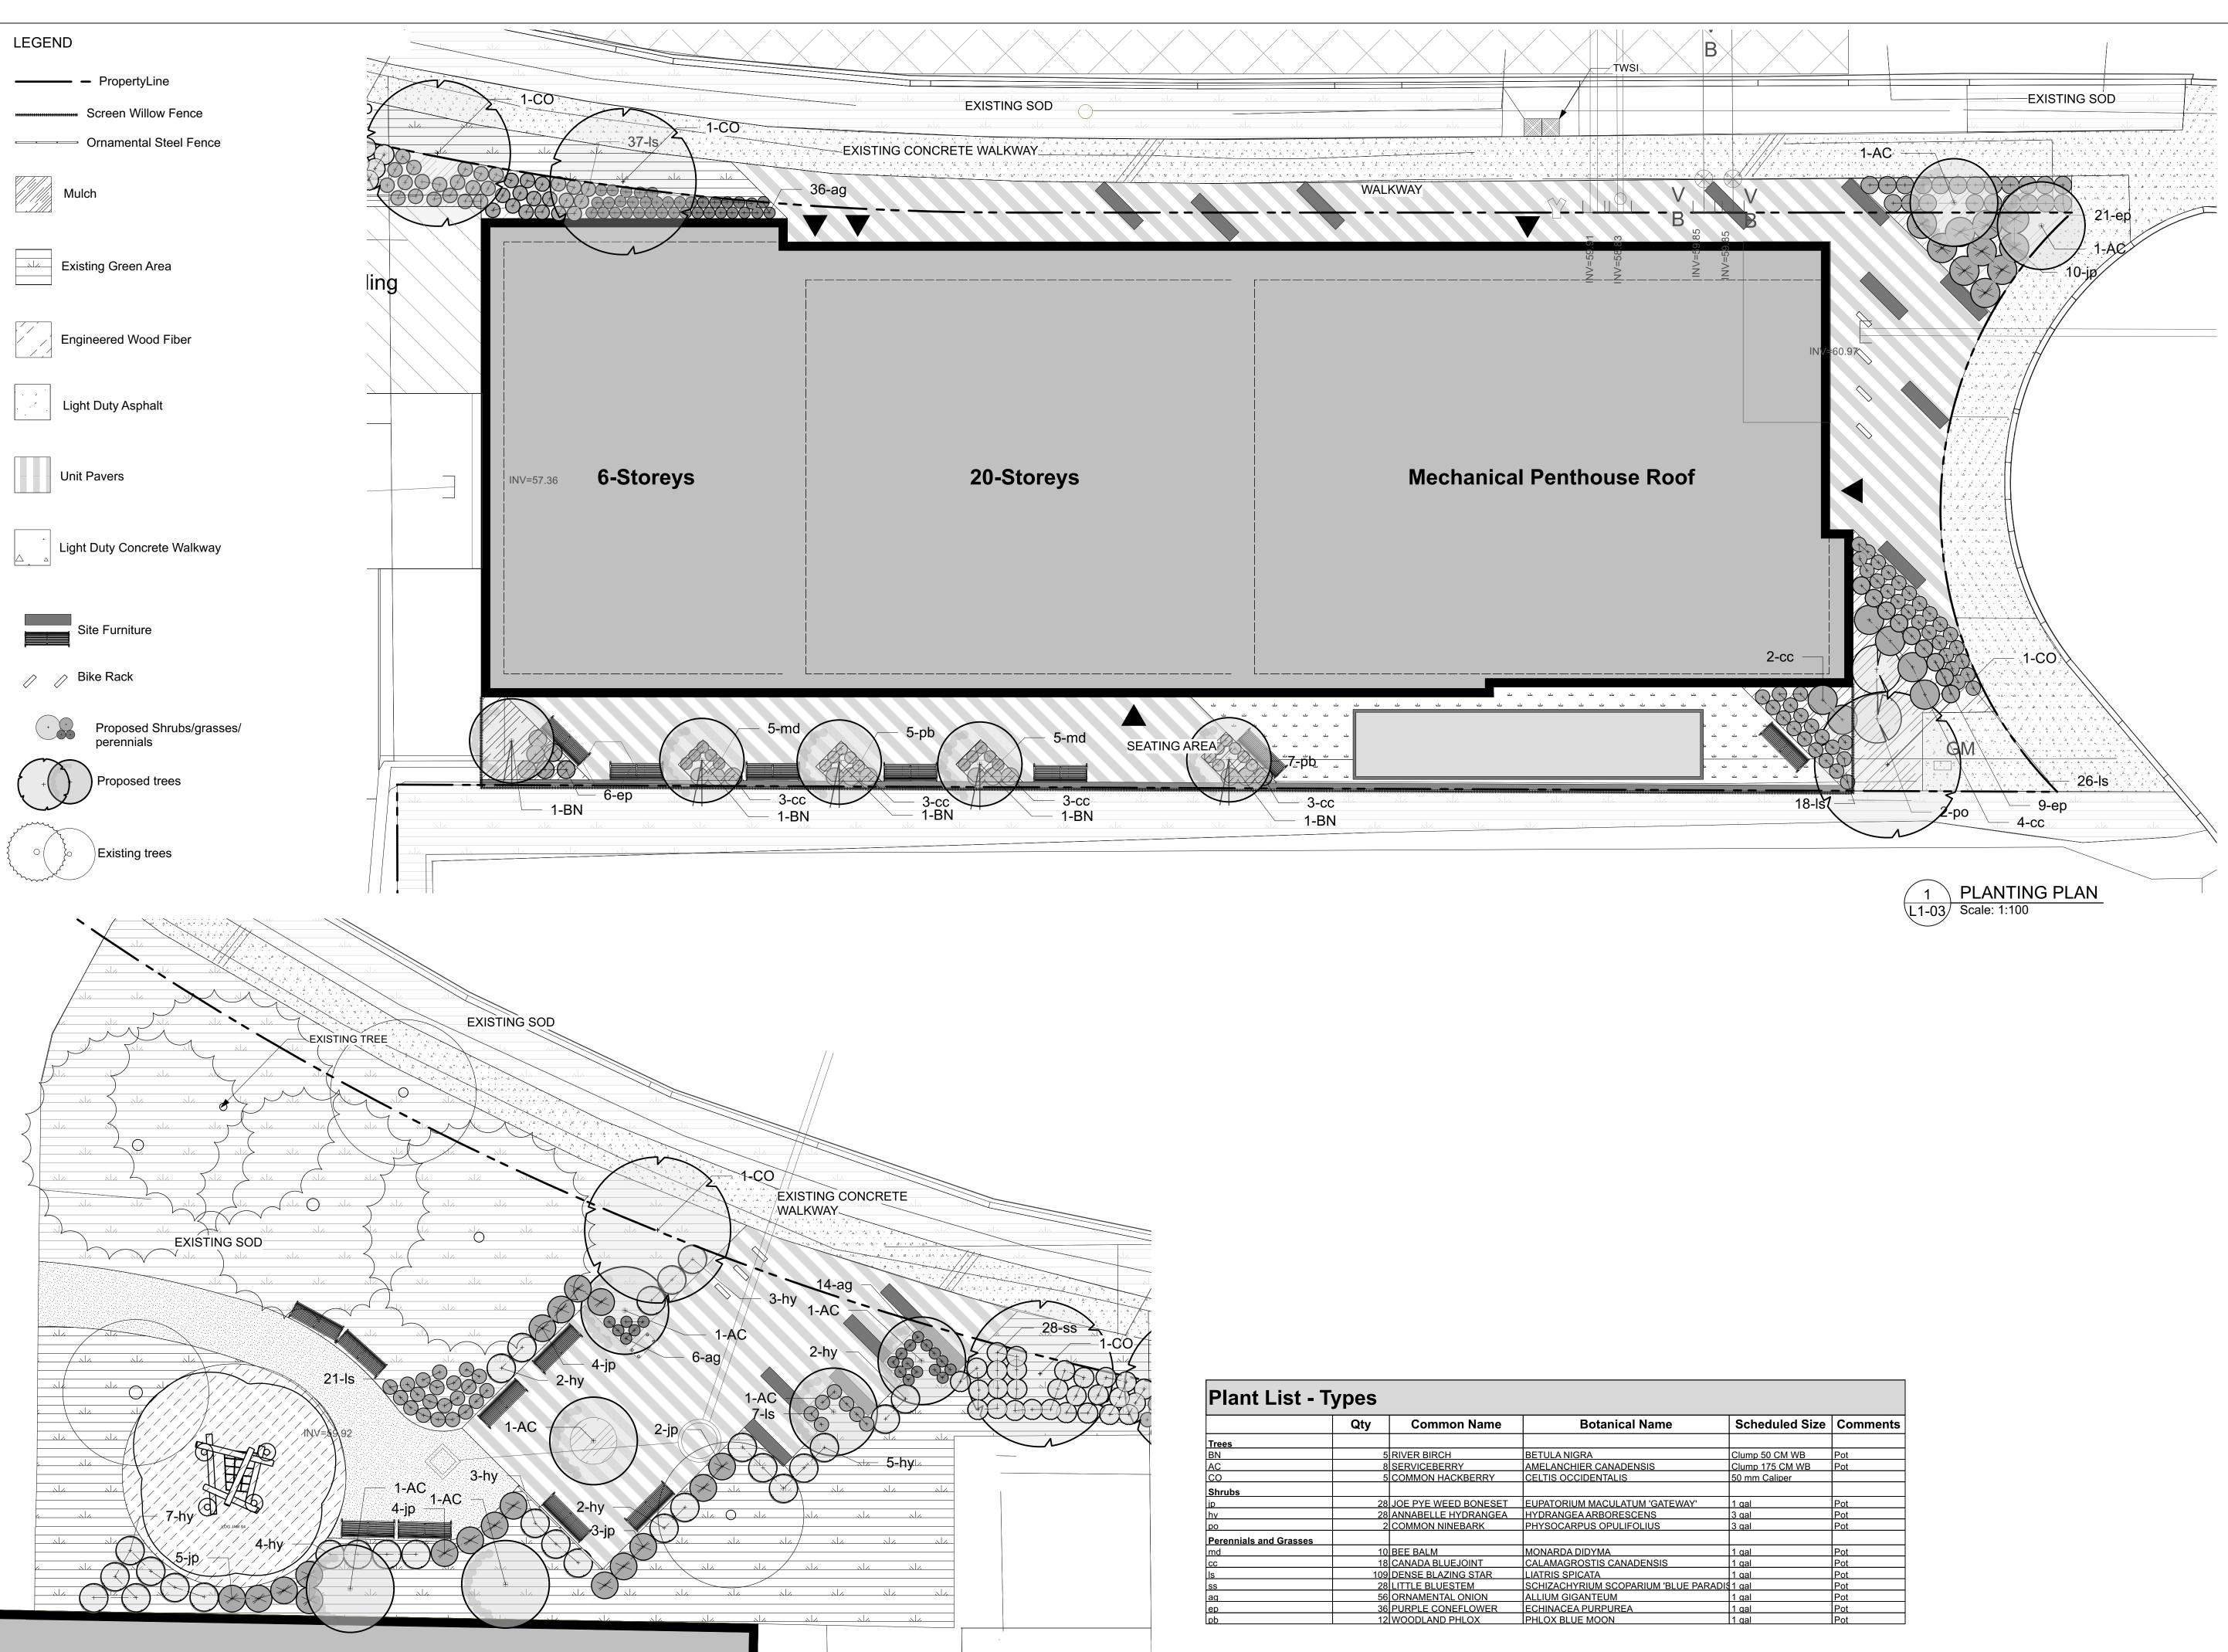



Plant List - Types						
	Qty	Common Name	Botanical Name	Scheduled S		
Trees						
BN	5	RIVER BIRCH	BETULA NIGRA	Clump 50 CM WB		
AC	8	SERVICEBERRY	AMELANCHIER CANADENSIS	Clump 175 CM WE		
со	5	COMMON HACKBERRY	CELTIS OCCIDENTALIS	50 mm Caliper		
Shrubs						
ip	28	JOE PYE WEED BONESET	EUPATORIUM MACULATUM 'GATEWAY'	1 gal		
hy	28	ANNABELLE HYDRANGEA	HYDRANGEA ARBORESCENS	3 gal		
ро	2	COMMON NINEBARK	PHYSOCARPUS OPULIFOLIUS	3 gal		
Perennials and Grasses						
md	10	BEE BALM	MONARDA DIDYMA	1 gal		
сс	18	CANADA BLUEJOINT	CALAMAGROSTIS CANADENSIS	1 gal		
ls	109	DENSE BLAZING STAR	LIATRIS SPICATA	1 gal		
SS	28	LITTLE BLUESTEM	SCHIZACHYRIUM SCOPARIUM 'BLUE PARADIS	1 gal		
ag	56	ORNAMENTAL ONION	ALLIUM GIGANTEUM	1 gal		
ер	36	PURPLE CONEFLOWER	ECHINACEA PURPUREA	1 gal		
da	12	WOODLAND PHLOX	PHLOX BLUE MOON	1 gal		

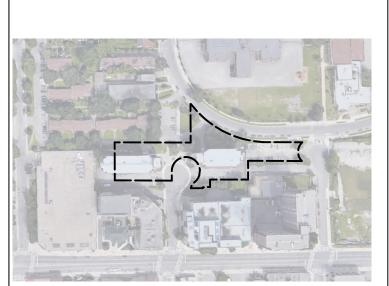

KEY PLAN, NTS

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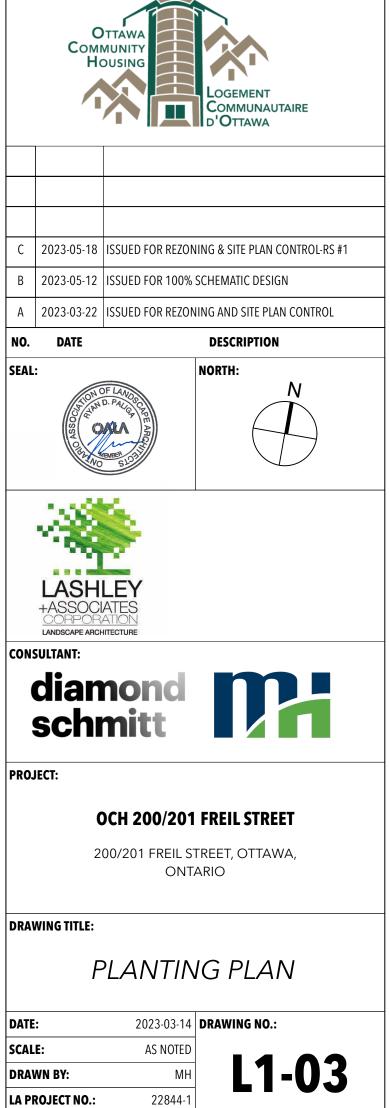
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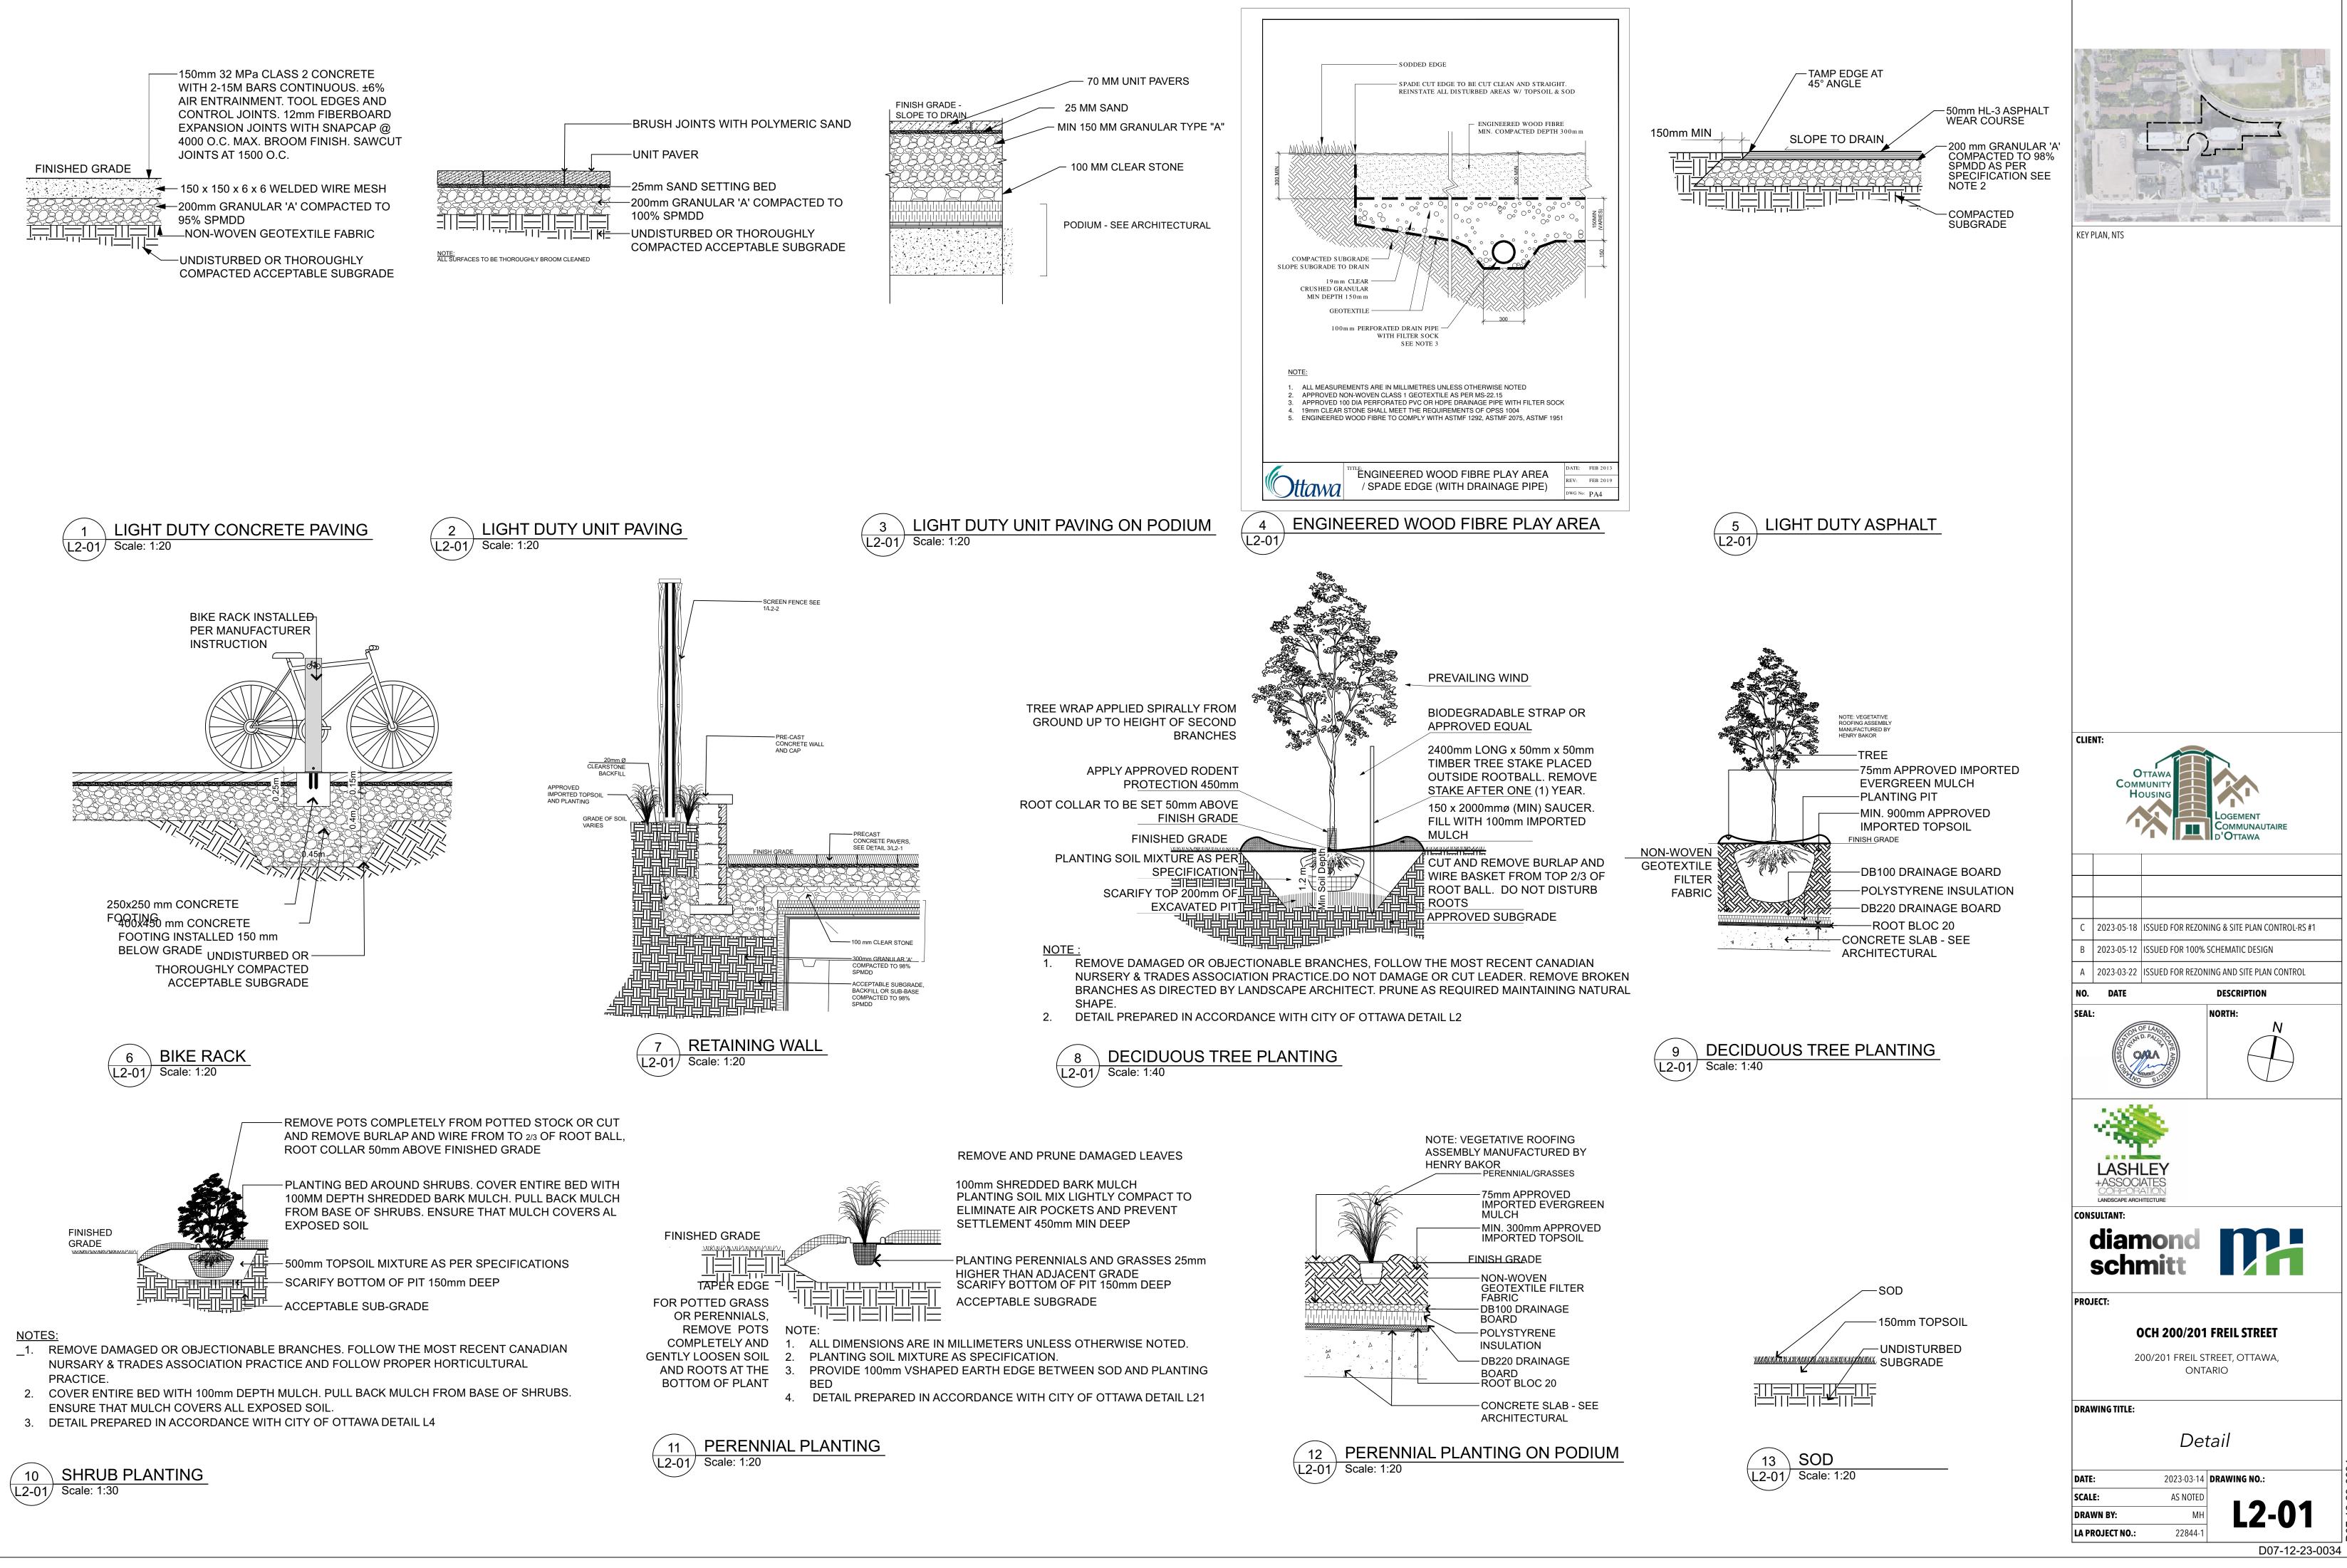
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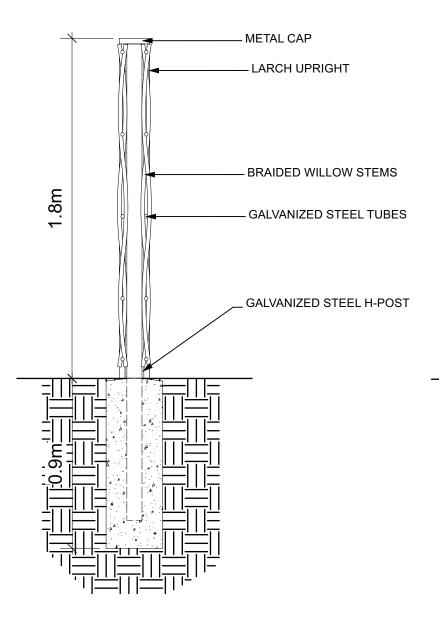
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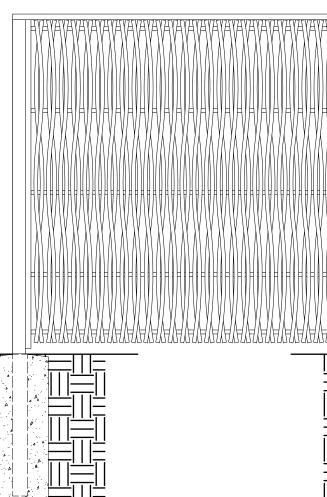


D07-12-23-0034











1 SCREEN WILLOW FENCE L2-02 Scale: 1:20

METAL CAP GALVANIZED STEEL H-POST GALVANIZED STEEL TUBES				KETS
BRAIDED WILLOW STEMS		1.2m		
BRAIDED WILLOW STEMS	FINISHED GRAD			CRETE, ± 6%

2 ORNAMENTAL STEEL FENCE L2-02 Scale: 1:20

