200/201 FRIEL STREET



202-950 GLADSTONE AVENUE OTTAWA, ON K1Y 3E6 T 613 233 8579 F 613 233 4051 W LashleyLA.com Mail@LashlevLA



200/201, FRIEL STREET OTTAWA, ONTARIO **ISSUED FOR** SITE PLAN CONTROL-RESUBMISSION 11 DECEMBER 2023

DRAWING INDEX

TREE PROTECTION PLAN TP -1 DEMOLITION PLAN D1-1 LANDSCAPE PLAN L1-1 LANDSCAPE PLAN POPS AREA L1-2 PLANTING PLAN L1-3 DETAILS L2-1 DETAILS L2-2



KEY PLAN






| TP-01 Scale: 1:150 |
|--|
| LEGEND |
| PropertyLine |
| Building Line |
| |
| —————————————————————————————————————— |
| ID: Multiple values Action: Remove |
| ID: Multiple values |
| Action: Retain |

1

| ID | Botanical Name | Common Name | DBH | Condition | Action | Location | Notes |
|------------|-----------------------|--------------------|-------|-----------|--------|-------------------------|-------------------|
| E01 | Ulmus pumila | Siberian Elm | 0.424 | Average | Remove | Project Property | |
| E02 | Ulmus pumila | Siberian Elm | 0.418 | Poor | Remove | Project Property | |
| E03 | Ulmus pumila | Siberian Elm | 0.205 | Poor | Remove | Project Property | Entwined in fence |
| E04 | Acer negundo | Manitoba Maple | 0.3 | Poor | Remove | Adjacent Property | Entwined in fence |
| E05 | Acer negundo | Manitoba Maple | 0.22 | Poor | Remove | Adjacent Property | Entwined in fence |
| E06 | Acer negundo | Manitoba Maple | 0.17 | Good | Remove | Adjacent Property | |
| E07 | Celtis occidentalis | Hackberry | 0.11 | Good | Remove | Project Property | |
| E08 | Celtis occidentalis | Hackberry | 0.19 | Good | Remove | City of Ottawa Property | |
| E09 | Pinus nigra | Austrian Pine | 0.46 | Good | Remove | Project Property | |
| E10 | Pinus nigra | Austrian Pine | 0.43 | Good | Remove | Project Property | |
| <u>E11</u> | Tilia cordata | Little Leaf Linden | 0.33 | Good | Remove | Project Property | |
| E12 | Ulmus americana | American Elm | 0.45 | Good | Retain | Project Property | |
| E13 | Celtis occidentalis | Hackberry | 0.14 | Poor | Remove | Project Property | |
| E14 | Pinus nigra | Austrian Pine | 0.34 | Good | Retain | Project Property | |
| E15 | Pinus nigra | Austrian Pine | 0.42 | Average | Retain | Project Property | |
| E16 | Pinus nigra | Austrian Pine | 0.25 | Good | Retain | Project Property | |
| E17 | Pinus nigra | Austrian Pine | 0.379 | Average | Retain | Project Property | |
| E18 | Acer negundo | Manitoba Maple | 0.266 | Average | Remove | City of Ottawa Property | |
| E19 | Tilia cordata | Little Leaf Linden | 0.32 | Good | Retain | City of Ottawa Property | |

NOTES:

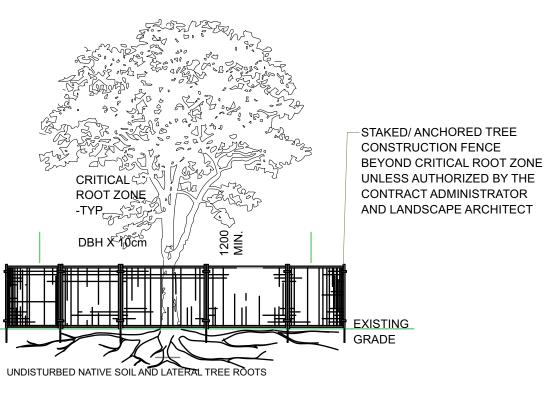

THE FOLLOWING PROTECTION MEASURES MUST BE IMPLEMENTED FOR RETAINED TREES, BOTH WITHIN THE WORK AREA AND ON ADJACENT PARCELS.

1. UNDER THE GUIDANCE OF AN ARBORIST, ERECT A MODULAR FENCE AT THE CRITICAL ROOT ZONE (CRZ) OF TREES WHERE THE CRZ IS ESTABLISHED AS BEING 10 CENTIMETERS FROM THE TRUNK FOR EVERY CENTIMETER OF TRUNK DIAMETER AT BREAST HEIGHT.


2. TREE PROTECTION SHALL BE ERECTED TO PROVIDE A CONTINUOUS BARRICADE BETWEEN DESIGNATED TREES AND THE WORK AREA PRIOR TO CONSTRUCTION. 3. TUNNEL OR BORE WHEN DIGGING WITHIN THE CRZ OF A TREE. 4. ENSURE ALL EQUIPMENT AND CONSTRUCTION RELATED MATERIAL ARE NOT PLACED

OR TEMPORARILY STORED WITHIN THE CRZ. 5. ENSURE EXHAUST FUMES FROM ALL EQUIPMENT ARE NOT DIRECTED TOWARDS ANY TREE'S CANOPY. 6. FLOODING OR DEPOSITION OF SEDIMENT SHALL BE PREVENTED WHERE TREES ARE

LOCATED. 7. ALL DISTURBED ROOT SYSTEMS SHALL BE EXPOSED AND BACKFILLED IN ONE

CONTINUOUS OPERATION TO MINIMIZE DESICCATION. 8. EXPOSED ROOTS SHALL BE KEPT CONTINUOUSLY MOIST DURING EXCAVATION. 9. REMOVE BROKEN AND DAMAGED ROOTS WITH SHARP PRUNING SHEARS. 10. THE TREE PROTECTION MODULAR FENCE IS TEMPORARY, SHALL BE MAINTAINED AT ALL TIMES DURING

CONSTRUCTION OPERATIONS, AND SHALL BE REMOVED UPON COMPLETION OF WORK WHEN AGREED TO BY THE CONTRACT ADMINISTRATOR AND LANDSCAPE ARCHITECT.

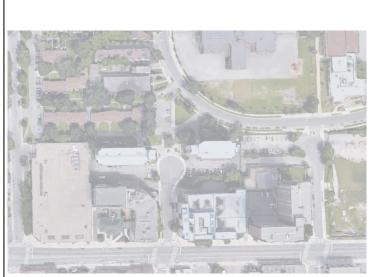

KEY PLAN, NTS

LANDSCAPE NOTES

1. All general site information and conditions compiled from architect's and engineer's plans and surveys. 2. Do not scale this drawing.

Report any discrepancies prior to commencing work. No responsibility is born by the Landscape Architect for unknown subsurface conditions.

4. Reinstate all areas and items damaged as a result of construction activities to the satisfaction of the Landscape Architect.

5. Drawing may not be used for construction until signed by Landscape Architect as issued for construction.

6. The accuracy of the position of utilities is not guaranteed. Individual utility co. must be contacted for confirmation of

utility existence and location prior to digging. 8. This drawing is an instrument of service and requires the

permission of the Landscape Architect for use. Copyright is reserved by the Landscape Architect, David M. Lashley.

9. Plant material shall be No.1 Grade and shall comply with the Metric Guide Specifications for Nursery stock (latest edition), published by Canadian Nursery Trades Association.

10. Plant substitutions shall not be permitted unless approved by the Landscape Architect.

11. Obtain approval of planting prior to digging.

12. Topsoil shall be garden sirl mixture sandy loam with min. 5% organic matter and peat moss added at ratio of 1:10, topsoil to be approved by Landscape Architect.

CLIENT:









LEGEND

------ PropertyLine

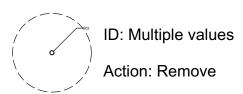

ID: Multiple values

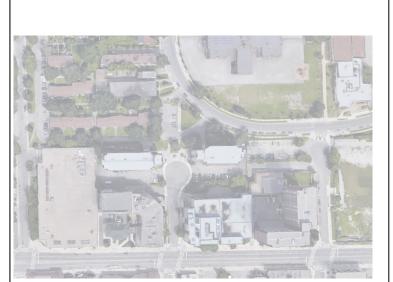

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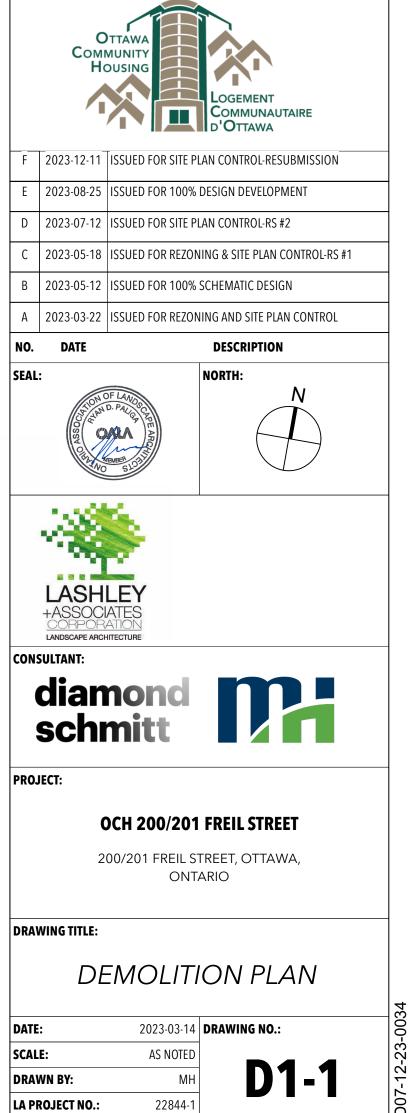
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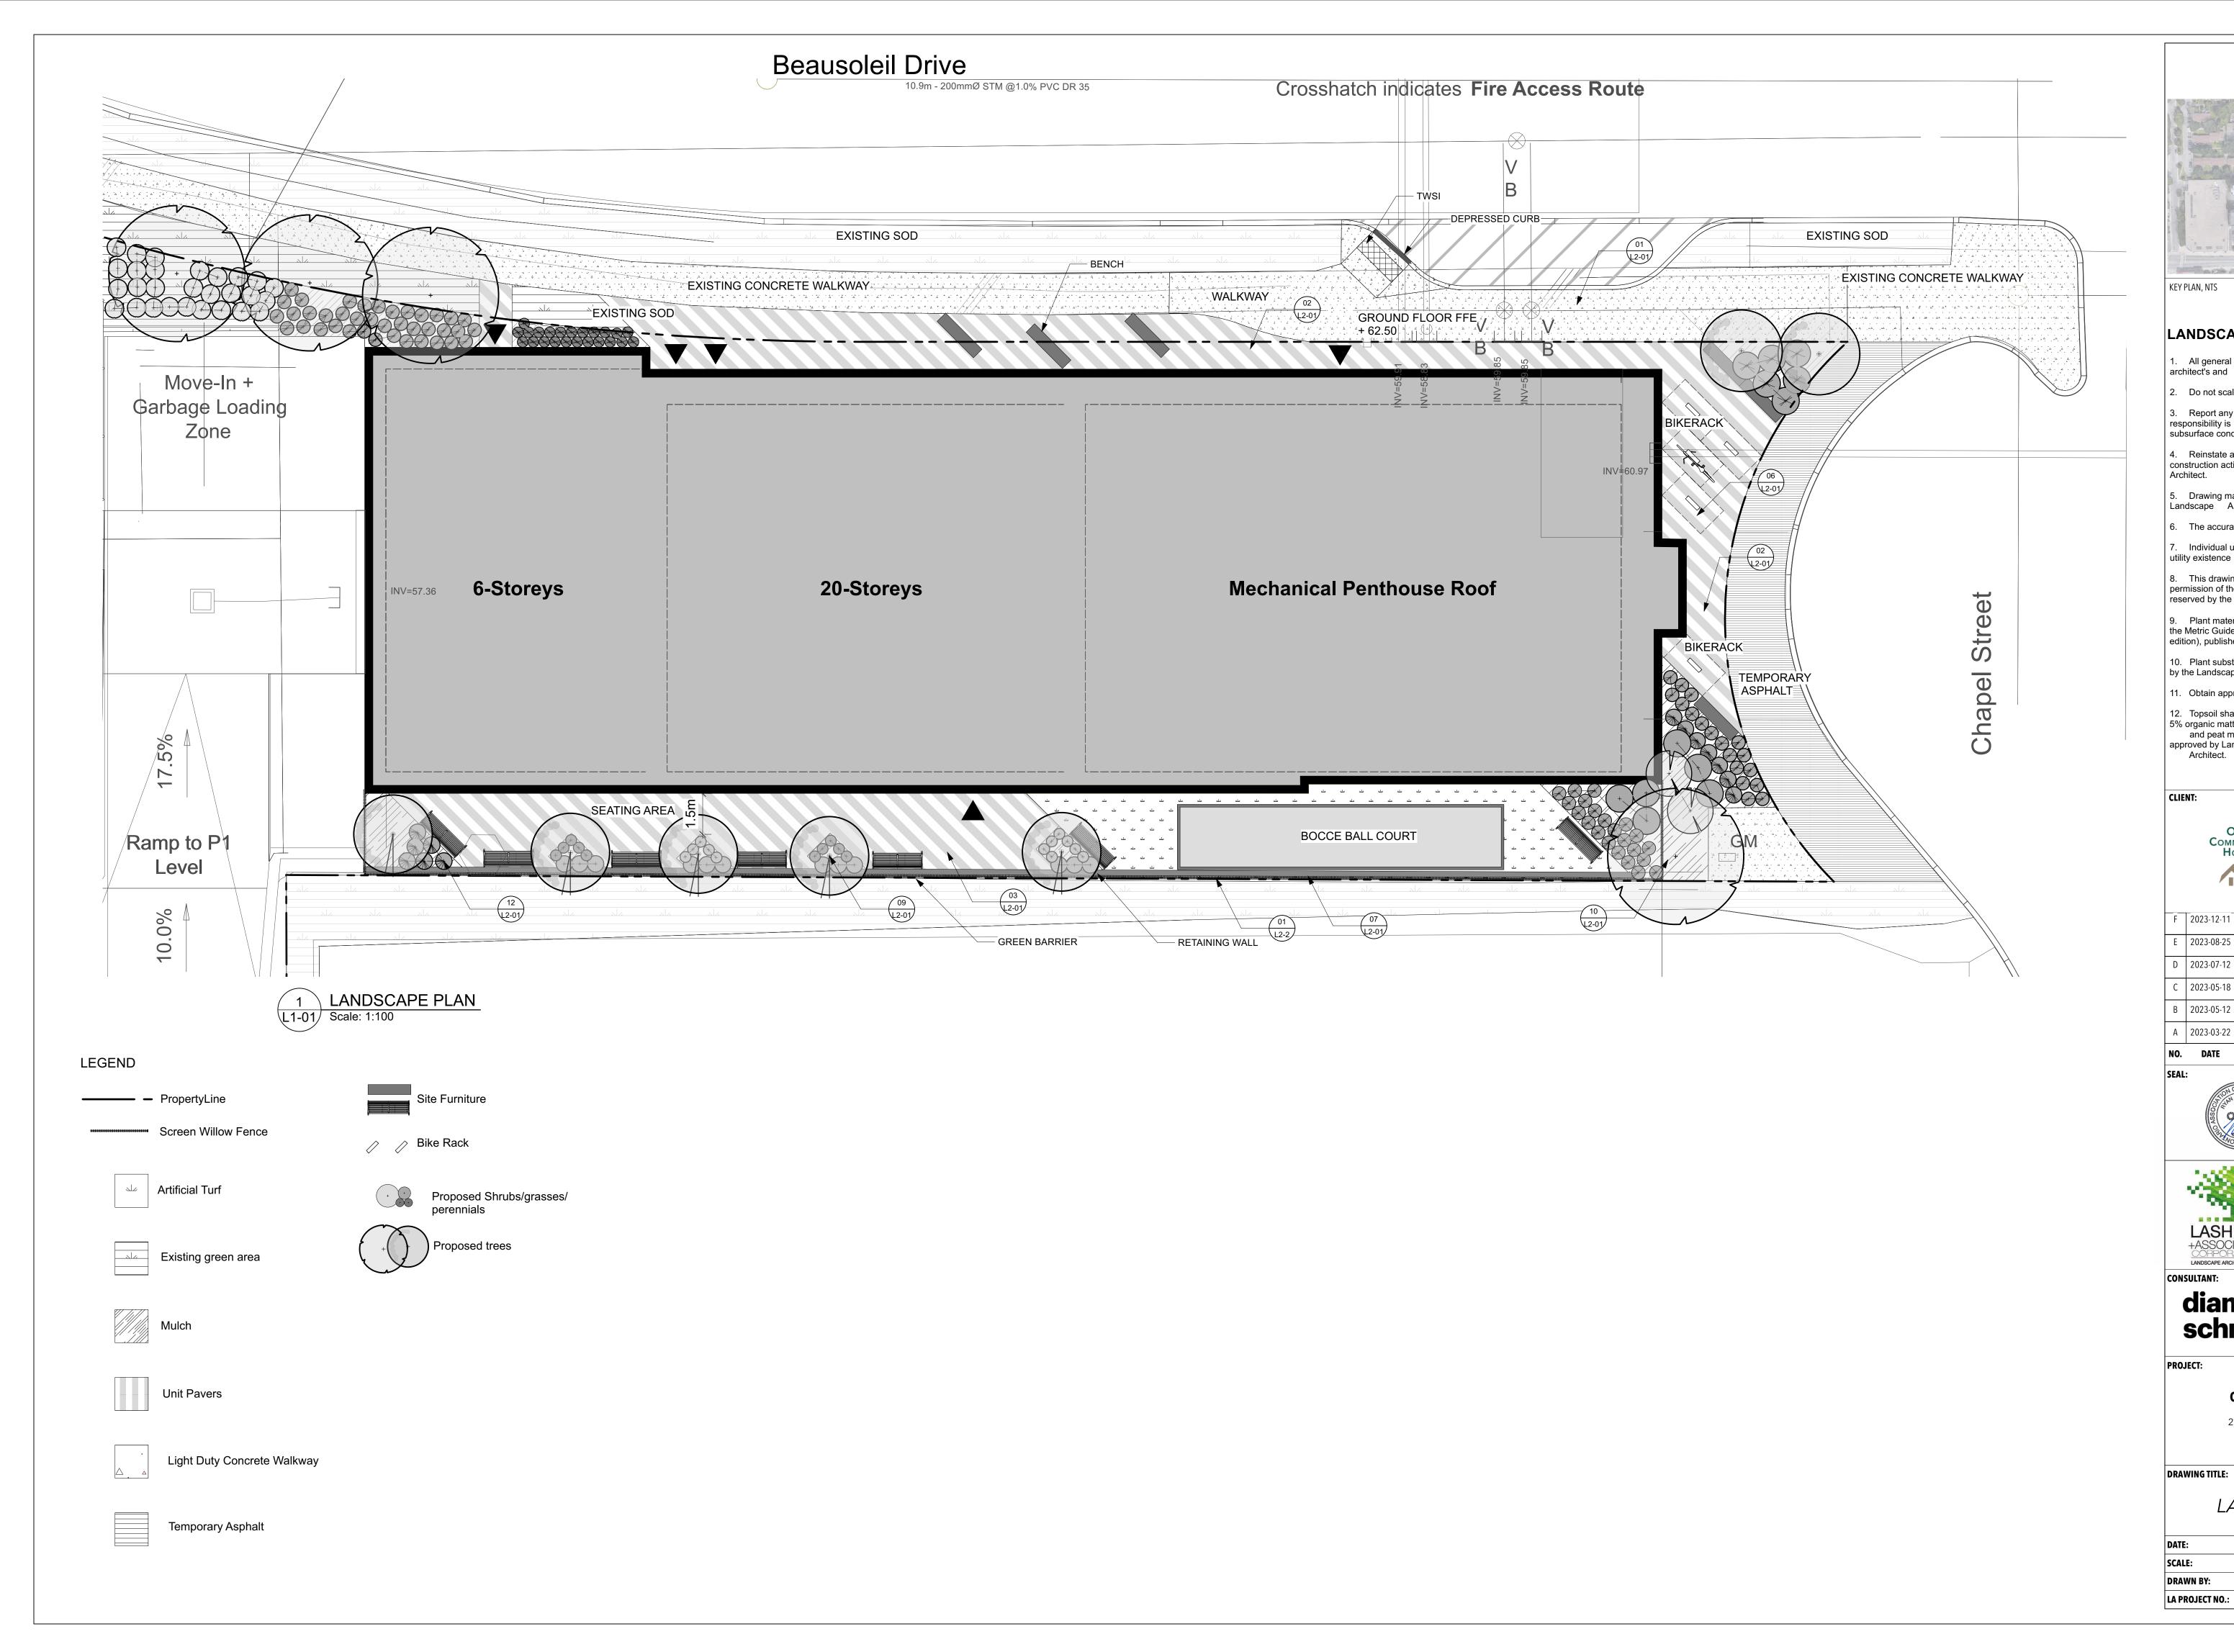
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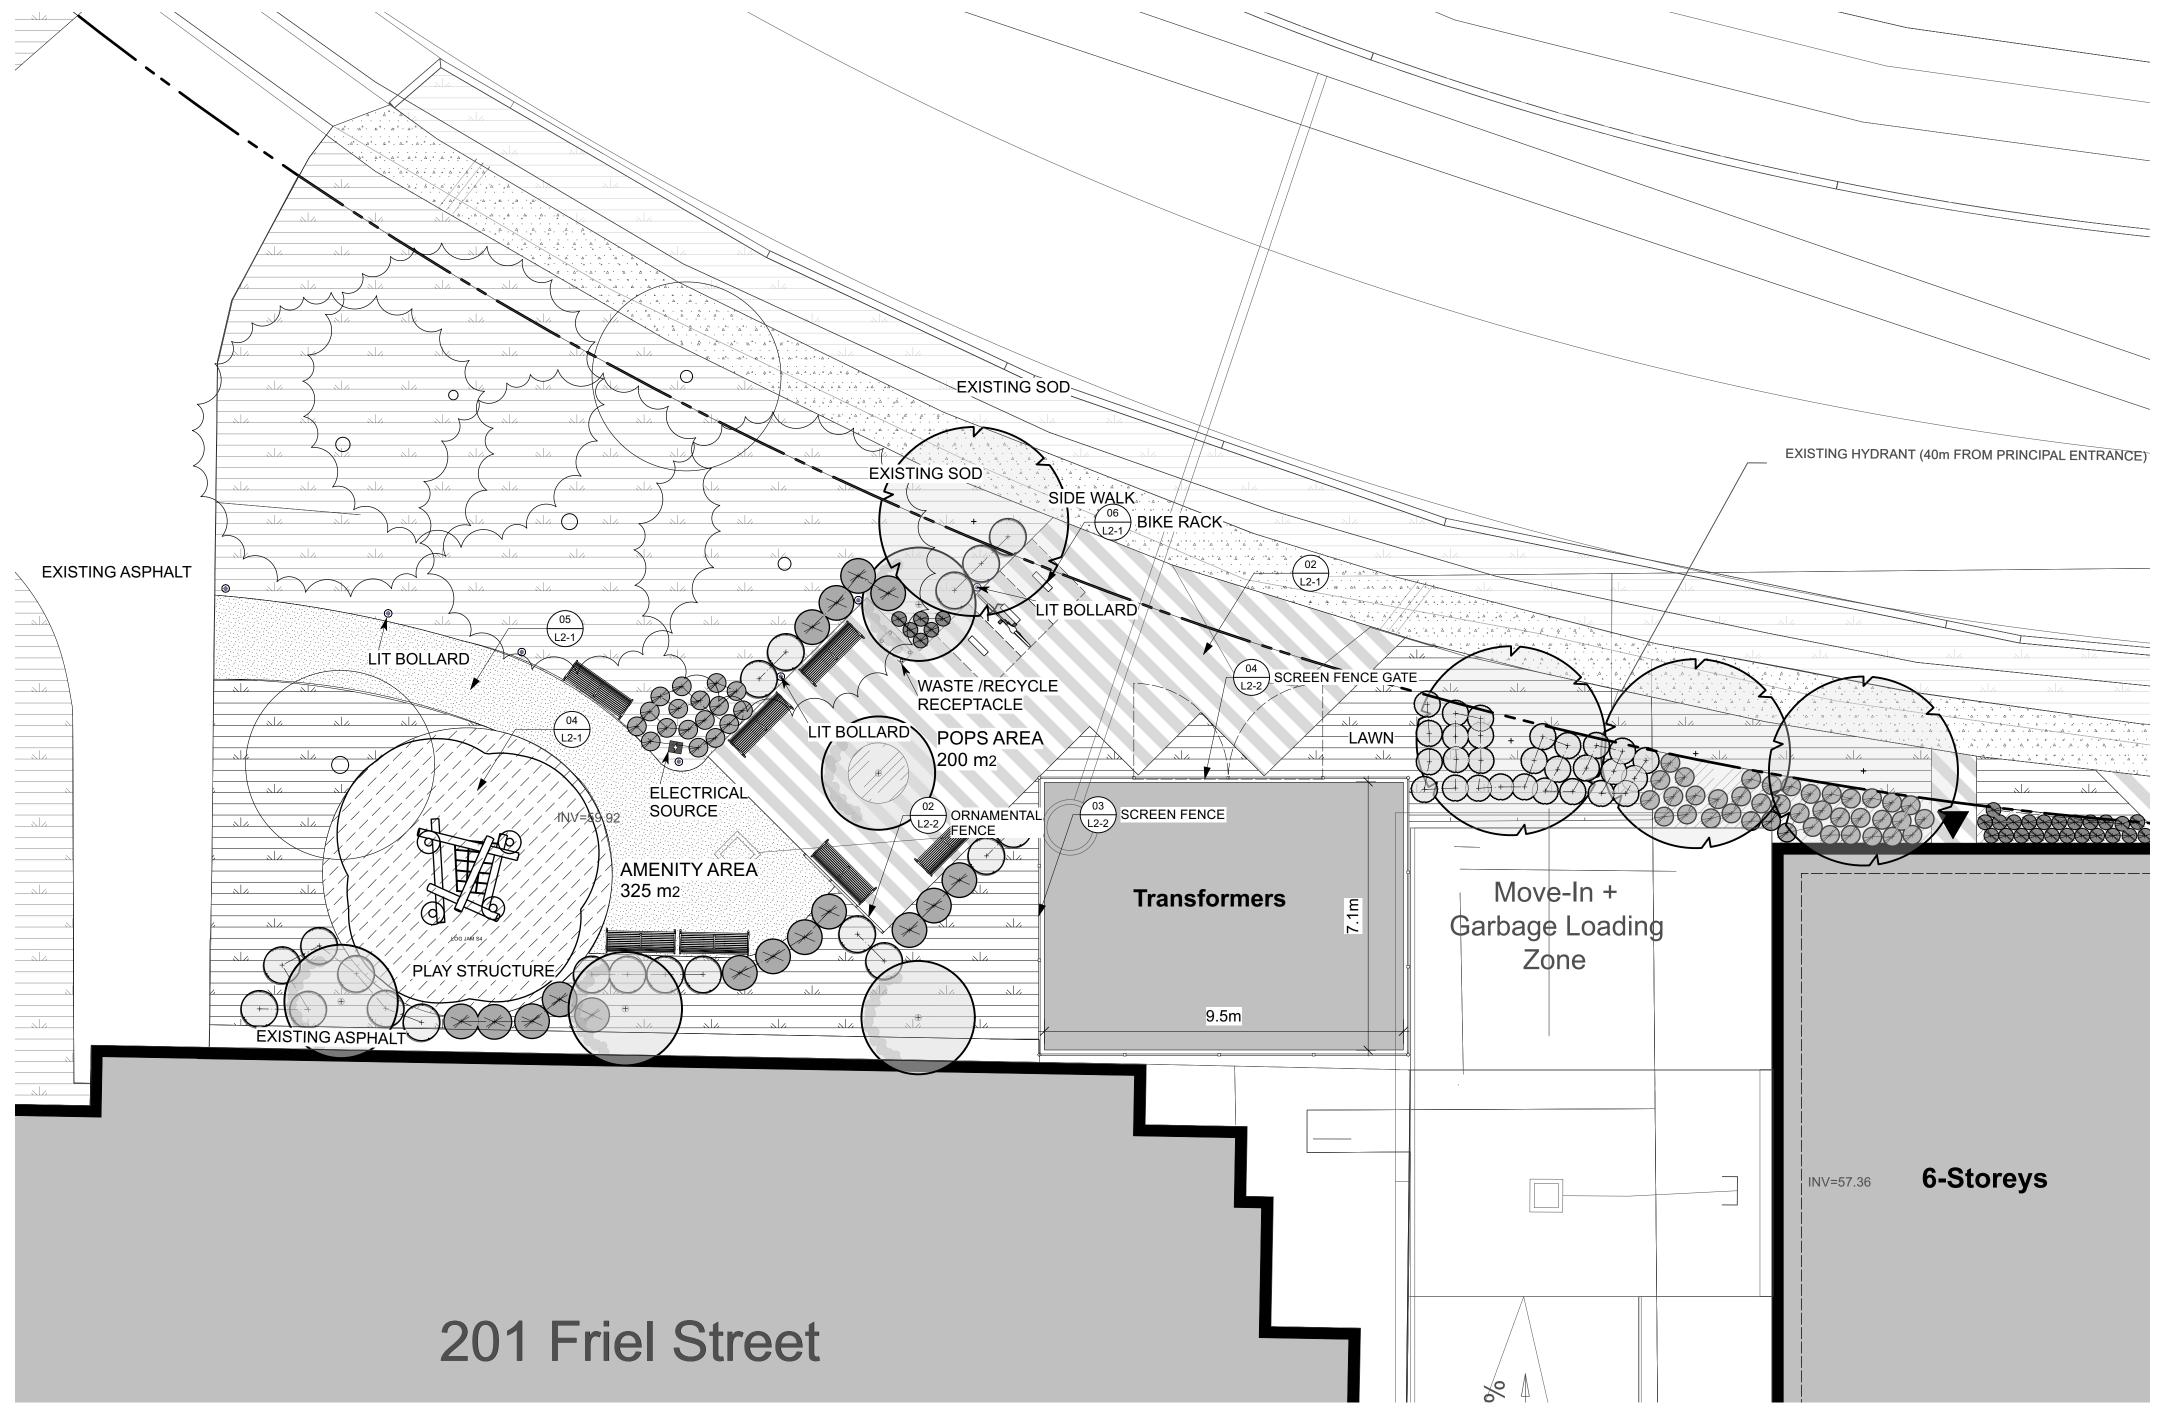
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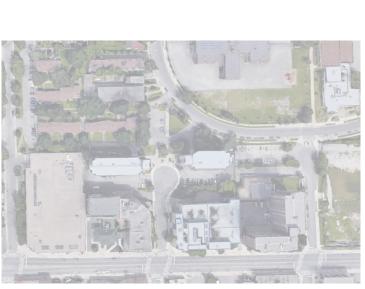
22844-1

D07-12-23-0034









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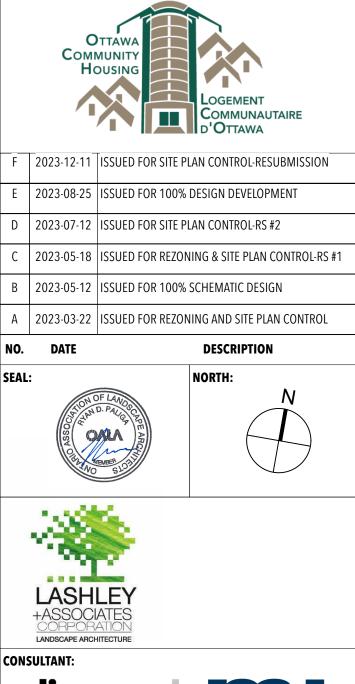
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PROJECT:


OCH 200/201 FREIL STREET

200/201 FREIL STREET, OTTAWA, ONTARIO

DRAWING TITLE:

LANDSCAPE PLAN-POPS 2023-03-14 **DRAWING NO.:** DATE: SCALE: AS NOTED L1-02 **DRAWN BY:** MH LA PROJECT NO.: 22844-1

D07-12-23-0034

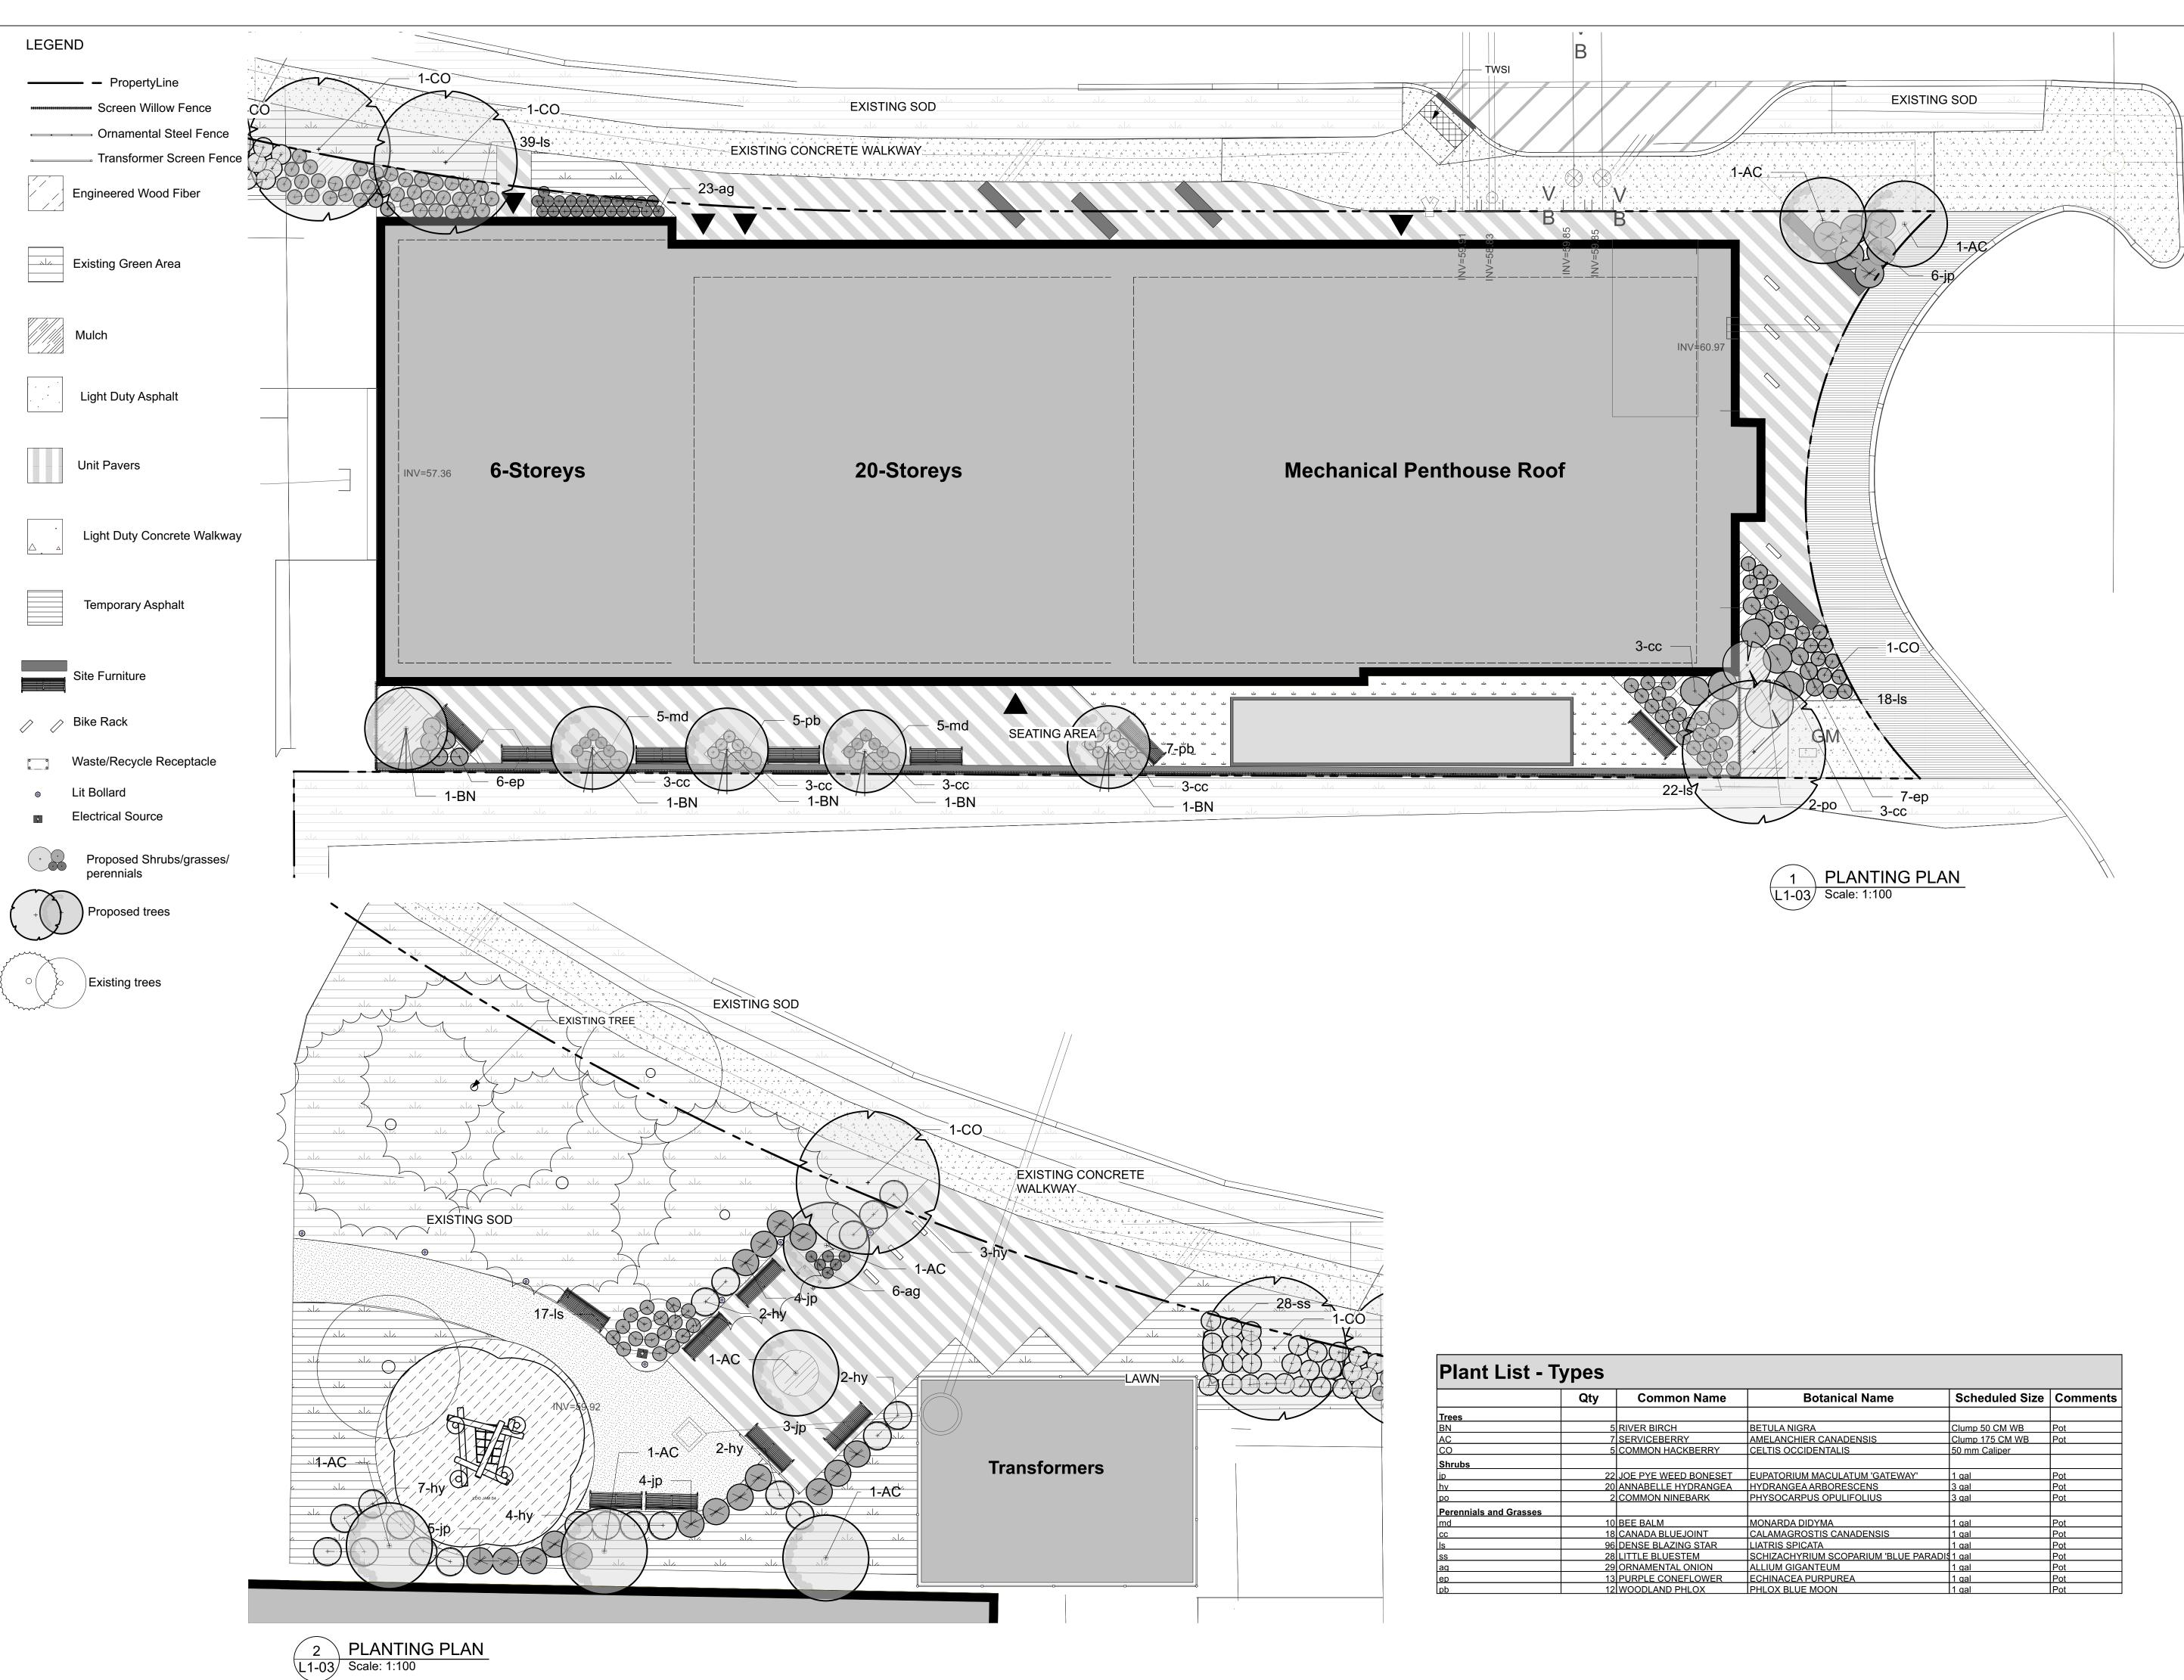

| | Qty | Common Name | Botanical Name | Scheduled Size | Comments |
|------------------------|-----|----------------------|---------------------------------------|-----------------|----------|
| Trees | | | | | |
| BN | 5 | RIVER BIRCH | BETULA NIGRA | Clump 50 CM WB | Pot |
| AC | 7 | SERVICEBERRY | AMELANCHIER CANADENSIS | Clump 175 CM WB | Pot |
| СО | 5 | COMMON HACKBERRY | CELTIS OCCIDENTALIS | 50 mm Caliper | |
| Shrubs | | | | | |
| ip | 22 | JOE PYE WEED BONESET | EUPATORIUM MACULATUM 'GATEWAY' | 1 gal | Pot |
| hy | 20 | ANNABELLE HYDRANGEA | HYDRANGEA ARBORESCENS | 3 gal | Pot |
| po | 2 | COMMON NINEBARK | PHYSOCARPUS OPULIFOLIUS | 3 gal | Pot |
| Perennials and Grasses | | | | | |
| md | 10 | BEE BALM | MONARDA DIDYMA | 1 gal | Pot |
| сс | 18 | CANADA BLUEJOINT | CALAMAGROSTIS CANADENSIS | 1 gal | Pot |
| ls | 96 | DENSE BLAZING STAR | LIATRIS SPICATA | 1 gal | Pot |
| SS | 28 | LITTLE BLUESTEM | SCHIZACHYRIUM SCOPARIUM 'BLUE PARADIS | 1 gal | Pot |
| ag | 29 | ORNAMENTAL ONION | ALLIUM GIGANTEUM | 1 gal | Pot |
| ер | 13 | PURPLE CONEFLOWER | ECHINACEA PURPUREA | 1 gal | Pot |
| pb | 12 | WOODLAND PHLOX | PHLOX BLUE MOON | 1 gal | Pot |



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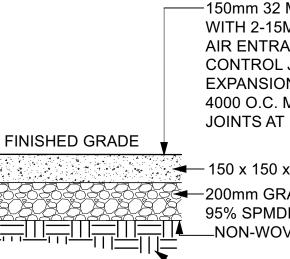
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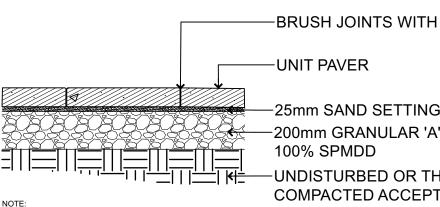
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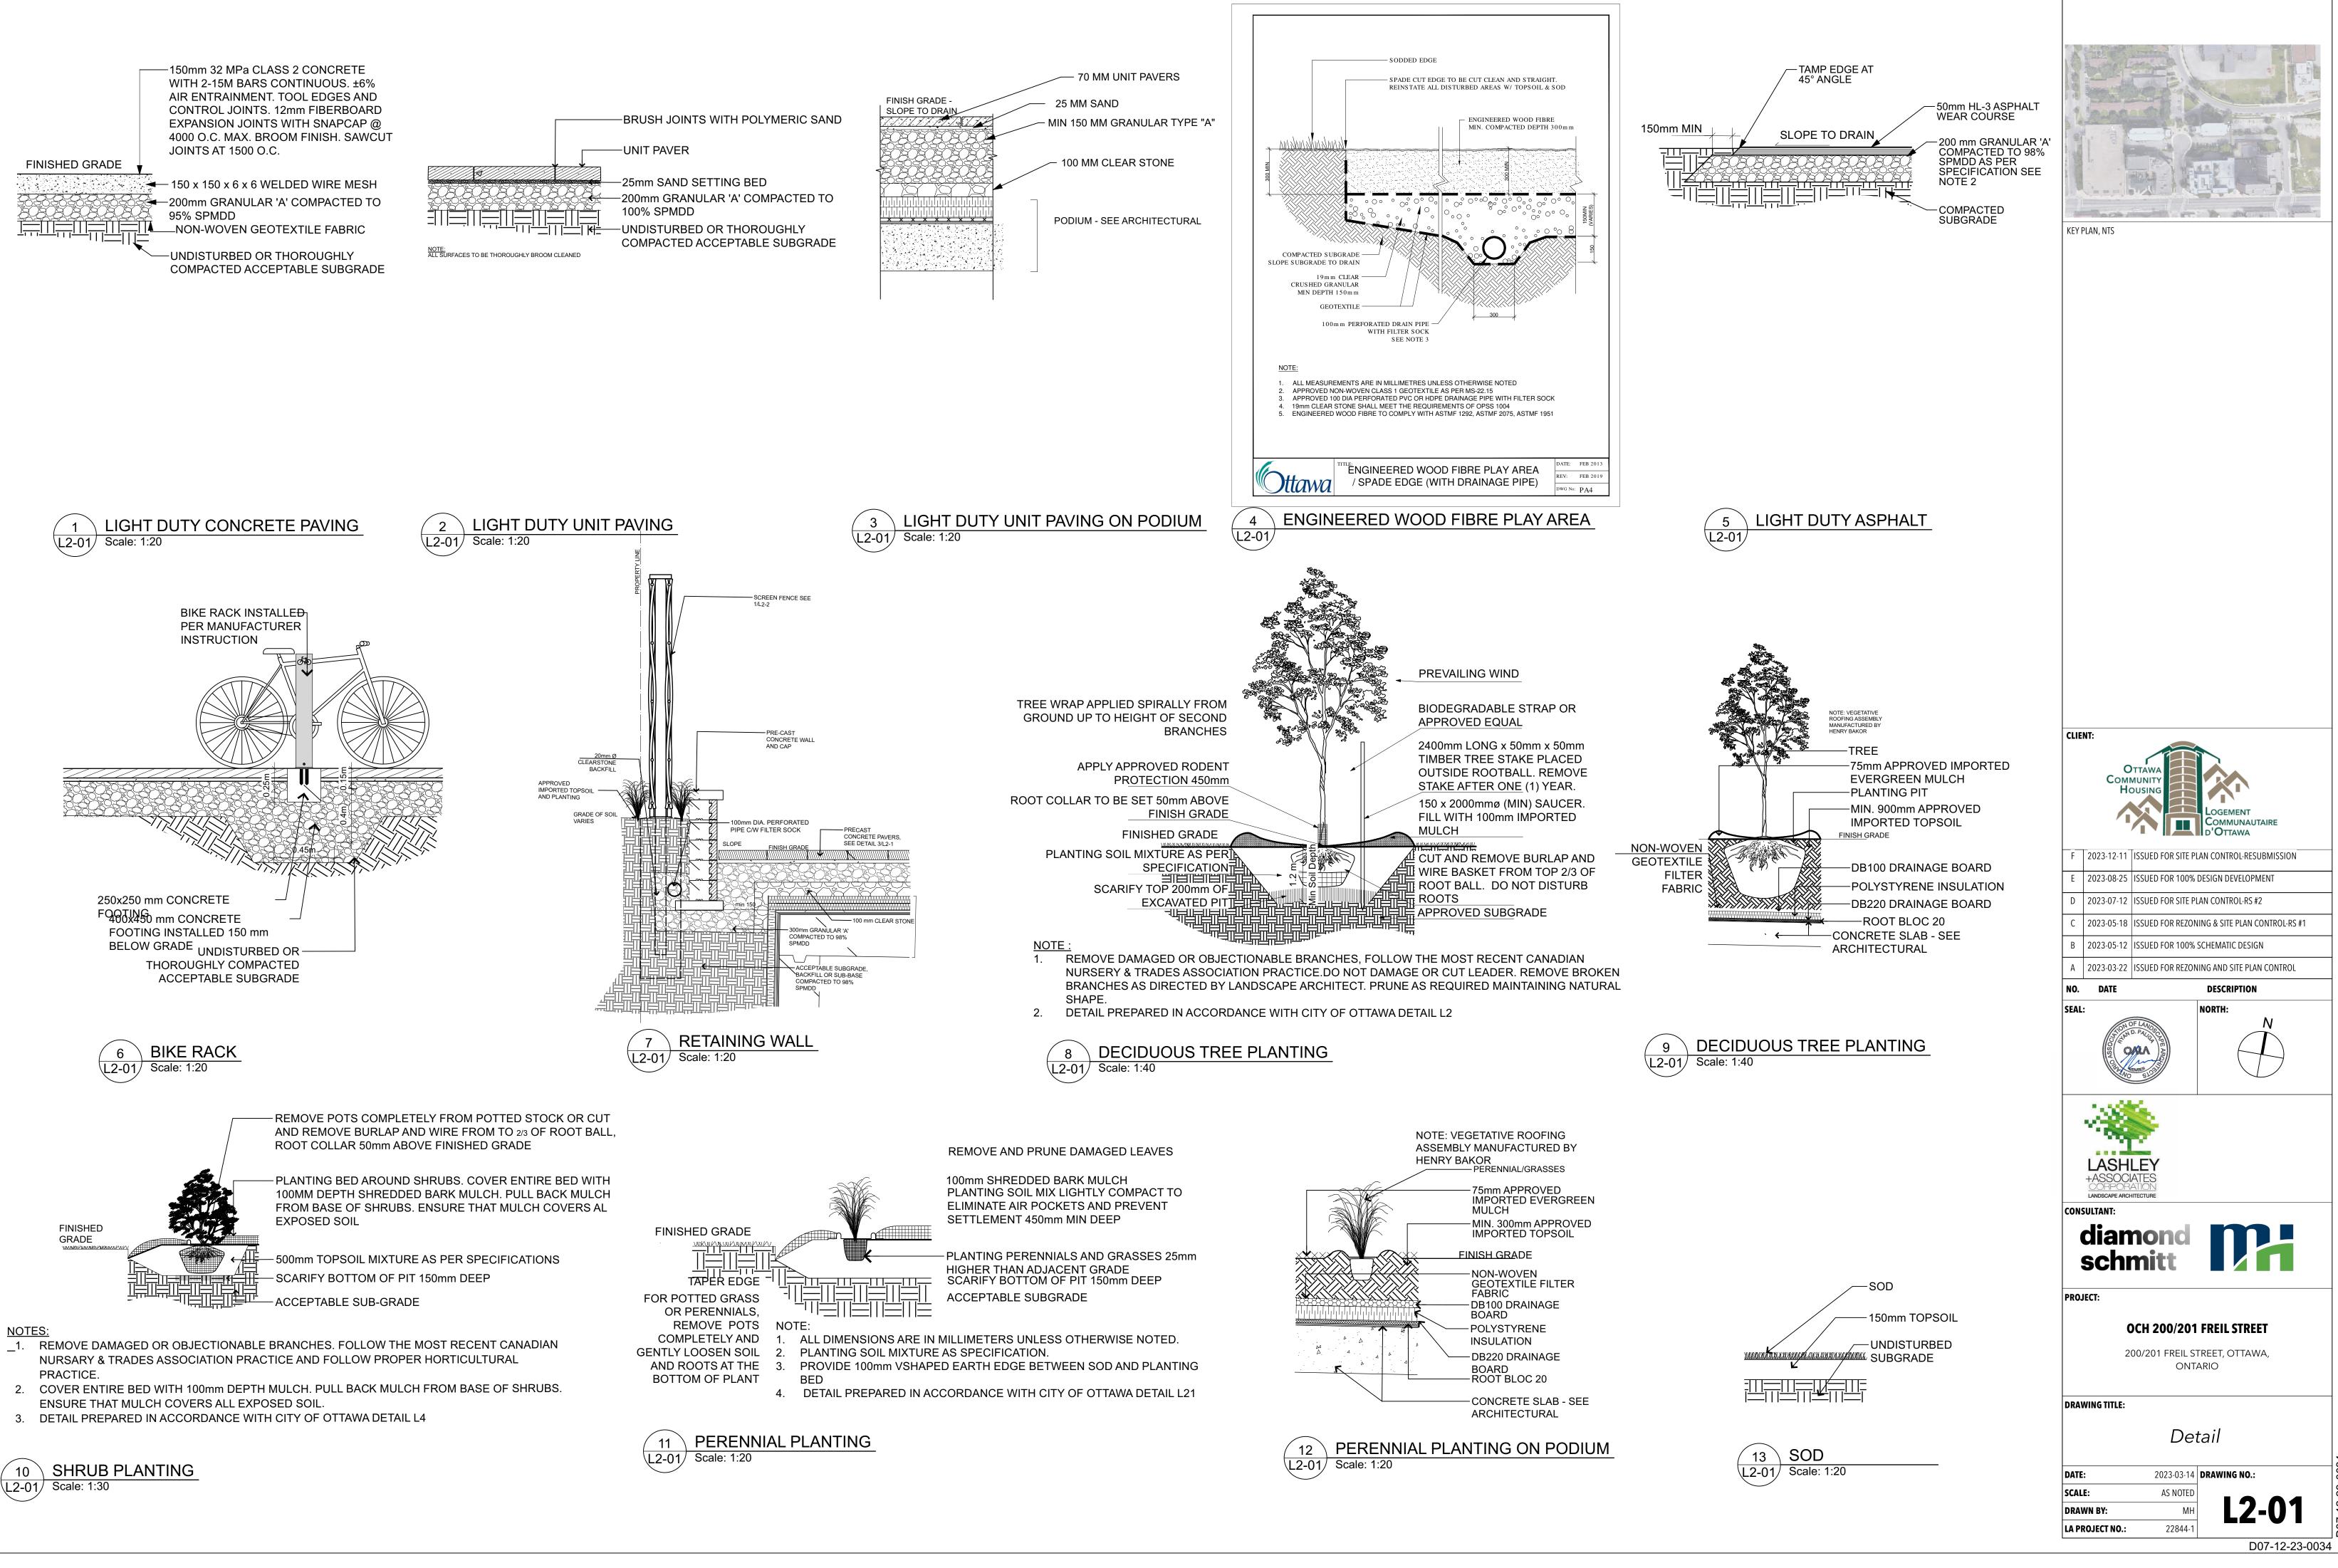


D07-12-23-0034



–NON-WOVEN GEOTEXTILE FABRIC





- 10 ` L2-01 Scale: 1:30

1.

