COMMERCIAL DEVELOPMENT

CAMBRIAN RD, BARRHAVEN, ONTARIO

21.326SD



Loblaw Companies Limited

Loblaw Companies Limited 1 President's Choice Circle Bramton, Ontario L6Y5S5 Contact Name: Luna Shrourou Phone Number: 437-929-4157 Email: Luna.Shrourou01@loblaw.ca



TURNER
ptersetG7 Lesmill RdToronto, ON, M3B 2T8Contact Name:Phone Number: 416-425-2222 extEmail: first.last@turnerfleischer.com



Senior Municipal Engineer/Ingénieur Municipal 100-1223 Michael St North Ottawa, ON K1J 7T2 Mathew Theiner, P.Eng., ing. (ON, QC, AB) +16136911545 mathew.theiner@parsons.com

Ontario Land Surveyors 14 Concourse Gate, Suite 500, Nepean, Ontario K2E 7S6 Ed Herweyer Tel 613-727-0850 Fax 613-727-1079 Direct Line 613-727-0934 EdH@aovltd.com







ZONING COMPLIANCE CHART - ZONING: GM[1628]		
	REQUIRED	PROPOSED
Minimum Lot Width (m)	N/A	76.55 m
Minimum Lot Area (acres)	N/A	3.72 acres
Minimum Front Yard Setback (Cambrian Rd) (m)	3 m	5.12 m
Minimum Rear Yard Setback (m)	N/A	21.76 m
Minimum Interior Side Yard Setback (m)	5m on West lot line Om on East lot line (future Greenbank Rd)	9.99 m West 0.45 m East
Maximum Height (m)	24 m / 6 storeys	7.48 m / 1 storey
Minimum Parking Dimensions (m)	2.6m x 5.2m	2.7m x 5.5m
Minimum Parking required (3.6 per 100 s.m. of GFA)	141 spaces	181 spaces
Minimum Bicycle Parking required (1 per 250 s.m. of GFA)	15 spaces	15 spaces
Loading spaces (for up to 4999 s.m. of GFA)	1 standard space (3.5x9x4.2 m) 1 oversized space (4.3x13x4.2 m)	3 standard spaces 1 oversized space
Minimum Drive Aisle Width (parking angle at 90 degrees) (m)	6.7 m	6.7 m






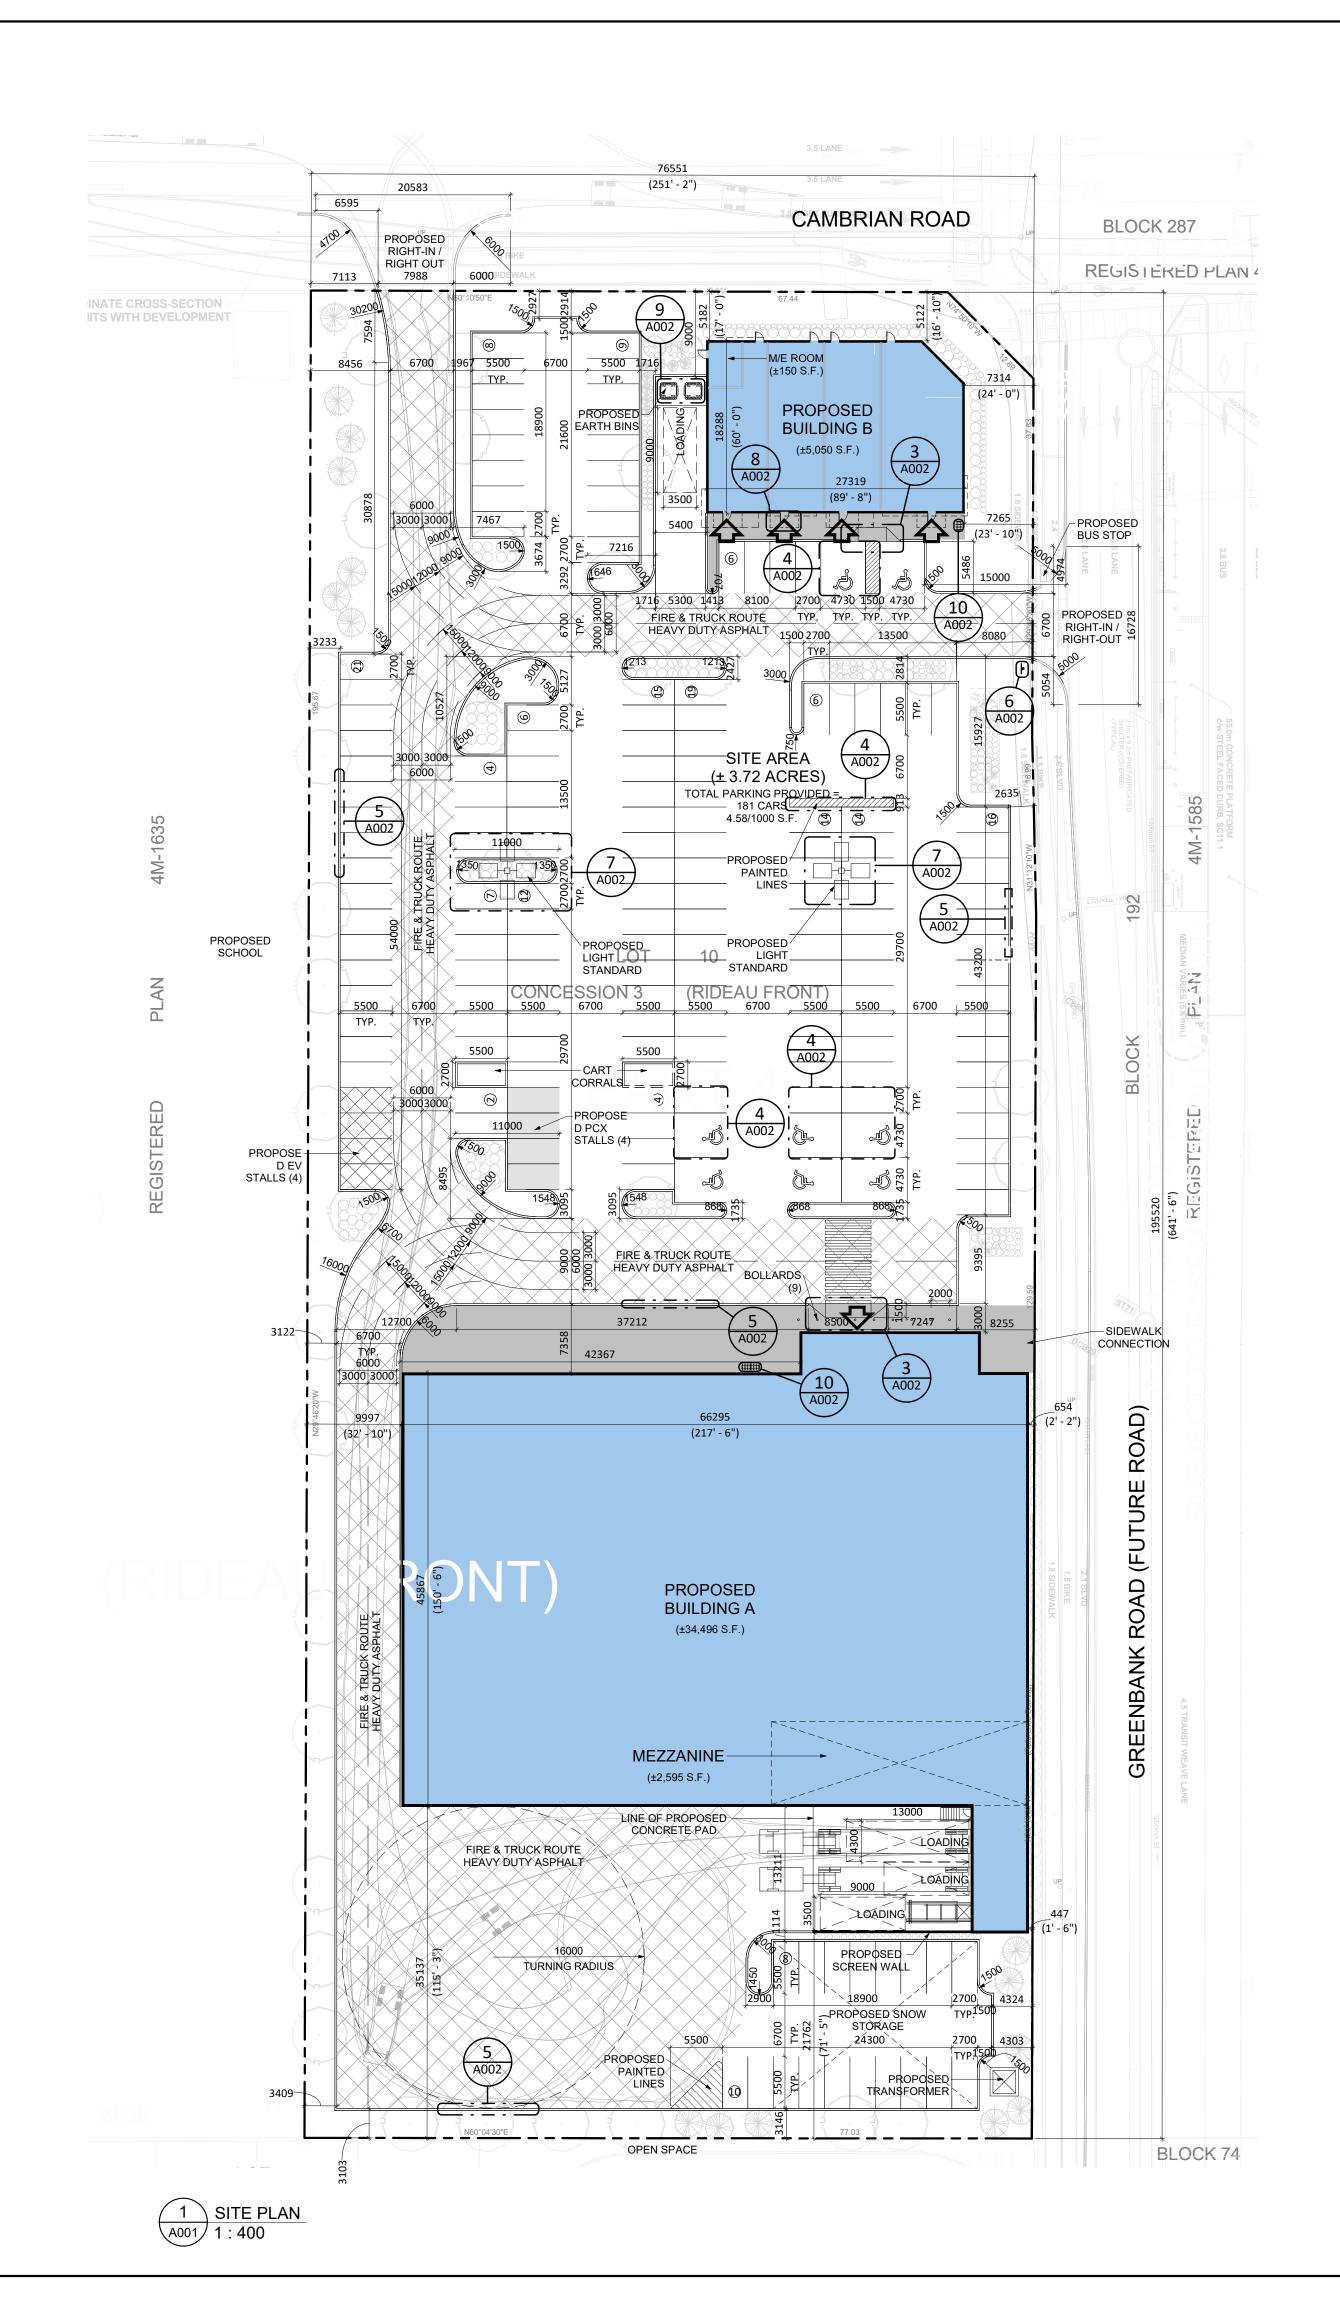

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The contractor must verif	turnerfleischer.com
scaled. The architect is no information shown on th the work. Construction m jurisdiction. The contract	It responsible for the accuracy of survey, structural, mechanical, electrical, etc., is drawing. Refer to the appropriate consultant's drawings before proceeding with ust conform to all applicable codes and requirements of authorities having or working from drawings not specifically marked 'For Construction' must assume ar costs for any corrections or damages resulting from his work.
together with the current	y Turner Fleischer is reliant on a legal survey showing the boundaries of the lands location of any existing buildings, features or encroachment prepared by Annis, D., dated 2023-03-28 as provided by Loblaw Companies Limited.
	LEGAL DESCRIPTION
CONCESSIO	IIC PLAN OF PART OF LOT 10 N 3 (RIDEAU FRONT) C TOWNSHIP OF NEPEAN AWA
	STATISTICS
SITE AREA	±3.72 ACRES ±1.51 HA.
PROPOSED I MEZZANINE TOTAL BUILE	BUILDING A AREA±34,496 S.F. ±3,205 S.M. AREA ±2,595 S.F. ±241 S.M. DING A AREA ±37,091 S.F. ±3,446 S.M.
PROPOSED I TOTAL BUILD	BUILDING B ±5,050 S.F. ±469 S.M. M/E ROOM ±150 S.F. ±14 S.M. DING B AREA ±5,200 S.F. ±483 S.M.
TOTAL BUILD	S FLOOR AREA ±39,546 S.F. ±3,674 S.M. DING AREA ±42,291 S.F. ±3,929 S.M. ING PROVIDED 181 CARS
COVERAGE	4.58/1000 S.F. 4.93/100 S.M. 21.28 %
	LEGEND
	PROPOSED BUILDING
	PROPOSED ENTRANCE ARROW
Y	PROPOSED CONCRETE SIDEWALK
	PROPOSED FIRE & TRUCK ROUTE
	(HEAVY DUTY ASPHALT)
	PROPOSED PCX PARKING
	PROPOSED EV PARKING
	PROPOSED TRANSFORMER
	ISSUED FOR COORDINATION FPI
3 2023-03-30	ISSUED FOR COORDINATIONFPIISSUED FOR COORDINATIONFPIISSUED FOR COORDINATIONFPIISSUED FOR COORDINATIONFPI
# DATE	
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PROJECT	
CA	MBRIAN RD (S. PARCEL)
DRAWING	BARRHAVEN, ONTARIO
SI	TE PLAN & FLOOR PLAN
PROJECT NO. 21.326SD	
PROJECT DATE 2023-05-01 DRAWN BY	
FPI CHECKED BY RAD	_
SCALE 1:400	
	A001

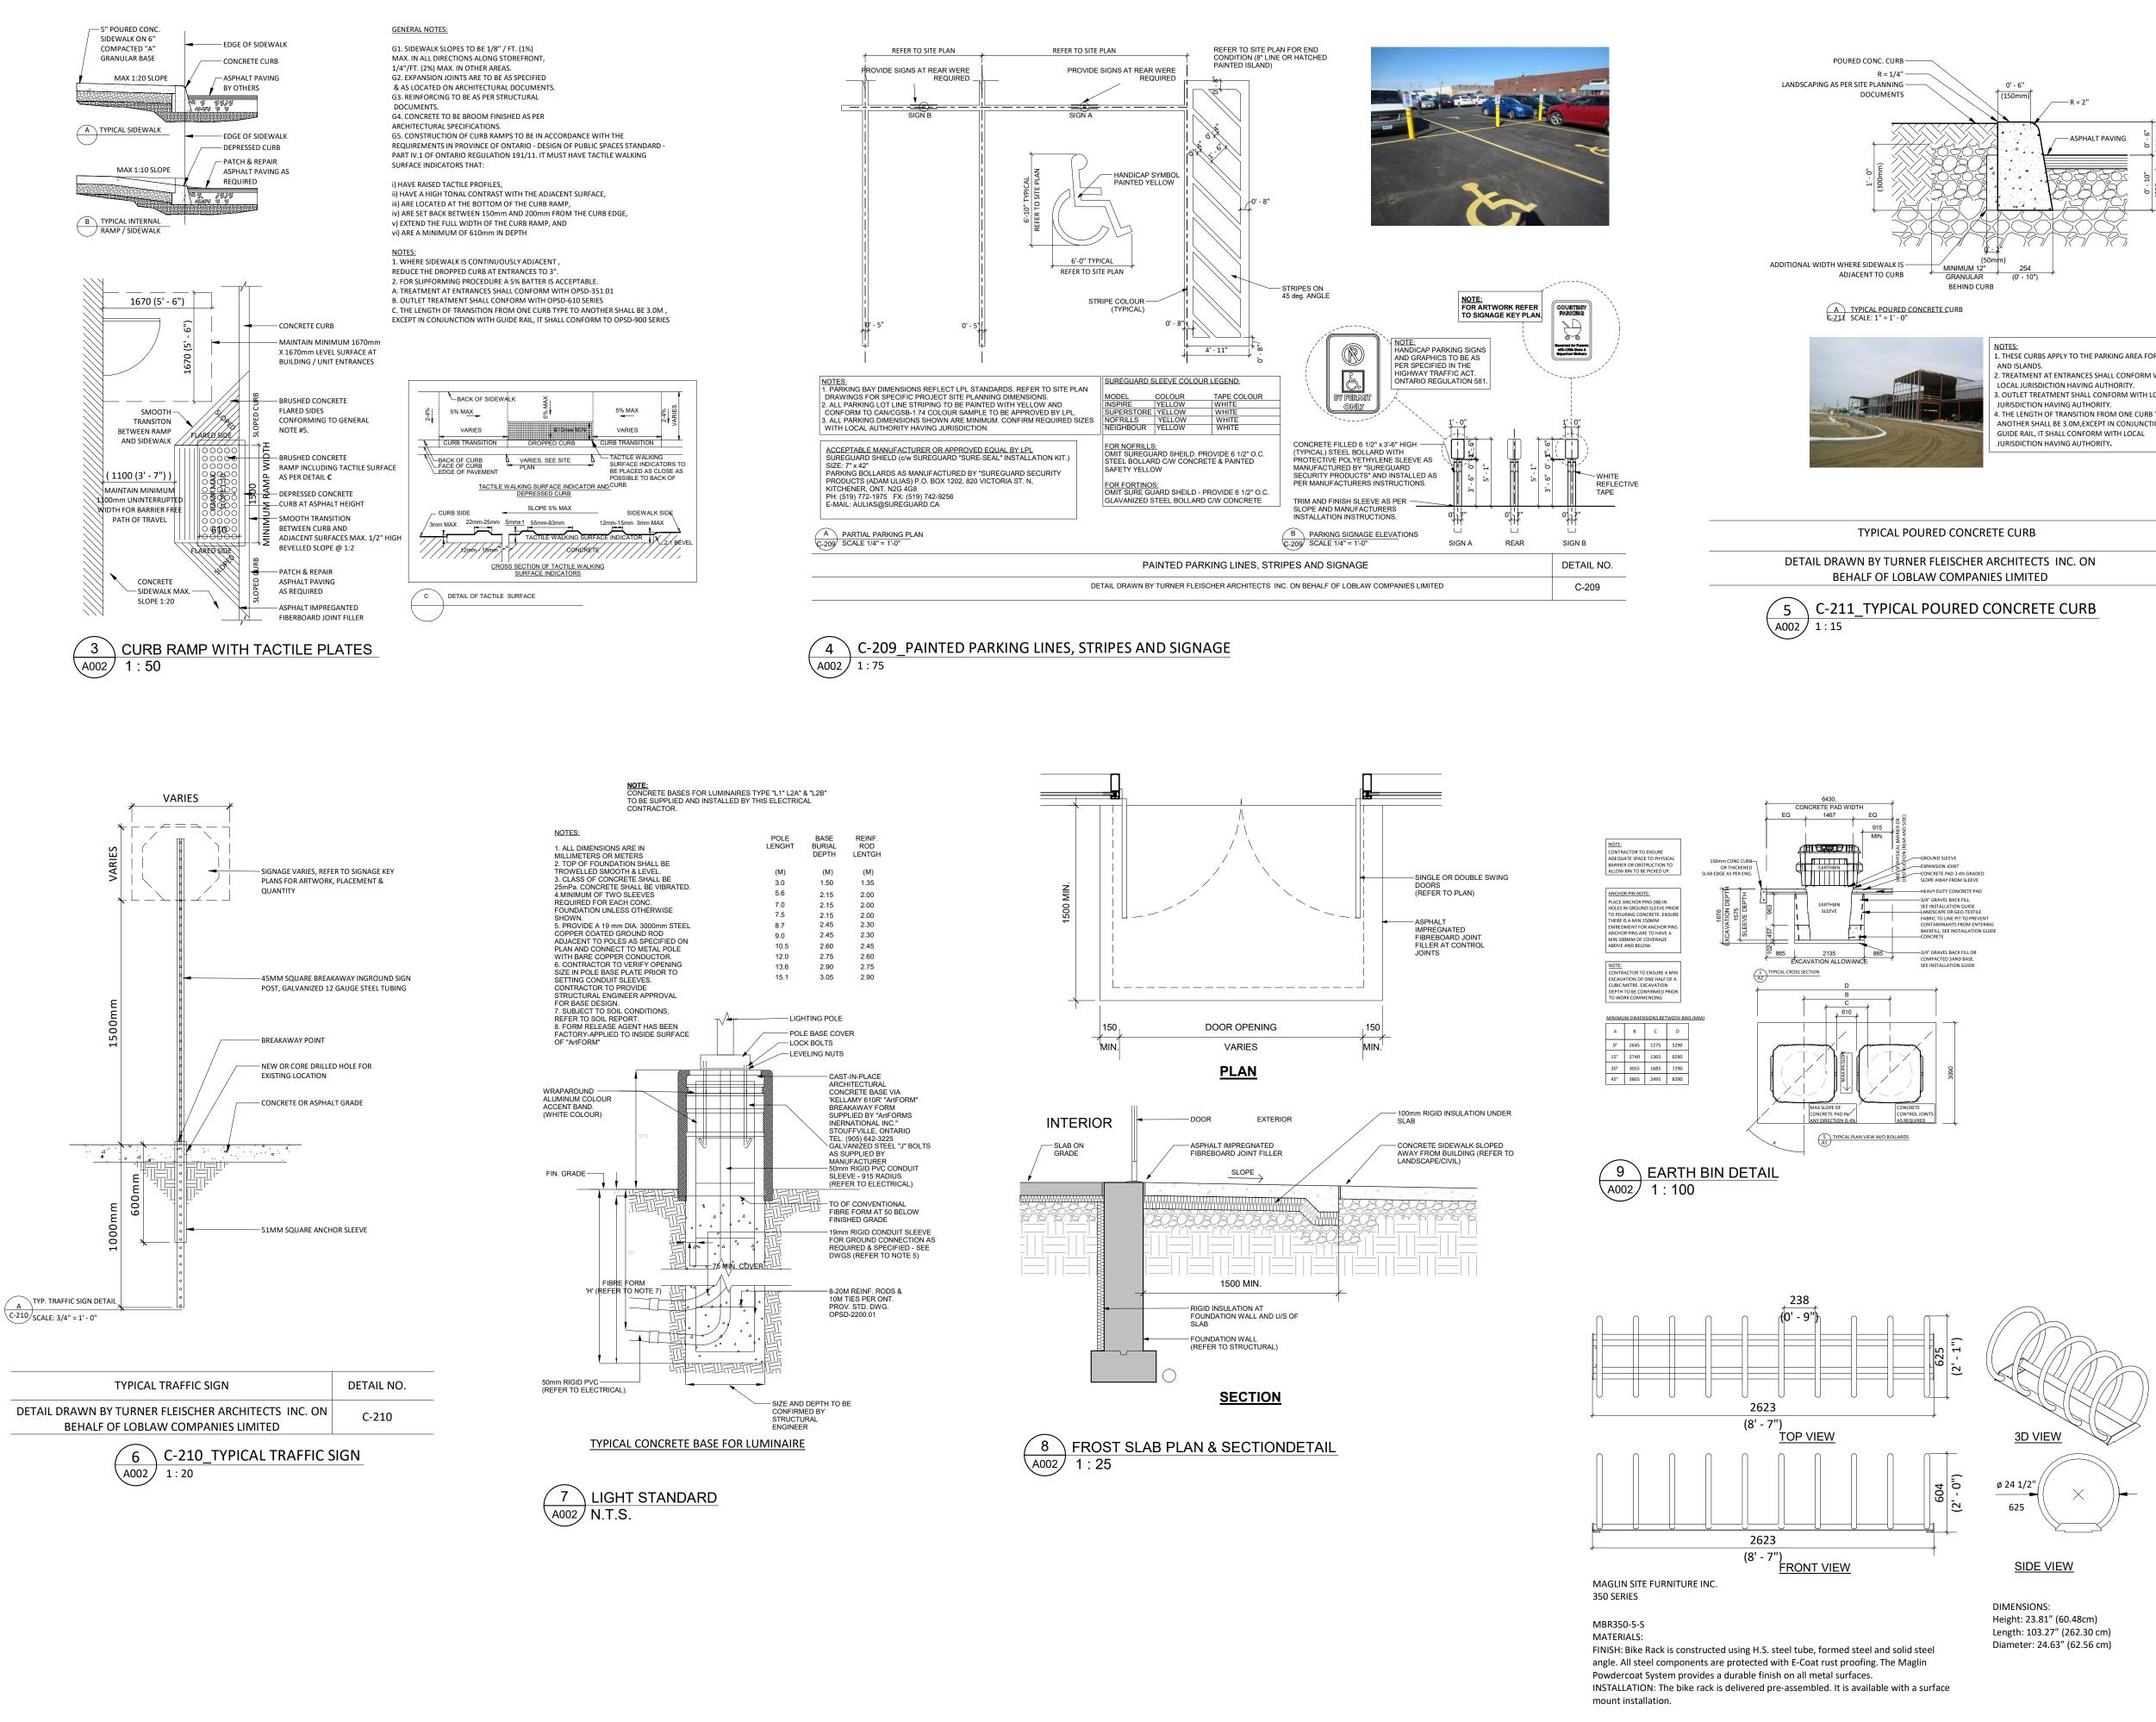

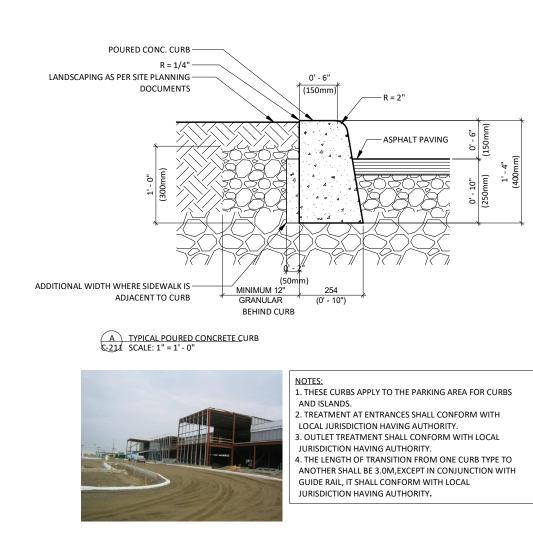



TE CURB	DETAIL NO.
RCHITECTS INC. ON	C-211
S LIMITED	

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scaled interacting of the sponsible for the decision of or savey, structural, inclinancial, rectinance, etc., information shown on this drawing. Refer to the appropriate consultant's drawings before proceeding wit the work. Construction must conform to all applicable codes and requirements of authorities having

jurisdiction. The contractor working from drawings not specifically marked 'For Construction' must assume

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2023-05-01 ISSUED FOR COORDINATION 2023-04-24 ISSUED FOR COORDINATION 2023-03-30 ISSUED FOR COORDINATION

2023-03-28 ISSUED FOR COORDINATION 2023-03-02 ISSUED FOR COORDINATION

Loblaw

Limited

DESCRIPTION

Companies

CAMBRIAN RD (S. PARCEL)

BARRHAVEN, ONTARIO

SITE DETAILS

DRAWING NO.

A002

DATE

RO.IEC

DRAWING

PROJECT NO.

21.326SD

PROJECT DATE


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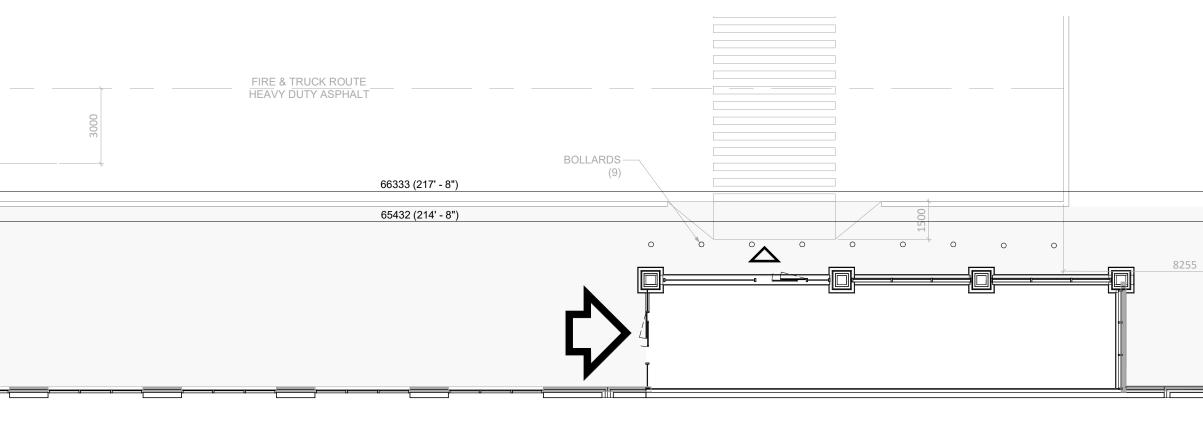
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RAD SCALE As indicated **Turner Fleischer Architects Inc.**


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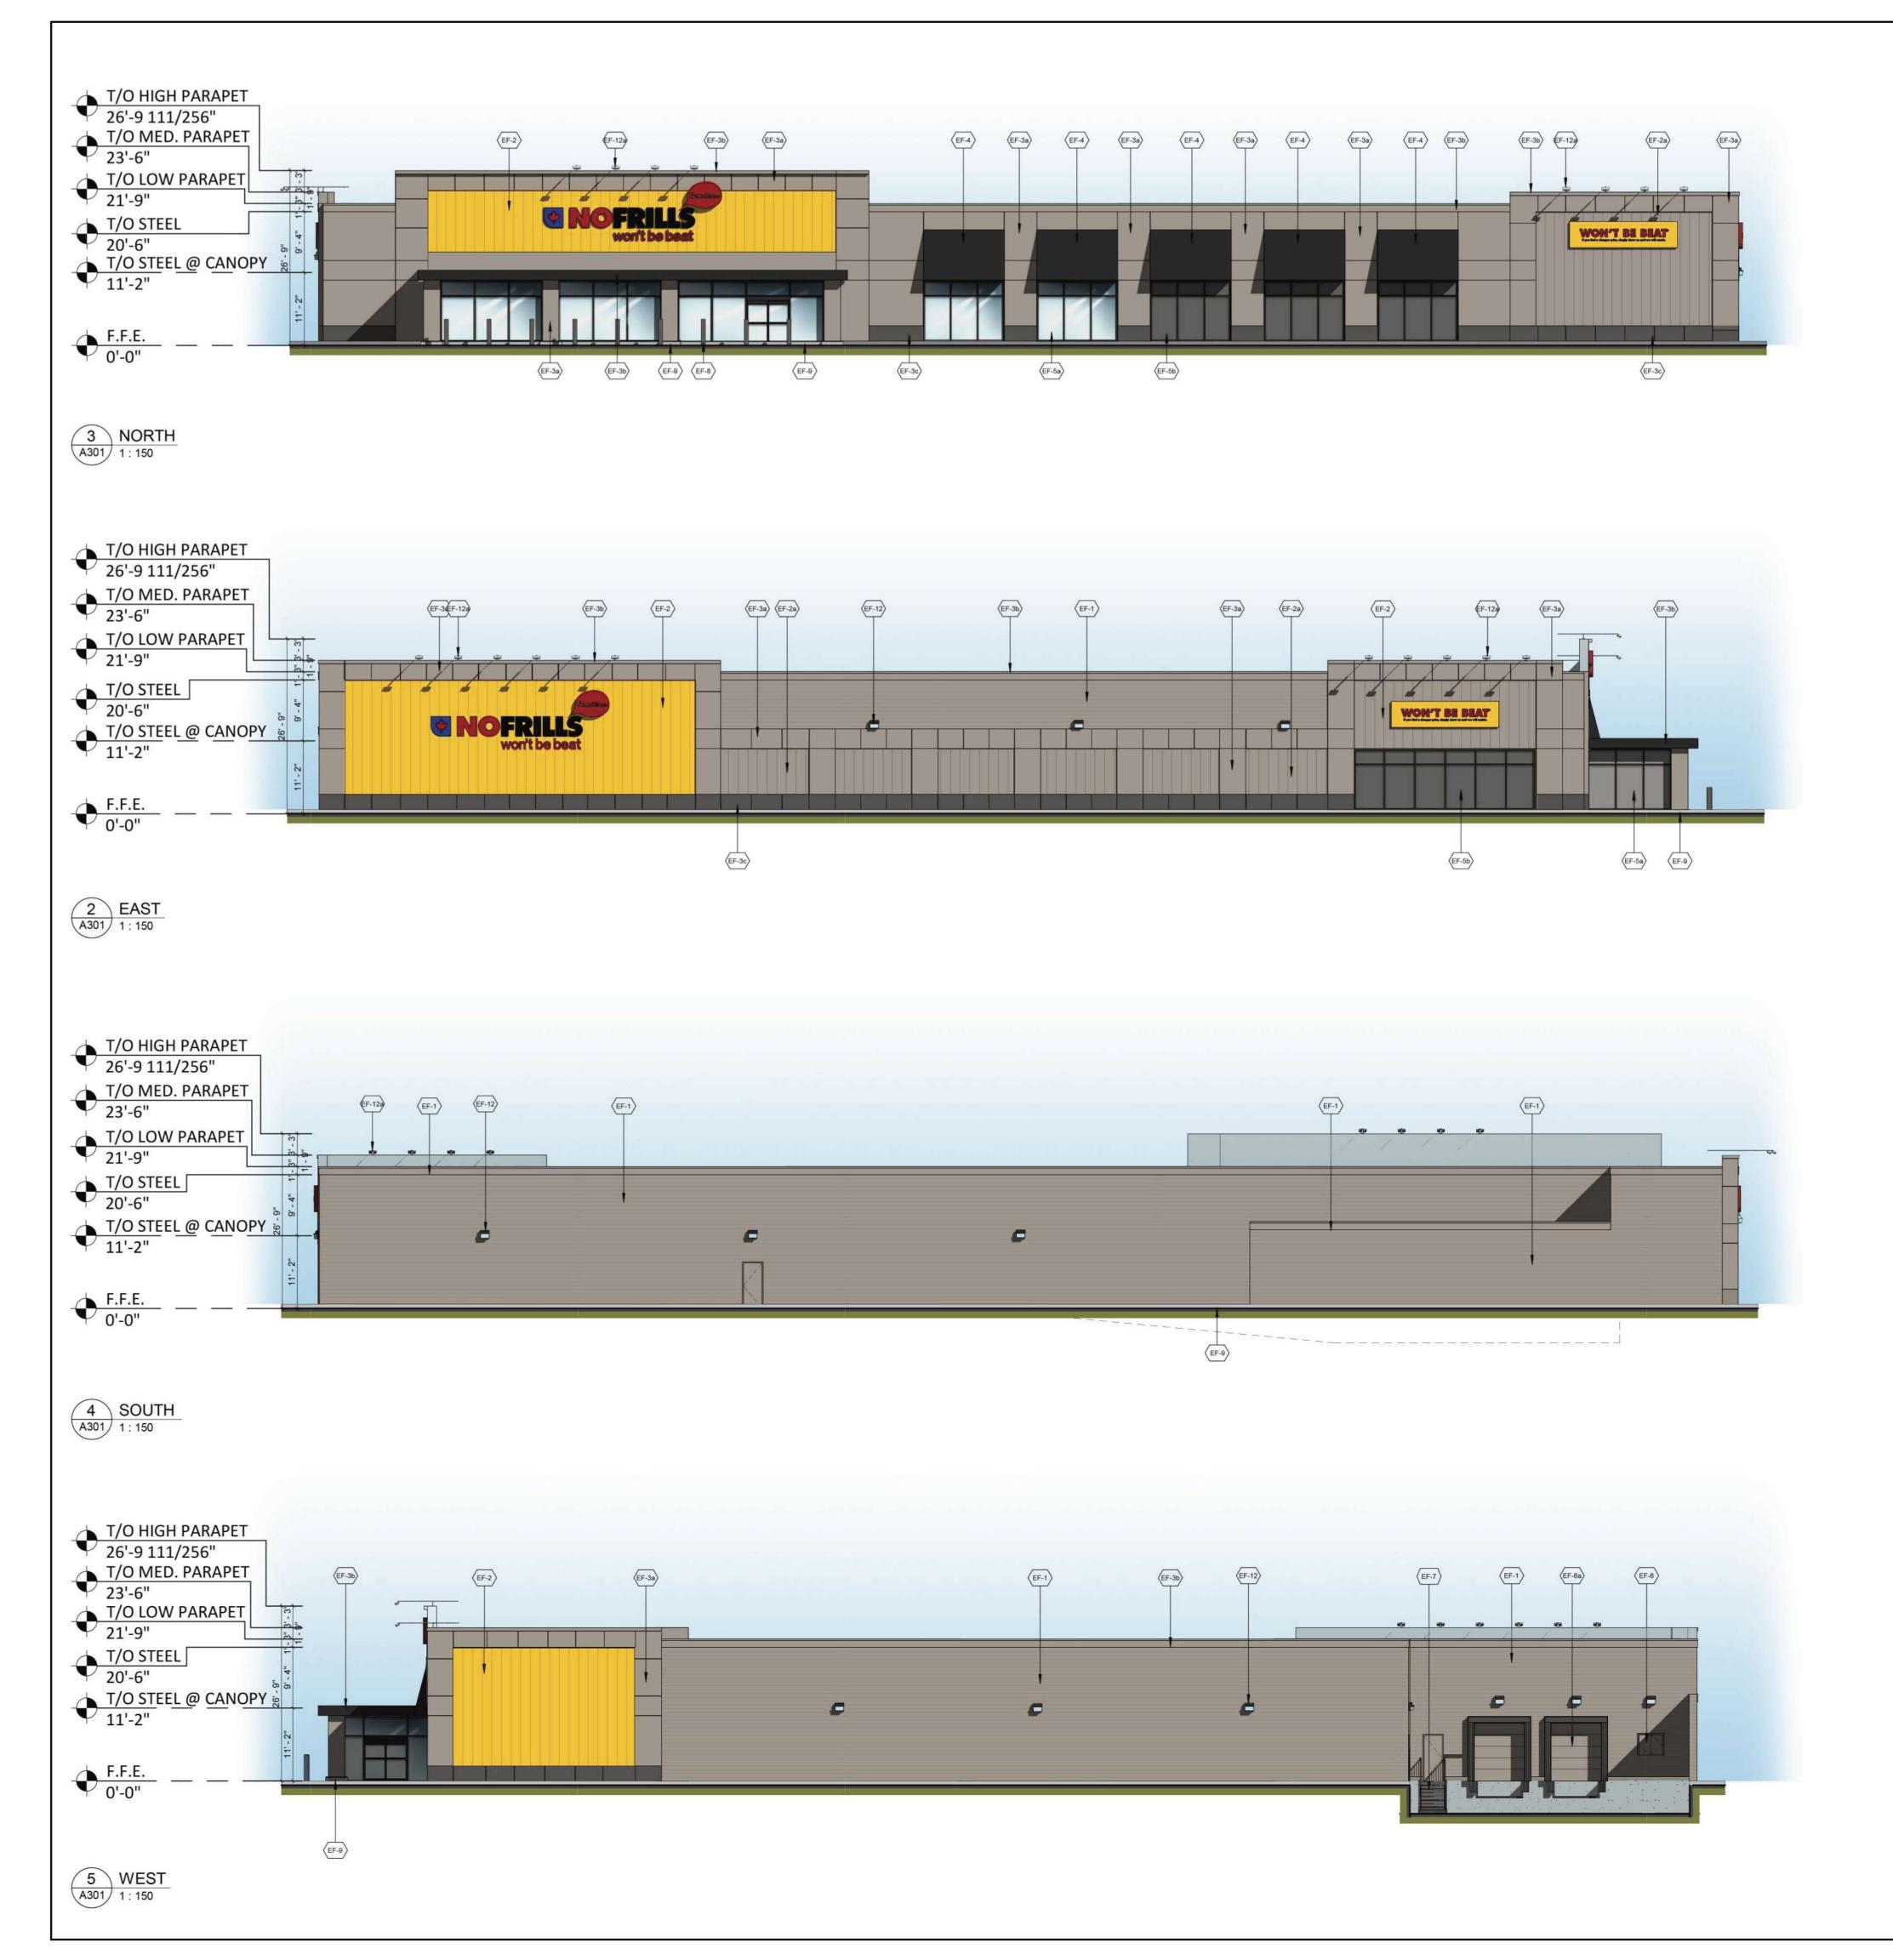



PROPOSED BUILDING A

(±34,496 S.F.)

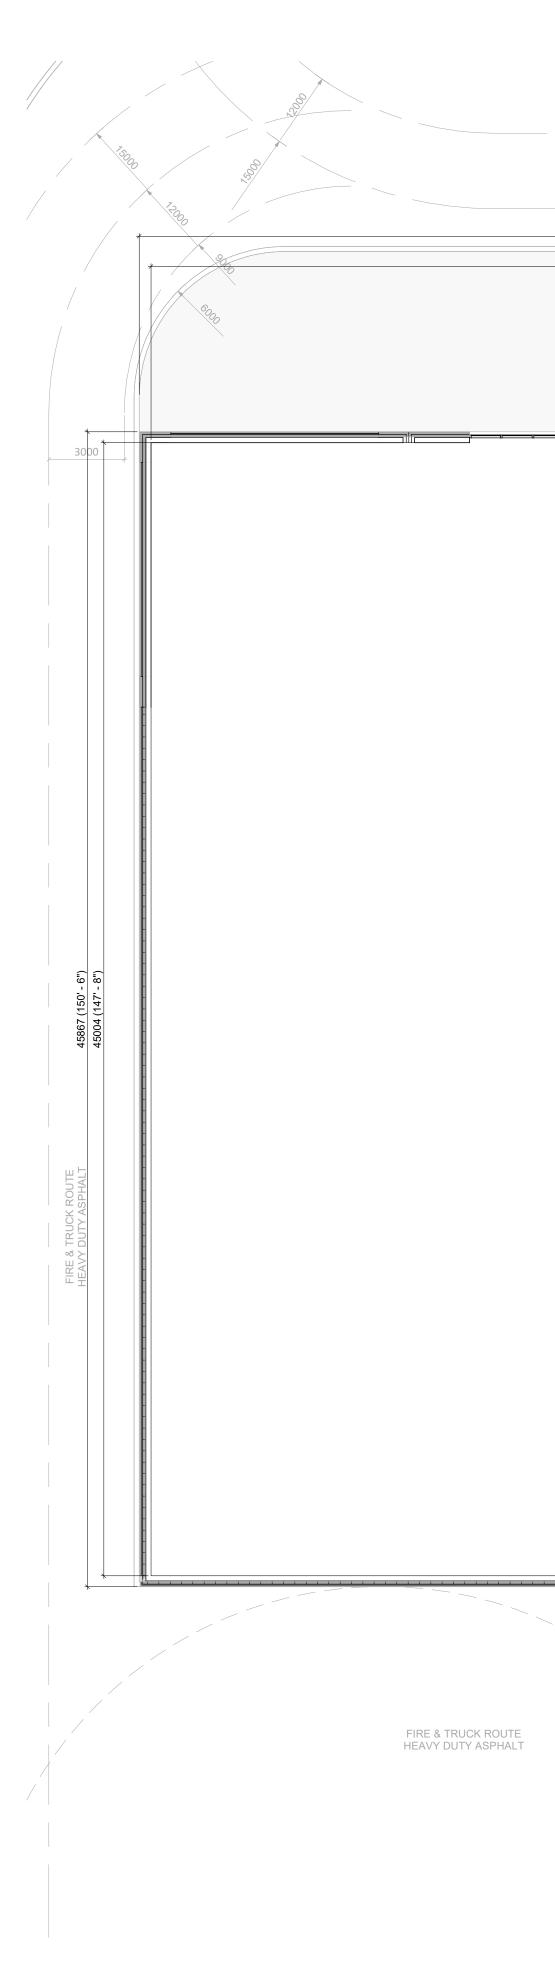

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	Information showing, refer to all applicable consulting of adving before proceeding with the work. Construction must conform to all applicable codes and requirements of authorities having jurisdiction. The contractor working from drawings not specifically marked 'For Construction' must assume full responsibility and bear costs for any corrections or damages resulting from his work.
PART 1 plan 4R-29284	
1.8 SIDEWALK	4 2023-05-01 ISSUED FOR COORDINATION FPI
	# DATE DESCRIPTION BY Loblaw Companies Limited PROJECT CAMBRIAN RD (S. PARCEL) BARRHAVEN, ON
	DRAWING BUILDING A - FLOOR PLAN
	PROJECT NO. 21.326SD PROJECT DATE 2023-05-01 DRAWN BY FPI CHECKED BY RAD SCALE 1:150
	DRAWING NO. A101

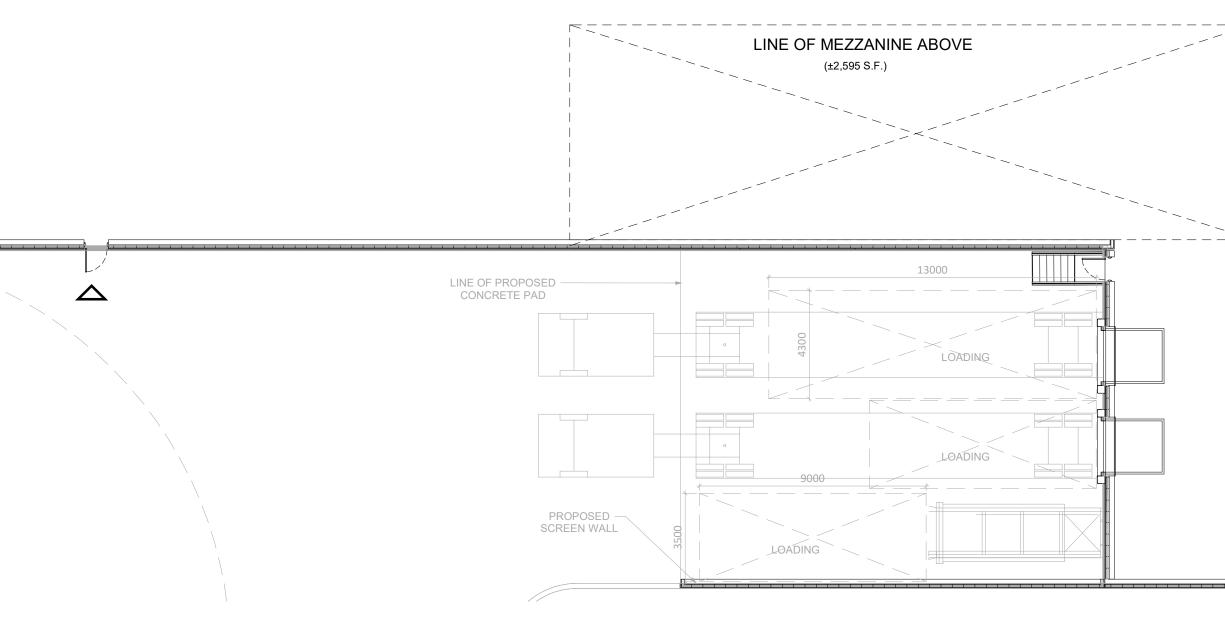

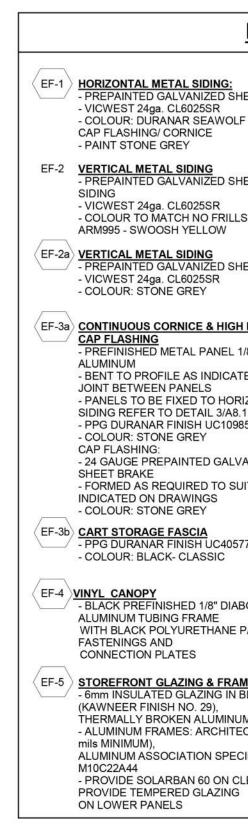



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EXTERIOR FINISH SCHEDULE

EF-1 HORIZONTAL METAL SIDING: - PREPAINTED GALVANIZED SHEET STEEL SIDING - VICWEST 24ga. CL6025SR - COLOUR: DURANAR SEAWOLF CAP FLASHING/ CORNICE - PAINT STONE GREY EF-2 VERTICAL METAL SIDING - PREPAINTED GALVANIZED SHEET STEEL - VICWEST 24ga. CL6025SR - COLOUR TO MATCH NO FRILLS YELLOW -

ARM995 - SWOOSH YELLOW EF-2a VERTICAL METAL SIDING - PREPAINTED GALVANIZED SHEET STEEL SIDING

- VICWEST 24ga. CL6025SR - COLOUR: STONE GREY

EF-3a CONTINUOUS CORNICE & HIGH PARAPET CORNICE CAP FLASHING - PREFINISHED METAL PANEL 1/8" THICK - PREFINISHED METAL PANEL 1/8 THICK ALUMINUM - BENT TO PROFILE AS INDICATED WITH BUTT JOINT BETWEEN PANELS - PANELS TO BE FIXED TO HORIZONTAL METAL SIDING REFER TO DETAIL 3/A8.1 - PPG DURANAR FINISH UC109855

- COLOUR: STONE GREY - 24 GAUGE PREPAINTED GALVANIZED STEEL - FORMED AS REQUIRED TO SUIT PROFILE AS INDICATED ON DRAWINGS

EF-3b CART STORAGE FASCIA - PPG DURANAR FINISH UC40577/ 5MB86928 - COLOUR: BLACK- CLASSIC


EF-4 VINYL CANOPY - BLACK PREFINISHED 1/8" DIABOND ON 1"x1" ALUMINUM TUBING FRAME WITH BLACK POLYURETHANE PAINT FINISH WITH FASTENINGS AND CONNECTION PLATES


- EF-5
 STOREFRONT GLAZING & FRAMES

 6mm INSULATED GLAZING IN BLACK ANODIZED


 - SIMM INSULATED GLAZING IN BLACK ANODIZED (KAWNEER FINISH NO. 29), THERMALLY BROKEN ALUMINUM FRAMES - ALUMINUM FRAMES: ARCHITECTURAL CLASS I (.7 ALUMINUM ASSOCIATION SPECIFICIATION: AA-- PROVIDE SOLARBAN 60 ON CLEAR GLASS.
- EF-5a CART STORAGE GLAZING & FRAMES 6mm GLAZING IN BLACK ANODIZED (KAWNEER FINISH NO. 29) ALUMINUM FRAMES - ALUMINUM FRAMES: ARCHITECTURAL CLASS I (.7 mils MINIMUM), ALUMINUM ASSOCIATION SPECIFICIATION: AA-M10C22A44 - PROVIDE TEMPERED GLAZING ON LOWER PANELS EF-5b SPANDREL PANEL & FRAMES -INKAN CUSTOM OPACICOATE FINISH OPACI-COAT-300 # 3-967 (BLACK GREY) ON INTERIOR FACE OF PANE WITH 22 GAUGE GALVANIZED METAL AND INSULATION BACKPAN - BLACK ANODIZED (KAWNEER FINISH NO. 29), THERMALLY BROKEN ALUMINUM FRAMES - ALUMINUM FRAMES: ARCHITECTURAL CLASS I (.7 mils MINIMUM), ALUMINUM ASSOCIATION SPECIFICIATION: AA-M10C22A44 EF-6 MISCELLANEOUS DOORS & OPENINGS - PAINT BLACK (PT4-SICO 922.180) EF-6a OVERHEAD DOORS - PREFINISHED STANDARD WHITE EF-6b GLAZED ALUMINUM DOOR - 6mm GLAZING IN BLACK ANODIZED (KAWNEER FINISH NO. 29), ALUMINUM FRAMES (TO MATCH GLAZING SYSTEM) - ALUMINUM FRAMES: ARCHITECTURAL CLASS I (.7 mils MINIMUM), ALUMINUM ASSOCIATION SPECIFICIATION: AA-M10C22A44 EF-7 EXTERIOR STAIRS, HANDRAILS, PICKETS & STRINGER - PAINT BLACK (PT4-SICO 922.180) EF-8 BUILDING PROTECTION BOLLARD - STEEL PIPE BOLLARD FILLED WITH CONCRETE - PAINTED SAFETY YELLOW - REFER TO DETAIL C-05 AND C-06 (EF-9) CONCRETE FOUNDATION CURB

4	2023-05-01	ISSUED FOR COORDINATION	FPI
3	2023-04-24	ISSUED FOR COORDINATION	FPI
2	2023-02-24	ISSUED FOR COORDINATION	FPI
1 #	2023-01-24 DATE	ISSUED FOR COORDINATION DESCRIPTION	FPI BY
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PR	OJECT CA	MBRIAN RD (S. PARCEL)	
		BARRHAVEN, ON	
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	В	UILDING A ELEVATIONS	
	OJECT NO.		
	21.326SD		
	OJECT DATE		
1	2023-05-01		
DR	AWN BY	-	
3	FPI		
СН	ECKED BY		
	RCH		
	ALE As indicated		
		A301	

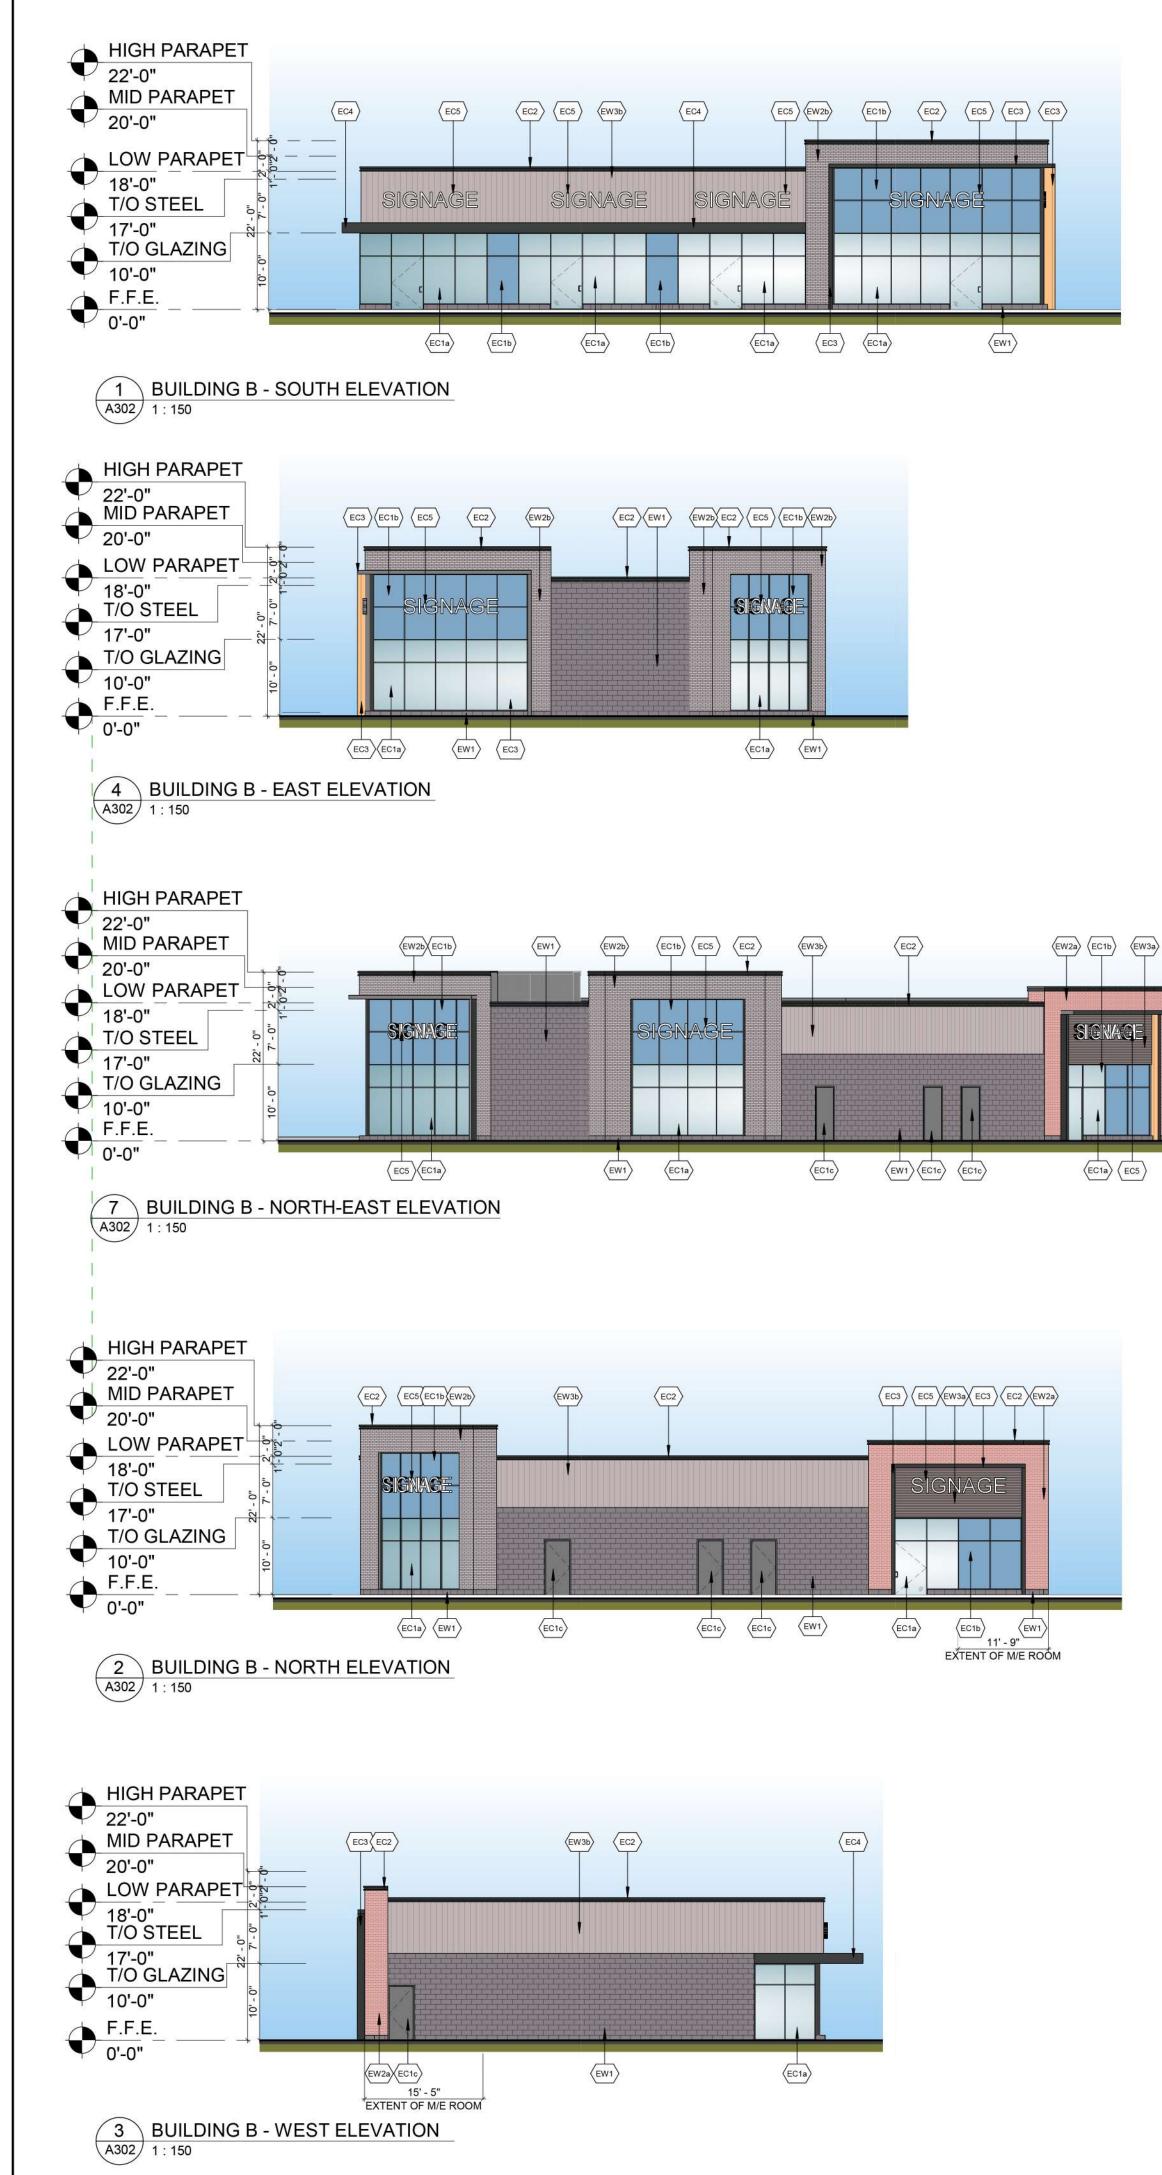

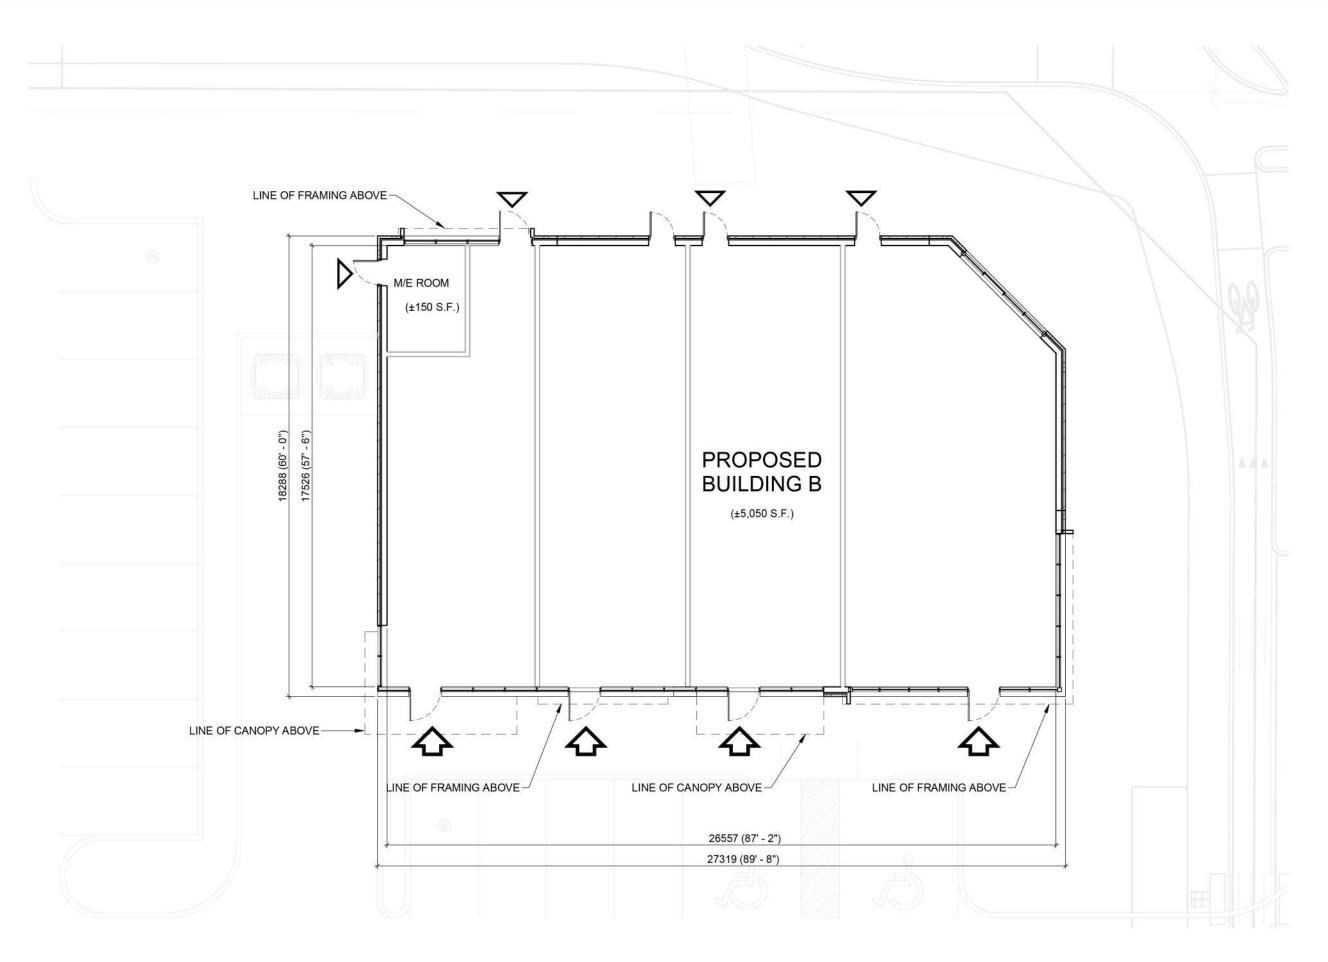



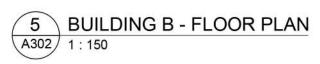

	EXTERIOR FINI	SH SCHE	DULE
(EW1)	ARCHITECTURAL BLOCK: PRODUCT: CONCRETE MASONRY COLOUR: DARK GREY MORTAR: DARK GREY SEE MANUFACTURER'S STANDARD SPECIFICATIONS CONTROL JOINT AND CAULKING COLOURS TO MATCH MASONRY UNIT COLOUR.	(EC1a)	GLAZED DOORS & WINDOWS: CURTAIN WALL & STOREFRONT FRAMING SYSTEM COLOUR: BLACK ANODIZED THERMALLY BROKEN ALUMINUM FRAMES GLAZING: CLEAR INSULATED VISION GLASS c/w LOW-E GLAZING
EW2a	<u>BRICKS:</u> PRODUCT: BRICK MASONRY COLOUR: BROWN MORTAR: WHITE SEE MANUFACTURER'S STANDARD SPECIFICATIONS CONTROL JOINT AND CAULKING	(EC1b)	SPANDREL GLAZED DOORS & WINDOWS: BLACK ANODIZED ALUMINUM FRAMES CLEAR GLASS UNIT WITH CUSTOM COLOUR COATING ON INBOARD SURFACE OF OUTERLITE (TEMPERED GLASS TO BE USED AT DOORS AND SIDELIGHTS) COLOUR: BLACK ANODIZED
EW2b	COLOURS TO MATCH MASONRY UNIT COLOUR.	(EC1c)	H.M. DOORS & FRAMES: PREFINISHED HOLLOW METAL DOORS AND FRAMES PAINT DARK GREY
EWZD	PRODUCT: BRICK MASONRY COLOUR: LIGHT GREY MORTAR: LIGHT GREY SEE MANUFACTURER'S STANDARD SPECIFICATIONS CONTROL JOINT AND CAULKING COLOURS TO MATCH MASONRY UNIT COLOUR.	EC2	PREFINISHED METAL CAP FLASHING: PRE-FINISHED 20 GA. METAL FLASHING COLOUR: BLACK REFER TO DETAILS FOR PROFILE
(EW3a)	METAL SIDING - HORIZONTAL PRODUCT: METAL PANELS PROFILE: CORRUGATED COLOUR: CHARCOAL	EC3	ACM PORTAL: PRODUCT: ALPOLIC COMPOSITE METAL PANEL COLOUR: CHARCOAL SOFFIT: METAL COMPOSITE WOOD FINISH, COLOUR: MPL MAPLE
(EW3b)	METAL SIDING - VERTICAL	EC4	ACM CANOPY: PRODUCT: ALPOLIC COMPOSITE METAL PANEL COLOUR: CHARCOAL
<u> </u>	PRODUCT: METAL PANELS PROFILE: CORRUGATED COLOUR: LIGHT GREY	(EC5)	EXTERIOR SIGNAGE: SIGNAGE TO BE PROVIDED BY AND INSTALLED BY TENANT

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3 2023-05-01 ISSUED FOR COORDINATION FPI 2 2023-04-19 ISSUED FOR COORDINATION FPI 1 2023-02-23 ISSUED FOR COORDINATION FPI
DATE DESCRIPTION BY
CAMBRIAN RD (S. PARCEL)
BARRHAVEN, ONTARIO
BUILDING B ELEVATIONS
PROJECT NO. 21.326SD
PROJECT DATE 2023-05-01 DRAWN BY
FPI CHECKED BY RAD SCALE
As indicated
DRAWING NO. A302