



ZONING COMPLIANCE CHART - ZONING: GM[1628]		
	REQUIRED	
Minimum Lot Width (m)	N/A	
Minimum Lot Area (acres)	N/A	
Minimum Front Yard Setback (Cambrian Rd) (m)	3 m	
Minimum Rear Yard Setback (m)	7.5 m (from any portion of a rear lot line abutting a residential zone)	
Minimum Interior Side Yard Setback (m)	5 m (for a non-residential or mixed-use building, from any portion of lot line abutting a residential zone)	
Maximum Height (m)	18 m	
Maximum Floor Space Index	N/A	
Minimum Parking Dimensions (m)	2.6m x 5.2m	
Minimum Parking required (3.6 per 100 s.m. of total GFA)	132 spaces	
Minimum Bicycle Parking required (1 per 500 s.m. of GFA)	8 spaces	
Loading spaces (for up to 4999 s.m. of GFA)	1 standard space (3.5x9x4.2 m) 1 oversized space (4.3x13x4.2 m)	
Minimum Drive Aisle Width (parking angle at 90 degrees) (m)	6.7 m	



PROPOS	ED
	76.98 m
	3.66 acres
	3 m
	21.76 m

9.38 m West 1.10 m East

7.48 m / 1 storey


0.24 2.7m x 5.5m

180 spaces


8 spaces

3 standard spaces 1 oversized space

6.7 m

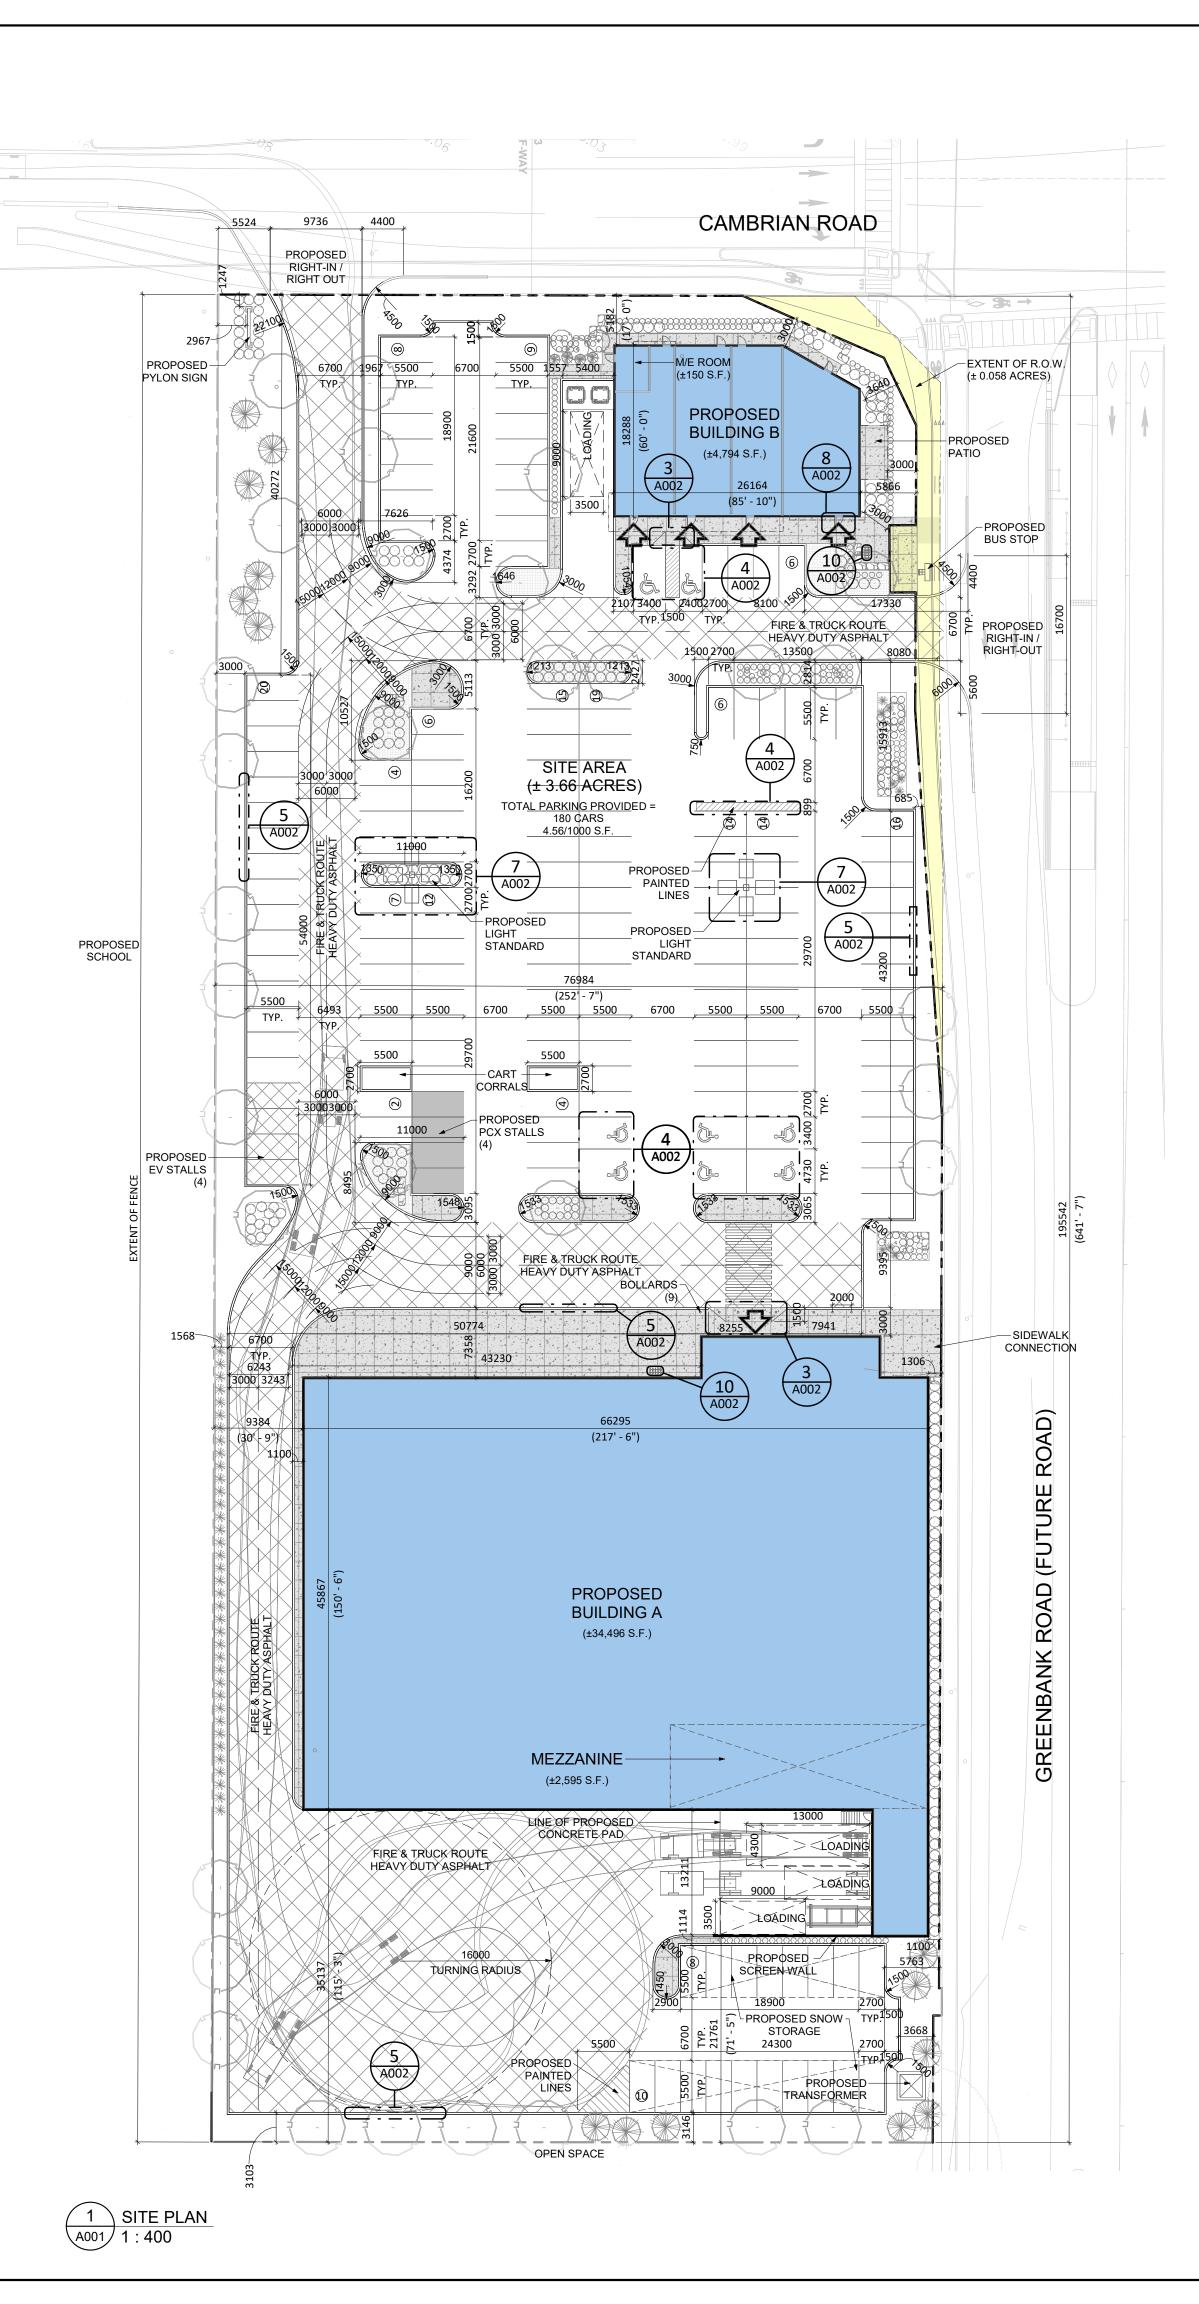

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Turner Fleischer Architects Inc. 67 Lesmill Road Toronto, ON, M3B 2T8 T 416 425 2222		
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LEGAL DESCRIPTION		
TOPOGRAPHIC PLAN OF PART OF LOT 10 CONCESSION 3 (RIDEAU FRONT) GEOGRAPHIC TOWNSHIP OF NEPEAN CITY OF OTTAWA		
STATISTICS		
SITE AREA ± 3.66 ACRES ± 1.48 HA. PROPOSED BUILDING A AREA $\pm 34,496$ S.F. $\pm 3,205$ S.M. MEZZANINE AREA $\pm 2,595$ S.F. ± 241 S.M. TOTAL BUILDING A AREA $\pm 37,091$ S.F. $\pm 3,446$ S.M. PROPOSED BUILDING B $\pm 4,794$ S.F. $\pm 3,446$ S.M. PROPOSED BUILDING B $\pm 4,794$ S.F. ± 1445 S.M. PROPOSED M/E ROOM ± 150 S.F. ± 1445 S.M. TOTAL BUILDING B AREA $\pm 4,944$ S.F. ± 459 S.M. TOTAL GROSS FLOOR AREA $\pm 39,440$ S.F. $\pm 3,664$ S.M. TOTAL BUILDING AREA $\pm 39,440$ S.F. $\pm 3,905$ S.M. TOTAL BUILDING AREA $\pm 39,640$ S.F. $\pm 3,005$ S.M. TOTAL PARKING PROVIDED 180 CARS $4.56/1000$ S.F. $4.60/100$ S.M. COVERAGE 24.74 %		
LEGEND		
PROPOSED BUILDING PROPOSED ENTRANCE ARROW		
PROPOSED CONCRETE SIDEWALK		
PROPOSED FIRE & TRUCK ROUTE (HEAVY DUTY ASPHALT)		
PROPOSED PCX PARKING		
PROPOSED EV PARKING		
PROPOSED TRANSFORMER		
EXTENT OF RIGHT OF WAY (R.O.W.)		
12 2023-10-25 ISSUED FOR SPA FPI 11 2023-10-18 ISSUED FOR COORDINATION FPI 10 2023-10-12 ISSUED FOR COORDINATION FPI 9 2023-09-05 ISSUED FOR COORDINATION FPI 8 2023-08-28 ISSUED FOR COORDINATION FPI 7 2023-08-28 ISSUED FOR COORDINATION FPI 6 2023-05-08 ISSUED FOR COORDINATION FPI 5 2023-05-01 ISSUED FOR COORDINATION FPI 5 2023-05-01 ISSUED FOR COORDINATION FPI 4 2023-04-24 ISSUED FOR COORDINATION FPI 3 2023-03-30 ISSUED FOR COORDINATION FPI 2 2023-03-28 ISSUED FOR COORDINATION FPI 2 2023-03-28 ISSUED FOR COORDINATION FPI 1 2023-03-02 ISSUED FOR COORDINATION FPI 1 2023-03-02 ISSUED FOR COORDINATION FPI 1 2023-03-02 ISSUED FOR COORDINATION FPI		
Loblaw Companies Limited		
PROJECT CAMBRIAN RD (S. PARCEL)		
BARRHAVEN, ONTARIO		
DRAWING SITE PLAN & FLOOR PLAN		
PROJECT NO. 21.326SD PROJECT DATE 2023-10-25 DRAWN BY FPI CHECKED BY RCH SCALE 1:400 DRAWING NO. A001		

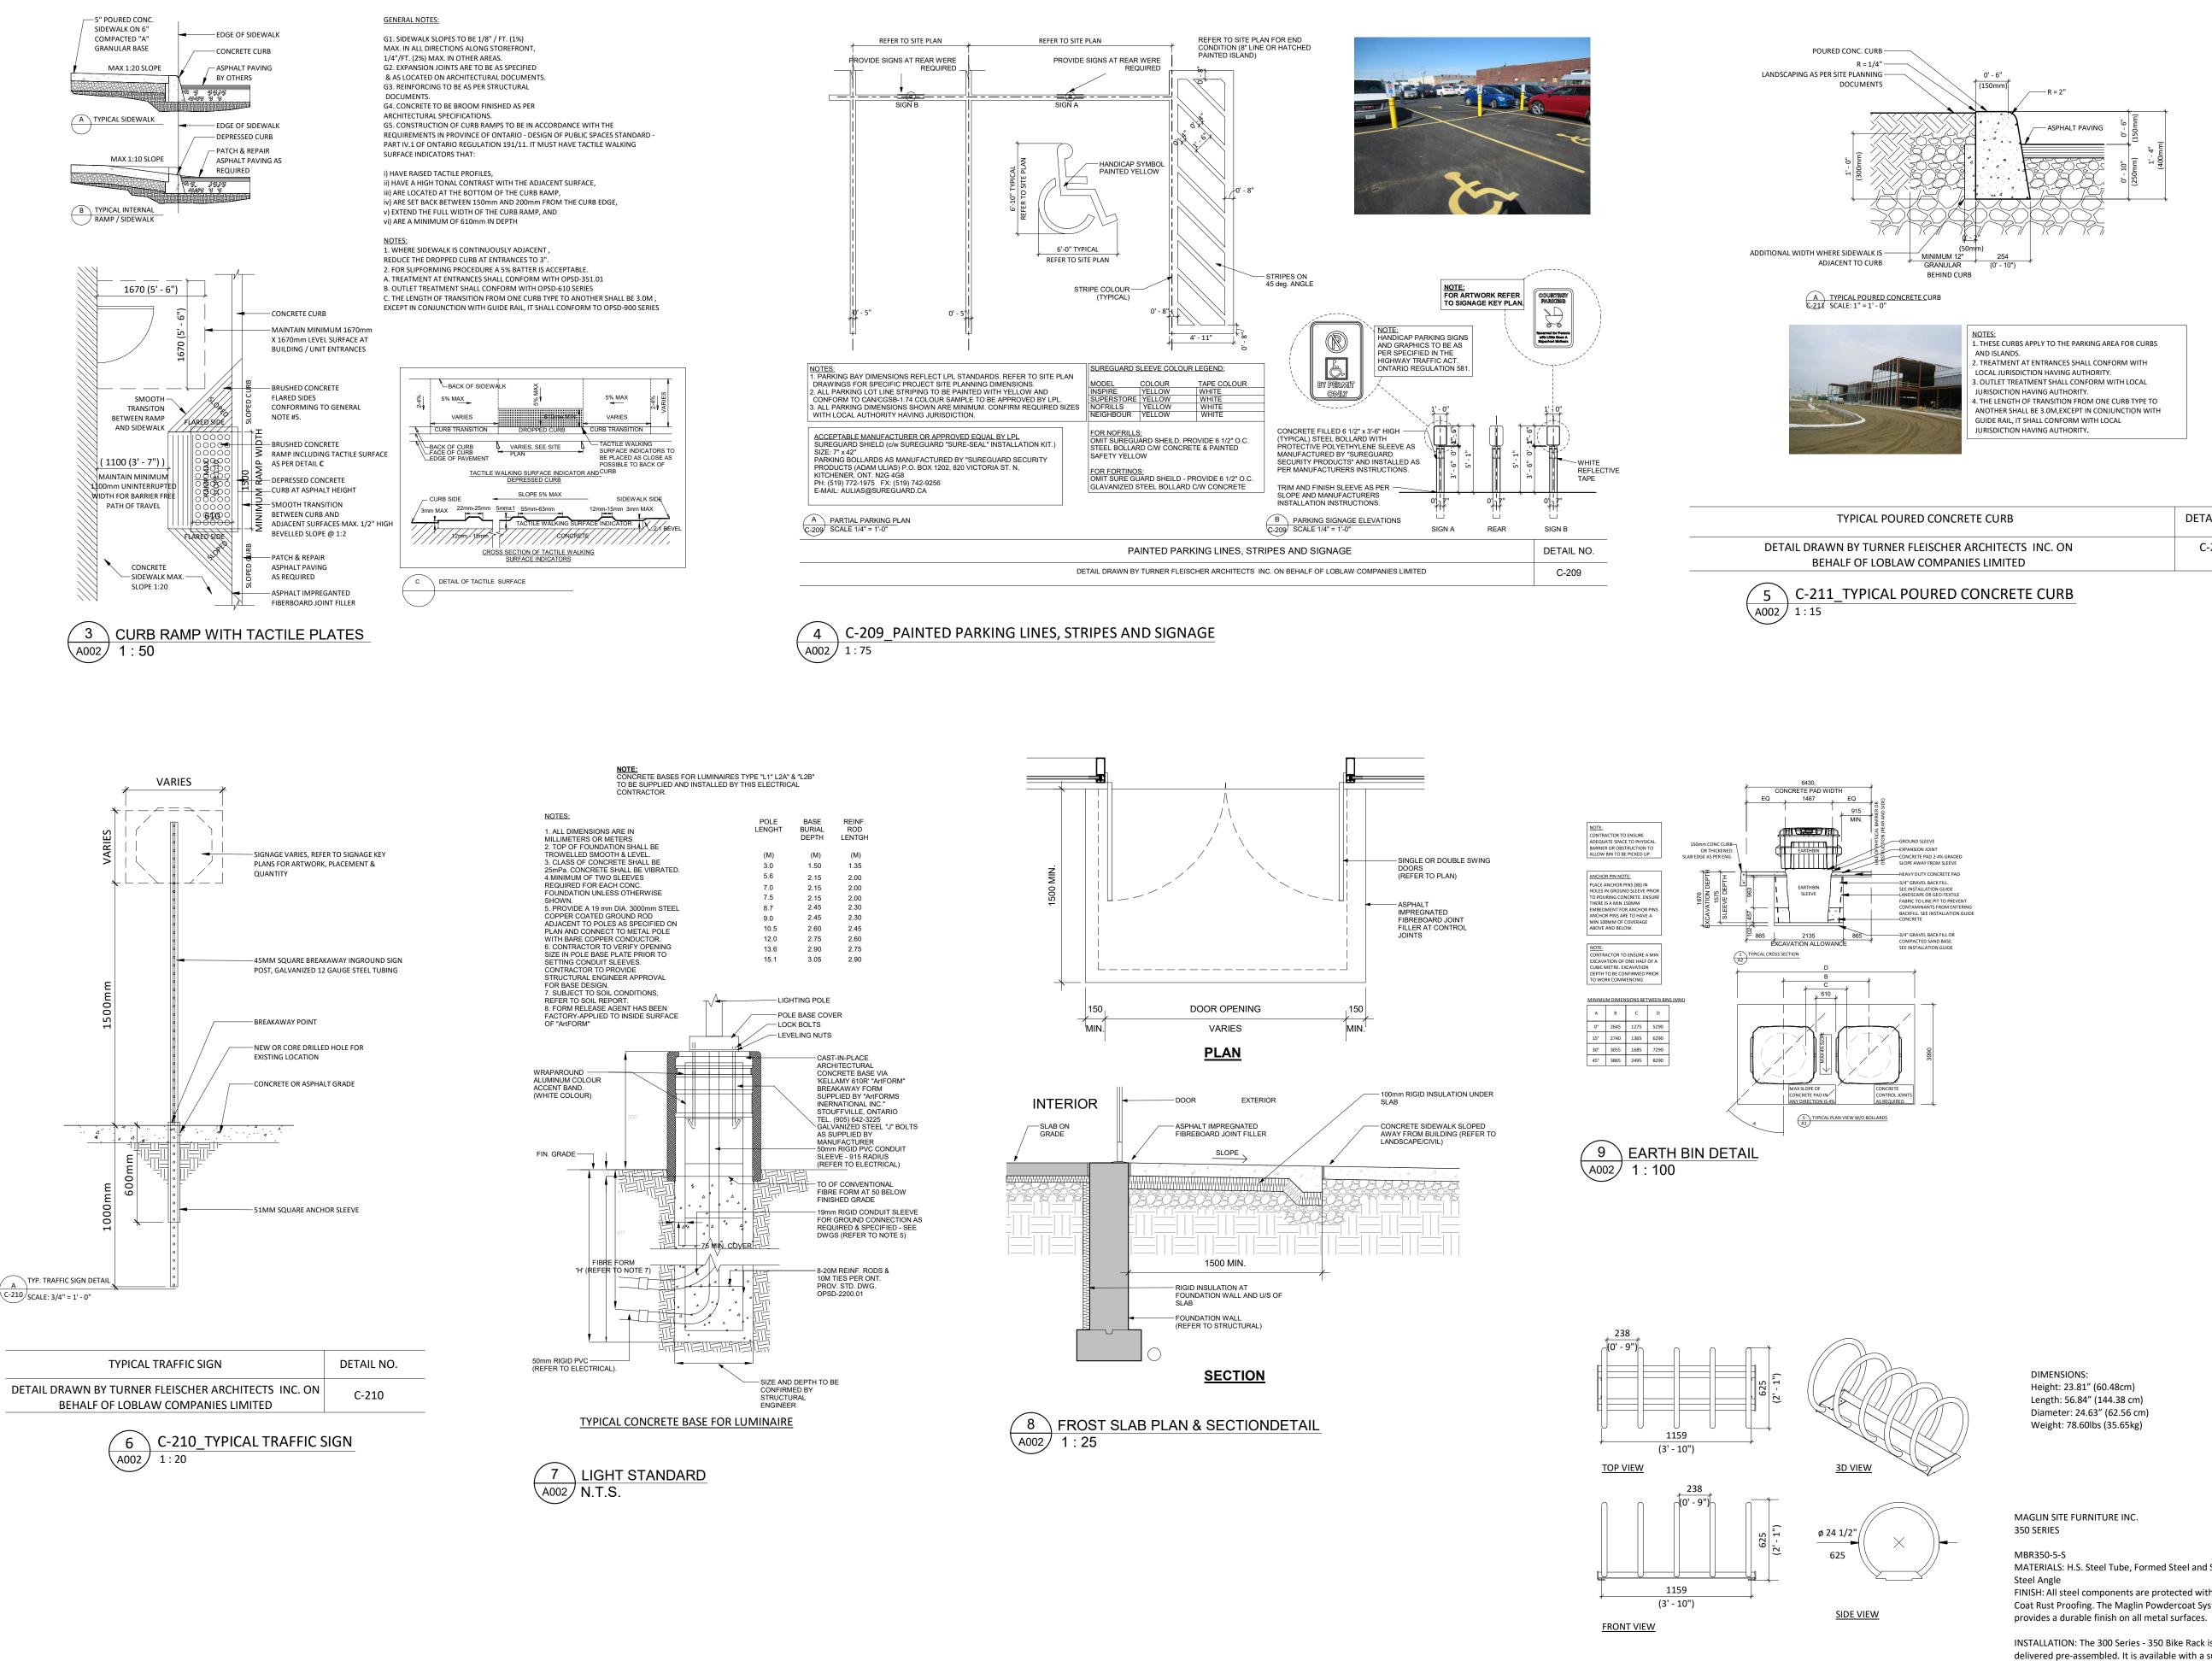

10 BICYCLE RACK DETAIL - 12 SPACES A002 1 : 25

D CONCRETE CURB	DETAIL NO.
EISCHER ARCHITECTS INC. ON COMPANIES LIMITED	C-211

MATERIALS: H.S. Steel Tube, Formed Steel and Solid FINISH: All steel components are protected with E-Coat Rust Proofing. The Maglin Powdercoat System

INSTALLATION: The 300 Series - 350 Bike Rack is delivered pre-assembled. It is available with a surface mount installation.

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RO.IEC CAMBRIAN RD (S. PARCEL)

BARRHAVEN, ONTARIO

DRAWING

SITE DETAILS

PROJECT NO. 21.326SD PROJECT DATE 2023-10-25 DRAWN BY FPI CHECKED BY RAD SCALE As indicated