
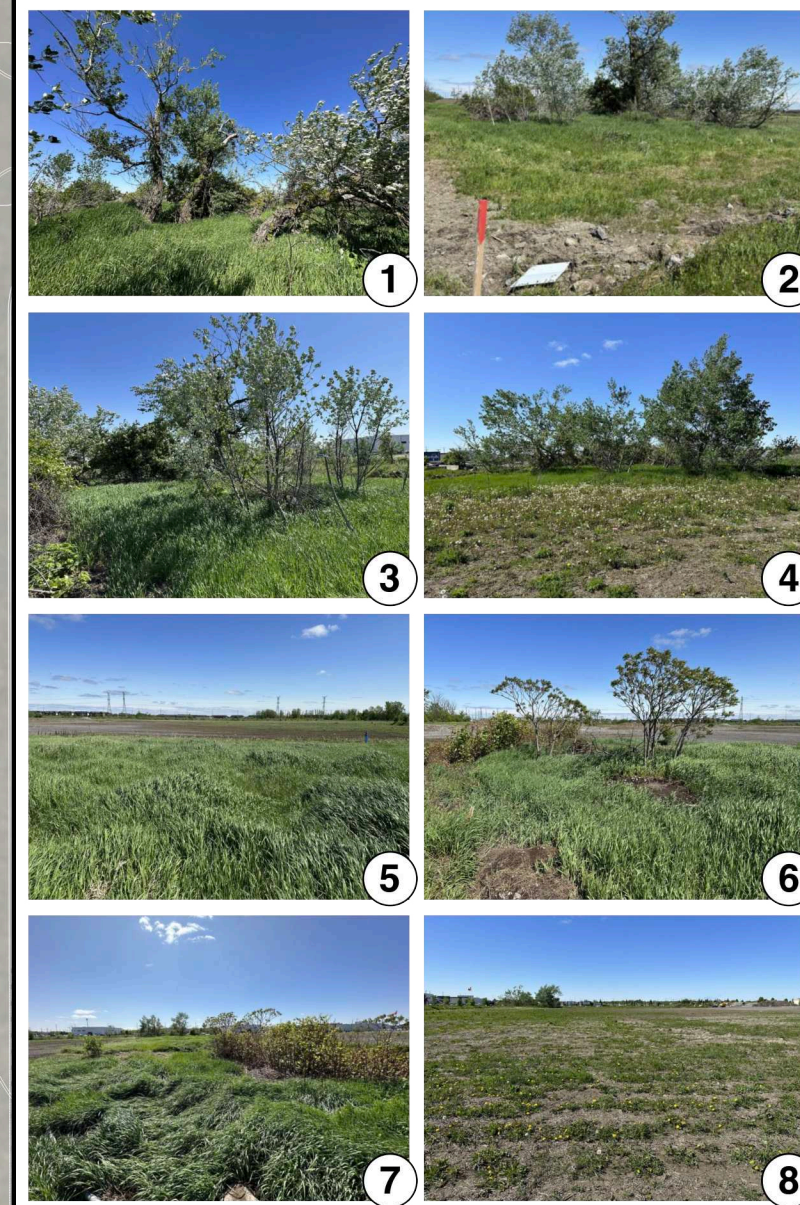


SITE CONTEXT

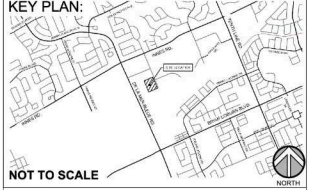

**NOTES:**  
 SITE INVESTIGATION FOR THE TREE CONSRATION REPORT WAS CARRIED OUT BY STUDIO RED LANDSCAPE ARCHITECTURE INC., ON MAY 8 & 24, 2023.  
 REMNANT TREE SPECIES IN THE NORTHWESTCORNER OF THE SITE ARE PREDOMINANTLY WHITE POPLAR; *Populus alba* AND HAWTHORN SPECIES; *Crataegus*. A SINGLE MANITOBA MAPLE; *Acer negundo* IS GROWING ON THE EAST SIDE OF THE POPLAR. THE PARENT POPLAR TREES ARE IN DECLINE AND IN POOR CONDITION WHILE THE SMALL EMERGING POPLAR COLONIES ARE IN GOOD HEALTH AND RANGE BETWEEN DBH 1 CM TO 15 CM.  
 THE NORTHEAST CORNER OF THE SITE CONTAINS A CLUMP OF YOUNG STAGHORN SUMAC; *Rhus typhina* AND A SINGLE SMALL HAWTHORN; *Crataegus* OF 8 CM CALIPER. A CLUMP OF INVASIVE JAPANESE KNOTWEED; *Fallopia japonica* IS THRIVING ADJACENT TO THE SUMAC.  
 ALL EXISTING TREES ARE PROPOSED FOR REMOVAL TO ACCOMMODATE SITE GRADING FOR THE PROPOSED TRINITY CROSSING DEVELOPMENT.  
 NEW TREES AND SHRUBS WILL BE PLANTED AS PER SITE PLAN CONTROL REQUIREMENTS.

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NOT TO SCALE  
 studioRed landscape architecture

Revision Schedule

No.	Description	Revision Date
1	ISSUED FOR CLIENT REVIEW	2023-05-25



# TREE CONSERVATION PLAN

# TRINITY CROSSING

SCALE - 1:300  
 TRUE NORTH PROJECT NORTH  
 DRAWN BY: K. SELIN  
 CHECKED BY: K. CERVENÝ  
 DATE: 2023-05-25  
 SCALE: 1:300  
 DRAWING #: TCR -1  
 REV #: