


1815 MONTREAL ROAD

1815 MONTREAL ROAD


ISSUED FOR SITE PLAN CONTROL 3.1: 2024.02.09

A000	COVER PAGE
A100	SITE PLAN
A101	SITE PLAN CONTEXT
A102	SITE ACCESS/ TURNING TEMPLATES
A.201	PARKING LEVEL 2 PLAN
A.202	PARKING LEVEL 1 PLAN
A.211	1st FLOOR PLAN
A.212	2nd FLOOR PLAN
A.213	3rd FLOOR PLAN
A.214	4th FLOOR PLAN
A.215	5th FLOOR PLAN
A.216	6th FLOOR PLAN
A.217	7th FLOOR PLAN
A.218	8th FLOOR PLAN
A.219	9th FLOOR PLAN
A.219a	PENTHOUS PLAN
A.300	SOUTH ELEVATION
A.301	EAST ELEVATION
A.302	NORTH ELEVATION
A.303	WEST ELEVATION
A.400	STREETSCAPE SECTIONS

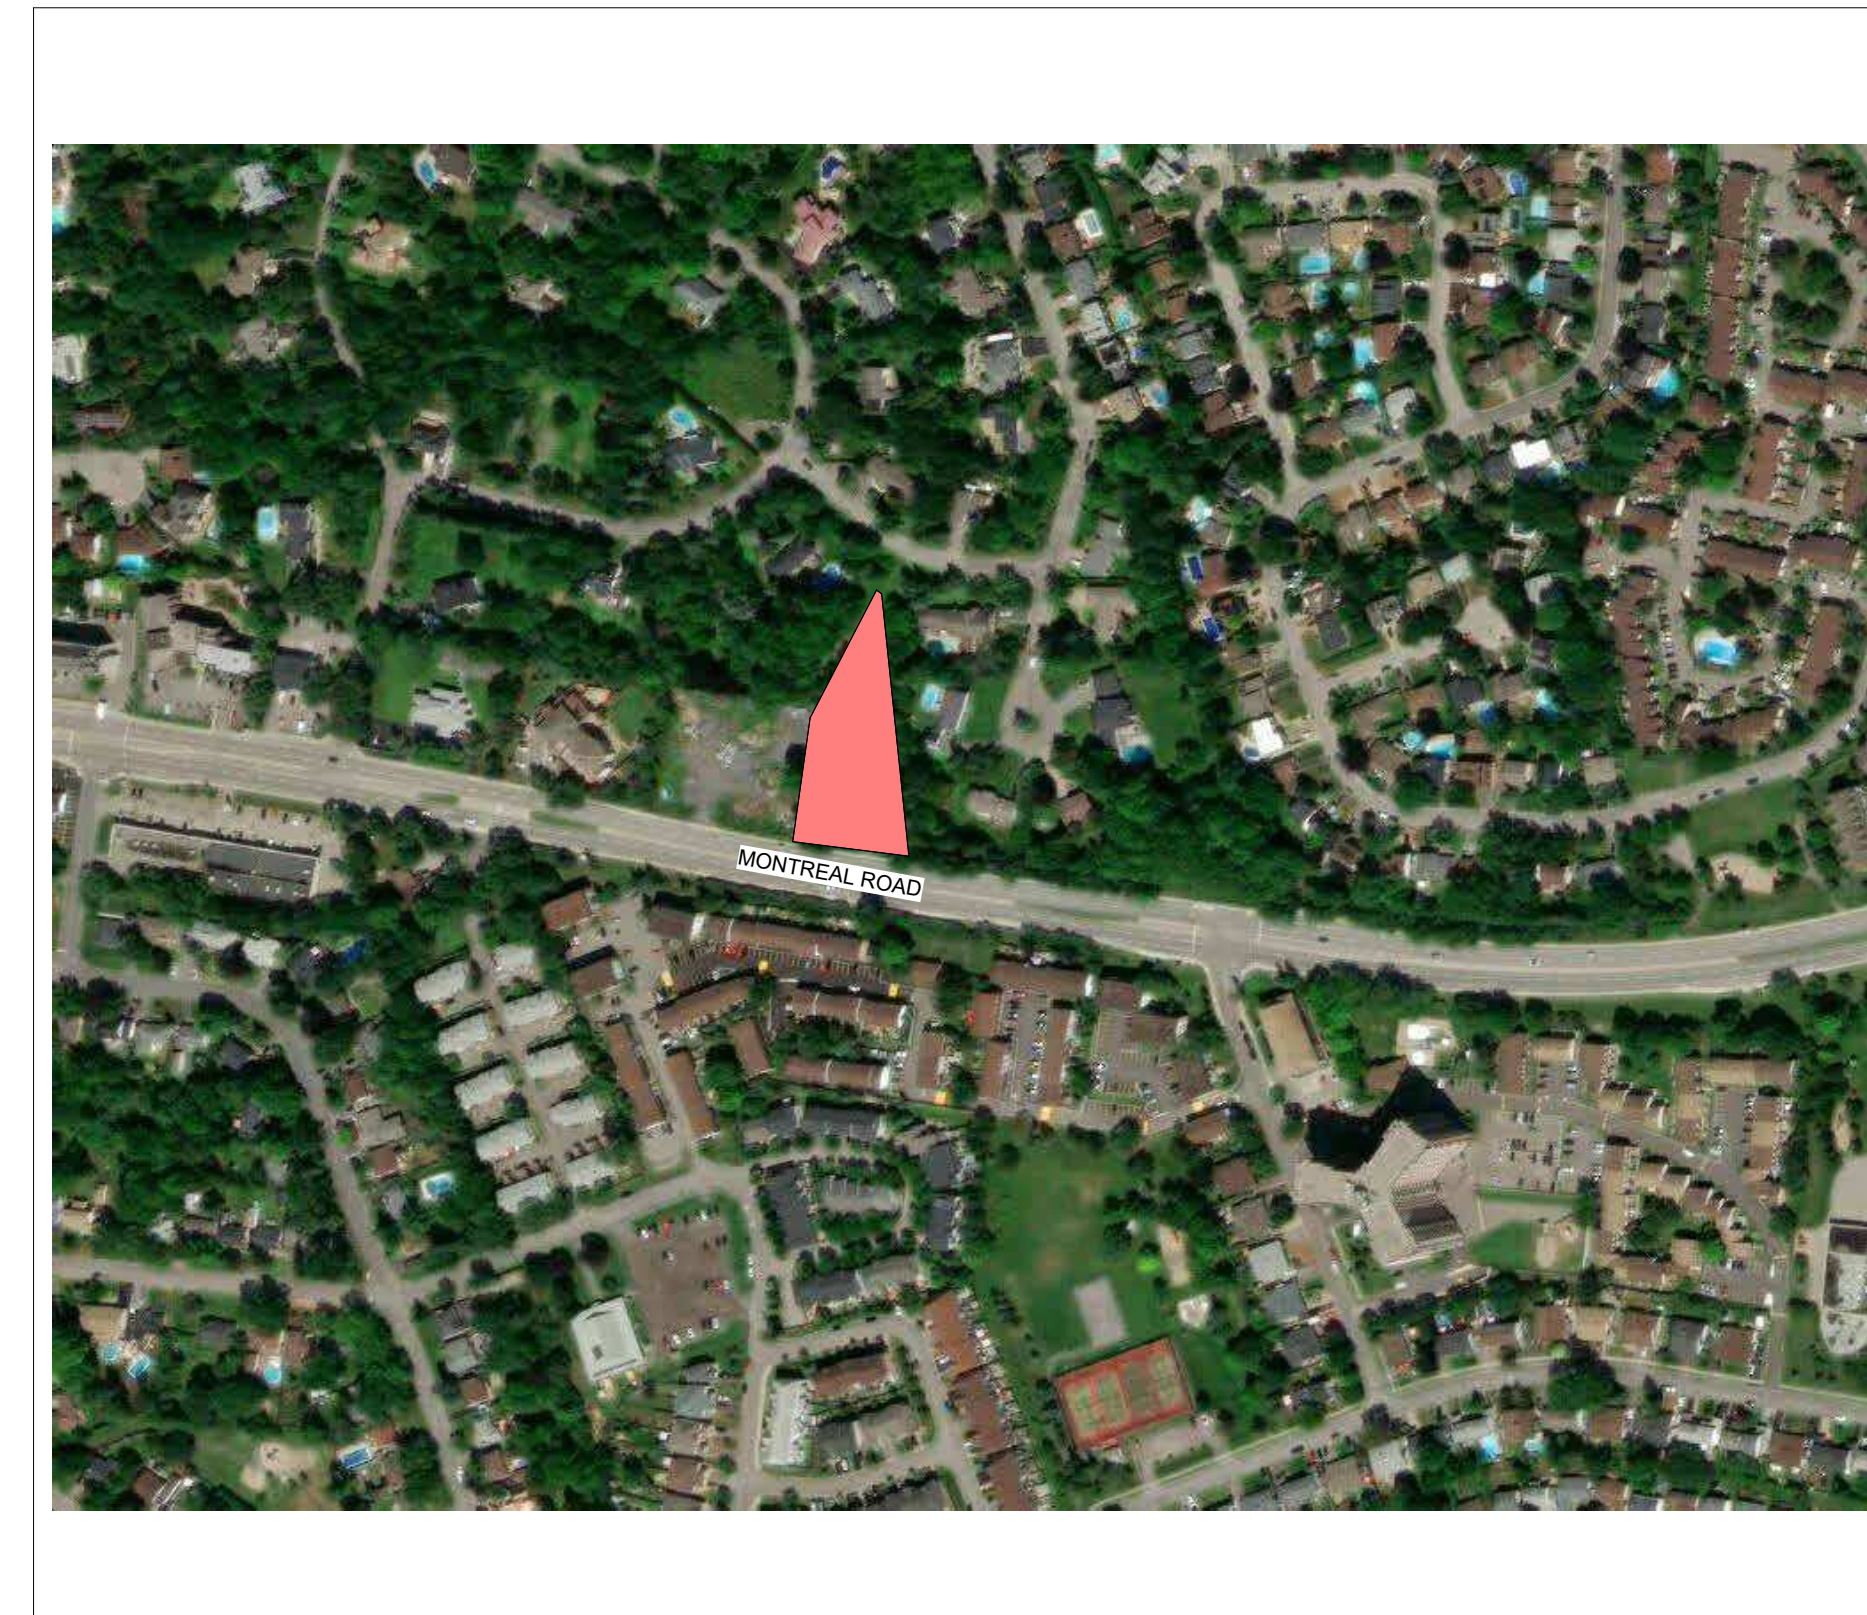

LOCATION PLAN

1:100

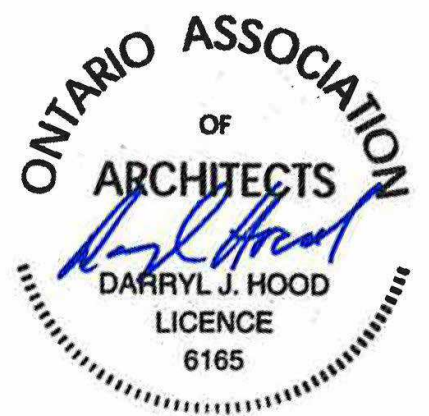

STAMP

8	2024.02.09	ISSUED FOR SITE PLAN CONTROL 3.1
7	2024.01.05	ISSUED FOR SITE PLAN CONTROL 3
6	2023.10.10	ISSUED FOR SITE PLAN CONTROL 2
5	2023.05.26	ISSUED FOR SITE PLAN CONTROL
2	2023.04.18	ISSUED FOR COORDINATION
1	2023.04.03	ISSUED FOR REVIEW

REV DATE ISSUE



NOTES

1. OWNERSHIP OF THE COPYRIGHT OF THE DESIGN AND THE WORKS EXECUTED FROM THE DESIGN REMAINS WITH CSV ARCHITECTS, AND MAY NOT BE REPRODUCED IN ANY FORM WITHOUT THE WRITTEN CONSENT OF CSV ARCHITECTS.
2. THE DRAWINGS, PRESENTATIONS AND SPECIFICATIONS AS INSTRUMENTS OF SERVICE ARE AND SHALL REMAIN THE PROPERTY OF CSV ARCHITECTS. THEY ARE NOT TO BE USED BY THE CLIENT ON OTHER PROJECTS OR ON EXTENSIONS TO THIS PROJECT WITHOUT THE WRITTEN CONSENT OF CSV ARCHITECTS.
3. THIS DRAWING IS TO BE READ IN CONJUNCTION WITH ALL OTHER PROJECT DRAWINGS AND SPECIFICATIONS.
4. DO NOT SCALE DRAWINGS. CONTRACTOR SHALL BE RESPONSIBLE TO VERIFY DIMENSIONS ON SITE.
5. ALL WORK SHALL BE IN ACCORDANCE WITH THE ONTARIO BUILDING CODE AND ALL SUPPLEMENTS AND APPLICABLE MUNICIPAL REGULATIONS.

CLIENT

OTTAWA
ONTARIO, CANADA

PROJECT

1815 MONTREAL ROAD

1815 MONTREAL ROAD

TITLE

COVER PAGE

PROJECT NO: 222450
DRAWN: R.R.
APPROVED: D.H.
SCALE: 1 : 100
DATE PRINTED: 2/9/2024 2:27:14 PM

REV DRAWING NO.

8 A000

SITE PLAN GENERAL NOTES:

- ALL GENERAL SITE INFORMATION AND CONDITIONS COMPILED FROM EXISTING PLANS AND SURVEYS
- DO NOT SCALE THIS DRAWING
- REPORT ANY DISCREPANCIES PRIOR TO COMMENCING WORK. NO RESPONSIBILITY IS BORN BY THE CONSULTANT FOR UNKNOWN SUBSURFACE CONDITIONS
- CONTRACTOR TO CHECK AND VERIFY ALL DIMENSIONS ON SITE AND REPORT ANY ERRORS AND/OR OMISSIONS TO THE CONSULTANT
- REINSTATE ALL AREAS AND ITEMS DAMAGED AS A RESULT OF CONSTRUCTION ACTIVITIES TO THE SATISFACTION OF THE CONSULTANT
- CONTRACTOR TO LAYOUT PLANTING BEDS, PATHWAYS ETC. TO APPROVAL OF CONSULTANT PRIOR TO ANY JOB EXCAVATION
- THE ACCURACY OF THE POSITION OF UTILITIES IS NOT GUARANTEED - CONTRACTOR TO VERIFY PRIOR TO EXCAVATION
- INDIVIDUAL UTILITY COMPANY MUST BE CONTACTED FOR CONFIRMATION OF UTILITY EXISTENCE AND LOCATION PRIOR TO DIGGING
- ALL DISTURBED AREAS TO BE RESTORED TO ORIGINAL CONDITION OR BETTER UNLESS OTHERWISE NOTED

SITE PLAN KEYNOTES:

- HYDRO-TRANSFORMER
- 6m WIDE FIRE TRUCK ACCESS
- UNDERGROUND PARKING ACCESS RAMP
- DEPRESSED CURB
- PRIVATE PATIO
- PRIVACY FENCE
- 8 X VISITOR BIKE RACKS 1800x600 TYP
- VISITOR PARKING SPACE
- EXISTING RETAINING WALL
- INTERLOCK AREA/ GARBAGE PICKUP
- NEW ASPHALT LANEWAY
- RETAINING WALL
- GATE
- BALCONIES ABOVE
- ACCESS TO SITE DESIGNED AS PER CITY OF OTTAWA "CURB RETURN ENTRANCE" DWG. NO. SC7.1 "CURB RETURN AT A PRIVATE OR COMMERCIAL ENTRANCE WITH BOULEVARD - UNSIGNALIZED INTERSECTION"



STAMP

REV DATE	ISSUE
8 2024.02.09	ISSUED FOR SITE PLAN CONTROL 3.1
7 2024.01.05	ISSUED FOR SITE PLAN CONTROL 3
6 2023.10.10	ISSUED FOR SITE PLAN CONTROL 2
5 2023.05.26	ISSUED FOR SITE PLAN CONTROL 4
4 2023.05.25	ISSUED FOR COORDINATION
3 2023.05.04	ISSUED FOR COORDINATION
2 2023.04.18	ISSUED FOR COORDINATION
1 2023.04.03	ISSUED FOR REVIEW

NOTES

- OWNERSHIP OF THE COPYRIGHT OF THE DESIGN AND THE WORKS EXECUTED FROM THE DESIGN REMAINS WITH CSV ARCHITECTS, AND MAY NOT BE REPRODUCED IN ANY FORM WITHOUT THE WRITTEN CONSENT OF CSV ARCHITECTS.
- THE DRAWINGS, PRESENTATIONS AND SPECIFICATIONS AS INSTRUMENTS OF SERVICE ARE AND SHALL REMAIN THE PROPERTY OF CSV ARCHITECTS. THEY ARE NOT TO BE USED BY THE CLIENT ON OTHER PROJECTS OR ON EXTENSIONS TO THIS PROJECT WITHOUT THE WRITTEN CONSENT OF CSV ARCHITECTS.
- THIS DRAWING IS TO BE READ IN CONJUNCTION WITH ALL OTHER PROJECT DRAWINGS AND SPECIFICATIONS.
- DO NOT SCALE DRAWINGS. CONTRACTOR SHALL BE RESPONSIBLE TO VERIFY DIMENSIONS ON SITE.
- ALL WORK SHALL BE IN ACCORDANCE WITH THE ONTARIO BUILDING CODE AND ALL SUPPLEMENTS AND APPLICABLE MUNICIPAL REGULATIONS.

CLIENT

OTTAWA
ONTARIO, CANADA

PROJECT

1815 MONTREAL ROAD

1815 MONTREAL ROAD

TITLE

SITE PLAN


PROJECT NO: 222450
DRAWN: R.R.
APPROVED: D.H.
SCALE: As Indicated
DATE PRINTED: 2/9/2024 2:27:16 PM

REV DRAWING NO.

8 A100

SITE PLAN LEGEND:

- EXISTING BUILDING
- ASPHALT PAVING
- PARKLAND AREA
- NEW GRASS
- CONCRETE SIDEWALK
- PATIO PAVER TYPE
- MULCH
- OTHER ENTRANCES / EXIT
- SERVICE DOORS
- BUILDING MAIN ENTRANCE
- PROPERTY LINE
- FENCE
- EXISTING OVERHEAD WIRE
- PERIMETER OF EXCAVATION
- FIRE HYDRANT
- FIRE HYDRANT EXISTING
- UTILITY POLE EXISTING
- SIAMESE CONNECTION
- DROPPED CURB
- SIGN
- NEW TREE

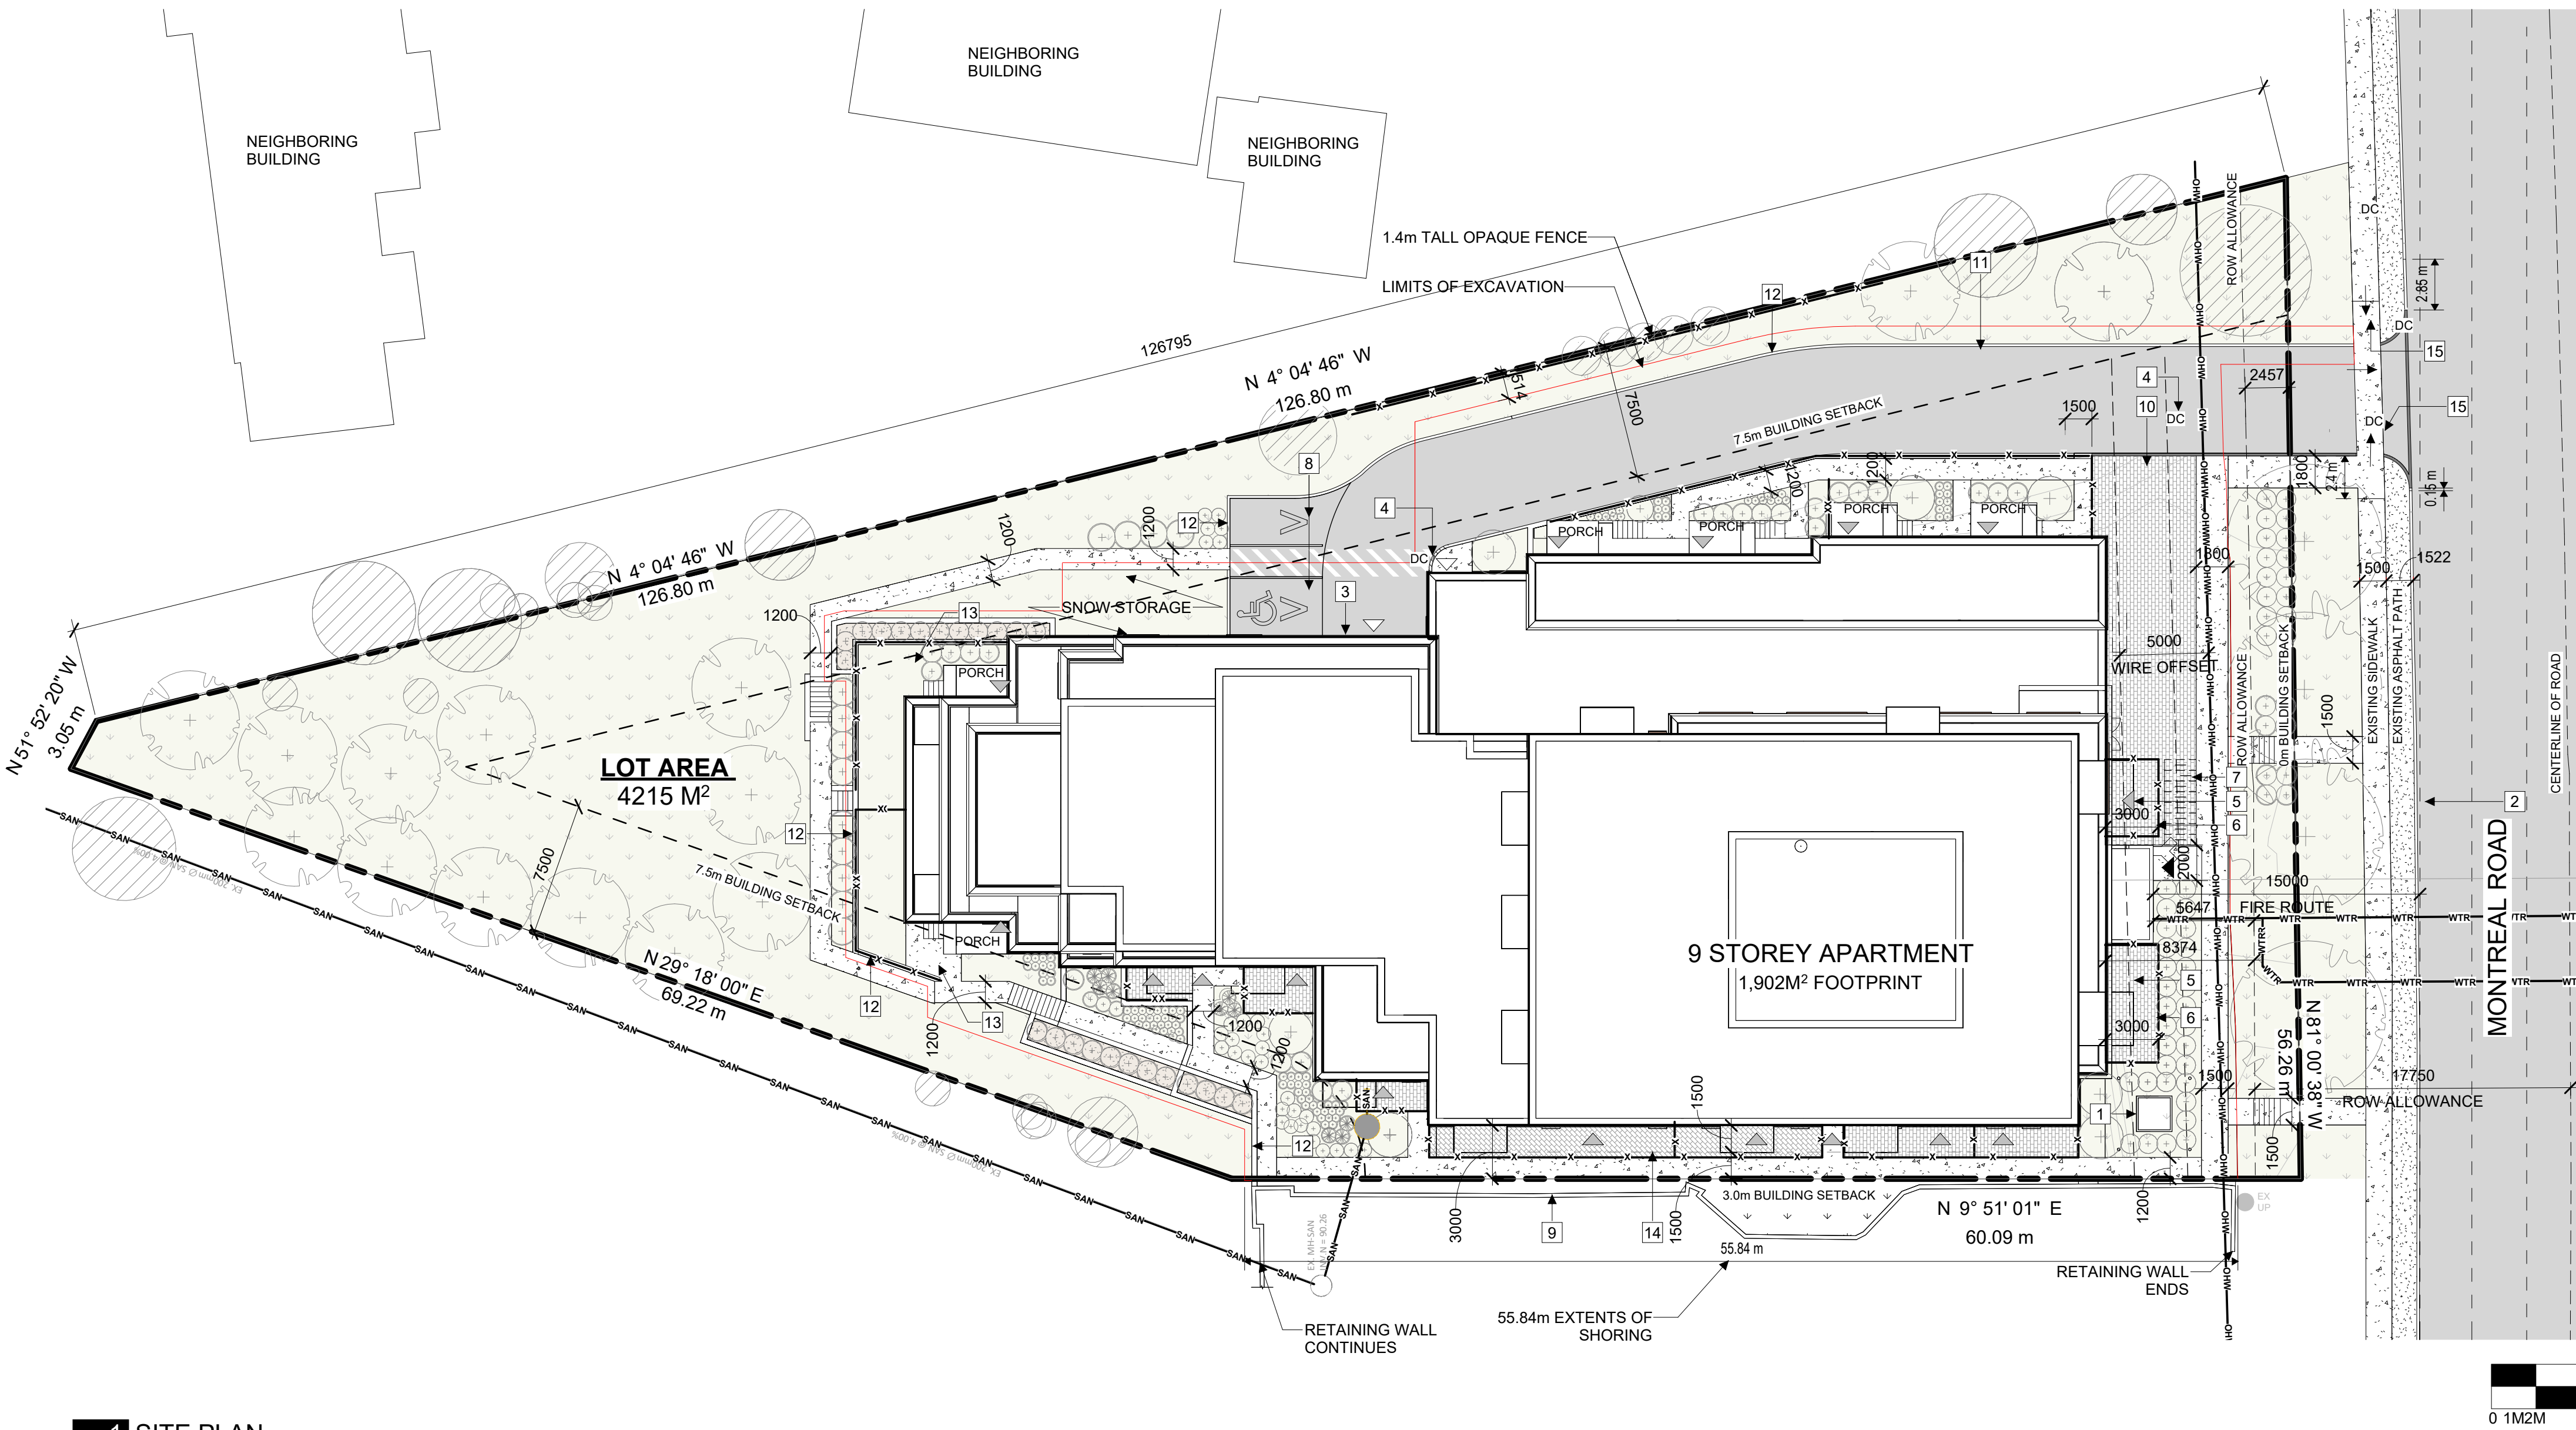

1 SITE PLAN
A100 1:250

LEGAL DESCRIPTION:

LOT 141 REGISTERED PLAN 652
CITY OF OTTAWA

REFERENCE SURVEY:

BASED ON INFORMATION FROM A SURVEY
PREPARED BY R.P., J.D. BARNES LIMITED, DATED:
3RD DAY OF OCTOBER, 2022.

MUNICIPAL ADDRESS:

1815 MONTREAL ROAD, CITY OF OTTAWA, ON

DEVELOPMENT INFORMATION:

SITE AREA	4,215 m ²
BUILDING FOOTPRINT	1,902 m ²
LOT COVERAGE	= 45%
GROSS FLOOR AREA (1st FLOOR - 9th FLOOR)	10,918 m ²
BUILDING HEIGHT	+/-31m

ZONE Proposed - AM10
Current - R1AA

SCHEDULE 1: AREA C "URBAN AND GREEN BELT AREA"

SCHEDULE 1A: AREA C "SUBURBAN"

SCHEDULE 2: DISTANCE EXCEEDS 600 m

UNIT MIX

1 BED APT	54
2 BED APT	55
3 BED APT	2
GFU*	6
BACH	13
TOTAL	130

DENSITY

SITE AREA (m ²)	4352
SITE AREA (Ha)	0.4352
DENSITY du/Ha	299

*GROUND FACING UNIT

ZONING PROVISION

ZONING PROVISION	REQUIRED	PROVIDED
MIN. LOT WIDTH	NO MINIMUM	54.9m AFTER ROW
MIN. LOT AREA	NO MINIMUM	4215m ² AFTER ROW
MIN. FRONT YARD SETBACK	3m	5.6m
ROW DEDICATION REQUIREMENT	17.75m FROM CENTERLINE (2.39m)	2.4m
HYDRO SETBACK	5m	5m
MIN. REAR YARD SETBACK	7.5m	45.5m
MIN. INTERIOR SIDE YARD ABUTTING A RESIDENTIAL ZONE	7.5m	7.5m
MIN. INTERIOR SIDE YARD ABUTTING AN AM. ZONE	0M	3.0M

Maximum Building Height (m) (height is from average grade)	Up to 20 meters from a R1, R2, R3 Zone	11m	East:24.8m West: 31.28m
20m to 30m from R1-R3 Zone	20m		31.28m
30m from property line abutting R1-R4 Zone	30m, max. 9 storeys.		
In all other cases	30m, max. 9 storeys.		

Landscaped Area	Abutting a residential zone	Min 3 m; reduced to 1 m where 1.4 m high opaque fence is provided	East: 1.0m, 1.4m opaque fence is provided.
In all other cases	No minimum		

TOTAL LANDSCAPED AREA 1,916M²

ZONING PROVISION

ZONING PROVISION	REQUIRED	PROVIDED
Amenity Space Requirements	6m ² per dwelling unit. Min 50% communal, aggregated into areas of 54m ² and where more than one aggregated area is provided, at least one must be minimum 54m ² = 780 m ² (Can count towards landscape requirements)	Balconies= 805.7 m ² Communal Rooftop Terrace (2 nd and 7 th floor): 135 m ² Outdoor Private Patio (ground floor): 127 m ² Interior amenity space = 205.7 m ² Rear Yard Area: 770.2 m ² Total amenity area= 2043.6 m ²


PARKING QUEUING + LOADING

RESIDENTIAL SPACES	REQUIRED	PROVIDED
	156	89 TOTAL (18) 4.6m x 2.4m (71) 6m x 2.6m

VISITOR SPACES	REQUIRED	PROVIDED
	26	18 TOTAL (16) 5.2m x 2.6m (2) BF 6m x 3.40m C/W 1.5m Transfer space

BICYCLE PARKING	REQUIRED	PROVIDED
	65	Total: 66 Residential: 12 @P2 Residential: 19 @P1 Residential: 27 @L1 Visitors: 8 Outside All spaces are 1.8m x 0.6m

Waste / Garbage Collection Location	If outdoor: Located within 9m from lot line abutting a public street, 3m from any other lot line, and screened from view with an opaque screen of minimum height of 2m.	Pickup staging at interlock paver area greater than 9m away from lot line abutting a public street.
-------------------------------------	---	---

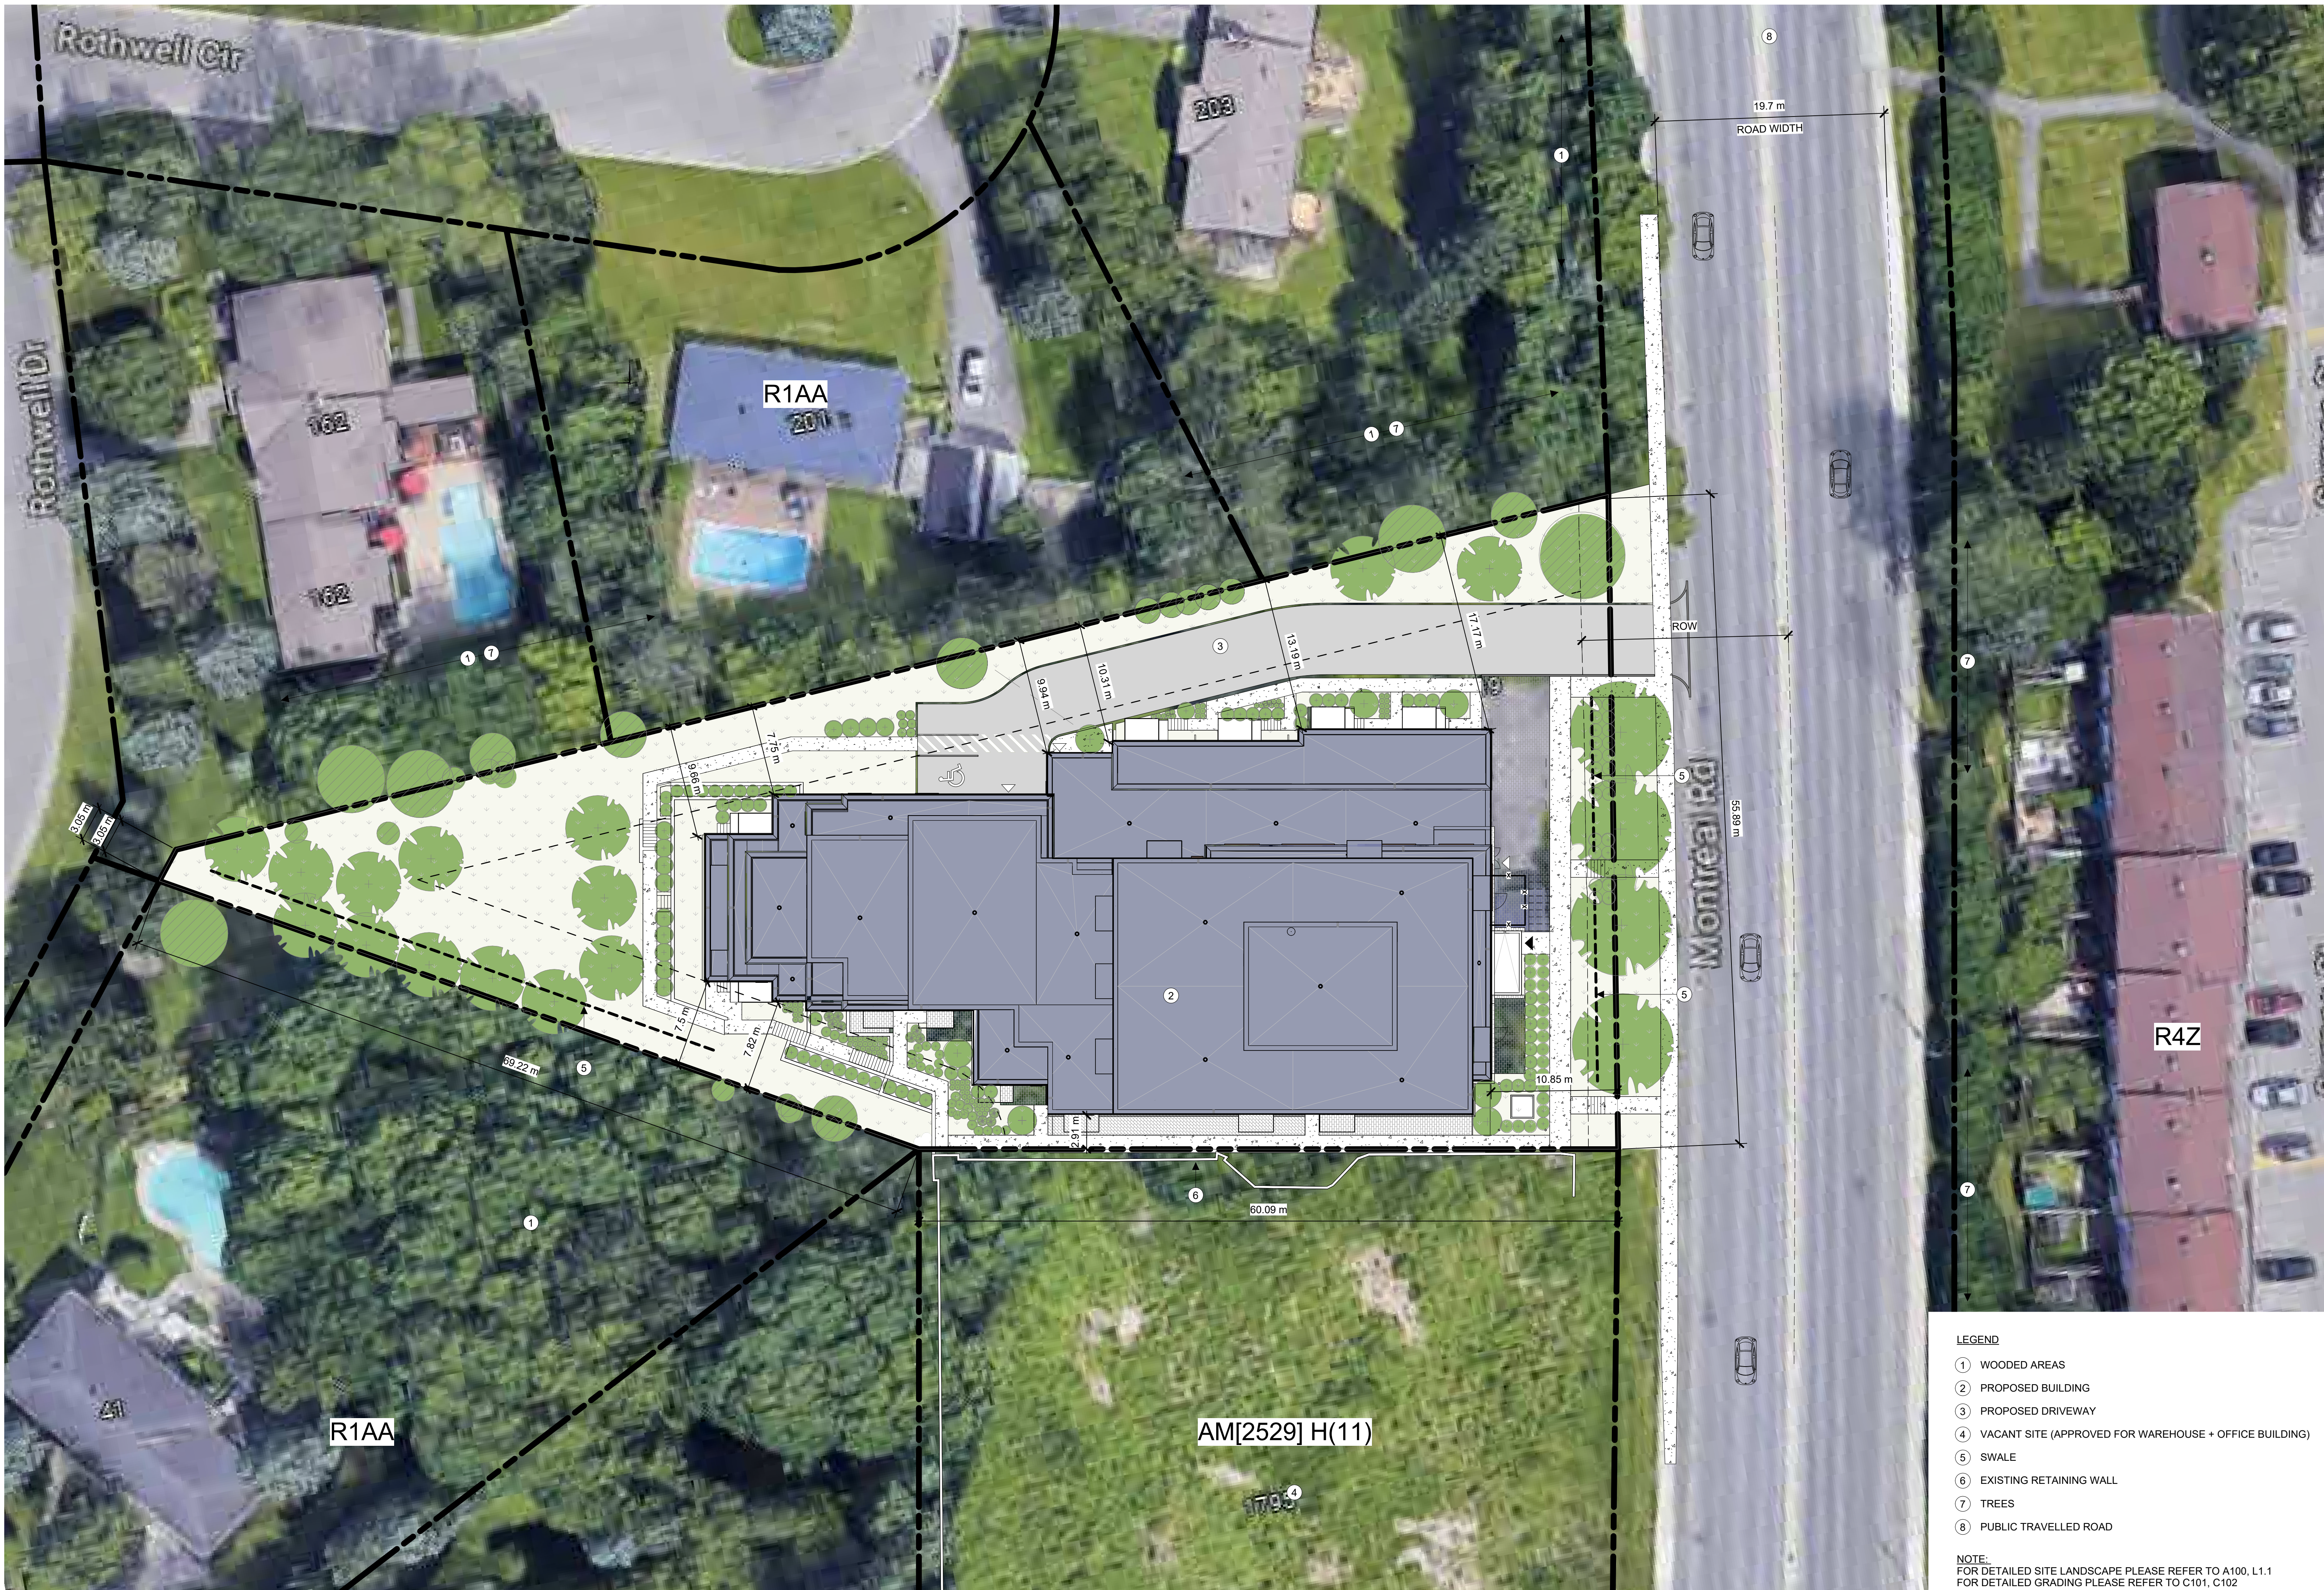

STAMP

8	2024.02.09	ISSUED FOR SITE PLAN CONTROL 3.1
7	2024.01.05	ISSUED FOR SITE PLAN CONTROL 3
6	2023.10.10	ISSUED FOR SITE PLAN CONTROL 2
5	2023.05.26	ISSUED FOR SITE PLAN CONTROL

REV DATE	ISSUE

- NOTES
1. OWNERSHIP OF THE COPYRIGHT OF THE DESIGN AND THE WORKS EXECUTED FROM THE DESIGN REMAINS WITH CSV ARCHITECTS, AND MAY NOT BE REPRODUCED IN ANY FORM WITHOUT THE WRITTEN CONSENT OF CSV ARCHITECTS.
 2. THE DRAWINGS, PRESENTATIONS AND SPECIFICATIONS AS INSTRUMENTS OF SERVICE ARE AND SHALL REMAIN THE PROPERTY OF CSV ARCHITECTS. THEY ARE NOT TO BE USED BY THE CLIENT ON OTHER PROJECTS OR ON EXTENSIONS TO THIS PROJECT WITHOUT THE WRITTEN CONSENT OF CSV ARCHITECTS.
 3. THIS DRAWING IS TO BE READ IN CONJUNCTION WITH ALL OTHER PROJECT DRAWINGS AND SPECIFICATIONS.
 4. DO NOT SCALE DRAWINGS. CONTRACTOR SHALL BE RESPONSIBLE TO VERIFY DIMENSIONS ON SITE.
 5. ALL WORK SHALL BE IN ACCORDANCE WITH THE ONTARIO BUILDING CODE AND ALL SUPPLEMENTS AND APPLICABLE MUNICIPAL REGULATIONS.

CLIENT

OTTAWA
ONTARIO, CANADA

PROJECT
1815 MONTREAL ROAD

1815 MONTREAL ROAD


TITLE
SITE PLAN CONTEXT

PROJECT NO: 222450
DRAWN: R.R.
APPROVED: D.H.
SCALE: 1: 250
DATE PRINTED: 2/9/2024 2:32:01 PM

REV DRAWING NO.
8 A101

- LEGEND
- ① WOODED AREAS
 - ② PROPOSED BUILDING
 - ③ PROPOSED DRIVEWAY
 - ④ VACANT SITE (APPROVED FOR WAREHOUSE + OFFICE BUILDING)
 - ⑤ SWALE
 - ⑥ EXISTING RETAINING WALL
 - ⑦ TREES
 - ⑧ PUBLIC TRAVELLED ROAD


NOTE:
FOR DETAILED SITE LANDSCAPE PLEASE REFER TO A100, L1.1
FOR DETAILED GRADING PLEASE REFER TO C101, C102

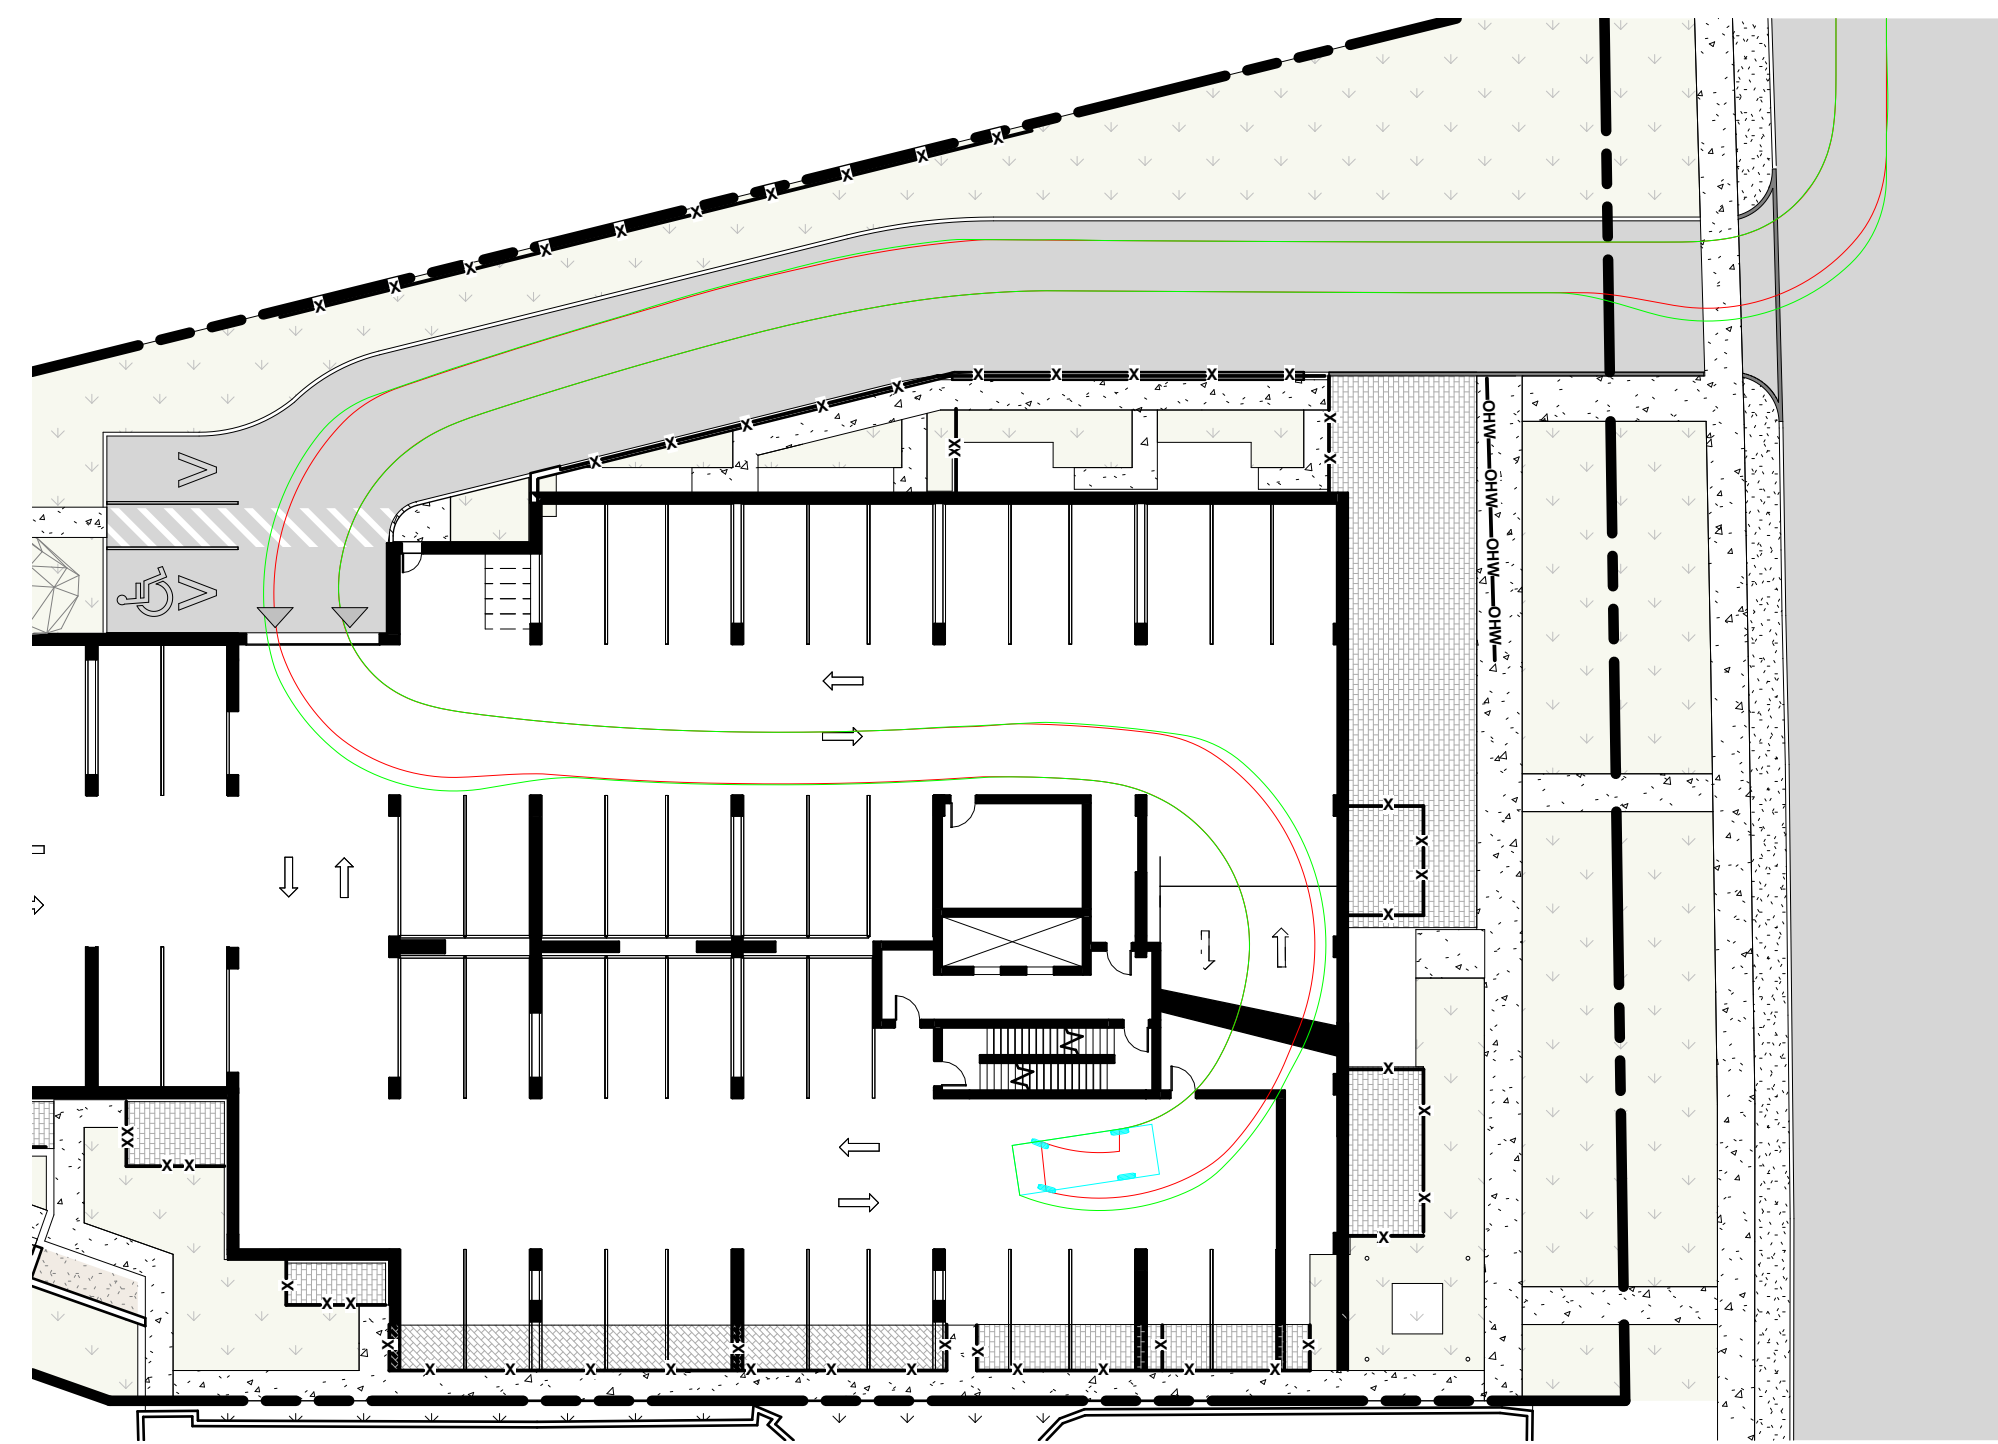

P - Passenger Car


Passenger Car	
Overall Length	5.600m
Overall Width	2.000m
Overall Body Height	1.555m
Min Body Ground Clearance	0.340m
Track Width	2.000m
Lock-to-lock time	4.00s
Curb to Curb Turning Radius	6.300m

5 TURNING TEMPLATE - Car Entering
A102 | 1:300

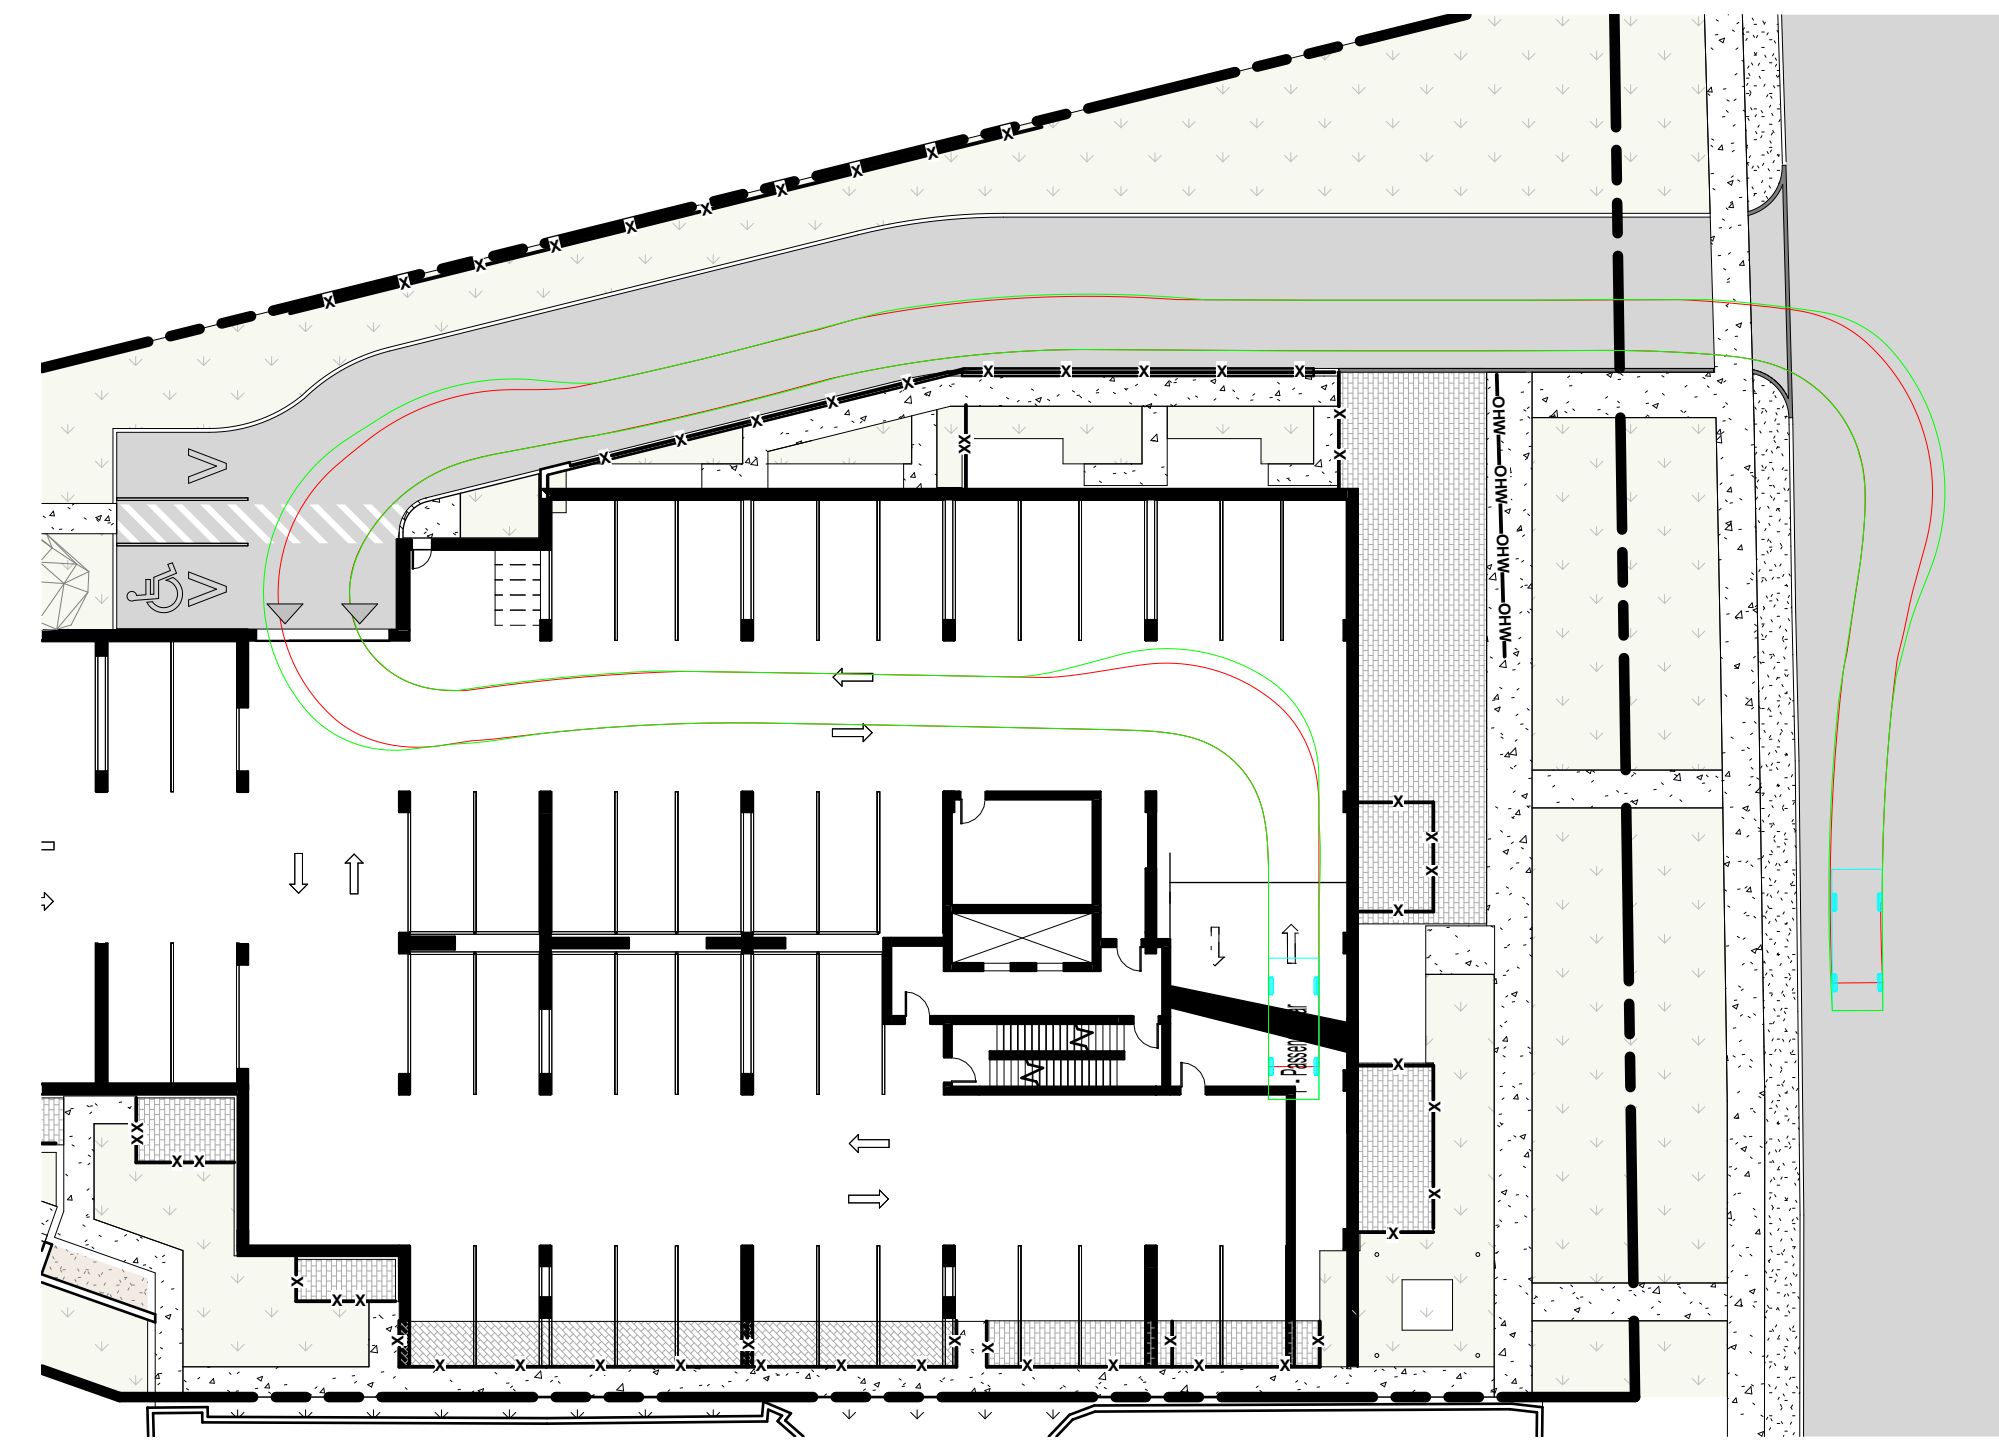


Passenger Car	
Overall Length	5.600m
Overall Width	2.000m
Overall Body Height	1.555m
Min Body Ground Clearance	0.340m
Track Width	2.000m
Lock-to-lock time	4.00s
Curb to Curb Turning Radius	6.300m

6 TURNING TEMPLATE - Car Exiting
A102 | 1:300

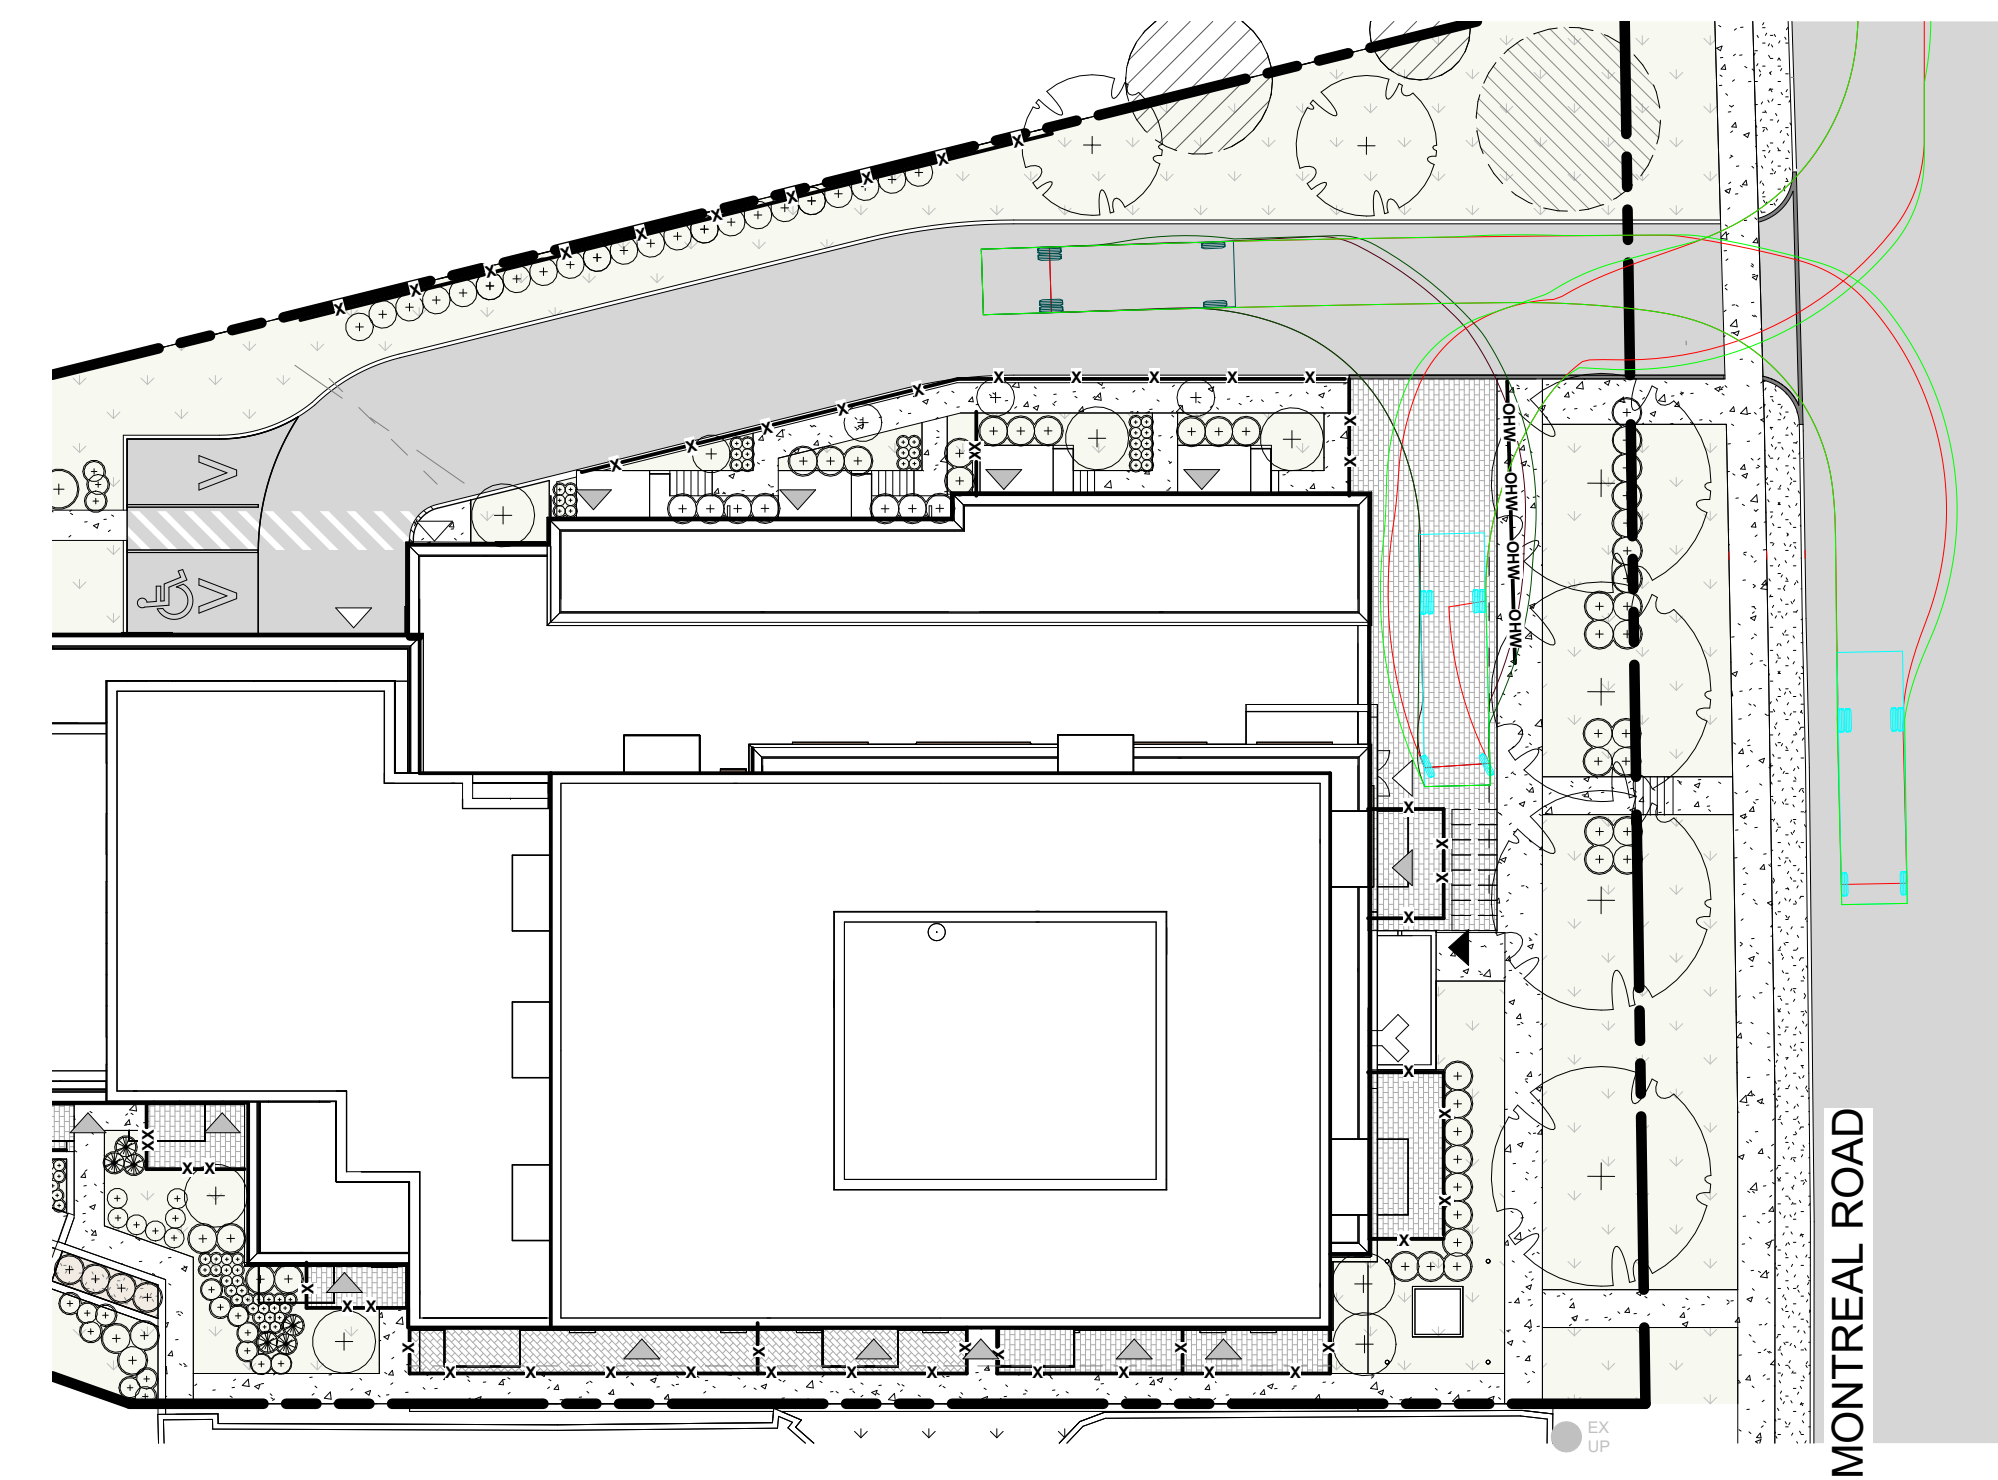


MSU - MEDIUM SINGLE UNIT TRUCK	
Overall Length	10m
Overall Width	2.6m
Overall Body Height	3.65m
Min Body Ground Clearance	0.445m
Track Width	2.6m
Lock-to-lock time	4s
Curb to Curb Turning Radius	11m

3 TURNING TEMPLATE - Garbage
A102 | 1:300

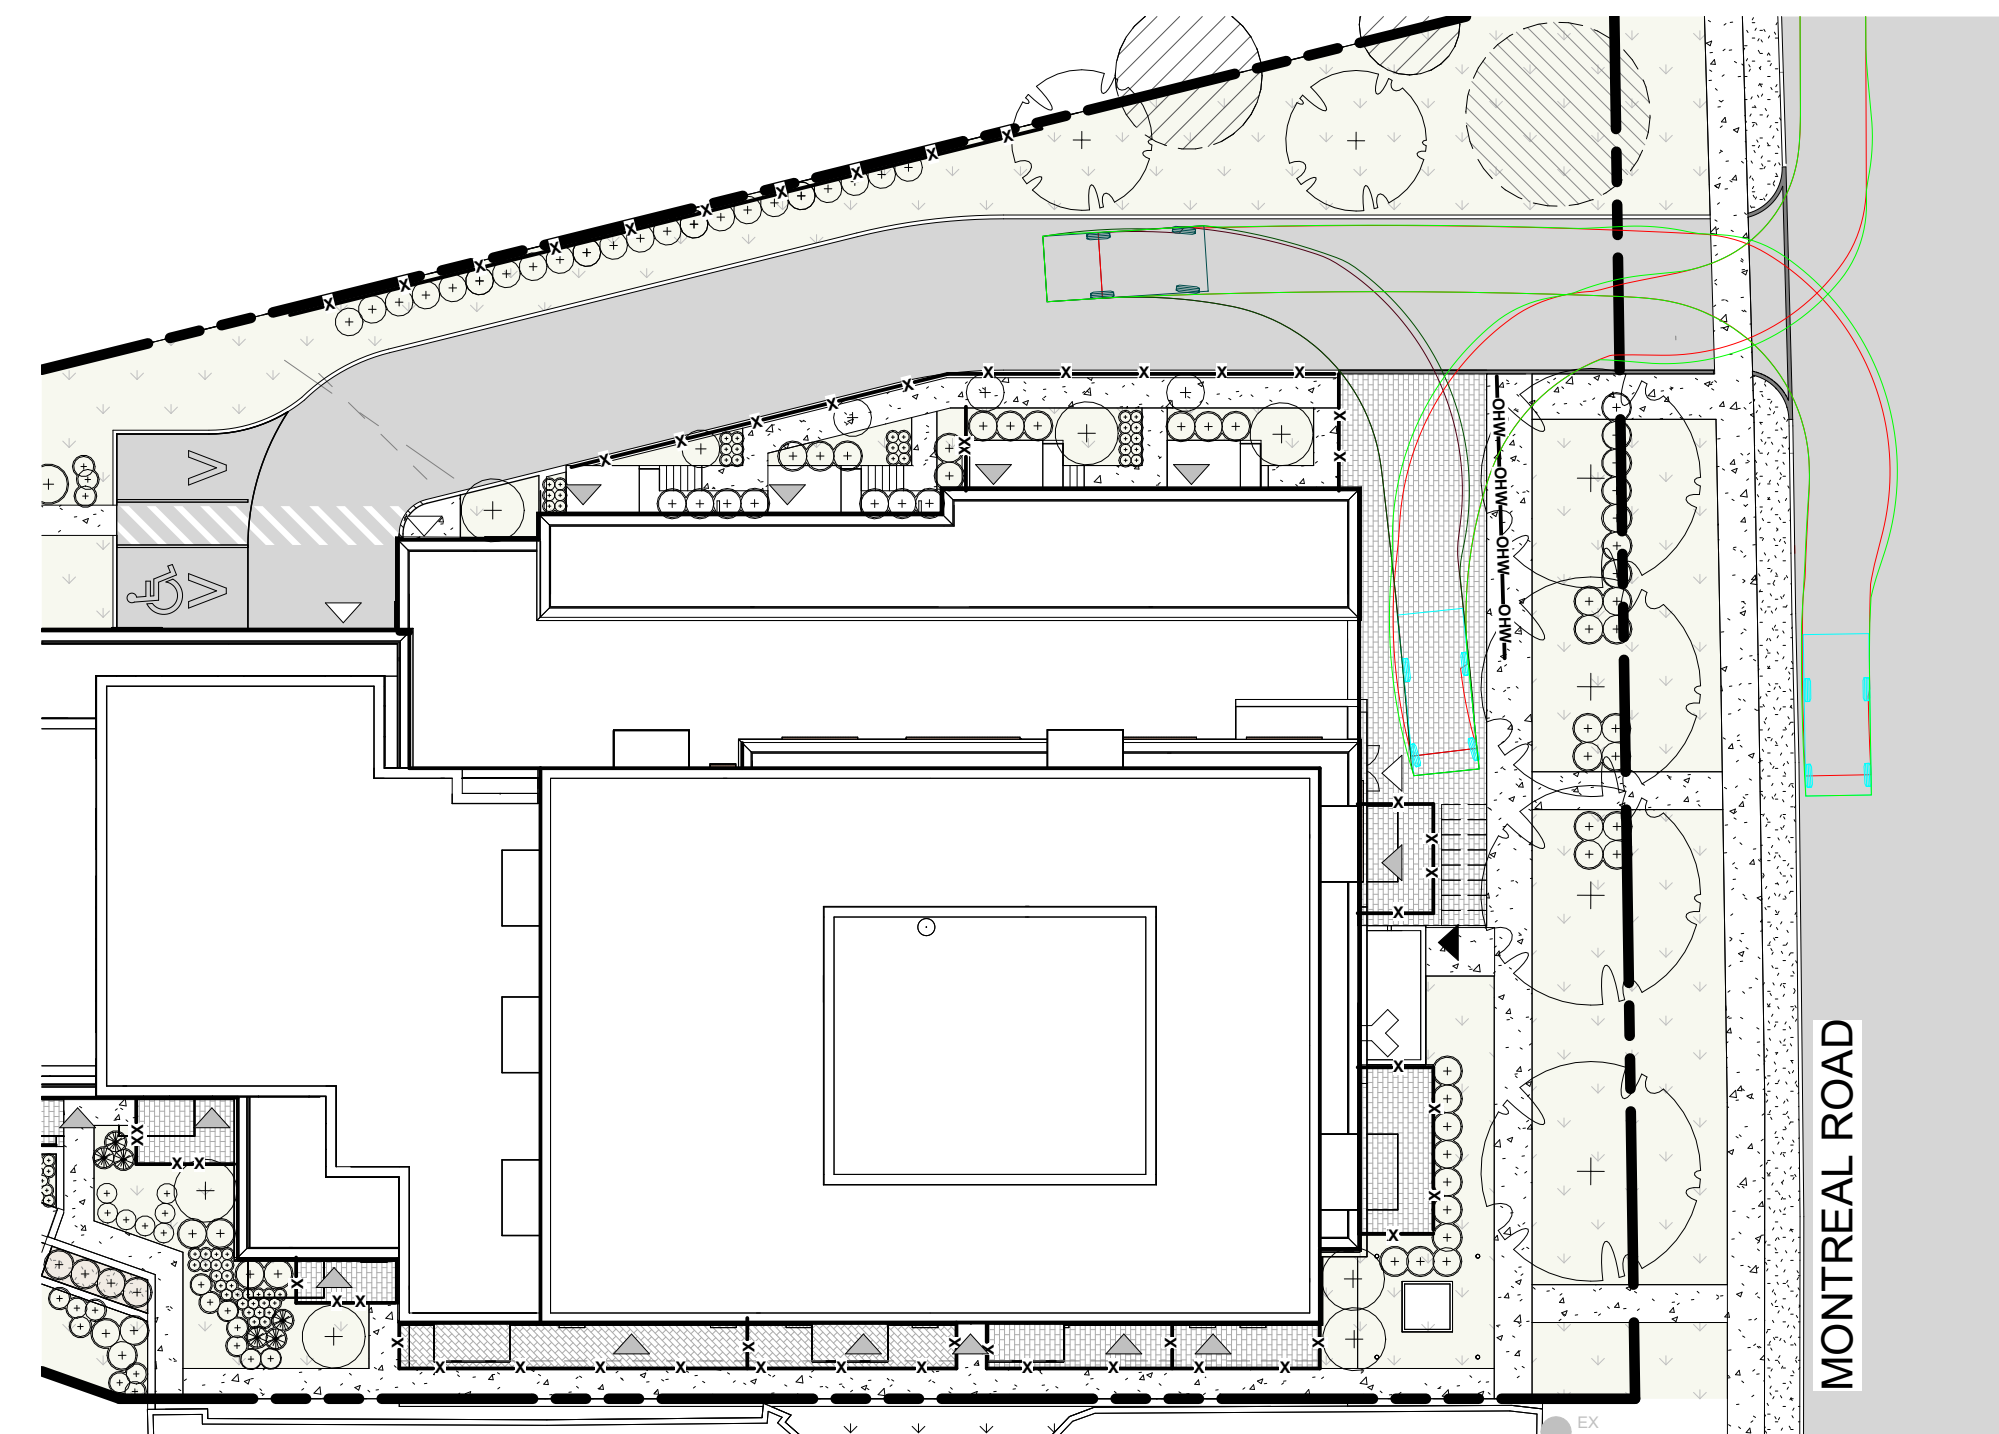

LSU - Light Single Unit Truck	
Overall Length	6.400m
Overall Width	2.600m
Overall Body Height	3.650m
Min Body Ground Clearance	0.445m
Track Width	2.600m
Lock-to-lock time	4.00s
Curb to Curb Turning Radius	6.300m

4 TURNING TEMPLATE - U-Haul
A102 | 1:300

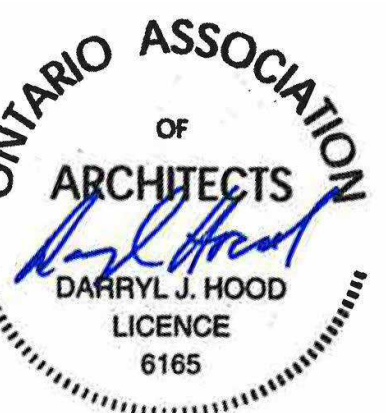

STAMP

8	2024.02.09	ISSUED FOR SITE PLAN CONTROL 3.1
7	2024.01.05	ISSUED FOR SITE PLAN CONTROL 3
6	2023.10.10	ISSUED FOR SITE PLAN CONTROL 2
REV DATE	ISSUE	



NOTES

1. OWNERSHIP OF THE COPYRIGHT OF THE DESIGN AND THE WORKS EXECUTED FROM THE DESIGN REMAINS WITH CSV ARCHITECTS, AND MAY NOT BE REPRODUCED IN ANY FORM WITHOUT THE WRITTEN CONSENT OF CSV ARCHITECTS.
2. THE DRAWINGS, PRESENTATIONS AND SPECIFICATIONS AS INSTRUMENTS OF SERVICE ARE AND SHALL REMAIN THE PROPERTY OF CSV ARCHITECTS. THEY ARE NOT TO BE USED BY THE CLIENT ON OTHER PROJECTS OR ON EXTENSIONS TO THIS PROJECT WITHOUT THE WRITTEN CONSENT OF CSV ARCHITECTS.
3. THIS DRAWING IS TO BE READ IN CONJUNCTION WITH ALL OTHER PROJECT DRAWINGS AND SPECIFICATIONS.
4. DO NOT SCALE DRAWINGS. CONTRACTOR SHALL BE RESPONSIBLE TO VERIFY DIMENSIONS ON SITE.
5. ALL WORK SHALL BE IN ACCORDANCE WITH THE ONTARIO BUILDING CODE AND ALL SUPPLEMENTS AND APPLICABLE MUNICIPAL REGULATIONS.

CLIENT

OTTAWA
ONTARIO, CANADA

PROJECT
1815 MONTREAL ROAD

1815 MONTREAL ROAD

TITLE
**SITE ACCESS/
TURNING TEMPLATES**


PROJECT NO: 222450
DRAWN: Author
APPROVED: Approver
SCALE: 1: 300
DATE PRINTED: 2/9/2024 2:27:21 PM

REV DRAWING NO.

8 A102

Resident	
17	COMPACT
72	NORMAL
Visitor	
2	BF PARKING
16	NORMAL
107	

Bike Parking	66
--------------	----

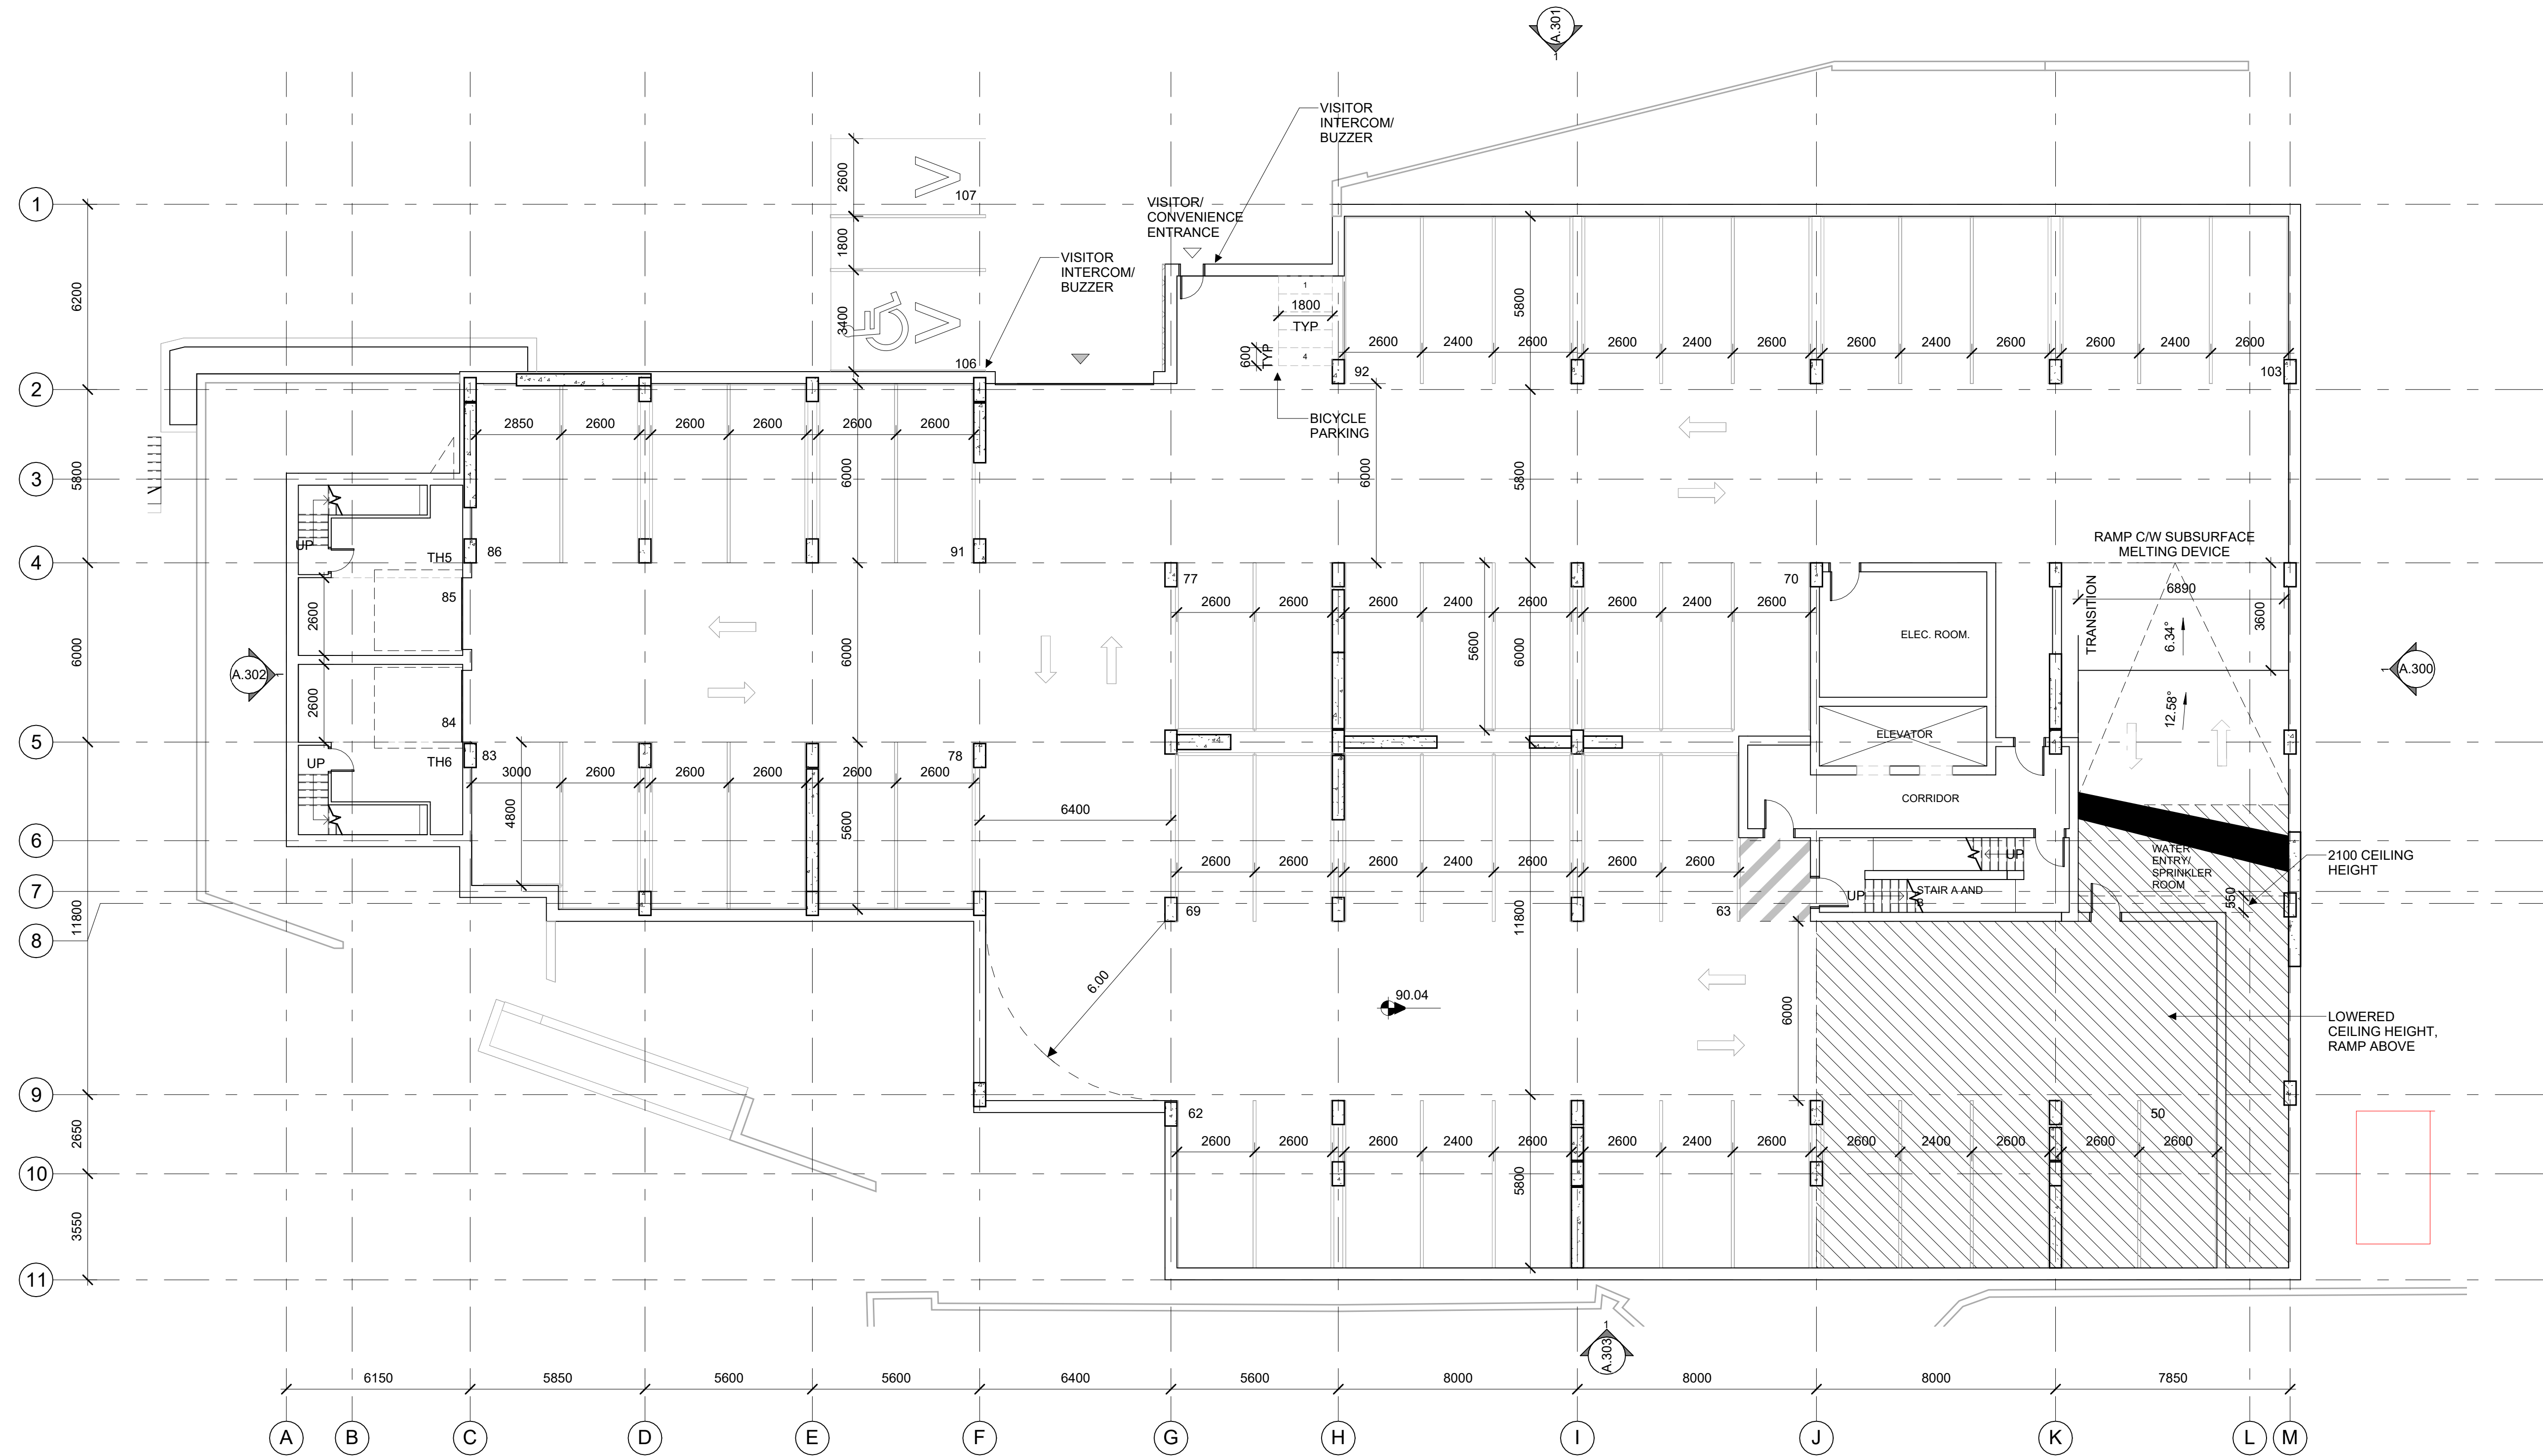

REV	DATE	ISSUE
8	2024 02 09	ISSUED FOR SITE PLAN CONTROL 3.1
7	2024 01 05	ISSUED FOR SITE PLAN CONTROL 3
6	2023 10 10	ISSUED FOR SITE PLAN CONTROL 2
3	2023 05 04	ISSUED FOR COORDINATION
2	2023 04 18	ISSUED FOR COORDINATION
1	2023 04 03	ISSUED FOR REVIEW

- NOTES
1. OWNERSHIP OF THE COPYRIGHT OF THE DESIGN AND THE WORKS EXECUTED FROM THE DESIGN REMAINS WITH CSV ARCHITECTS, AND MAY NOT BE REPRODUCED IN ANY FORM WITHOUT THE WRITTEN CONSENT OF CSV ARCHITECTS.
 2. THE DRAWINGS, PRESENTATIONS AND SPECIFICATIONS AS INSTRUMENTS OF SERVICE ARE AND SHALL REMAIN THE PROPERTY OF CSV ARCHITECTS. THEY ARE NOT TO BE USED BY THE CLIENT ON OTHER PROJECTS OR ON EXTENSIONS TO THIS PROJECT WITHOUT THE WRITTEN CONSENT OF CSV ARCHITECTS.
 3. THIS DRAWING IS TO BE READ IN CONJUNCTION WITH ALL OTHER PROJECT DRAWINGS AND SPECIFICATIONS.
 4. DO NOT SCALE DRAWINGS. CONTRACTOR SHALL BE RESPONSIBLE TO VERIFY DIMENSIONS ON SITE.
 5. ALL WORK SHALL BE IN ACCORDANCE WITH THE ONTARIO BUILDING CODE AND ALL SUPPLEMENTS AND APPLICABLE MUNICIPAL REGULATIONS.

CLIENT

OTTAWA
ONTARIO, CANADA

PROJECT

1815 MONTREAL ROAD

1815 MONTREAL ROAD

TITLE

PARKING LEVEL 2 PLAN

PROJECT NO: 222450
DRAWN: R.R.
APPROVED: D.H.
SCALE: 1:125
DATE PRINTED: 2/9/2024 2:27:22 PM


REV DRAWING NO.

8 A.201


1 PARKING LEVEL 2
A.201 1:125

Resident	
17	COMPACT
72	NORMAL
Visitor	
2	BF PARKING
16	NORMAL
107	

Bike Parking	66
--------------	----

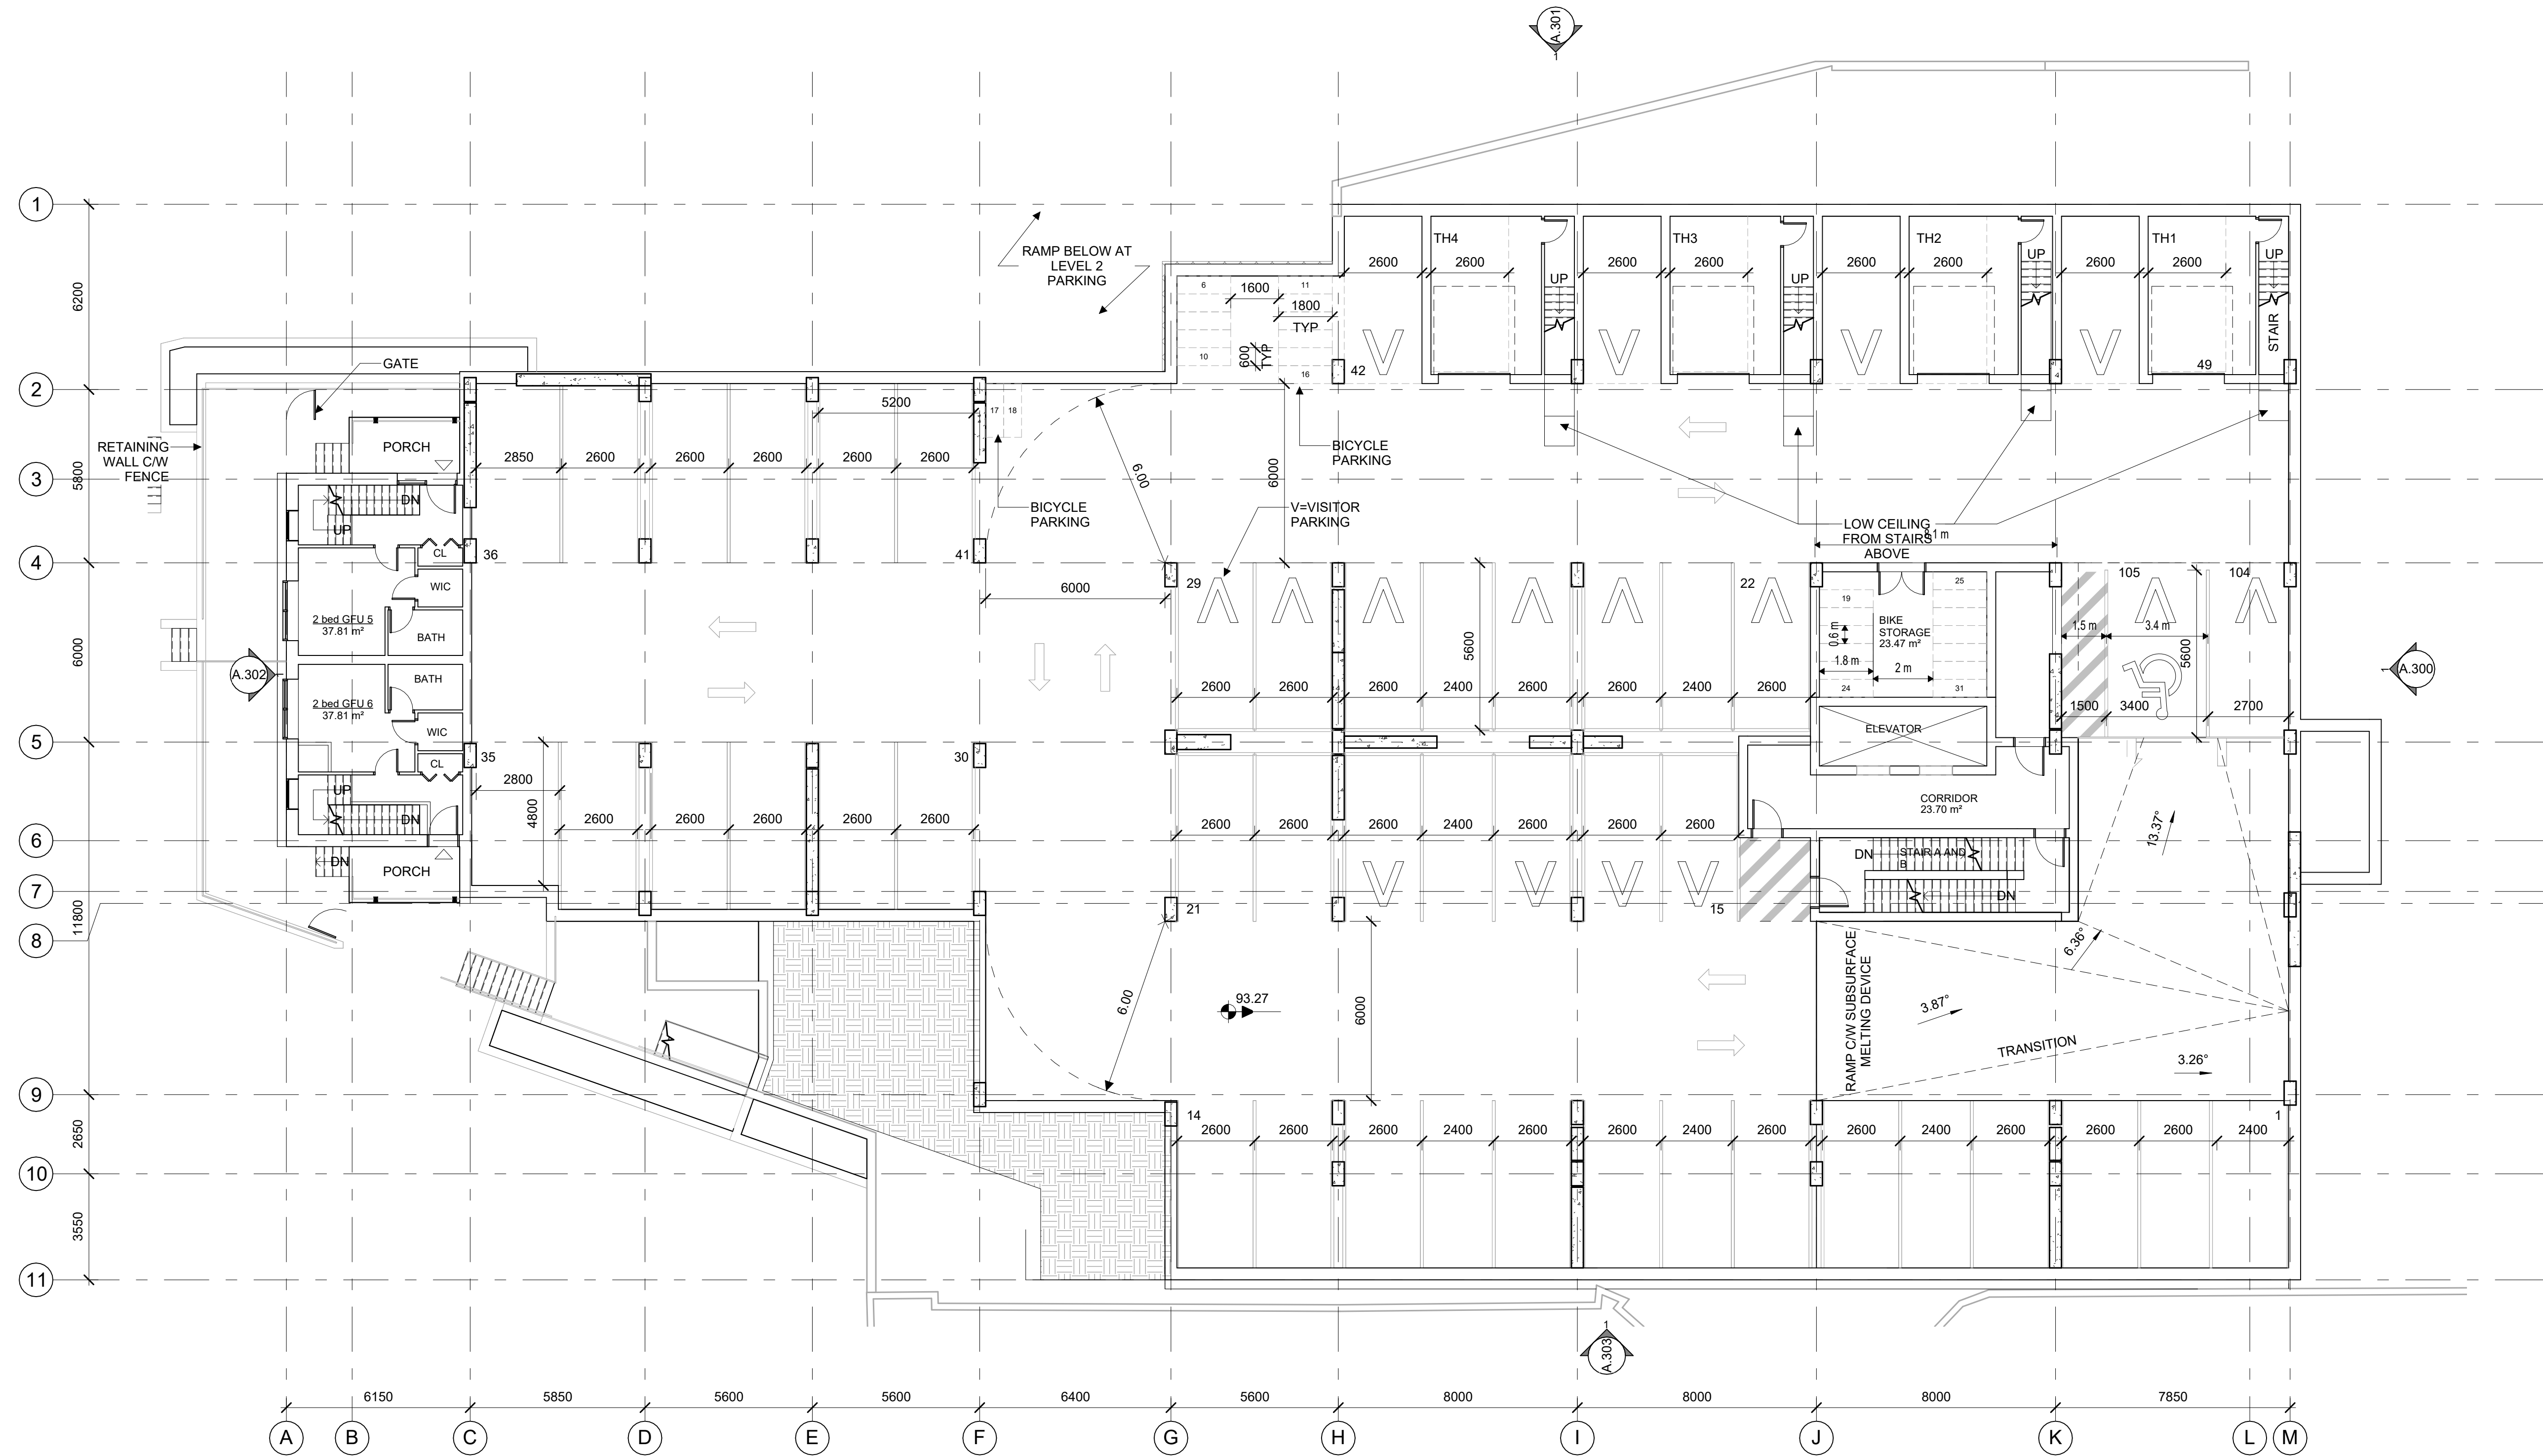

1 PARKING LEVEL 1
A.202 1:125

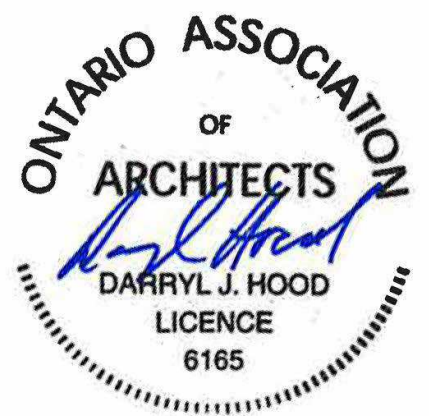

STAMP

8	2024.02.09	ISSUED FOR SITE PLAN CONTROL 3.1
7	2024.01.05	ISSUED FOR SITE PLAN CONTROL 3
6	2023.10.10	ISSUED FOR SITE PLAN CONTROL 2
5	2023.05.04	ISSUED FOR COORDINATION
4	2023.04.18	ISSUED FOR COORDINATION
3	2023.04.03	ISSUED FOR REVIEW
2		
1		

NOTES

1. OWNERSHIP OF THE COPYRIGHT OF THE DESIGN AND THE WORKS EXECUTED FROM THE DESIGN REMAINS WITH CSV ARCHITECTS, AND MAY NOT BE REPRODUCED IN ANY FORM WITHOUT THE WRITTEN CONSENT OF CSV ARCHITECTS.
2. THE DRAWINGS, PRESENTATIONS AND SPECIFICATIONS AS INSTRUMENTS OF SERVICE ARE AND SHALL REMAIN THE PROPERTY OF CSV ARCHITECTS. THEY ARE NOT TO BE USED BY THE CLIENT ON OTHER PROJECTS OR ON EXTENSIONS TO THIS PROJECT WITHOUT THE WRITTEN CONSENT OF CSV ARCHITECTS.
3. THIS DRAWING IS TO BE READ IN CONJUNCTION WITH ALL OTHER PROJECT DRAWINGS AND SPECIFICATIONS.
4. DO NOT SCALE DRAWINGS. CONTRACTOR SHALL BE RESPONSIBLE TO VERIFY DIMENSIONS ON SITE.
5. ALL WORK SHALL BE IN ACCORDANCE WITH THE ONTARIO BUILDING CODE AND ALL SUPPLEMENTS AND APPLICABLE MUNICIPAL REGULATIONS.

CLIENT

OTTAWA
ONTARIO, CANADA

PROJECT
1815 MONTREAL ROAD

1815 MONTREAL ROAD

TITLE
**PARKING LEVEL 1
PLAN**

PROJECT NO: 222450
DRAWN: R.R.
APPROVED: D.H.
SCALE: 1:125
DATE PRINTED: 2/9/2024 2:27:22 PM

REV DRAWING NO.

8 A.202



STAMP

REV DATE	ISSUE
8 2024.02.09	ISSUED FOR SITE PLAN CONTROL 3.1
7 2024.01.05	ISSUED FOR SITE PLAN CONTROL 3
6 2023.10.10	ISSUED FOR SITE PLAN CONTROL 2
5 2023.05.26	ISSUED FOR SITE PLAN CONTROL 4
4 2023.05.25	ISSUED FOR COORDINATION
3 2023.05.04	ISSUED FOR COORDINATION
2 2023.04.18	ISSUED FOR COORDINATION
1 2023.04.03	ISSUED FOR REVIEW

NOTES

1. OWNERSHIP OF THE COPYRIGHT OF THE DESIGN AND THE WORKS EXECUTED FROM THE DESIGN REMAINS WITH CSV ARCHITECTS, AND MAY NOT BE REPRODUCED IN ANY FORM WITHOUT THE WRITTEN CONSENT OF CSV ARCHITECTS.
2. THE DRAWINGS, PRESENTATIONS AND SPECIFICATIONS AS INSTRUMENTS OF SERVICE ARE AND SHALL REMAIN THE PROPERTY OF CSV ARCHITECTS. THEY ARE NOT TO BE USED BY THE CLIENT ON OTHER PROJECTS OR ON EXTENSIONS TO THIS PROJECT WITHOUT THE WRITTEN CONSENT OF CSV ARCHITECTS.
3. THIS DRAWING IS TO BE READ IN CONJUNCTION WITH ALL OTHER PROJECT DRAWINGS AND SPECIFICATIONS.
4. DO NOT SCALE DRAWINGS. CONTRACTOR SHALL BE RESPONSIBLE TO VERIFY DIMENSIONS ON SITE.
5. ALL WORK SHALL BE IN ACCORDANCE WITH THE ONTARIO BUILDING CODE AND ALL SUPPLEMENTS AND APPLICABLE MUNICIPAL REGULATIONS.

CLIENT

OTTAWA
ONTARIO, CANADA

PROJECT

1815 MONTREAL ROAD

1815 MONTREAL ROAD


TITLE

1st FLOOR PLAN

PROJECT NO: 222450
DRAWN: R.R.
APPROVED: D.H.
SCALE: 1 : 125
DATE PRINTED: 2/9/2024 2:27:23 PM

REV DRAWING NO.

8 A.211

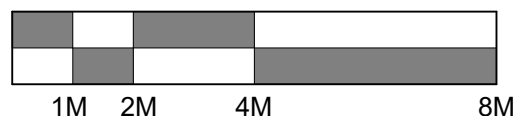



STAMP

REV DATE	ISSUE
8	2024.02.09 ISSUED FOR SITE PLAN CONTROL 3.1
7	2024.01.05 ISSUED FOR SITE PLAN CONTROL 3
6	2023.10.10 ISSUED FOR SITE PLAN CONTROL 2
5	2023.05.26 ISSUED FOR SITE PLAN CONTROL
4	2023.05.25 ISSUED FOR COORDINATION
3	2023.05.04 ISSUED FOR COORDINATION
2	2023.04.18 ISSUED FOR COORDINATION
1	2023.04.03 ISSUED FOR REVIEW

NOTES

1. OWNERSHIP OF THE COPYRIGHT OF THE DESIGN AND THE WORKS EXECUTED FROM THE DESIGN REMAINS WITH CSV ARCHITECTS, AND MAY NOT BE REPRODUCED IN ANY FORM WITHOUT THE WRITTEN CONSENT OF CSV ARCHITECTS.
2. THE DRAWINGS, PRESENTATIONS AND SPECIFICATIONS AS INSTRUMENTS OF SERVICE ARE AND SHALL REMAIN THE PROPERTY OF CSV ARCHITECTS. THEY ARE NOT TO BE USED BY THE CLIENT ON OTHER PROJECTS OR ON EXTENSIONS TO THIS PROJECT WITHOUT THE WRITTEN CONSENT OF CSV ARCHITECTS.
3. THIS DRAWING IS TO BE READ IN CONJUNCTION WITH ALL OTHER PROJECT DRAWINGS AND SPECIFICATIONS.
4. DO NOT SCALE DRAWINGS. CONTRACTOR SHALL BE RESPONSIBLE TO VERIFY DIMENSIONS ON SITE.
5. ALL WORK SHALL BE IN ACCORDANCE WITH THE ONTARIO BUILDING CODE AND ALL SUPPLEMENTS AND APPLICABLE MUNICIPAL REGULATIONS.

CLIENT

OTTAWA
ONTARIO, CANADA

PROJECT
1815 MONTREAL ROAD


1815 MONTREAL ROAD

TITLE
2nd FLOOR PLAN

PROJECT NO: 222450
DRAWN: R.R.
APPROVED: D.H.
SCALE: 1 : 125
DATE PRINTED: 2/9/2024 2:27:23 PM

REV DRAWING NO.

8 A.212

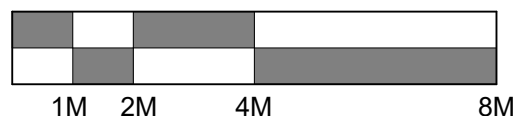



STAMP

REV DATE	ISSUE
8 2024.02.09	ISSUED FOR SITE PLAN CONTROL 3.1
7 2024.01.05	ISSUED FOR SITE PLAN CONTROL 3
6 2023.10.10	ISSUED FOR SITE PLAN CONTROL 2
5 2023.05.26	ISSUED FOR SITE PLAN CONTROL
4 2023.05.25	ISSUED FOR COORDINATION
3 2023.05.04	ISSUED FOR COORDINATION
2 2023.04.18	ISSUED FOR COORDINATION
1 2023.04.03	ISSUED FOR REVIEW

NOTES

1. OWNERSHIP OF THE COPYRIGHT OF THE DESIGN AND THE WORKS EXECUTED FROM THE DESIGN REMAINS WITH CSV ARCHITECTS, AND MAY NOT BE REPRODUCED IN ANY FORM WITHOUT THE WRITTEN CONSENT OF CSV ARCHITECTS.
2. THE DRAWINGS, PRESENTATIONS AND SPECIFICATIONS AS INSTRUMENTS OF SERVICE ARE AND SHALL REMAIN THE PROPERTY OF CSV ARCHITECTS. THEY ARE NOT TO BE USED BY THE CLIENT ON OTHER PROJECTS OR ON EXTENSIONS TO THIS PROJECT WITHOUT THE WRITTEN CONSENT OF CSV ARCHITECTS.
3. THIS DRAWING IS TO BE READ IN CONJUNCTION WITH ALL OTHER PROJECT DRAWINGS AND SPECIFICATIONS.
4. DO NOT SCALE DRAWINGS. CONTRACTOR SHALL BE RESPONSIBLE TO VERIFY DIMENSIONS ON SITE.
5. ALL WORK SHALL BE IN ACCORDANCE WITH THE ONTARIO BUILDING CODE AND ALL SUPPLEMENTS AND APPLICABLE MUNICIPAL REGULATIONS.

CLIENT

OTTAWA
ONTARIO, CANADA

PROJECT
1815 MONTREAL ROAD


1815 MONTREAL ROAD


TITLE
3rd FLOOR PLAN

PROJECT NO: 222450
DRAWN: R.R.
APPROVED: D.H.
SCALE: 1 : 125
DATE PRINTED: 2/9/2024 2:27:24 PM

REV DRAWING NO.

8 A.213

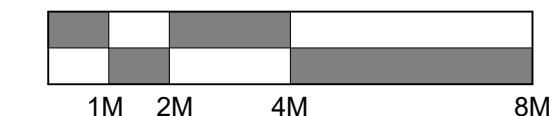

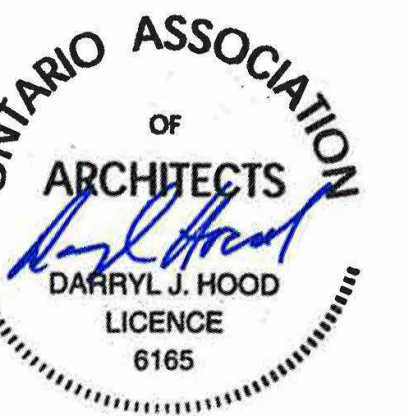

STAMP

REV DATE	ISSUE
8 2024.02.09	ISSUED FOR SITE PLAN CONTROL 3.1
7 2024.01.05	ISSUED FOR SITE PLAN CONTROL 3
6 2023.10.10	ISSUED FOR SITE PLAN CONTROL 2
5 2023.05.26	ISSUED FOR SITE PLAN CONTROL
4 2023.05.25	ISSUED FOR COORDINATION
3 2023.05.04	ISSUED FOR COORDINATION
2 2023.04.18	ISSUED FOR COORDINATION
1 2023.04.03	ISSUED FOR REVIEW

NOTES

1. OWNERSHIP OF THE COPYRIGHT OF THE DESIGN AND THE WORKS EXECUTED FROM THE DESIGN REMAINS WITH CSV ARCHITECTS, AND MAY NOT BE REPRODUCED IN ANY FORM WITHOUT THE WRITTEN CONSENT OF CSV ARCHITECTS.
2. THE DRAWINGS, PRESENTATIONS AND SPECIFICATIONS AS INSTRUMENTS OF SERVICE ARE AND SHALL REMAIN THE PROPERTY OF CSV ARCHITECTS. THEY ARE NOT TO BE USED BY THE CLIENT ON OTHER PROJECTS OR ON EXTENSIONS TO THIS PROJECT WITHOUT THE WRITTEN CONSENT OF CSV ARCHITECTS.
3. THIS DRAWING IS TO BE READ IN CONJUNCTION WITH ALL OTHER PROJECT DRAWINGS AND SPECIFICATIONS.
4. DO NOT SCALE DRAWINGS. CONTRACTOR SHALL BE RESPONSIBLE TO VERIFY DIMENSIONS ON SITE.
5. ALL WORK SHALL BE IN ACCORDANCE WITH THE ONTARIO BUILDING CODE AND ALL SUPPLEMENTS AND APPLICABLE MUNICIPAL REGULATIONS.

CLIENT

OTTAWA
ONTARIO, CANADA

PROJECT
1815 MONTREAL ROAD


1815 MONTREAL ROAD

TITLE
4th FLOOR PLAN

PROJECT NO: 222450
DRAWN: R.R.
APPROVED: D.H.
SCALE: 1 : 125
DATE PRINTED: 2/9/2024 2:27:25 PM

REV DRAWING NO.

8 A.214

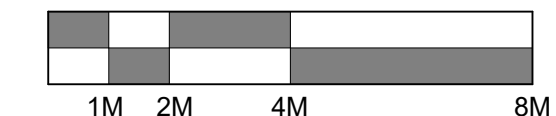



STAMP

REV DATE	ISSUE
8	2024.02.09 ISSUED FOR SITE PLAN CONTROL 3.1
7	2024.01.05 ISSUED FOR SITE PLAN CONTROL 3
6	2023.10.10 ISSUED FOR SITE PLAN CONTROL 2
5	2023.05.26 ISSUED FOR SITE PLAN CONTROL
4	2023.05.25 ISSUED FOR COORDINATION
3	2023.05.04 ISSUED FOR COORDINATION
2	2023.04.18 ISSUED FOR COORDINATION
1	2023.04.03 ISSUED FOR REVIEW

NOTES

1. OWNERSHIP OF THE COPYRIGHT OF THE DESIGN AND THE WORKS EXECUTED FROM THE DESIGN REMAINS WITH CSV ARCHITECTS, AND MAY NOT BE REPRODUCED IN ANY FORM WITHOUT THE WRITTEN CONSENT OF CSV ARCHITECTS.
2. THE DRAWINGS, PRESENTATIONS AND SPECIFICATIONS AS INSTRUMENTS OF SERVICE ARE AND SHALL REMAIN THE PROPERTY OF CSV ARCHITECTS. THEY ARE NOT TO BE USED BY THE CLIENT ON OTHER PROJECTS OR ON EXTENSIONS TO THIS PROJECT WITHOUT THE WRITTEN CONSENT OF CSV ARCHITECTS.
3. THIS DRAWING IS TO BE READ IN CONJUNCTION WITH ALL OTHER PROJECT DRAWINGS AND SPECIFICATIONS.
4. DO NOT SCALE DRAWINGS. CONTRACTOR SHALL BE RESPONSIBLE TO VERIFY DIMENSIONS ON SITE.
5. ALL WORK SHALL BE IN ACCORDANCE WITH THE ONTARIO BUILDING CODE AND ALL SUPPLEMENTS AND APPLICABLE MUNICIPAL REGULATIONS.

CLIENT


OTTAWA
ONTARIO, CANADA

PROJECT
1815 MONTREAL ROAD

1815 MONTREAL ROAD

TITLE
5th FLOOR PLAN

PROJECT NO: 222450
DRAWN: R.R.
APPROVED: D.H.
SCALE: 1 : 125
DATE PRINTED: 2/9/2024 2:27:26 PM

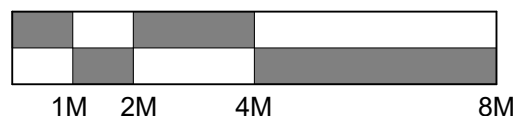

REV DRAWING NO.

8 A.215



STAMP

REV DATE	ISSUE
8	2024.02.09 ISSUED FOR SITE PLAN CONTROL 3.1
7	2024.01.05 ISSUED FOR SITE PLAN CONTROL 3
6	2023.10.10 ISSUED FOR SITE PLAN CONTROL 2
5	2023.05.26 ISSUED FOR SITE PLAN CONTROL
4	2023.05.25 ISSUED FOR COORDINATION
3	2023.05.04 ISSUED FOR COORDINATION
2	2023.04.18 ISSUED FOR COORDINATION
1	2023.04.03 ISSUED FOR REVIEW

NOTES

1. OWNERSHIP OF THE COPYRIGHT OF THE DESIGN AND THE WORKS EXECUTED FROM THE DESIGN REMAINS WITH CSV ARCHITECTS, AND MAY NOT BE REPRODUCED IN ANY FORM WITHOUT THE WRITTEN CONSENT OF CSV ARCHITECTS.
2. THE DRAWINGS, PRESENTATIONS AND SPECIFICATIONS AS INSTRUMENTS OF SERVICE ARE AND SHALL REMAIN THE PROPERTY OF CSV ARCHITECTS. THEY ARE NOT TO BE USED BY THE CLIENT ON OTHER PROJECTS OR ON EXTENSIONS TO THIS PROJECT WITHOUT THE WRITTEN CONSENT OF CSV ARCHITECTS.
3. THIS DRAWING IS TO BE READ IN CONJUNCTION WITH ALL OTHER PROJECT DRAWINGS AND SPECIFICATIONS.
4. DO NOT SCALE DRAWINGS. CONTRACTOR SHALL BE RESPONSIBLE TO VERIFY DIMENSIONS ON SITE.
5. ALL WORK SHALL BE IN ACCORDANCE WITH THE ONTARIO BUILDING CODE AND ALL SUPPLEMENTS AND APPLICABLE MUNICIPAL REGULATIONS.

CLIENT

OTTAWA
ONTARIO, CANADA

PROJECT
1815 MONTREAL ROAD


1815 MONTREAL ROAD

TITLE
6th FLOOR PLAN

PROJECT NO: 222450
DRAWN: R.R.
APPROVED: D.H.
SCALE: 1 : 125
DATE PRINTED: 2/9/2024 2:27:27 PM

REV DRAWING NO.

8 A.216

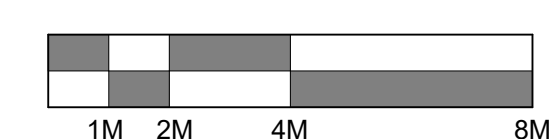



STAMP

REV	DATE	ISSUE
8	2024.02.09	ISSUED FOR SITE PLAN CONTROL 3.1
7	2024.01.05	ISSUED FOR SITE PLAN CONTROL 3
6	2023.10.10	ISSUED FOR SITE PLAN CONTROL 2
5	2023.05.26	ISSUED FOR SITE PLAN CONTROL
4	2023.05.25	ISSUED FOR COORDINATION
3	2023.05.04	ISSUED FOR COORDINATION
2	2023.04.18	ISSUED FOR COORDINATION
1	2023.04.03	ISSUED FOR REVIEW

NOTES

1. OWNERSHIP OF THE COPYRIGHT OF THE DESIGN AND THE WORKS EXECUTED FROM THE DESIGN REMAINS WITH CSV ARCHITECTS, AND MAY NOT BE REPRODUCED IN ANY FORM WITHOUT THE WRITTEN CONSENT OF CSV ARCHITECTS.
2. THE DRAWINGS, PRESENTATIONS AND SPECIFICATIONS AS INSTRUMENTS OF SERVICE ARE AND SHALL REMAIN THE PROPERTY OF CSV ARCHITECTS. THEY ARE NOT TO BE USED BY THE CLIENT ON OTHER PROJECTS OR ON EXTENSIONS TO THIS PROJECT WITHOUT THE WRITTEN CONSENT OF CSV ARCHITECTS.
3. THIS DRAWING IS TO BE READ IN CONJUNCTION WITH ALL OTHER PROJECT DRAWINGS AND SPECIFICATIONS.
4. DO NOT SCALE DRAWINGS. CONTRACTOR SHALL BE RESPONSIBLE TO VERIFY DIMENSIONS ON SITE.
5. ALL WORK SHALL BE IN ACCORDANCE WITH THE ONTARIO BUILDING CODE AND ALL SUPPLEMENTS AND APPLICABLE MUNICIPAL REGULATIONS.

CLIENT

OTTAWA
ONTARIO, CANADA


PROJECT
1815 MONTREAL ROAD


1815 MONTREAL ROAD

TITLE
7th FLOOR PLAN

PROJECT NO: 222450
DRAWN: R.R.
APPROVED: D.H.
SCALE: 1 : 125
DATE PRINTED: 2/9/2024 2:27:27 PM

REV DRAWING NO.
8 A.217

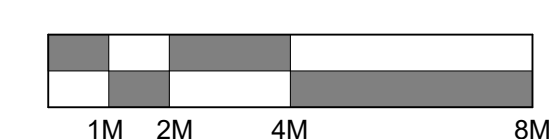

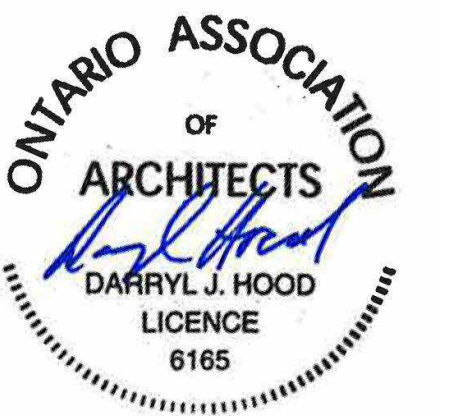

STAMP

REV DATE	ISSUE
8	2024.02.09 ISSUED FOR SITE PLAN CONTROL 3.1
7	2024.01.05 ISSUED FOR SITE PLAN CONTROL 3
6	2023.10.10 ISSUED FOR SITE PLAN CONTROL 2
5	2023.05.26 ISSUED FOR SITE PLAN CONTROL
4	2023.05.25 ISSUED FOR COORDINATION
3	2023.05.04 ISSUED FOR COORDINATION
2	2023.04.18 ISSUED FOR COORDINATION
1	2023.04.03 ISSUED FOR REVIEW

NOTES

1. OWNERSHIP OF THE COPYRIGHT OF THE DESIGN AND THE WORKS EXECUTED FROM THE DESIGN REMAINS WITH CSV ARCHITECTS, AND MAY NOT BE REPRODUCED IN ANY FORM WITHOUT THE WRITTEN CONSENT OF CSV ARCHITECTS.
2. THE DRAWINGS, PRESENTATIONS AND SPECIFICATIONS AS INSTRUMENTS OF SERVICE ARE AND SHALL REMAIN THE PROPERTY OF CSV ARCHITECTS. THEY ARE NOT TO BE USED BY THE CLIENT ON OTHER PROJECTS OR ON EXTENSIONS TO THIS PROJECT WITHOUT THE WRITTEN CONSENT OF CSV ARCHITECTS.
3. THIS DRAWING IS TO BE READ IN CONJUNCTION WITH ALL OTHER PROJECT DRAWINGS AND SPECIFICATIONS.
4. DO NOT SCALE DRAWINGS. CONTRACTOR SHALL BE RESPONSIBLE TO VERIFY DIMENSIONS ON SITE.
5. ALL WORK SHALL BE IN ACCORDANCE WITH THE ONTARIO BUILDING CODE AND ALL SUPPLEMENTS AND APPLICABLE MUNICIPAL REGULATIONS.

CLIENT

OTTAWA
ONTARIO, CANADA

PROJECT
1815 MONTREAL ROAD


1815 MONTREAL ROAD


TITLE
8th FLOOR PLAN

PROJECT NO: 222450
DRAWN: R.R.
APPROVED: D.H.
SCALE: 1 : 125
DATE PRINTED: 2/9/2024 2:27:28 PM

REV DRAWING NO.

8 A.218

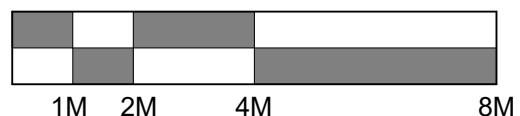

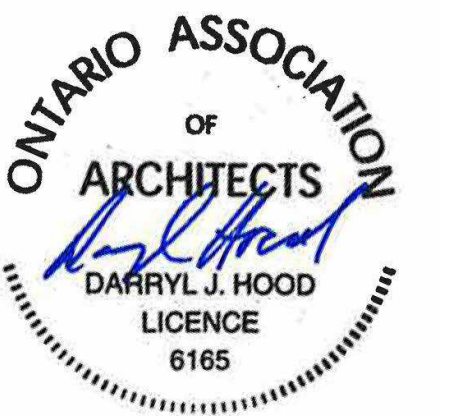

STAMP

REV DATE	ISSUE
8	2024.02.09 ISSUED FOR SITE PLAN CONTROL 3.1
7	2024.01.05 ISSUED FOR SITE PLAN CONTROL 3
6	2023.10.10 ISSUED FOR SITE PLAN CONTROL 2
5	2023.05.26 ISSUED FOR SITE PLAN CONTROL
4	2023.05.25 ISSUED FOR COORDINATION
3	2023.05.04 ISSUED FOR COORDINATION
2	2023.04.18 ISSUED FOR COORDINATION
1	2023.04.03 ISSUED FOR REVIEW

NOTES

1. OWNERSHIP OF THE COPYRIGHT OF THE DESIGN AND THE WORKS EXECUTED FROM THE DESIGN REMAINS WITH CSV ARCHITECTS, AND MAY NOT BE REPRODUCED IN ANY FORM WITHOUT THE WRITTEN CONSENT OF CSV ARCHITECTS.
2. THE DRAWINGS, PRESENTATIONS AND SPECIFICATIONS AS INSTRUMENTS OF SERVICE ARE AND SHALL REMAIN THE PROPERTY OF CSV ARCHITECTS. THEY ARE NOT TO BE USED BY THE CLIENT ON OTHER PROJECTS OR ON EXTENSIONS TO THIS PROJECT WITHOUT THE WRITTEN CONSENT OF CSV ARCHITECTS.
3. THIS DRAWING IS TO BE READ IN CONJUNCTION WITH ALL OTHER PROJECT DRAWINGS AND SPECIFICATIONS.
4. DO NOT SCALE DRAWINGS. CONTRACTOR SHALL BE RESPONSIBLE TO VERIFY DIMENSIONS ON SITE.
5. ALL WORK SHALL BE IN ACCORDANCE WITH THE ONTARIO BUILDING CODE AND ALL SUPPLEMENTS AND APPLICABLE MUNICIPAL REGULATIONS.

CLIENT

OTTAWA
ONTARIO, CANADA

PROJECT
1815 MONTREAL ROAD


1815 MONTREAL ROAD


TITLE
9th FLOOR PLAN

PROJECT NO: 222450
DRAWN: R.R.
APPROVED: D.H.
SCALE: 1 : 125
DATE PRINTED: 2/9/2024 2:27:28 PM

REV DRAWING NO.

8 A.219

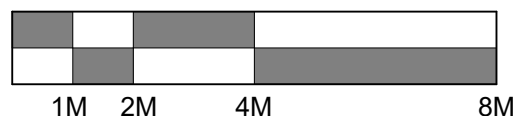

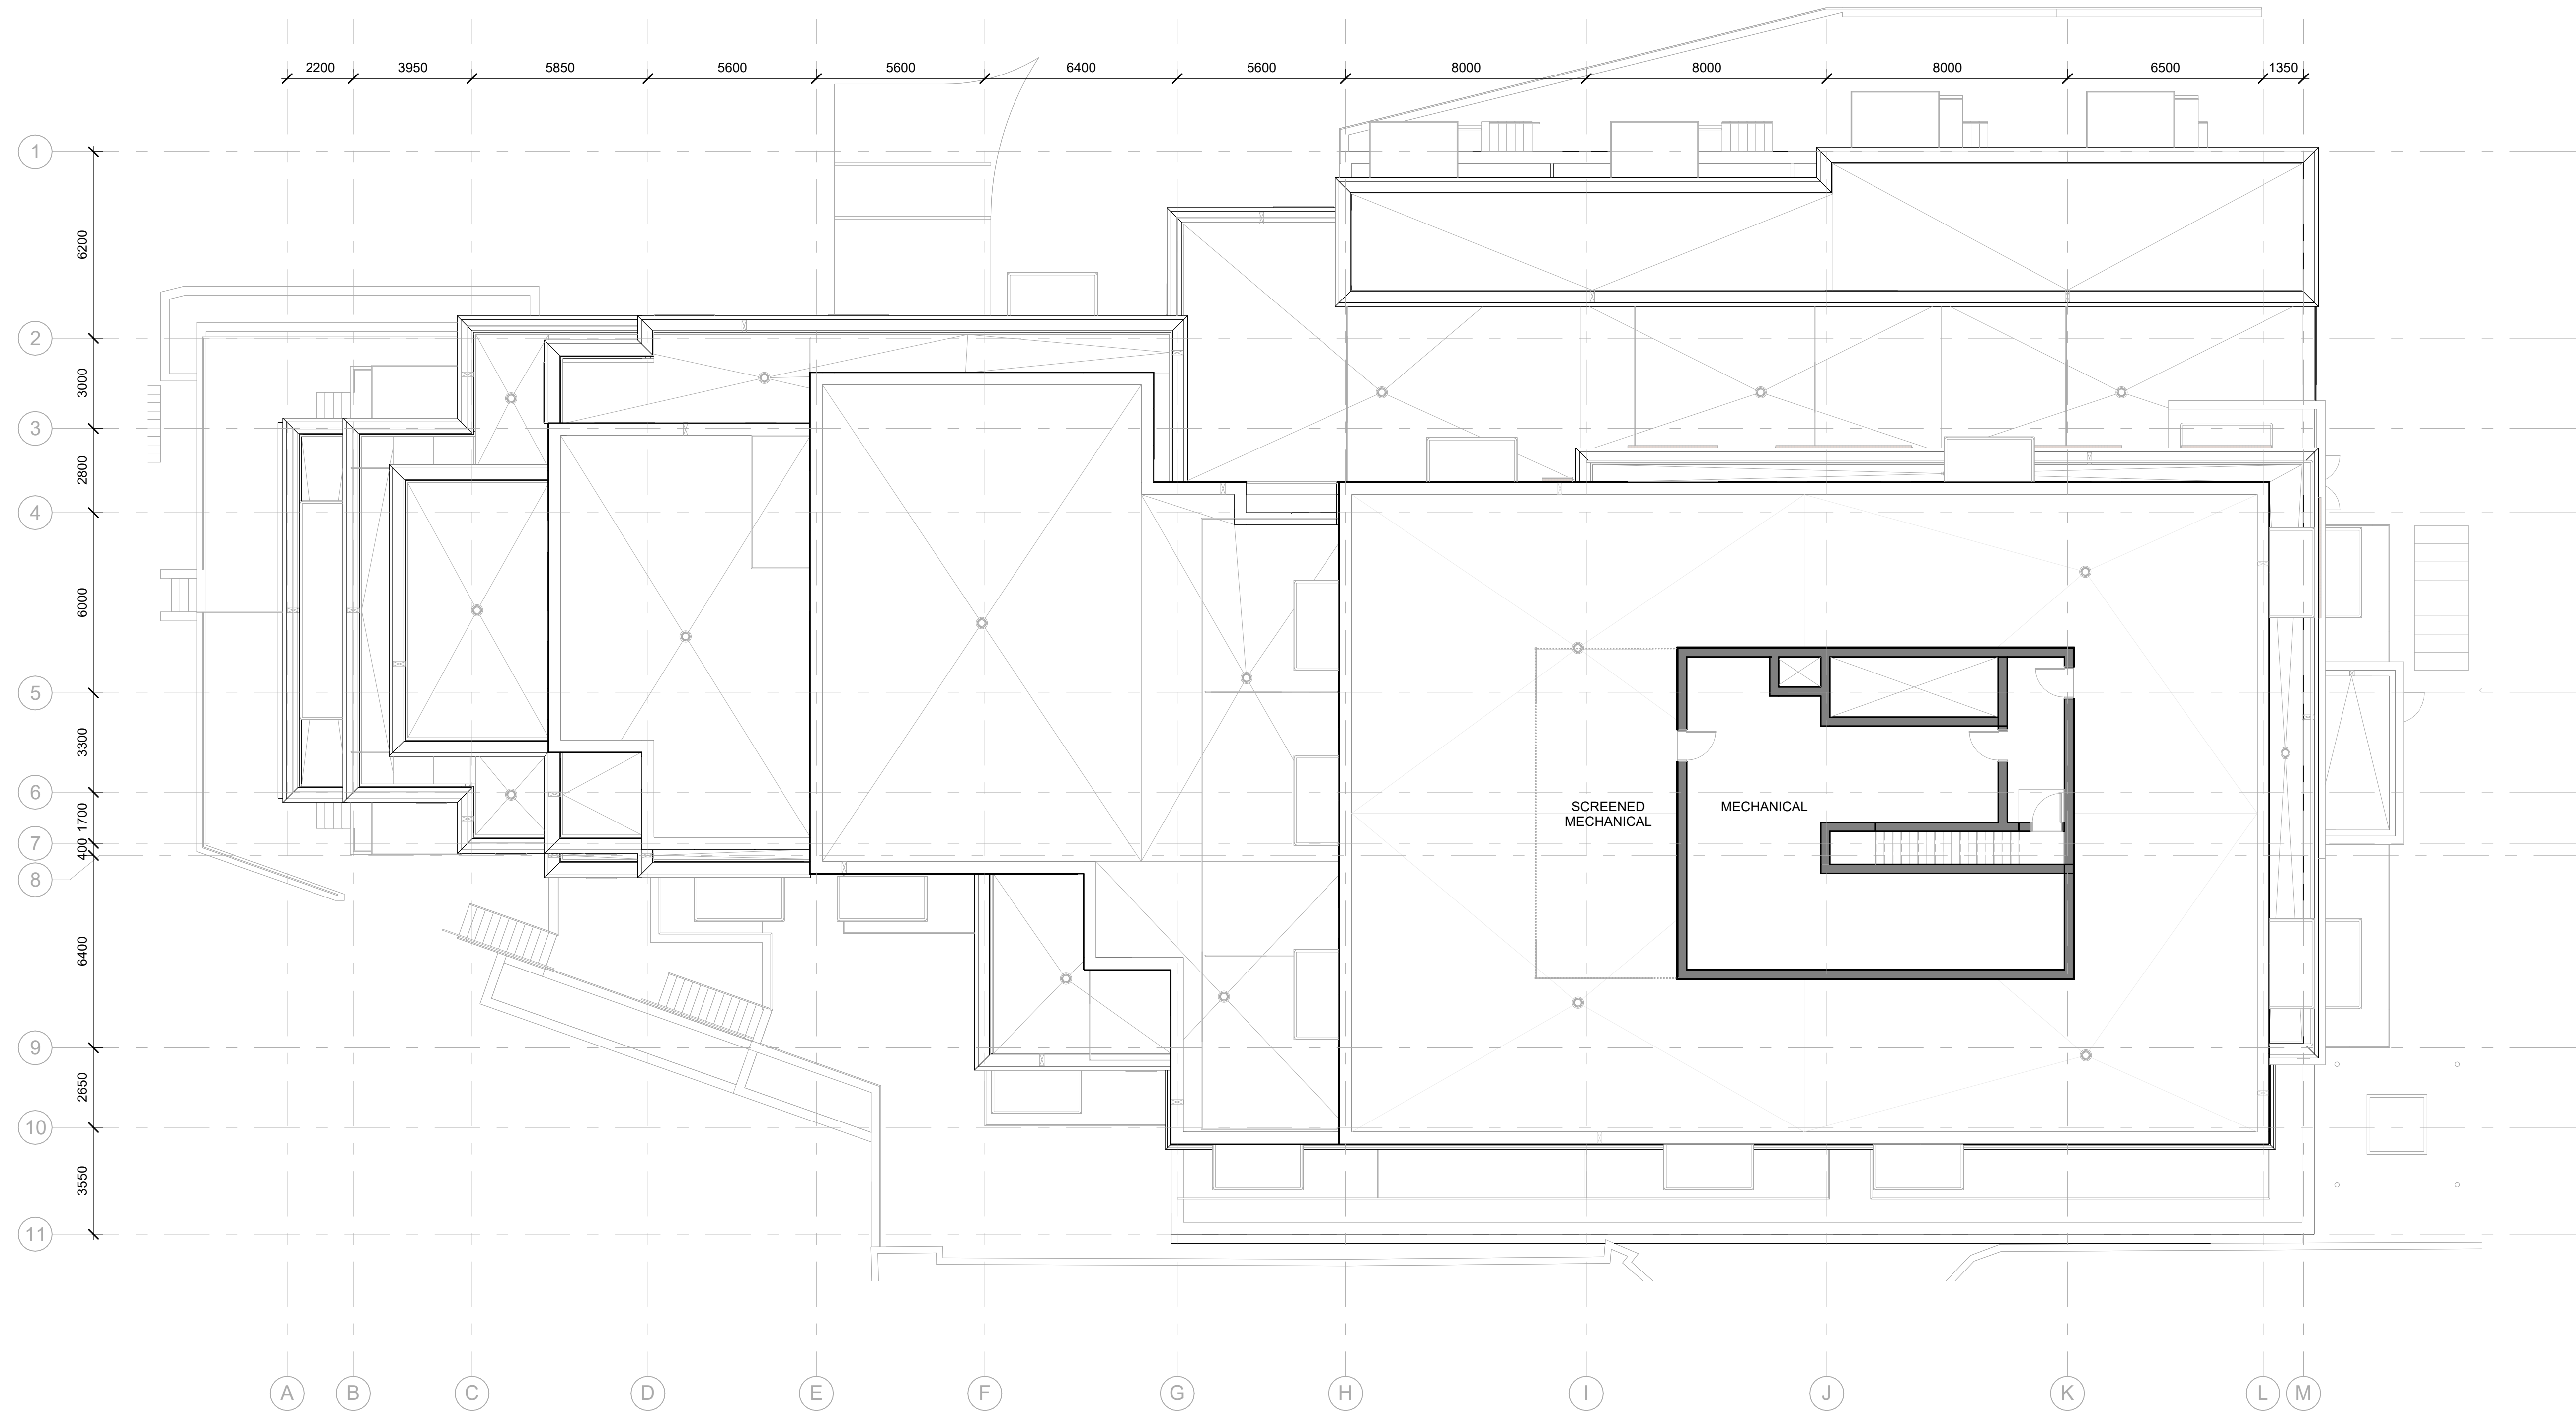

STAMP

REV DATE	ISSUE
8 2024.02.09	ISSUED FOR SITE PLAN CONTROL 3.1
7 2024.01.05	ISSUED FOR SITE PLAN CONTROL 3
6 2023.10.10	ISSUED FOR SITE PLAN CONTROL 2
5 2023.05.26	ISSUED FOR SITE PLAN CONTROL
4 2023.05.25	ISSUED FOR COORDINATION
3 2023.05.04	ISSUED FOR COORDINATION
2 2023.04.18	ISSUED FOR COORDINATION
1 2023.04.03	ISSUED FOR REVIEW

NOTES

1. OWNERSHIP OF THE COPYRIGHT OF THE DESIGN AND THE WORKS EXECUTED FROM THE DESIGN REMAINS WITH CSV ARCHITECTS, AND MAY NOT BE REPRODUCED IN ANY FORM WITHOUT THE WRITTEN CONSENT OF CSV ARCHITECTS.
2. THE DRAWINGS, PRESENTATIONS AND SPECIFICATIONS AS INSTRUMENTS OF SERVICE ARE AND SHALL REMAIN THE PROPERTY OF CSV ARCHITECTS. THEY ARE NOT TO BE USED BY THE CLIENT ON OTHER PROJECTS OR ON EXTENSIONS TO THIS PROJECT WITHOUT THE WRITTEN CONSENT OF CSV ARCHITECTS.
3. THIS DRAWING IS TO BE READ IN CONJUNCTION WITH ALL OTHER PROJECT DRAWINGS AND SPECIFICATIONS.
4. DO NOT SCALE DRAWINGS. CONTRACTOR SHALL BE RESPONSIBLE TO VERIFY DIMENSIONS ON SITE.
5. ALL WORK SHALL BE IN ACCORDANCE WITH THE ONTARIO BUILDING CODE AND ALL SUPPLEMENTS AND APPLICABLE MUNICIPAL REGULATIONS.

CLIENT

OTTAWA
ONTARIO, CANADA


PROJECT
1815 MONTREAL ROAD

1815 MONTREAL ROAD
TITLE
PENTHOUS PLAN

PROJECT NO: 222450
DRAWN: R.R.
APPROVED: D.H.
SCALE: 1 : 125
DATE PRINTED: 2/9/2024 2:27:30 PM

REV DRAWING NO.

8 A.219a

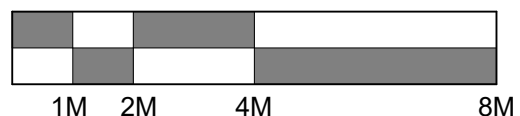

ELEVATION NOTES:

CONTRACTOR TO COORDINATE WITH MANUFACTURER'S SPECIFICATIONS AND INSTALLATIONS GUIDELINES FOR ALL MATERIAL SEALING, TRANSITIONS, SEPARATIONS, FLASHING DETAILS, CONNECTIONS, ANCHORAGES, ETC. CONTRACTOR TO PROVIDE DETAIL DRAWINGS OR MOCK-UP FOR ARCHITECT'S REVIEW AND APPROVAL FOR ALL SPECIAL CONDITIONS NOT SHOWN IN THE CONTRACT DOCUMENTS.

BIRD-SAFE GLASS TO BE USED AT A MIN. 90% OF ALL GLASS WITHIN THE FIRST 16M ABOVE AVERAGE GRADE (OR TO THE HEIGHT OF THE ADJACENT MATURE TREES)

ELEVATION KEYNOTES:

- # SAMPLE TEXT
- # SAMPLE TEXT
- # SAMPLE TEXT
- # SAMPLE TEXT MULTI LINE
- # SAMPLE TEXT

ELEVATION LEGEND:

HATCH PATTERNS SHOWN ARE FOR GRAPHIC PURPOSES ONLY AND SHOULD BE COORDINATED WITH ACTUAL SPECIFIED MATERIALS.

HATCH	SYMBOL	DESCRIPTION
		BRICK VENEER MANUFACTURER: COLOUR:
		STONE VENEER - BLOCK MANUFACTURER: COLOUR:
		FIBERCEMENT CLADDING MANUFACTURER: COLOUR:



STAMP

REV	DATE	ISSUE
8	2024.02.09	ISSUED FOR SITE PLAN CONTROL 3.1
7	2024.01.05	ISSUED FOR SITE PLAN CONTROL 3
6	2023.10.10	ISSUED FOR SITE PLAN CONTROL 2
5	2023.05.26	ISSUED FOR SITE PLAN CONTROL
4	2023.05.25	ISSUED FOR COORDINATION
3	2023.05.04	ISSUED FOR COORDINATION
2	2023.04.18	ISSUED FOR COORDINATION
1	2023.04.03	ISSUED FOR REVIEW

NOTES

- OWNERSHIP OF THE COPYRIGHT OF THE DESIGN AND THE WORKS EXECUTED FROM THE DESIGN REMAINS WITH CSV ARCHITECTS, AND MAY NOT BE REPRODUCED IN ANY FORM WITHOUT THE WRITTEN CONSENT OF CSV ARCHITECTS.
- THE DRAWINGS, PRESENTATIONS AND SPECIFICATIONS AS INSTRUMENTS OF SERVICE ARE AND SHALL REMAIN THE PROPERTY OF CSV ARCHITECTS. THEY ARE NOT TO BE USED BY THE CLIENT ON OTHER PROJECTS OR ON EXTENSIONS TO THIS PROJECT WITHOUT THE WRITTEN CONSENT OF CSV ARCHITECTS.
- THIS DRAWING IS TO BE READ IN CONJUNCTION WITH ALL OTHER PROJECT DRAWINGS AND SPECIFICATIONS.
- DO NOT SCALE DRAWINGS. CONTRACTOR SHALL BE RESPONSIBLE TO VERIFY DIMENSIONS ON SITE.
- ALL WORK SHALL BE IN ACCORDANCE WITH THE ONTARIO BUILDING CODE AND ALL SUPPLEMENTS AND APPLICABLE MUNICIPAL REGULATIONS.

CLIENT

OTTAWA
ONTARIO, CANADA

PROJECT
1815 MONTREAL ROAD


1815 MONTREAL ROAD

TITLE
SOUTH ELEVATION

PROJECT NO: 222450
DRAWN: R.R.
APPROVED: D.H.
SCALE: As Indicated
DATE PRINTED: 2/9/2024 2:27:41 PM

REV DRAWING NO.

8 **A.300**

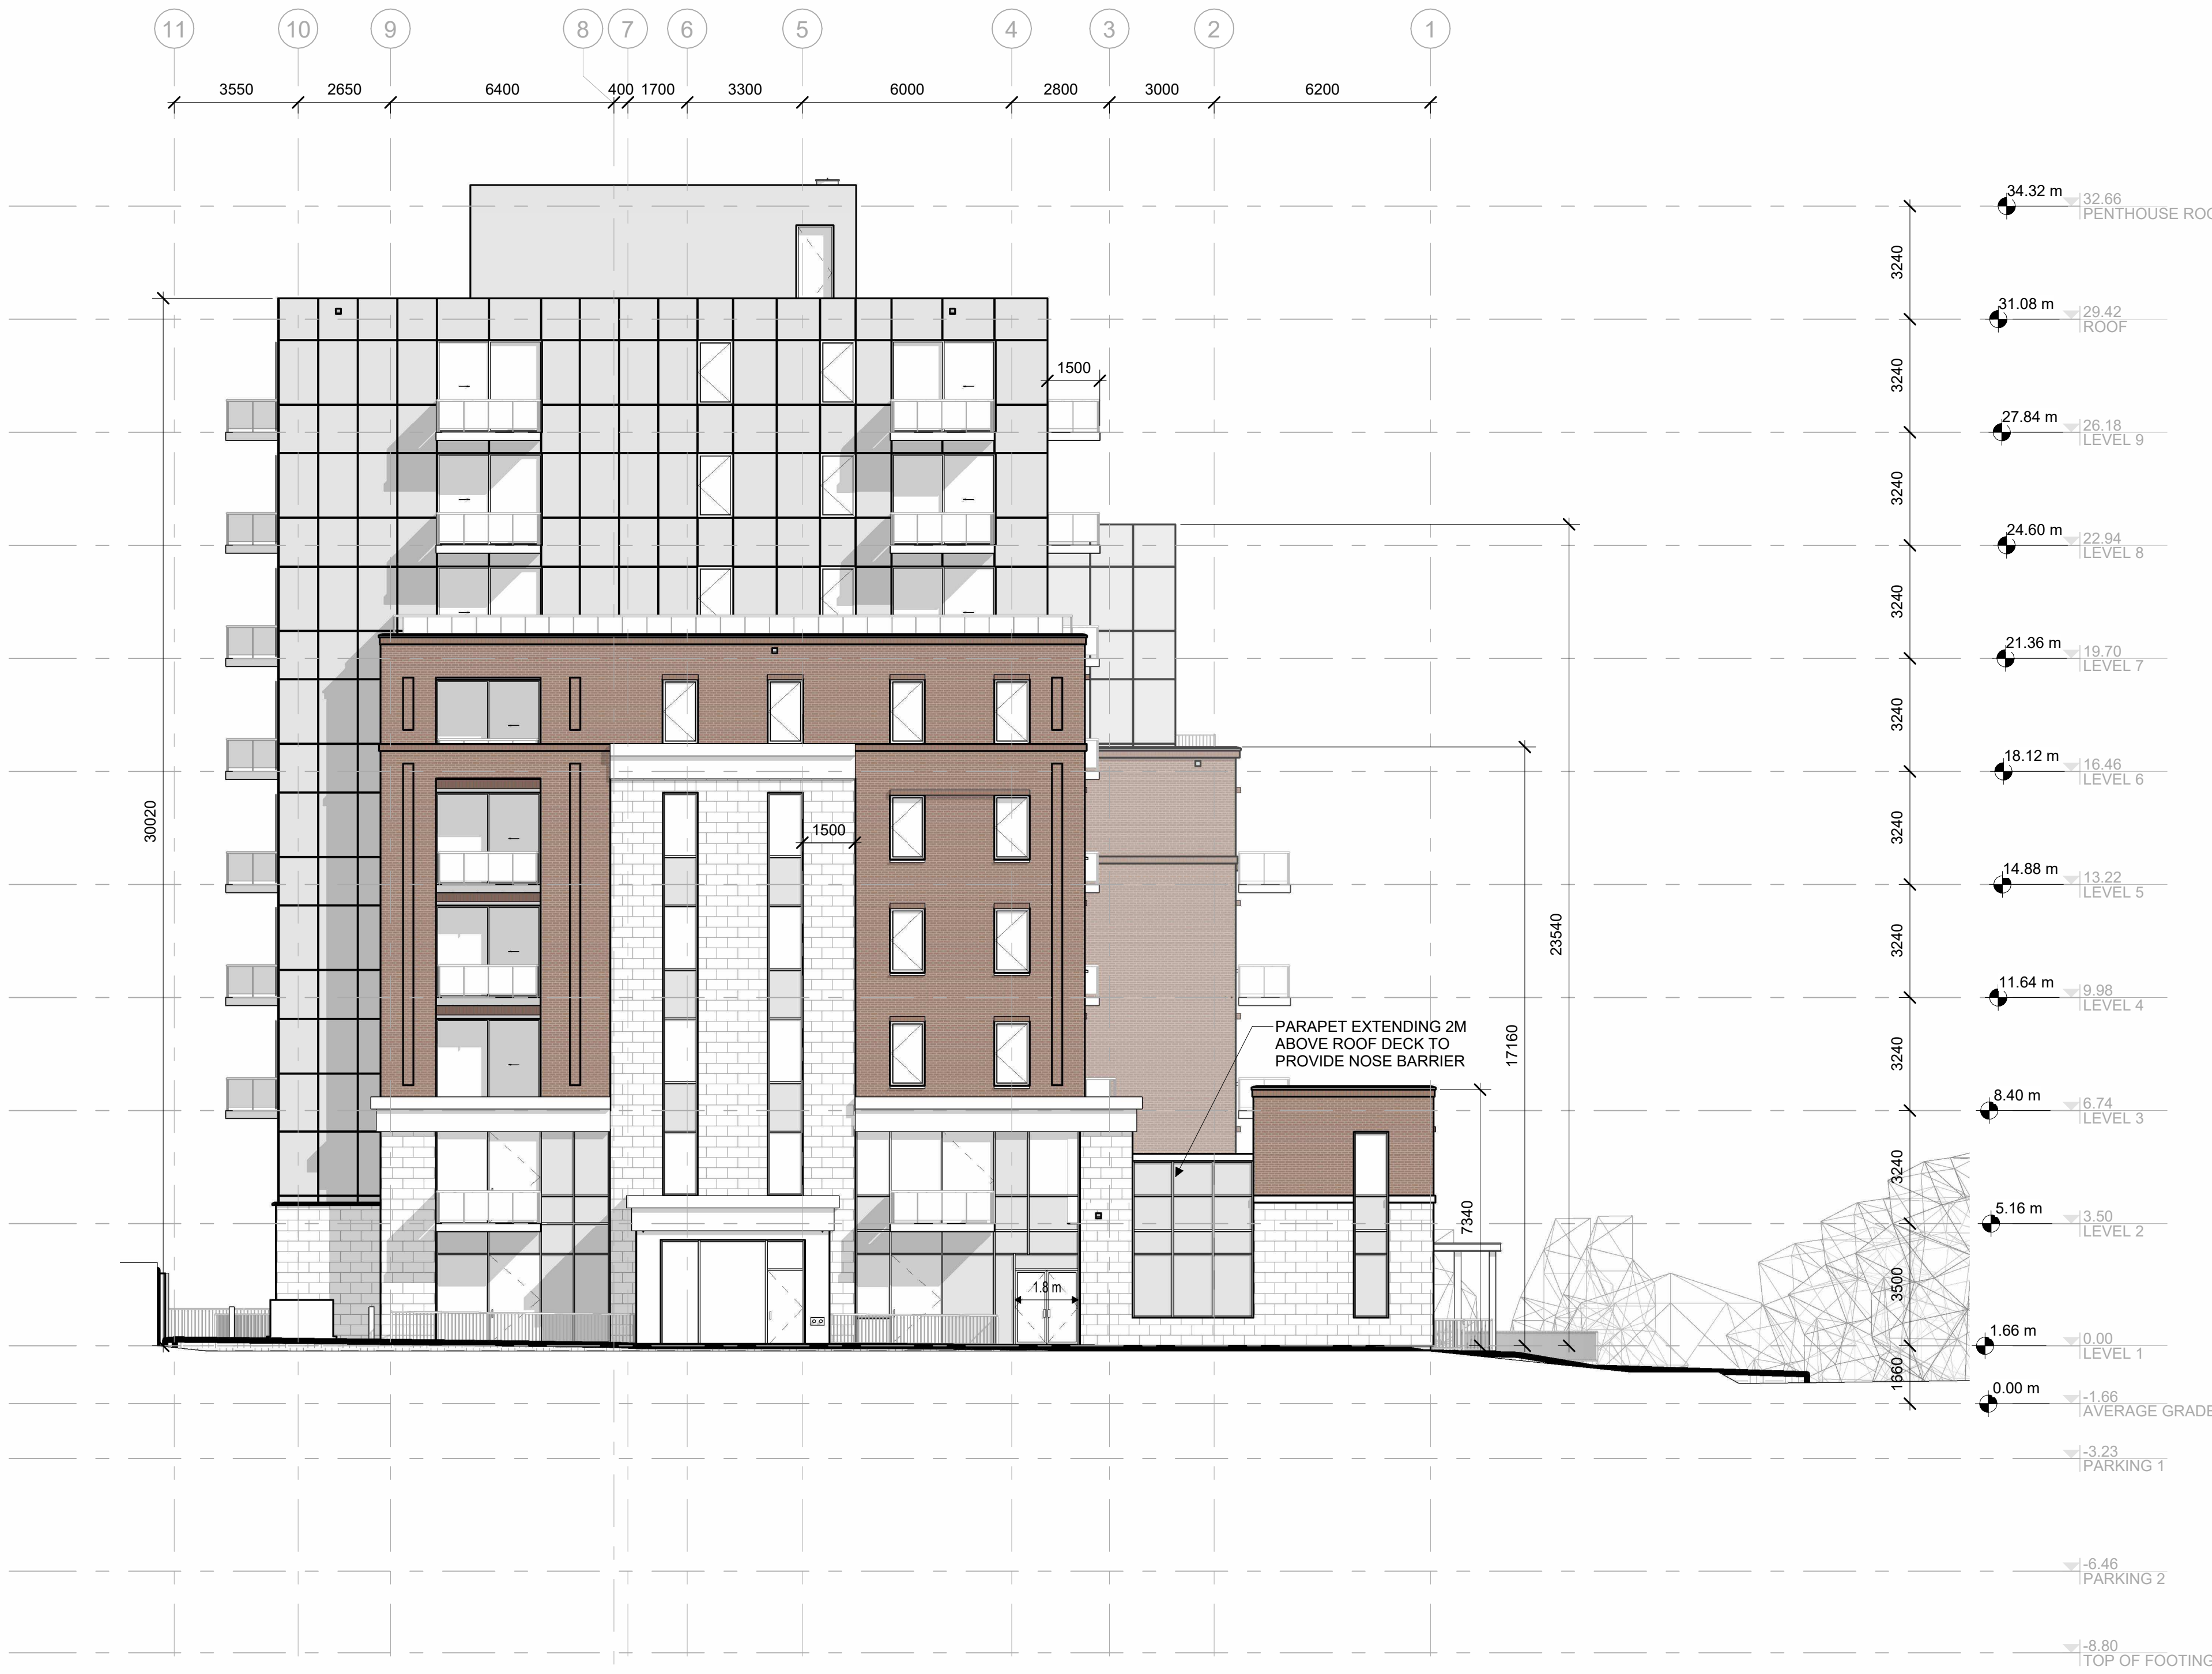

1 SOUTH ELEVATION
A.300 1:125

ELEVATION NOTES:

CONTRACTOR TO COORDINATE WITH MANUFACTURER'S SPECIFICATIONS AND INSTALLATIONS GUIDELINES FOR ALL MATERIAL SEALING, TRANSITIONS, SEPARATIONS, FLASHING DETAILS, CONNECTIONS, ANCHORAGES, ETC. CONTRACTOR TO PROVIDE DETAIL DRAWINGS OR MOCK-UP FOR ARCHITECT'S REVIEW AND APPROVAL FOR ALL SPECIAL CONDITIONS NOT SHOWN IN THE CONTRACT DOCUMENTS.

BIRD-SAFE GLASS TO BE USED AT A MIN. 90% OF ALL GLASS WITHIN THE FIRST 16M ABOVE AVERAGE GRADE (OR TO THE HEIGHT OF THE ADJACENT MATURE TREES)


ELEVATION KEYNOTES:

- # SAMPLE TEXT
- # SAMPLE TEXT
- # SAMPLE TEXT
- # SAMPLE TEXT MULTI LINE
- # SAMPLE TEXT

ELEVATION LEGEND:

HATCH PATTERNS SHOWN ARE FOR GRAPHIC PURPOSES ONLY AND SHOULD BE COORDINATED WITH ACTUAL SPECIFIED MATERIALS.

HATCH	SYMBOL	DESCRIPTION
		BRICK VENEER MANUFACTURER: COLOUR:
		STONE VENEER - BLOCK MANUFACTURER: COLOUR:
		FIBERCEMENT CLADDING MANUFACTURER: COLOUR:

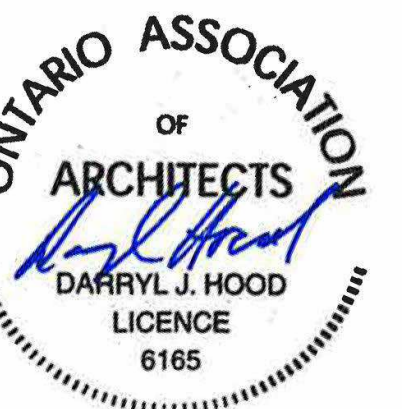

STAMP

REV	DATE	ISSUE
8	2024.02.09	ISSUED FOR SITE PLAN CONTROL 3.1
7	2024.01.05	ISSUED FOR SITE PLAN CONTROL 3
6	2023.10.10	ISSUED FOR SITE PLAN CONTROL 2
5	2023.05.26	ISSUED FOR SITE PLAN CONTROL
4	2023.05.25	ISSUED FOR COORDINATION
3	2023.05.04	ISSUED FOR COORDINATION
2	2023.04.18	ISSUED FOR COORDINATION
1	2023.04.03	ISSUED FOR REVIEW

NOTES

- OWNERSHIP OF THE COPYRIGHT OF THE DESIGN AND THE WORKS EXECUTED FROM THE DESIGN REMAINS WITH CSV ARCHITECTS, AND MAY NOT BE REPRODUCED IN ANY FORM WITHOUT THE WRITTEN CONSENT OF CSV ARCHITECTS.
- THE DRAWINGS, PRESENTATIONS AND SPECIFICATIONS AS INSTRUMENTS OF SERVICE ARE AND SHALL REMAIN THE PROPERTY OF CSV ARCHITECTS. THEY ARE NOT TO BE USED BY THE CLIENT ON OTHER PROJECTS OR ON EXTENSIONS TO THIS PROJECT WITHOUT THE WRITTEN CONSENT OF CSV ARCHITECTS.
- THIS DRAWING IS TO BE READ IN CONJUNCTION WITH ALL OTHER PROJECT DRAWINGS AND SPECIFICATIONS.
- DO NOT SCALE DRAWINGS. CONTRACTOR SHALL BE RESPONSIBLE TO VERIFY DIMENSIONS ON SITE.
- ALL WORK SHALL BE IN ACCORDANCE WITH THE ONTARIO BUILDING CODE AND ALL SUPPLEMENTS AND APPLICABLE MUNICIPAL REGULATIONS.

CLIENT

OTTAWA
ONTARIO, CANADA

PROJECT

1815 MONTREAL ROAD

1815 MONTREAL ROAD

TITLE

EAST ELEVATION

PROJECT NO: 222450
DRAWN: R.R.
APPROVED: D.H.
SCALE: As Indicated
DATE PRINTED: 2/9/2024 2:27:53 PM

REV DRAWING NO.

8 A.301



1 EAST ELEVATION
A.301 | 1:125

ELEVATION NOTES:

CONTRACTOR TO COORDINATE WITH MANUFACTURER'S SPECIFICATIONS AND INSTALLATIONS GUIDELINES FOR ALL MATERIAL SEALING, TRANSITIONS, SEPARATIONS, FLASHING DETAILS, CONNECTIONS, ANCHORAGES, ETC. CONTRACTOR TO PROVIDE DETAIL DRAWINGS OR MOCK-UP FOR ARCHITECT'S REVIEW AND APPROVAL FOR ALL SPECIAL CONDITIONS NOT SHOWN IN THE CONTRACT DOCUMENTS.

BIRD-SAFE GLASS TO BE USED AT A MIN. 90% OF ALL GLASS WITHIN THE FIRST 16M ABOVE AVERAGE GRADE (OR TO THE HEIGHT OF THE ADJACENT MATURE TREES)

ELEVATION KEYNOTES:

- # SAMPLE TEXT
- # SAMPLE TEXT
- # SAMPLE TEXT
- # SAMPLE TEXT MULTI LINE
- # SAMPLE TEXT

ELEVATION LEGEND:

HATCH PATTERNS SHOWN ARE FOR GRAPHIC PURPOSES ONLY AND SHOULD BE COORDINATED WITH ACTUAL SPECIFIED MATERIALS.

HATCH	SYMBOL	DESCRIPTION
		BRICK VENEER MANUFACTURER: COLOUR:
		STONE VENEER - BLOCK MANUFACTURER: COLOUR:
		FIBERCEMENT CLADDING MANUFACTURER: COLOUR:



STAMP

REV	DATE	ISSUE
8	2024.02.09	ISSUED FOR SITE PLAN CONTROL 3.1
7	2024.01.05	ISSUED FOR SITE PLAN CONTROL 3
6	2023.10.10	ISSUED FOR SITE PLAN CONTROL 2
5	2023.05.26	ISSUED FOR SITE PLAN CONTROL
4	2023.05.25	ISSUED FOR COORDINATION
3	2023.05.04	ISSUED FOR COORDINATION
2	2023.04.18	ISSUED FOR COORDINATION
1	2023.04.03	ISSUED FOR REVIEW

NOTES

- OWNERSHIP OF THE COPYRIGHT OF THE DESIGN AND THE WORKS EXECUTED FROM THE DESIGN REMAINS WITH CSV ARCHITECTS, AND MAY NOT BE REPRODUCED IN ANY FORM WITHOUT THE WRITTEN CONSENT OF CSV ARCHITECTS.
- THE DRAWINGS, PRESENTATIONS AND SPECIFICATIONS AS INSTRUMENTS OF SERVICE ARE AND SHALL REMAIN THE PROPERTY OF CSV ARCHITECTS. THEY ARE NOT TO BE USED BY THE CLIENT ON OTHER PROJECTS OR ON EXTENSIONS TO THIS PROJECT WITHOUT THE WRITTEN CONSENT OF CSV ARCHITECTS.
- THIS DRAWING IS TO BE READ IN CONJUNCTION WITH ALL OTHER PROJECT DRAWINGS AND SPECIFICATIONS.
- DO NOT SCALE DRAWINGS. CONTRACTOR SHALL BE RESPONSIBLE TO VERIFY DIMENSIONS ON SITE.
- ALL WORK SHALL BE IN ACCORDANCE WITH THE ONTARIO BUILDING CODE AND ALL SUPPLEMENTS AND APPLICABLE MUNICIPAL REGULATIONS.

CLIENT

OTTAWA
ONTARIO, CANADA

PROJECT

1815 MONTREAL ROAD

1815 MONTREAL ROAD


TITLE

NORTH ELEVATION

PROJECT NO: 222450
DRAWN: R.R.
APPROVED: D.H.
SCALE: As Indicated
DATE PRINTED: 2/9/2024 2:28:06 PM

REV DRAWING NO.

8 **A.302**

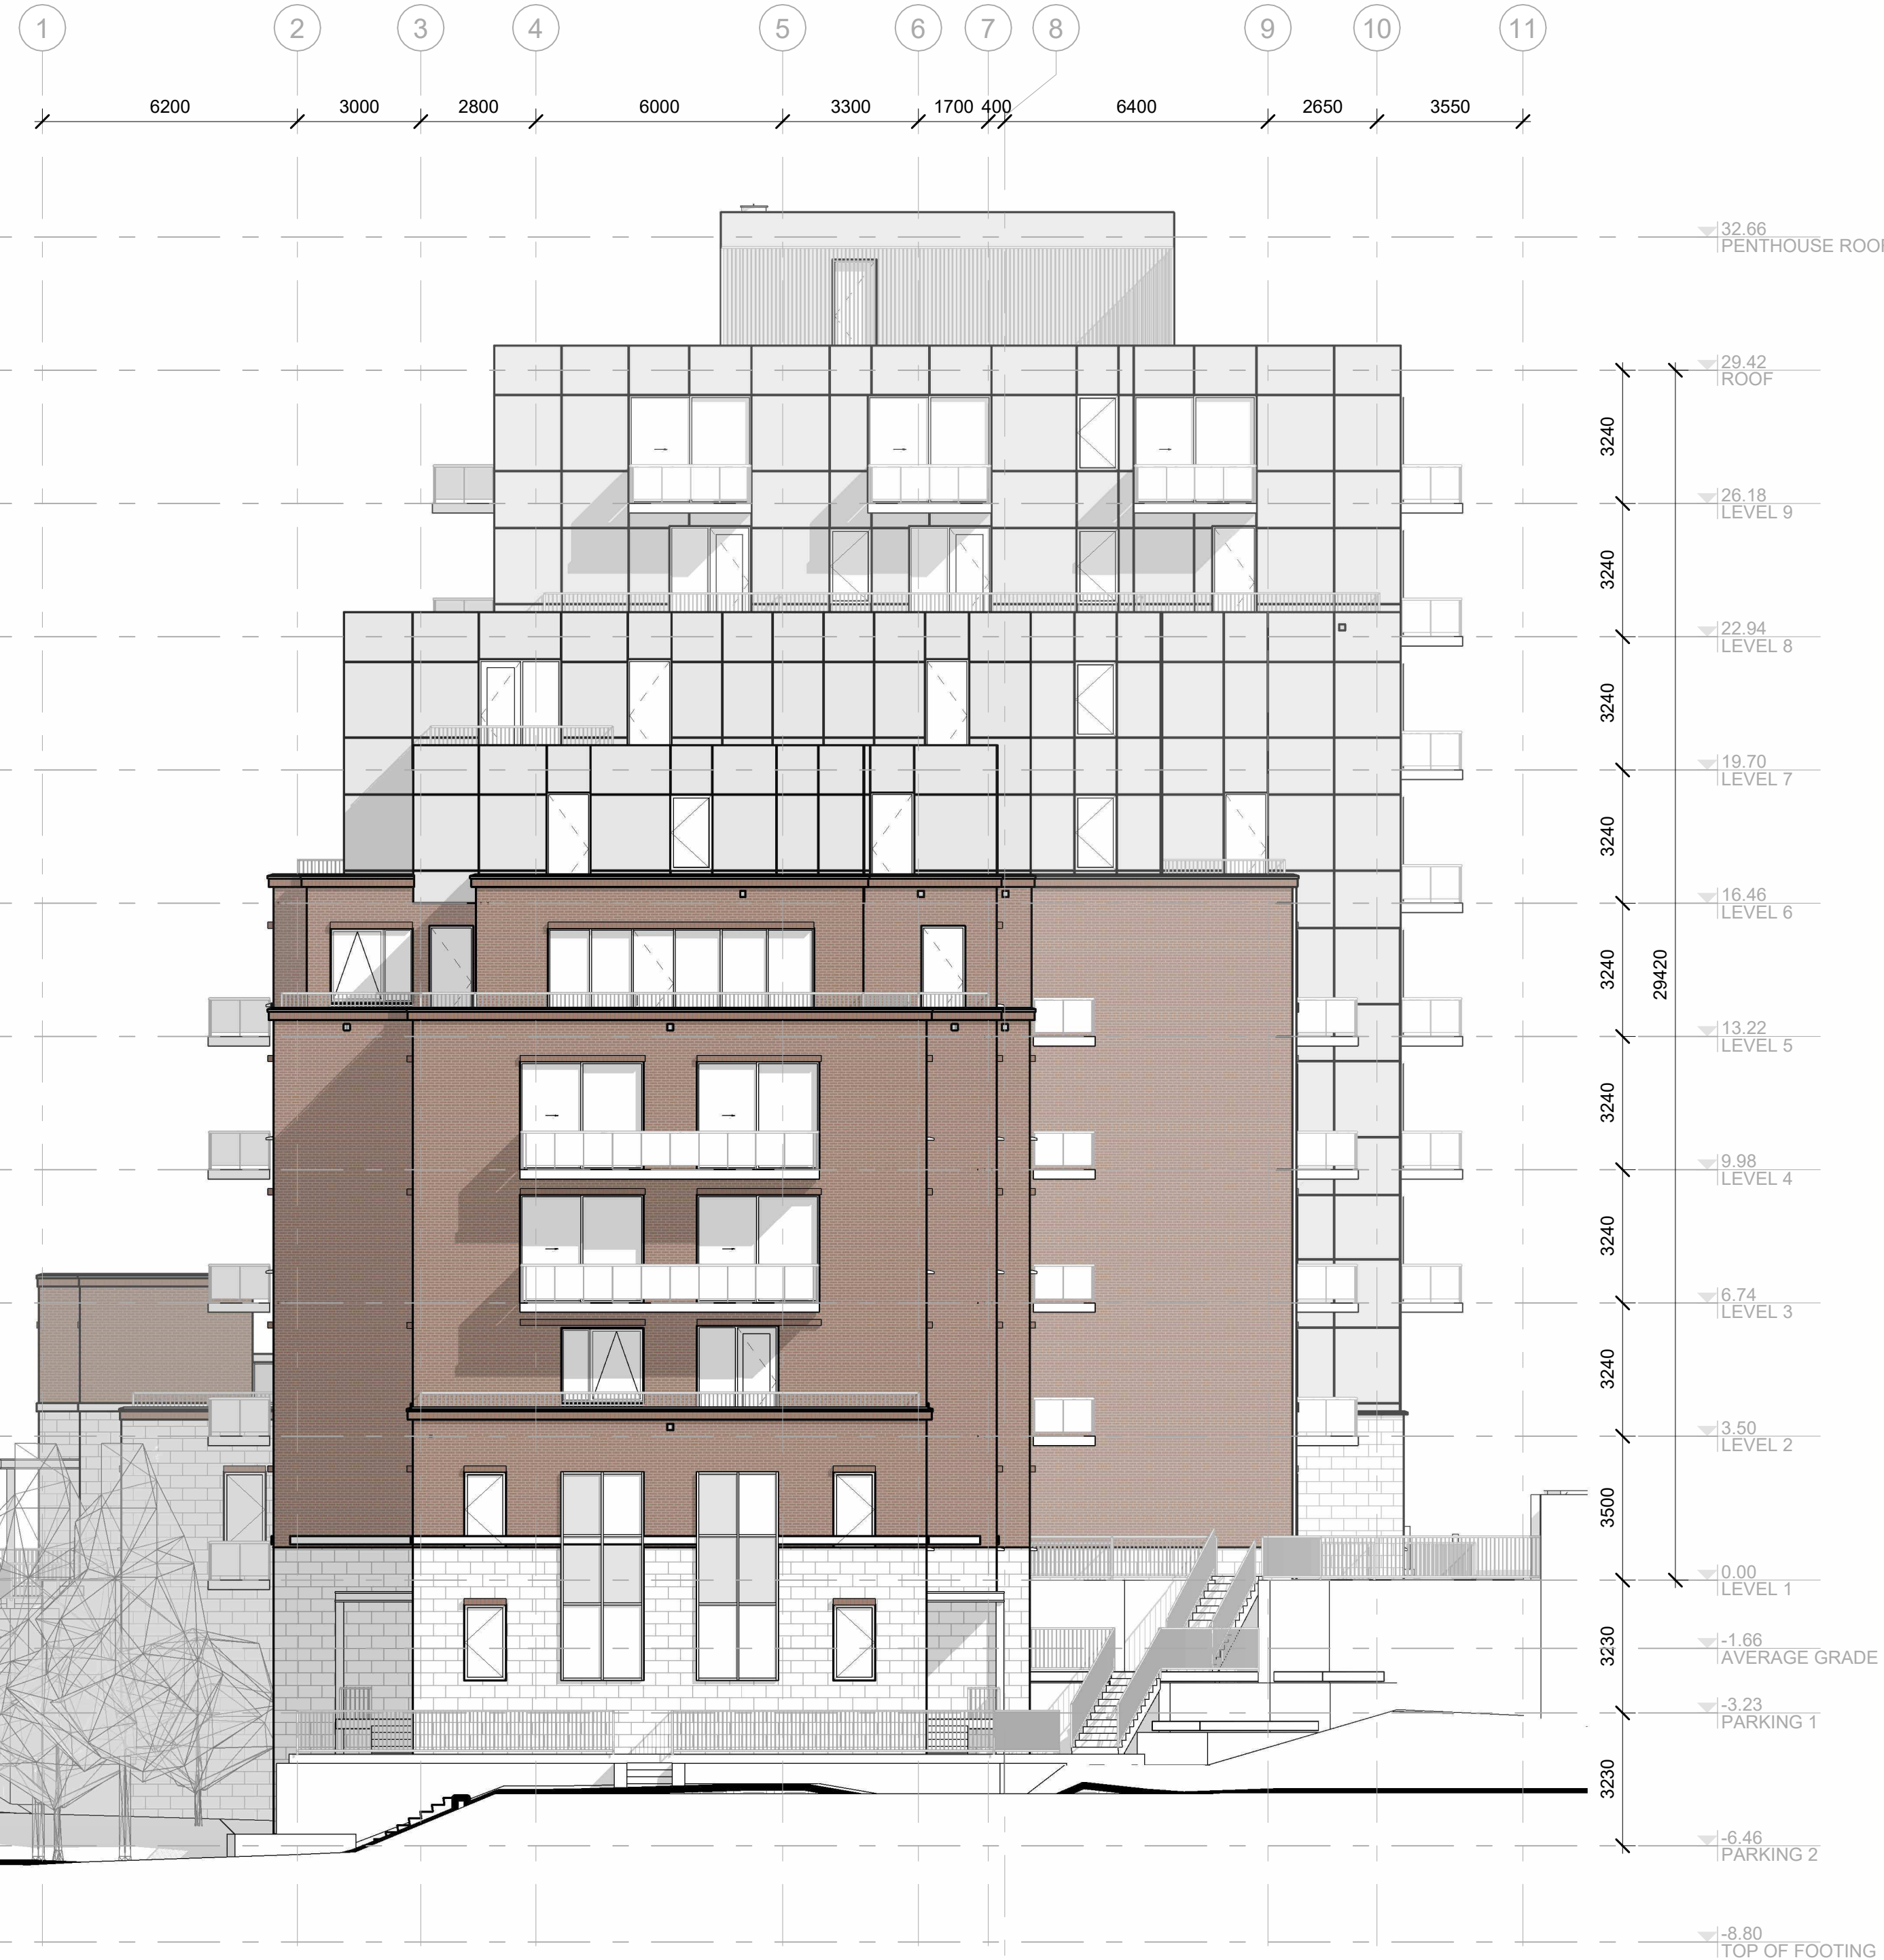

1 NORTH ELEVATION
A.302 | 1:125

ELEVATION NOTES:

CONTRACTOR TO COORDINATE WITH MANUFACTURER'S SPECIFICATIONS AND INSTALLATIONS GUIDELINES FOR ALL MATERIAL SEALING, TRANSITIONS, SEPARATIONS, FLASHING DETAILS, CONNECTIONS, ANCHORAGES, ETC. CONTRACTOR TO PROVIDE DETAIL DRAWINGS OR MOCK-UP FOR ARCHITECTS REVIEW AND APPROVAL FOR ALL SPECIAL CONDITIONS NOT SHOWN IN THE CONTRACT DOCUMENTS.

BIRD-SAFE GLASS TO BE USED AT A MIN. 90% OF ALL GLASS WITHIN THE FIRST 16M ABOVE AVERAGE GRADE (OR TO THE HEIGHT OF THE ADJACENT MATURE TREES)

ELEVATION KEYNOTES:

- # SAMPLE TEXT
- # SAMPLE TEXT
- # SAMPLE TEXT
- # SAMPLE TEXT MULTI LINE
- # SAMPLE TEXT

ELEVATION LEGEND:

HATCH PATTERNS SHOWN ARE FOR GRAPHIC PURPOSES ONLY AND SHOULD BE COORDINATED WITH ACTUAL SPECIFIED MATERIALS.

HATCH	SYMBOL	DESCRIPTION
		BRICK VENEER MANUFACTURER: COLOUR:
		STONE VENEER - BLOCK MANUFACTURER: COLOUR:
		FIBERCEMENT CLADDING MANUFACTURER: COLOUR:



STAMP

REV	DATE	ISSUE
8	2024.02.09	ISSUED FOR SITE PLAN CONTROL 3.1
7	2024.01.05	ISSUED FOR SITE PLAN CONTROL 3
6	2023.10.10	ISSUED FOR SITE PLAN CONTROL 2
5	2023.05.26	ISSUED FOR SITE PLAN CONTROL
4	2023.05.25	ISSUED FOR COORDINATION
3	2023.05.04	ISSUED FOR COORDINATION
2	2023.04.18	ISSUED FOR COORDINATION
1	2023.04.03	ISSUED FOR REVIEW

NOTES

- OWNERSHIP OF THE COPYRIGHT OF THE DESIGN AND THE WORKS EXECUTED FROM THE DESIGN REMAINS WITH CSV ARCHITECTS, AND MAY NOT BE REPRODUCED IN ANY FORM WITHOUT THE WRITTEN CONSENT OF CSV ARCHITECTS.
- THE DRAWINGS, PRESENTATIONS AND SPECIFICATIONS AS INSTRUMENTS OF SERVICE ARE AND SHALL REMAIN THE PROPERTY OF CSV ARCHITECTS. THEY ARE NOT TO BE USED BY THE CLIENT ON OTHER PROJECTS OR ON EXTENSIONS TO THIS PROJECT WITHOUT THE WRITTEN CONSENT OF CSV ARCHITECTS.
- THIS DRAWING IS TO BE READ IN CONJUNCTION WITH ALL OTHER PROJECT DRAWINGS AND SPECIFICATIONS.
- DO NOT SCALE DRAWINGS. CONTRACTOR SHALL BE RESPONSIBLE TO VERIFY DIMENSIONS ON SITE.
- ALL WORK SHALL BE IN ACCORDANCE WITH THE ONTARIO BUILDING CODE AND ALL SUPPLEMENTS AND APPLICABLE MUNICIPAL REGULATIONS.

CLIENT

OTTAWA
ONTARIO, CANADA

PROJECT

1815 MONTREAL ROAD

1815 MONTREAL ROAD


TITLE

WEST ELEVATION


PROJECT NO: 222450
DRAWN: R.R.
APPROVED: D.H.
SCALE: As Indicated
DATE PRINTED: 2/9/2024 2:28:21 PM

REV DRAWING NO.

8 **A.303**

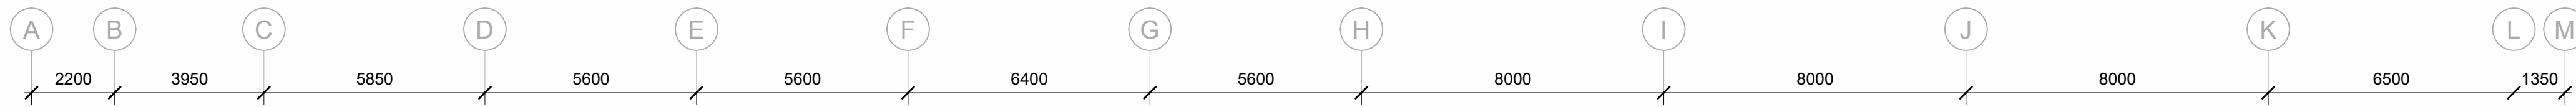


1 WEST ELEVATION
A.303 | 1:125

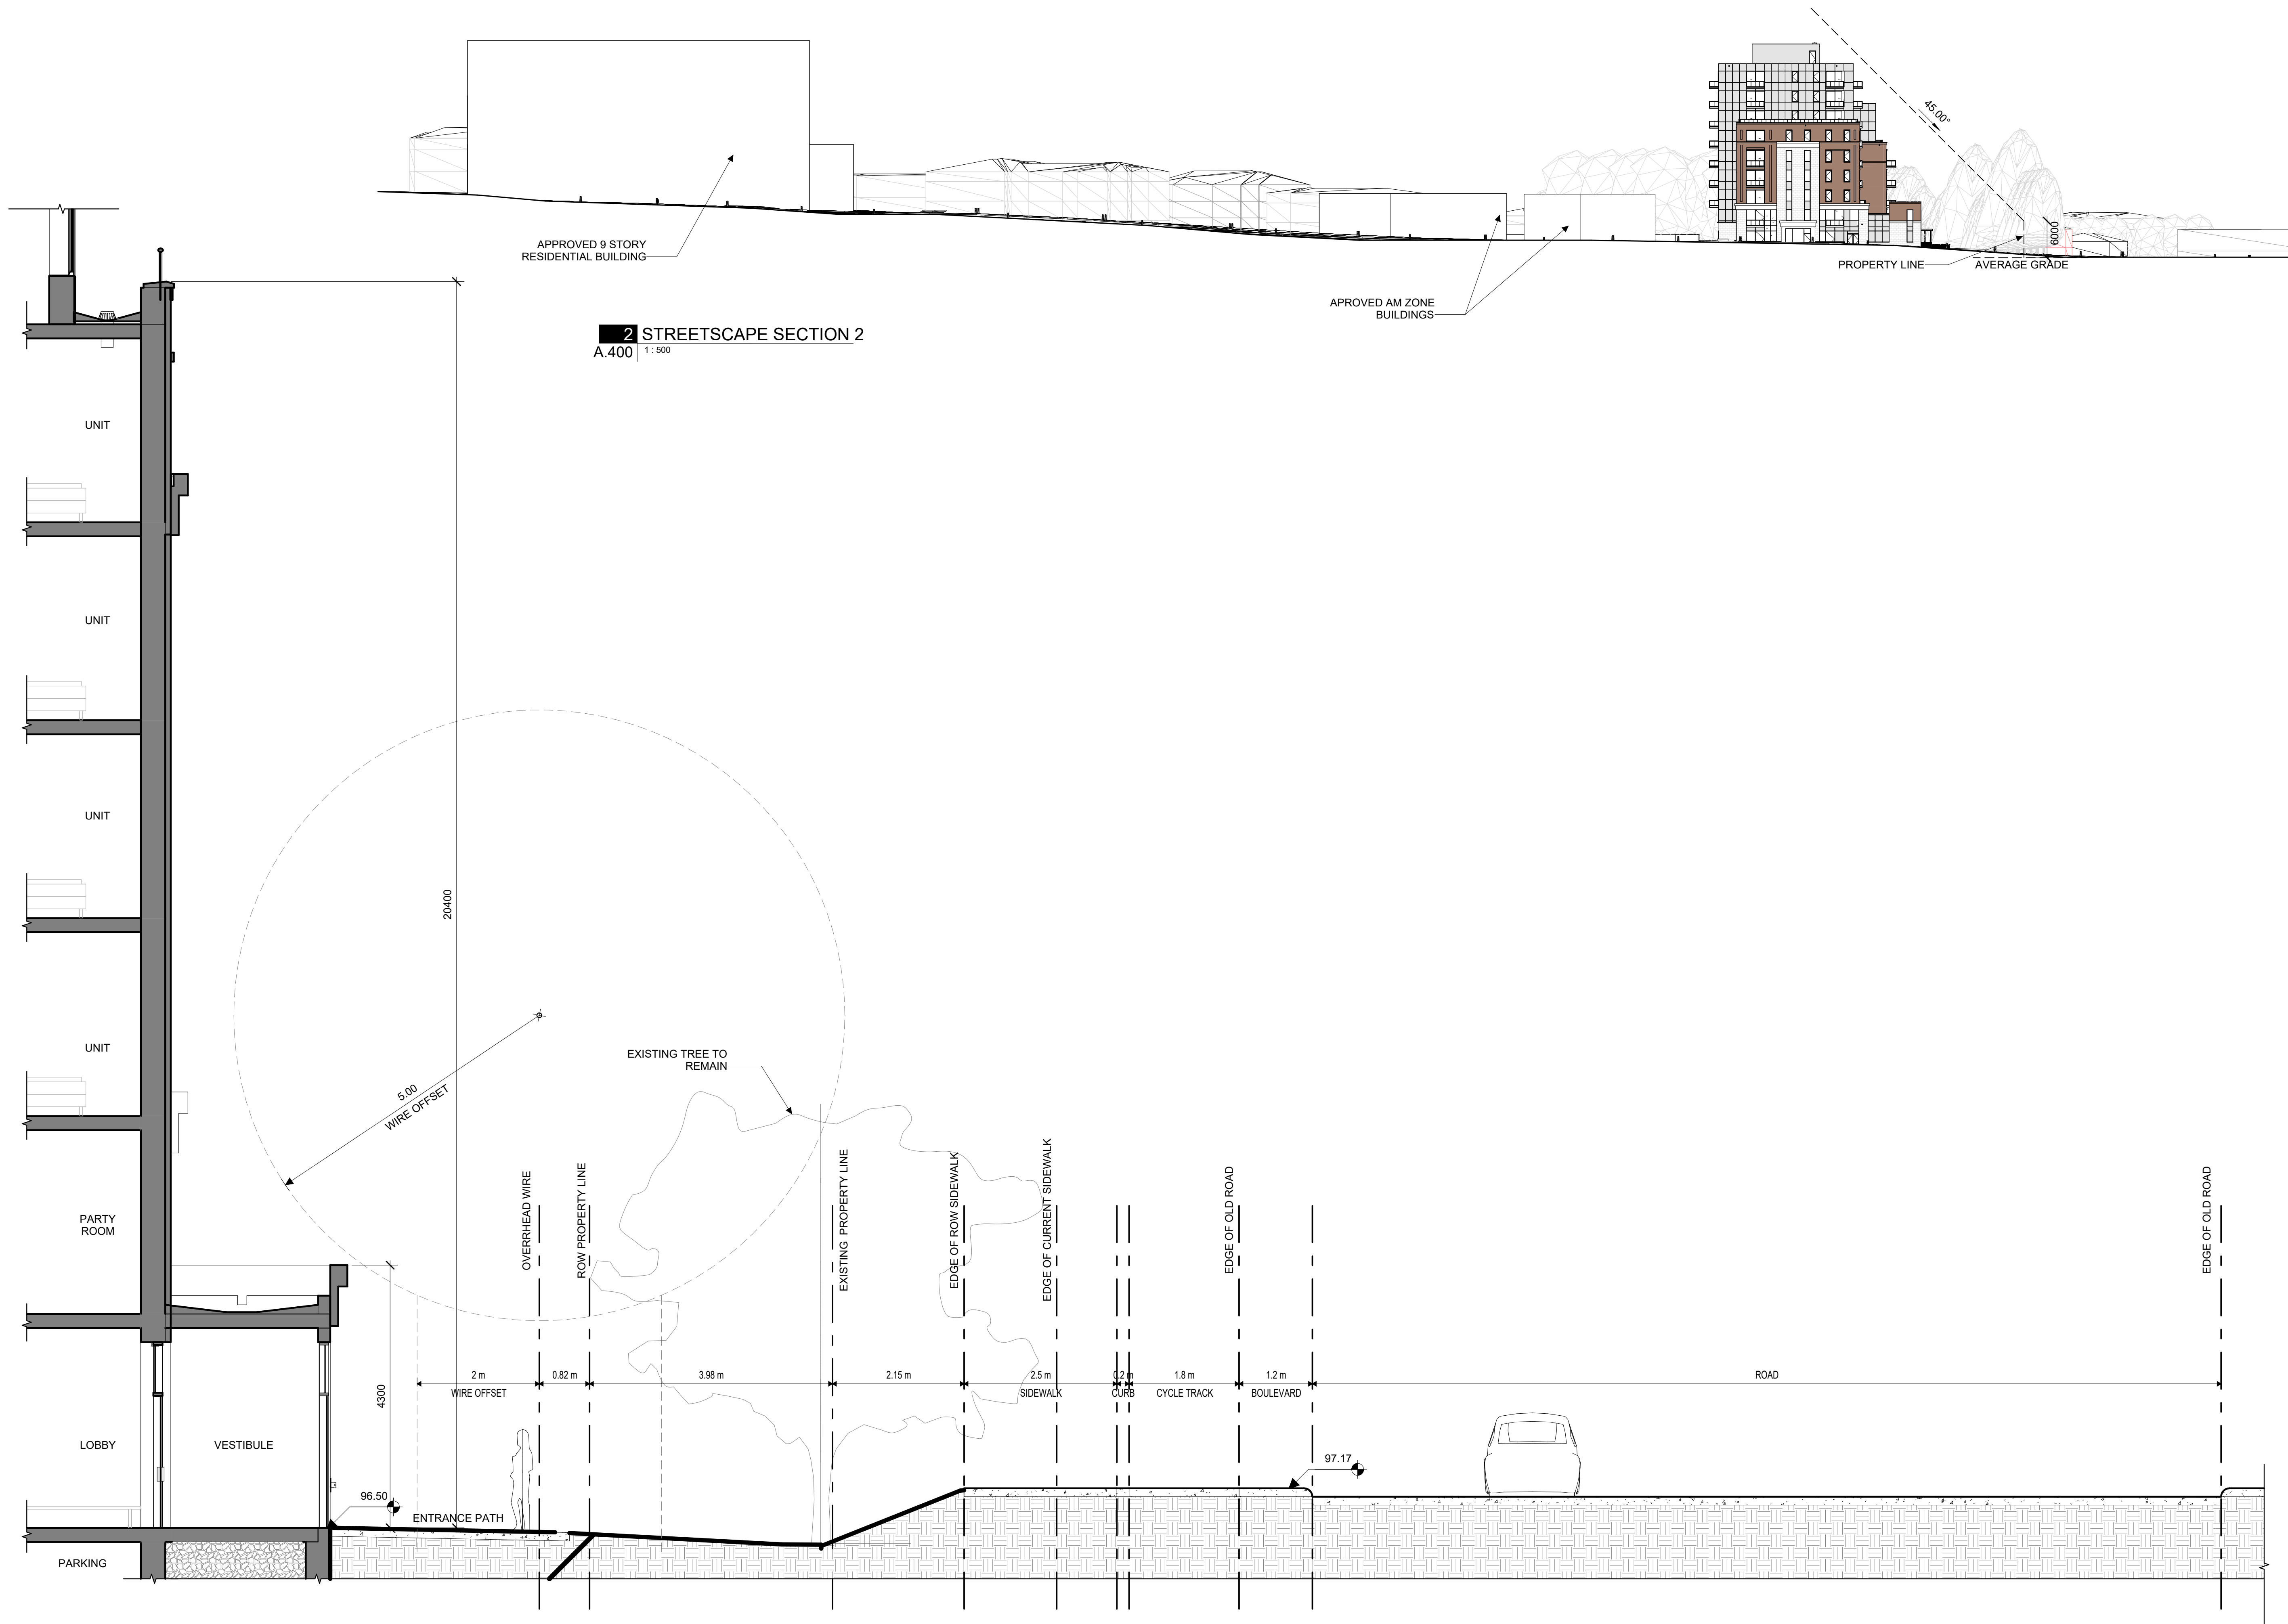

2 STREETScape SECTION 2
A.400 | 1:500

1 STREETScape SECTION 1
A.400 | 1:50

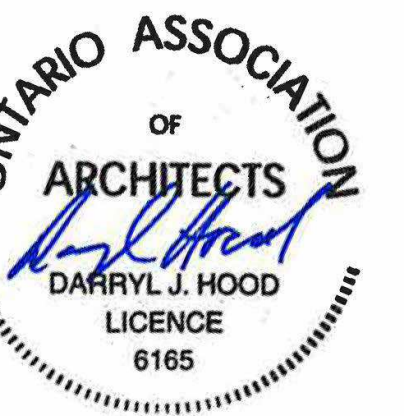

STAMP

8	2024.02.09	ISSUED FOR SITE PLAN CONTROL 3.1
7	2024.01.05	ISSUED FOR SITE PLAN CONTROL 3
6	2023.10.10	ISSUED FOR SITE PLAN CONTROL 2
5	2023.05.26	ISSUED FOR SITE PLAN CONTROL

REV DATE ISSUE



NOTES

1. OWNERSHIP OF THE COPYRIGHT OF THE DESIGN AND THE WORKS EXECUTED FROM THE DESIGN REMAINS WITH CSV ARCHITECTS, AND MAY NOT BE REPRODUCED IN ANY FORM WITHOUT THE WRITTEN CONSENT OF CSV ARCHITECTS.
2. THE DRAWINGS, PRESENTATIONS AND SPECIFICATIONS AS INSTRUMENTS OF SERVICE ARE AND SHALL REMAIN THE PROPERTY OF CSV ARCHITECTS. THEY ARE NOT TO BE USED BY THE CLIENT ON OTHER PROJECTS OR ON EXTENSIONS TO THIS PROJECT WITHOUT THE WRITTEN CONSENT OF CSV ARCHITECTS.
3. THIS DRAWING IS TO BE READ IN CONJUNCTION WITH ALL OTHER PROJECT DRAWINGS AND SPECIFICATIONS.
4. DO NOT SCALE DRAWINGS. CONTRACTOR SHALL BE RESPONSIBLE TO VERIFY DIMENSIONS ON SITE.
5. ALL WORK SHALL BE IN ACCORDANCE WITH THE ONTARIO BUILDING CODE AND ALL SUPPLEMENTS AND APPLICABLE MUNICIPAL REGULATIONS.

CLIENT

OTTAWA
ONTARIO, CANADA

PROJECT
1815 MONTREAL ROAD

1815 MONTREAL ROAD

TITLE
STREETScape SECTIONS

PROJECT NO: 222450
DRAWN: R.R.
APPROVED: D.H.
SCALE: As indicated
DATE PRINTED: 2/9/2024 2:28:25 PM

REV DRAWING NO.

8 **A.400**