



GENERAL NOTES:

- It is the responsibility of the appropriate contractor or official to report any errors, omissions or discrepancies on this plan with actual site conditions to the Landscape Architect before proceeding with construction.
- The contractor is to notify all utility companies and authorities prior to any excavation and ascertain locations of underground services.
- The contractor is to reinstate all areas and items damaged as a result of construction activity.
- The contractor is to comply with all pertinent codes and by-laws.
- The contractor is to maintain a positive surface run-off throughout the entire construction period.
- The Landscape Architect is not responsible for subsurface conditions.
- The contractor is to identify all existing trees to remain on site with the Landscape Architect prior to construction.
- The contractor is to stake the proposed location of all plant material in conjunction with the Landscape Architect prior to excavation.
- Minimum distances for selected deciduous trees are as follows:
 - Building Foundations 7.5m
 - Sidewalks 1.5m
 - Public Streets 2.5m
 - Underground Infrastructure 2.0m
- All trees within 1m of underground utility trenches are to be excavated by hand.
- Remove all protective wrapping from tree trunks after installation.
- Staking of trees shall only be performed if necessary.
- Ensure that mulch is pulled back a min. distance of 75mm from base of tree trunk.

PRECEDENT IMAGE: STOCK TANK PLANTER

GALVANIZED STOCK TANKS ARE A DURABLE AND SIMPLE OPTION FOR PLANTER BEDS. THEY REQUIRE NO INSTALLATION AND COME IN VARIOUS SIZES. THEY CAN ALSO OFTEN BE COST-EFFECTIVE WHEN COMPARED TO LESS-DURABLE ALTERNATIVES THAT REQUIRE ASSEMBLY.

NOTE: AREA WITHIN THE CRITICAL ROOT ZONE OF EXISTING WHITE SPRUCE TREE TO BE EXCAVATED USING A HYDRO-VAC

NOTE: AREA WITHIN THE CRITICAL ROOT ZONE OF EXISTING NORWAY MAPLE AND SIBERIAN ELM TREES TO REMAIN ARE TO BE EXCAVATED USING A HYDRO-VAC

NOTE: FENCE POSTS ARE TO BE INSTALLED AS FAR AWAY FROM EXISTING TREES AS POSSIBLE

NOTE: SHRUB PLANTING

NOTE: DECIDUOUS TREE PLANTING

NOTE: PRECAST PAVING DETAIL

NOTE: TREE INVENTORY AND ASSESSMENT LIST

NOTE: PROPOSED PLANT LIST

NOTE: PRECAST PAVING DETAIL - HERRINGBONE TO FADING GRID

NOTE: TREE INVENTORY AND ASSESSMENT LIST

NOTE: PROPOSED PLANT LIST

NOTE: PRECAST PAVING DETAIL












NOTE: TREE INVENTORY AND ASSESSMENT LIST

NOTE: PROPOSED PLANT LIST

NOTE: PRECAST PAVING DETAIL

NOTE: TREE INVENTORY AND ASSESSMENT LIST

NOTE: PROPOSED PLANT LIST

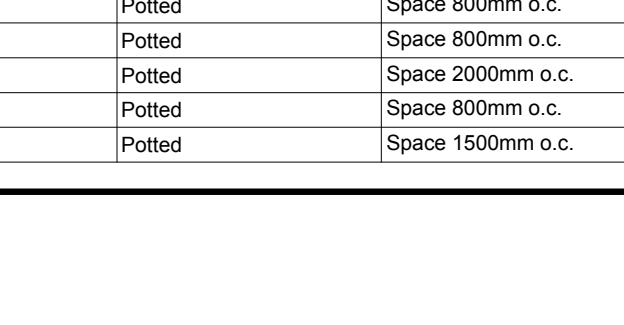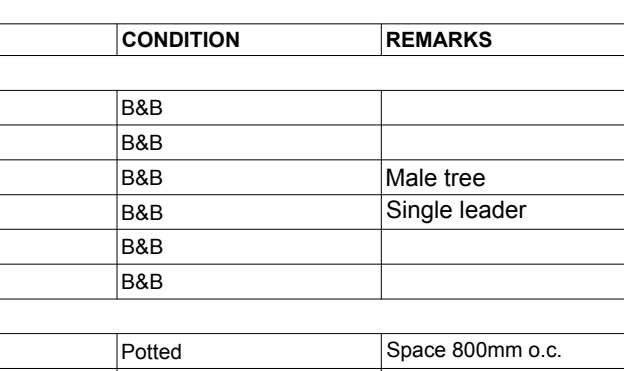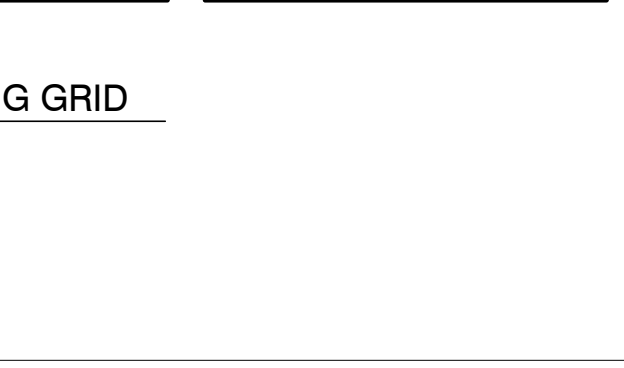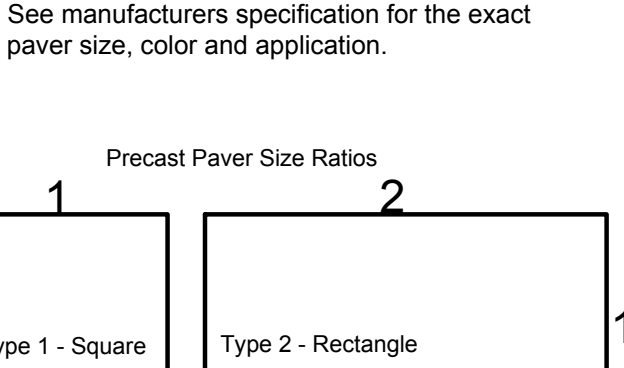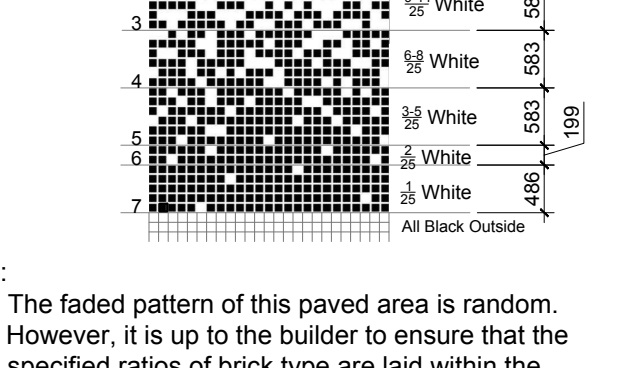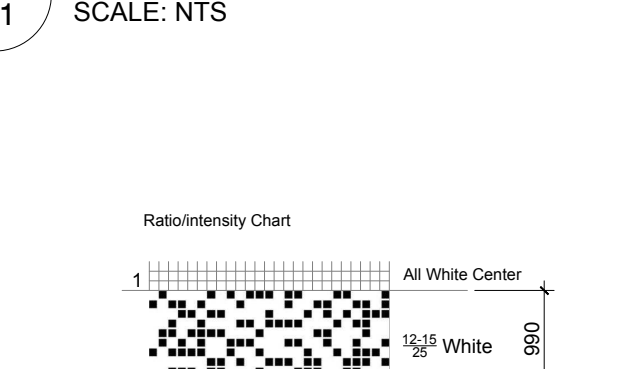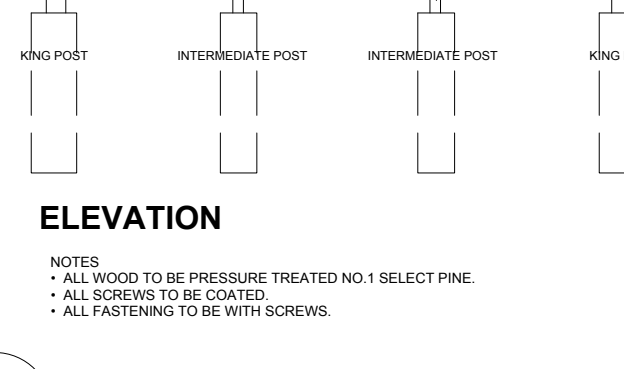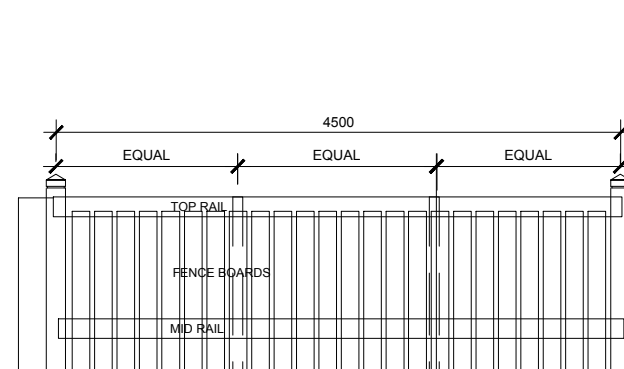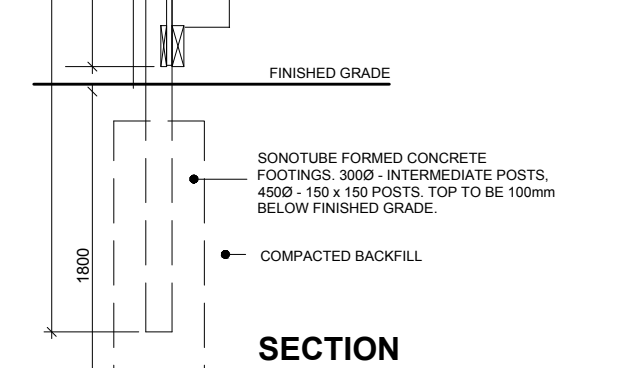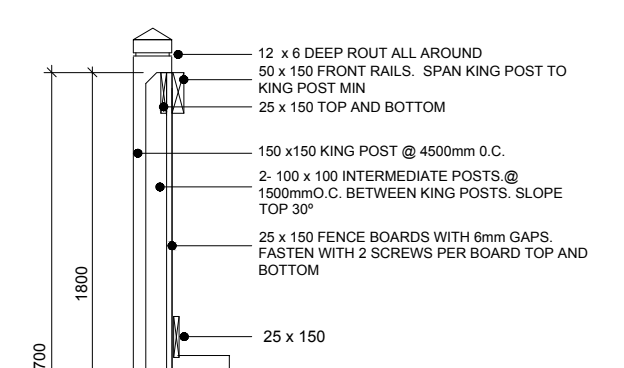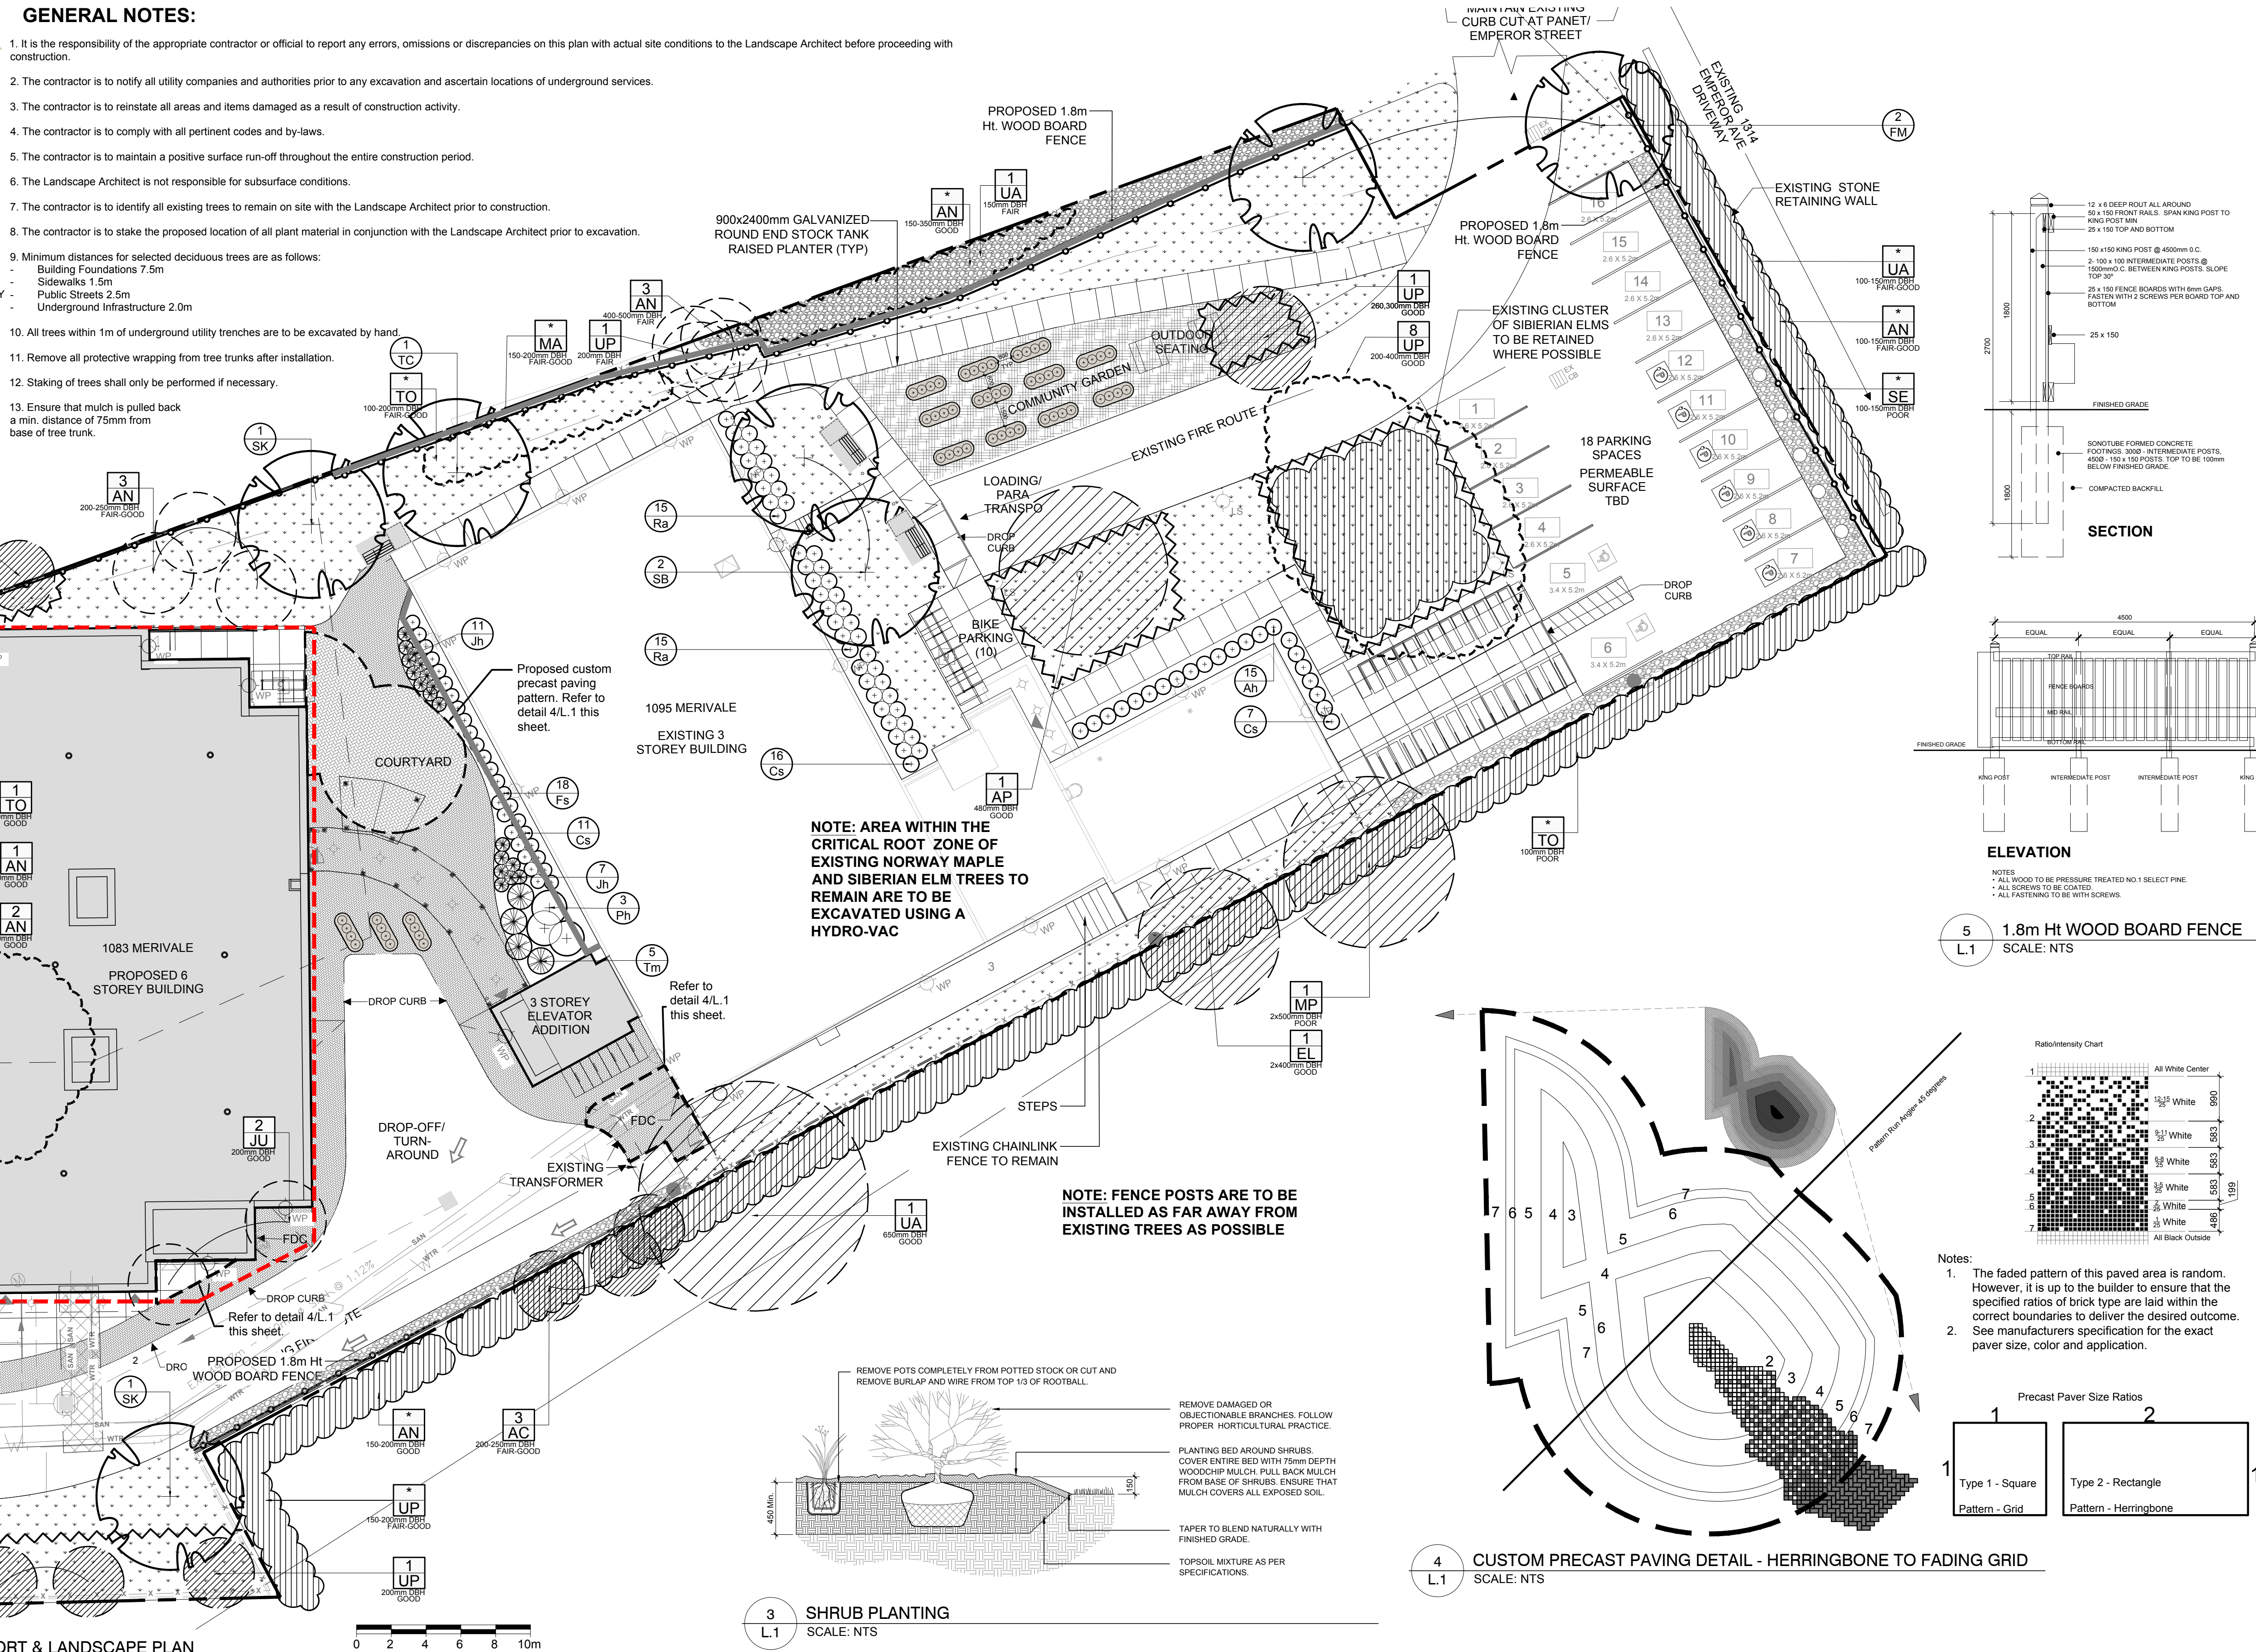

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- LEGEND**
- EXISTING TREE TO REMAIN
 - GROUP OF EXISTING TREES TO REMAIN
 - EXISTING TREE TO BE REMOVED
 - GROUP OF EXISTING TREES TO BE REMOVED
 - PROPOSED DECIDUOUS TREE
 - PROPOSED SHRUBS
 - PROPOSED SODDED GRASS AREA
 - PROPOSED PRECAST TYPE 1 CONCRETE PAVERS
 - PROPOSED PRECAST TYPE 2 CONCRETE PAVERS
 - PROPOSED RIVERSTONE MULCH
 - PROPOSED STONEDUST
 - PROPOSED STOCK TANK PLANTER
 - PROPOSED TREE PROTECTION FENCING
 - PROPOSED 1.8m Ht WOOD BOARD FENCE
 - PROPOSED BENCH
 - APPROXIMATE LIMIT OF EXCAVATION

7	REISSUED FOR SITE PLAN CONTROL	10/26/2023	ML	JL
6	ISSUED FOR SITE PLAN CONTROL	06/02/2023	ML	JL
5	ISSUED FOR DISCUSSION AND REVIEW	03/16/2023	CM	JL
4	ISSUED FOR DISCUSSION AND REVIEW	03/15/2023	ML	JL
3	ISSUED FOR DISCUSSION AND REVIEW	01/04/2023	ML	JL
2	ISSUED FOR DISCUSSION AND REVIEW	12/09/2022	ML	JL
1	ISSUED FOR DISCUSSION AND REVIEW	11/30/2022	ML	JL
No.	Issue	Date	DR	CK

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PROJECT
SGH 1083 MERIVALE
 1083 MERIVALE ROAD, OTTAWA ON K1Z 6A9

DRAWING
TREE CONSERVATION REPORT & LANDSCAPE PLAN

SCALE
 AS SHOWN

START DATE
 NOVEMBER 2022

PROJECT NO.

DRAWING NO.
L.1

PLOT SIZE ARCH-D


PLAN # 18957

TREE INVENTORY AND ASSESSMENT LIST

KEY	BOTANICAL NAME	COMMON NAME	SIZE	CRITICAL ROOT ZONE	OWNERSHIP	CONDITION	ACTION
3-AC	<i>Acer negundo</i>	Manitoba Maple	200-250mm DBH	2000-2500mm	1083 Merivale Ave	FAIR-GOOD	TO REMAIN
*-AN	<i>Acer negundo</i>	Manitoba Maple	150-500mm DBH	1500-5000mm	Numerous	FAIR-GOOD	SEE PLAN
1-AP	<i>Acer platanoides</i>	Norway Maple	480mm DBH	4800mm	1083 Merivale Ave	GOOD	TO REMAIN
1-EL	<i>Ulmus americana</i>	American Elm	2x400mm DBH	4000mm	1335 Dorchester	GOOD	SEE PLAN
2-JU	<i>Juniperus spp.</i>	Juniper	200mm DBH	2000mm	1083 Merivale Ave	GOOD	TO BE REMOVED
*-MA	<i>Malus spp.</i>	Crabapple	150-200mm DBH	1500-2000mm	1083 Merivale Ave	FAIR-GOOD	SEE PLAN
1-MP	<i>Acer negundo</i>	Manitoba Maple	500mm DBH	5000mm	1335 Dorchester	FAIR-GOOD	SEE PLAN
1-PG	<i>Picea glauca</i>	White Spruce	200mm DBH	2000mm	1077 Merivale Ave	FAIR	TO REMAIN
*-SE	<i>Ulmus pumila</i>	Siberian Elm	100-150mm DBH	1000-1500mm	1314 Emperor	GOOD	TO REMAIN
*-TO	<i>Thuja occidentalis</i>	White Cedar	100-200mm DBH	1000-2000mm	Numerous	POOR-GOOD	TO REMAIN
*-UA	<i>Ulmus americana</i>	American Elm	100-650mm DBH	1000-6500mm	1343 Dorchester	GOOD	SEE PLAN
*-UP	<i>Ulmus pumila</i>	Siberian Elm	300-350mm DBH	3000-3500mm	1083 Merivale Ave	FAIR-GOOD	SEE PLAN

PROPOSED PLANT LIST

KEY	QTY	BOTANICAL NAME	COMMON NAME	SIZE	CONDITION	REMARKS
FM	2	<i>Acer x freemanii</i>	Freeman's Maple	60mm cal.	B&B	
HB	1	<i>Celtis occidentalis</i>	Hackberry	60mm cal.	B&B	
GB	1	<i>Ginkgo biloba 'Princeton Sentry'</i>	Princeton Sentry Ginkgo	60mm cal.	B&B	Male tree
SB	2	<i>Amelanchier canadensis</i>	Serviceberry	60mm cal.	B&B	Single leader
SK	2	<i>Gleditsia triacanthos var. inermis 'Draves'</i>	Street Keeper Honeylocust	60mm cal.	B&B	
TC	2	<i>Tilia cordata</i>	Littleleaf Linden	60mm cal.	B&B	

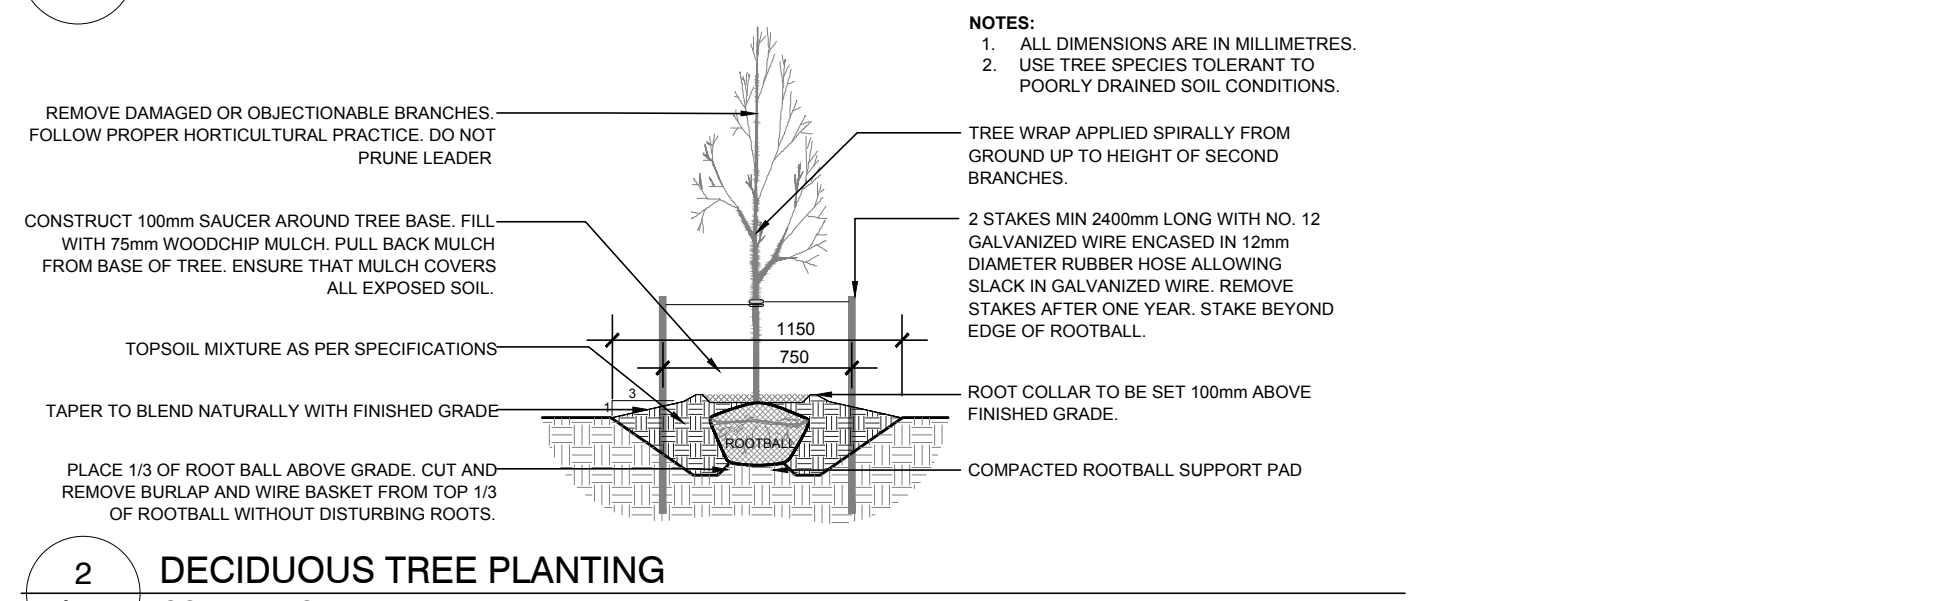

2 DECIDUOUS TREE PLANTING
 SCALE: NTS

D07-12-23-0078