


PAVERS	A CONTRACTOR OF THE PARTY OF TH			301		
CONCRETE 1 SOIL VOLUME AREA & ID						
		COIL VOLOIVI	_ ,	ANLA & ID		
		OTTAWA	Design	Soil		
Soil Volume Area, Tree Quantity and Size	Tree	Target Soil	Soil	Adequacy		
•	Quantity	Volume (m ³)	Volume			
AREA 1 - 4 large trees, 4 medium trees, 1 conifer						
plant bed (160 sq m x 0.9 metre deep)	9	147.0	144.0	97.96%		
AREA 2 - 2 large trees, 4 medium trees, 4 conifers						
plant bed (245 sq m x 0.7 metre deep)	10	156.0	171.5	109.94%		
AREA 3 - 1 small ornamental tree (15cm DBH)*						
plant bed (7 sq m x 0.9 metre deep)	1	7.0	6.3	90.00%		
* Small ornamental trees with growth to 8-15cm DBH, calculated using 'How much soil to grow a big tree' by	_		nnar conif	ers		

Meadow Seed mix			
Bromus ciliatus	Fringed Brome		
Elymus canadensis	Canada Wild Rye		
Monarda fistulosa	Wild Bergamot		
Rudbeckia fulgida	Blackeyed Susan		
Schizachyrium scoparium	Little bluestem		
Sporobolus compositus	Rough Dropseed		
Symphyotrichum novae-angliae	New England Aster		
Spartina pectinata	Prairie Cord Grass		
Agrostis perennans	Autumn Bentgrass		
โo be used along eastern edge of ∣ Riperian Seed Mix			
Agrostis scabra	Ticklegrass		
Carex vulpinoidea	Fox Sedge		
Elymus virginicus	Virginia Wild Rye.		
Poa palustris	Fowl Bluegrass		
Puccinellia nuttalliana	Nuttall's Alkali Grass		
Asclepias incarnata	Marsh Milkweed		
Asciepias ilicalitata	Obedient plant		
Physostegia virginiana			
	Culvers Root		

List					
Qty	Botanical Name	Common Name	Sched. Size	Remarks	Origin
	TREES				
3	Acer rubrum	Red Maple	70mm caliper	WB, Staked	Ntv
2	Aesculus glabra	Ohio Buckeye	50mm caliper	WB, Staked	Ntv
2	Betula papyrifera	Paper Birch, Canoe Birch	60mm caliper	WB, Staked	Ntv
4	Celtis occidentalis	Common Hackberry	60mm caliper	WB, Staked	Ntv
2	Picea glauca	White Spruce	200cm ht	WB, Staked	Ntv
2	Pinus strobus	Eastern White Pine	200cm ht	WB, Staked	Ntv
3	Quercus rubra	Northern Red Oak	70mm caliper	WB, Staked	Ntv
1	Tsuga canadensis	Canadian Hemlock	200cm ht	WB, Staked	Ntv
	SHRUBS				
9	Aronia melanocarpa	Black Chokeberry	50cm ht.	Bare root	Ntv
14	Cephalanthus occidentalis	Buttonbush	50cm ht.	Potted	Ntv
9	Cornus racemosa	Gray Dogwood	50cm ht	Potted	Ntv
14	Diervilla Ionicera	Dwarf Bush-honeysuckle	2 gallon pot	Potted	Ntv
17	Potentilla fruticosa	Bush Cinquefoil	2 gallon pot	Potted	Ntv
36	Rhus aromatica	Fragrant Sumac	50cm ht.	Potted	Ntv
27	Symphoricarpos albus	Snowberry	50cm ht.	Potted	Ntv
11	Thuja occidentalis (Nursery grown, Clumps)	White Cedar, Eastern Arborivitae	200cm ht	B&B	Ntv H
20	CLIMBERS				
6	Lonicera dioica	Glaucous Honeysuckle	3 year	Potted	Ntv
8		-		Potted	Ntv
					Ntv
675					
61	Ornamental Grasses - Mixed	Karl Foerster Featherreed Grass, Switch Grass, Big Bluestem	3 year	Potted	Mix
42	Ornamental Grasses - Native	Hall's Fescue, Bottlebrush Grass, Canada Wild Rye, Little Bluestem	3 year	Potted	Ntv
Planter Qty	Perennial planter type				
11	Planter type A	Per planter: 2 Rodgersia, 14 (Wild Strawberry, Pink Coreopsis, Candytuft			Mix
13	Planter type B	Per planter: 2 Little Bluestem Grass, 17 (trailing sedum varieties, Wild Strawberry, Pink Coreopsis)			Mix
10	Planter type C	Per planter: 2 Prairie Dropseed Grass, 17 (Trailing sedum varieties, Wild Strawberry, trailing Phlox)			Mix
	3 2 2 4 2 3 1 9 14 9 14 17 36 27 11 20 6 8 6 675 61 42 Planter Qty 11	TREES Acer rubrum Aesculus glabra Betula papyrifera Celtis occidentalis Picea glauca Pinus strobus Quercus rubra Tsuga canadensis SHRUBS Aronia melanocarpa Cephalanthus occidentalis Cornus racemosa Diervilla lonicera Potentilla fruticosa Rhus aromatica Symphoricarpos albus Thuja occidentalis (Nursery grown, Clumps) CLIMBERS Lonicera dioica Clematis virginiana Clematis occidentalis Clematis occidentalis PERENNIALS Ornamental Grasses - Mixed Planter Qty Planter type A Planter type B	Qty Botanical Name Common Name TREES 3 Acer rubrum Red Maple 2 Aesculus glabra Ohio Buckeye 2 Betula papyrifera Paper Birch, Canoe Birch 4 Celtis occidentalis Common Hackberry 2 Picus strobus Eastern White Pine 3 Quercus rubra Northern Red Oak 1 Tsuga canadensis Canadian Hemlock 5HRUBS SHRUBS 9 Aronia melanocarpa Black Chokeberry 14 Cephalanthus occidentalis Buttonbush 9 Cornus racemosa Gray Dogwood 14 Diervilla lonicera Dwarf Bush-honeysuckle 17 Potentilla fruticosa Bush Cinquefoil 36 Rhus aromatica Fragrant Sumac 27 Symphoricarpos albus Snowberry 11 Thuja occidentalis (Nursery grown, Clumps) White Cedar, Eastern Arborivitae 20 CLIMBERS Lonicera dioica Glaucous Honeysuckle 3 Clematis virginiana Virgin'	Ret Sched. Size TREES	Remarks TREES TR

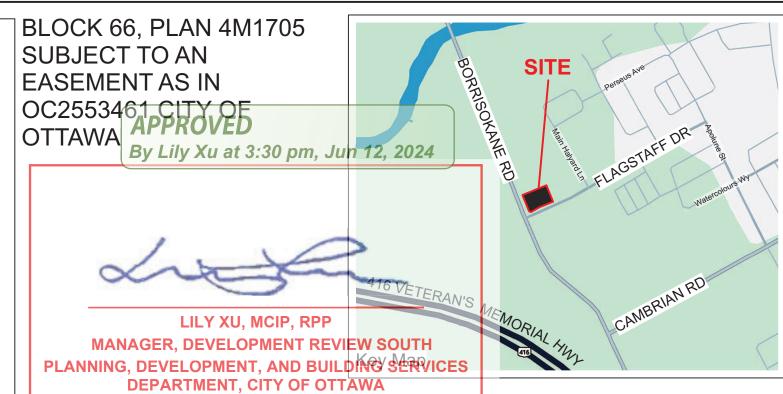

.1 All general site information and conditions compiled from existing plans, surveys and consultant's field notes. Report all discrepancies prior

to any work. No responsibility is born by the Consultant for unknown

.2 The location of the utilities is approximate only, and the exact location should be determined by consulting the municipal authorities and utility

companies concerned. The Contractor shall prove the location of utilities

construction. No deviations are to be made from the layouts as shown on this plan without prior consultation with the Landscape Architect and Owner.

.4 Obtain approval of Landscape Architect for granular base and layout of

.5 Stake planting locations and receive approval of Landscape Architect, prior to excavation of any planting pits. No substitutions of plant material

.7 Maintain positive surface runoff through the entire construction period.

THIS PLAN IS ISSUED FOR SITE PLAN CONTROL SUBMISSION ONLY.

TREE CANOPY COVERAGE

TOTAL CANOPY AREA | 1319 23

PERCENT COVERAGE 30%

4390 m2

Scale: 1:500

TOTAL SITE AREA

ADDITIONAL DETAILING AND SPECIFICATIONS ARE REQUIRED

PRIOR TO TENDERING OR CONSTRUCTION.

EXISTING SITE CONDITIONS

THE SITE HAS BEEN CLEARED OF VEGETATION. NO TREES OVER 10cm DBH EXIST ON THE SITE.

.8 Reinstate all areas and items damaged as a result of construction

and shall be responsible for adequate protection from damage. .3 All dimensions shown are to be verified on site prior to any

shall be made without prior approval of the Landscape Architect. .6 Where clay is encountered proper drainage must be ensured in tree/shrub pits, prior to planting. Have method approved by Landscape

GENERAL NOTES

subsurface conditions.

all pavement areas prior to construction.













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ENGINEERS & SCIENTISTS



LRL ENGINEERING



Ruhland & Associates Ltd landscape architecture • urban design • site planning

3 Re-Issued for SPC 2024/02/22 Re-Issued for SPC 2023/12/14

NUMBER/ NUMÉRO MILESTONE / FAIT SAILLANT DESIGNED BY / CONCU PAR M. Ruhland M. Ruhland DRAWN BY / DESSINE PAR SCALE / ECHELLE



ARCHITECT

T.Frost / V. Odusanya



CONSULTANT

CONSULTANT


PROJECT / LOCATION


THE NUKK

652 FLAGSTAFF DRIVE, OTTAWA ON.

LANDSCAPE PLAN


SHEET NO. L-01 PROJECT NO. 23-1719

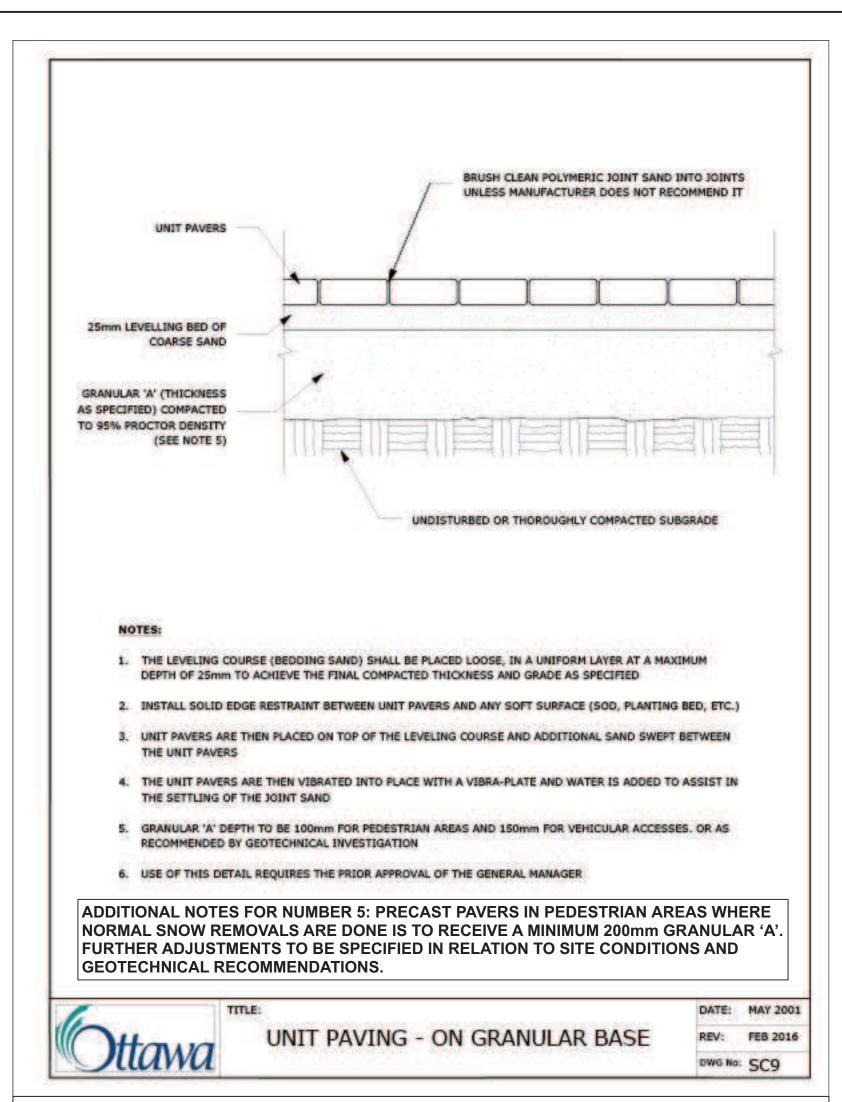

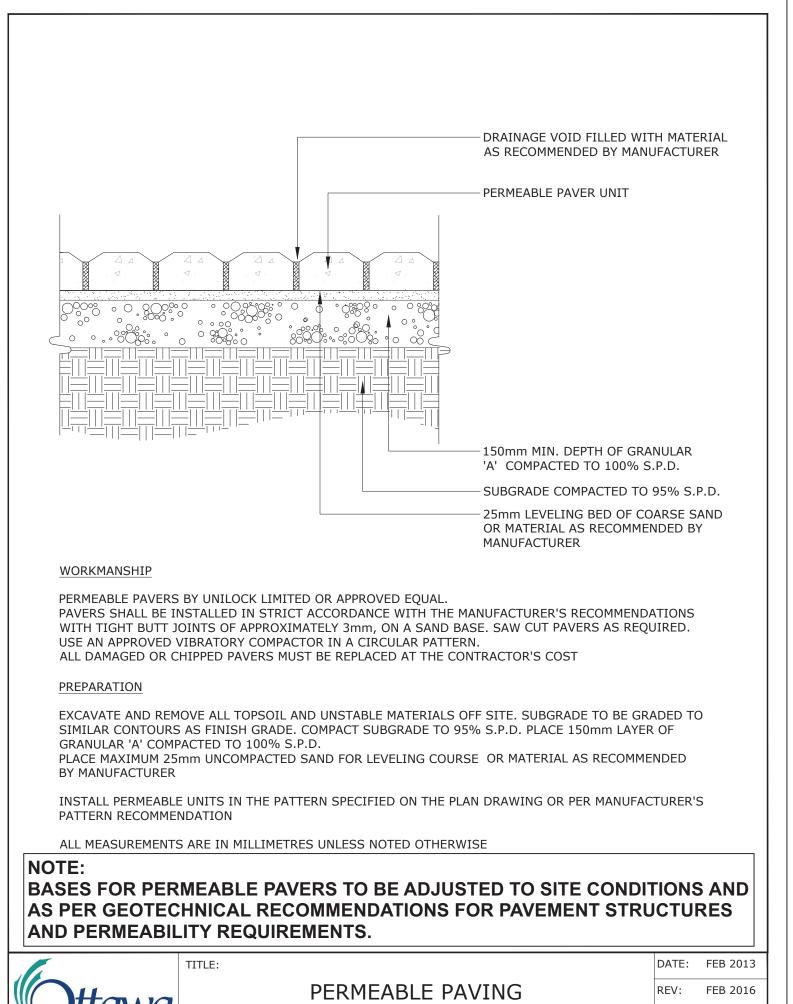

DWG No: SC27



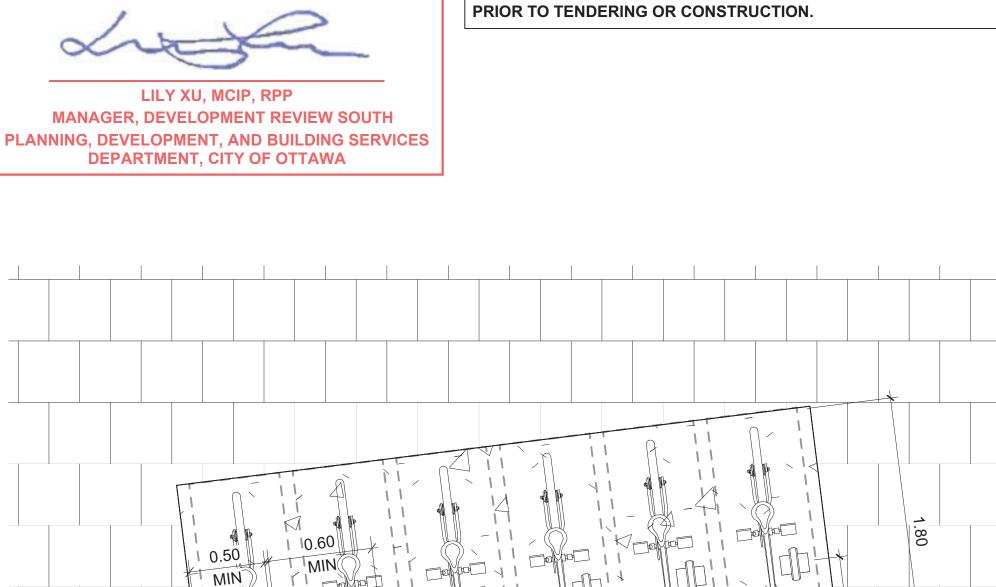


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ADDITIONAL DETAILING AND SPECIFICATIONS ARE REQUIRED



PLANTER



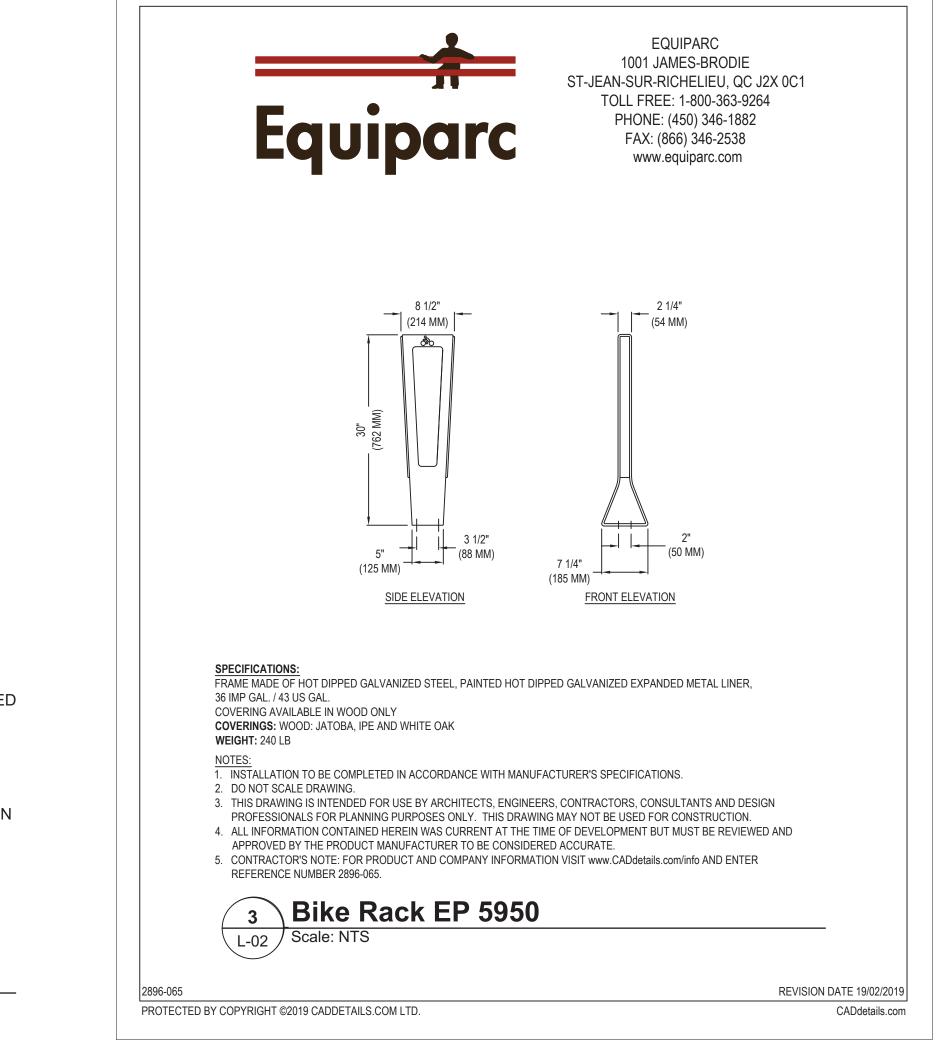





DESIGN & SYSTEMS













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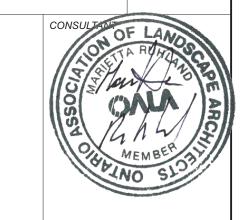
3 Re-Issued for SPC 2024/02/22 Re-Issued for SPC 2023/12/14 Issued for SPC 2023/08/22

DATE: (Y/M/D) INITIALS INITIALE MBER/ MILESTONE / FAIT SAILLANT DESIGNED BY / CONCU PAR CHECKED BY / VERIFIE PAR M. Ruhland M. Ruhland

DRAWN BY / DESSINE PAR

T.Frost / V. Odusanya

ARCHITECT



CONSULTANT

SCALE / ECHELLE

AS SHOWN

CONSULTANT

PROJECT / LOCATION

THE NUKK

652 FLAGSTAFF DRIVE, OTTAWA ON.


LANDSCAPE PLAN

SHEET NO. PROJECT NO.


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L-02

19106

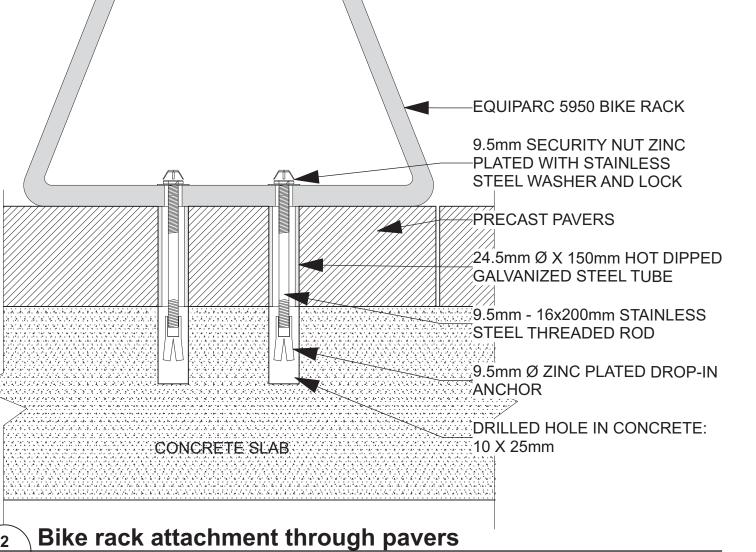

PROVIDE SHOP DRAWINGS FOR ANCHORS AND CONCRETE PAD

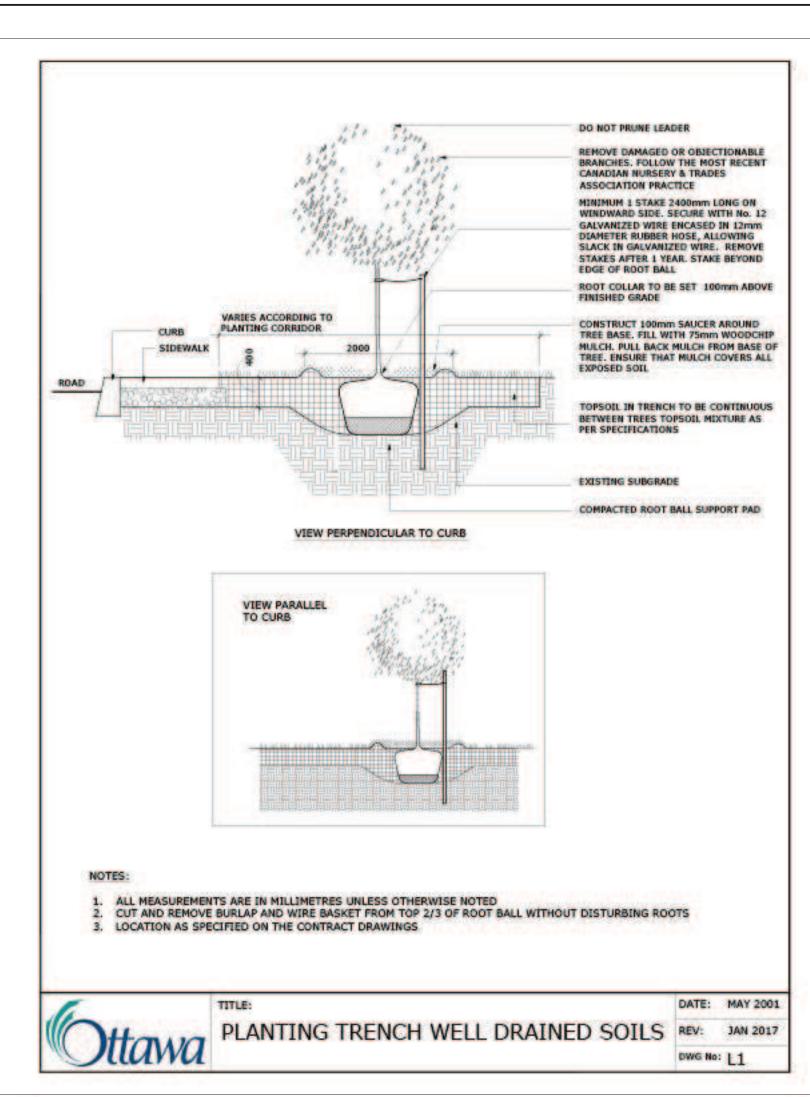

TREE SOIL VOLUME REQUIREMENTS:

STANDARD TREE SOIL VOLUMES QUANTITIES INCLUDE THE TOP 900-1000mm OF SOIL/EXISTING SUBSOIL LAYER TO CALCULATE TOTAL SOIL VOLUMES REQUIRED BY CITY OF OTTAWA FOR SUSTAINABLE TREE GROWTH. WHERE LARGER SOFT AREAS ARE AVAILABLE, THE TOP 400-500mm LAYER IS USED TO CALCULATE SOIL VOLUMES.

WHERE EXISTING MATERIAL BELOW THE SPECIFIED TOPSOIL IS NOT CONDUCIVE TO TREE GROWTH, AN ADDITIONAL LAYER OF PLANTING MEDIUM IS TO BE INSTALLED BELOW SPECIFIED TOPSOIL DEPTH TO OBTAIN THE SOIL VOLUME DEPTH REQUIRED.

REFER TO SOIL VOLUME CHART AND PLANS FOR AREA WHERE TREE SOIL VOLUMES ARE REQUIRED.


TREE SOIL VOLUME REQUIREMENTS:


STANDARD TREE SOIL VOLUMES QUANTITIES INCLUDE THE TOP 900-1000mm OF IMPORTED AND EXISTING SOIL/SUBSOIL LAYER TO CALCULATE TOTAL SOIL VOLUMES REQUIRED BY CITY OF OTTAWA FOR SUSTAINABLE TREE GROWTH.


WHERE LARGER SOFT AREAS ARE AVAILABLE WITH APPROVED EXISTING TOPSOIL AND SUBSOIL, IMPORTED TOPSOIL ONLY AS PER DETAIL L-2.


WHERE EXISTING MATERIAL BELOW THE SPECIFIED TOPSOIL IS NOT CONDUCIVE TO TREE GROWTH, AN ADDITIONAL LAYER OF 400mm PLANTING MEDIUM AND APPROVED SUBSOIL IS TO BE INSTALLED BELOW SPECIFIED TOPSOIL DEPTH TO OBTAIN THE SOIL VOLUME DEPTH REQUIRED.

REFER TO SOIL VOLUME NOTES.

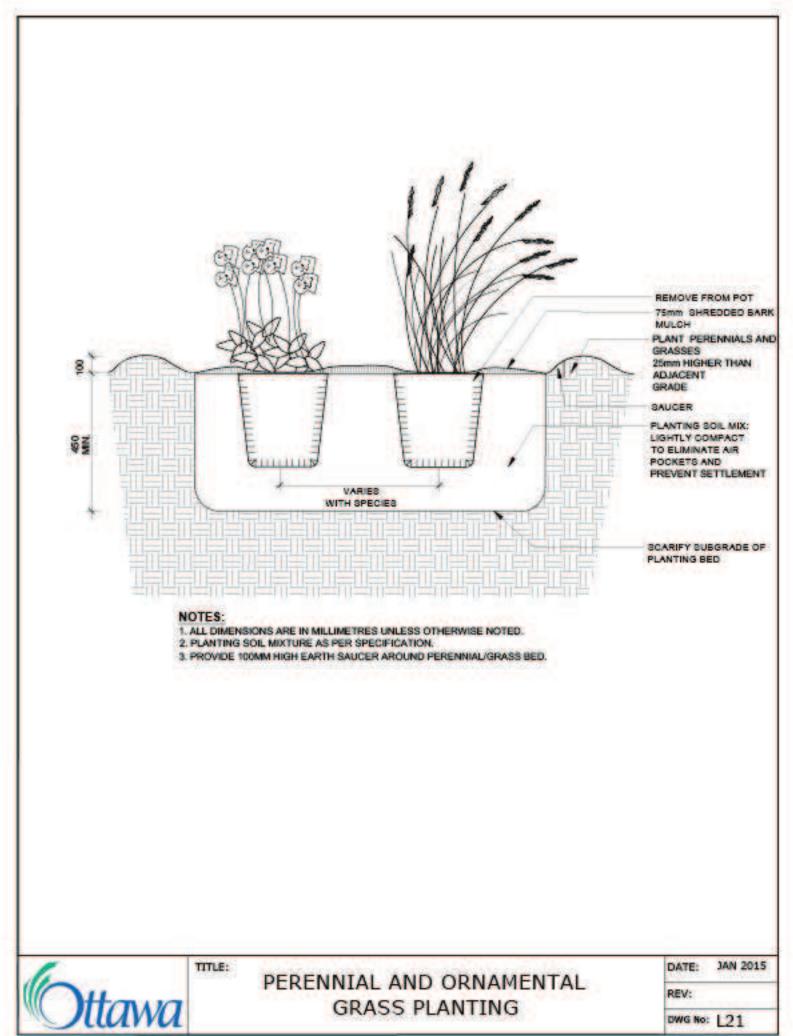

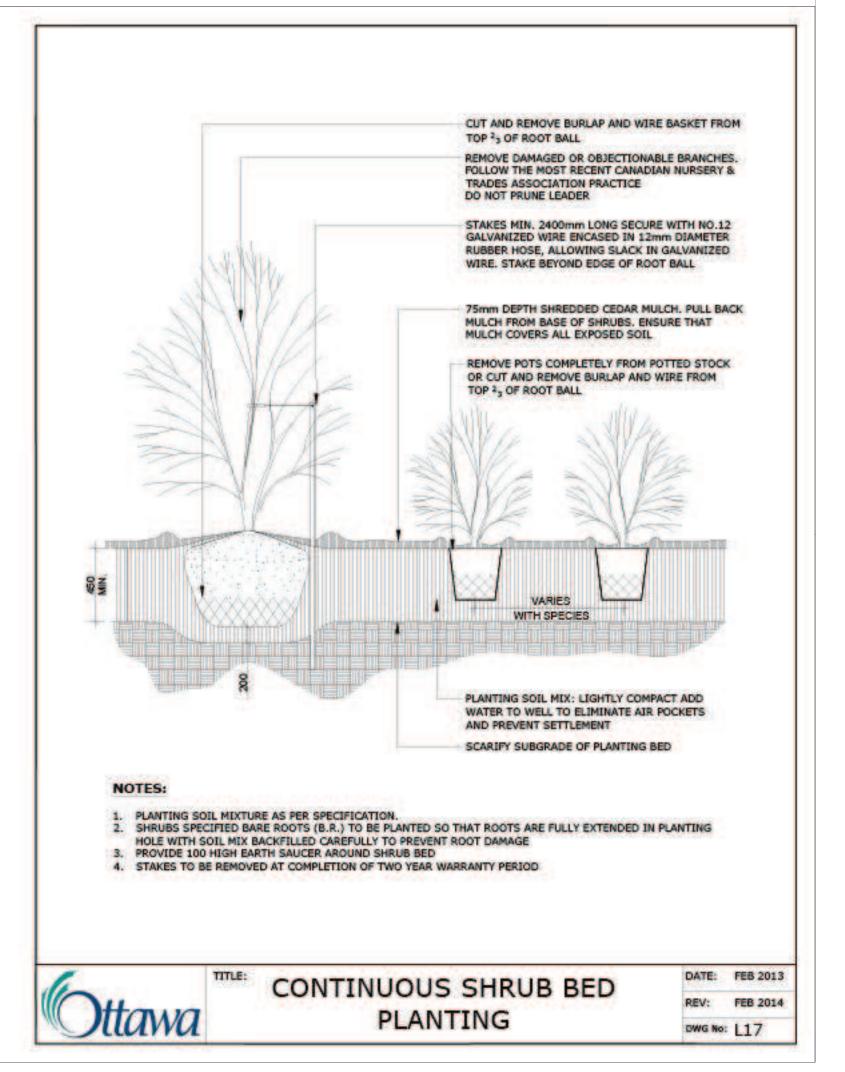

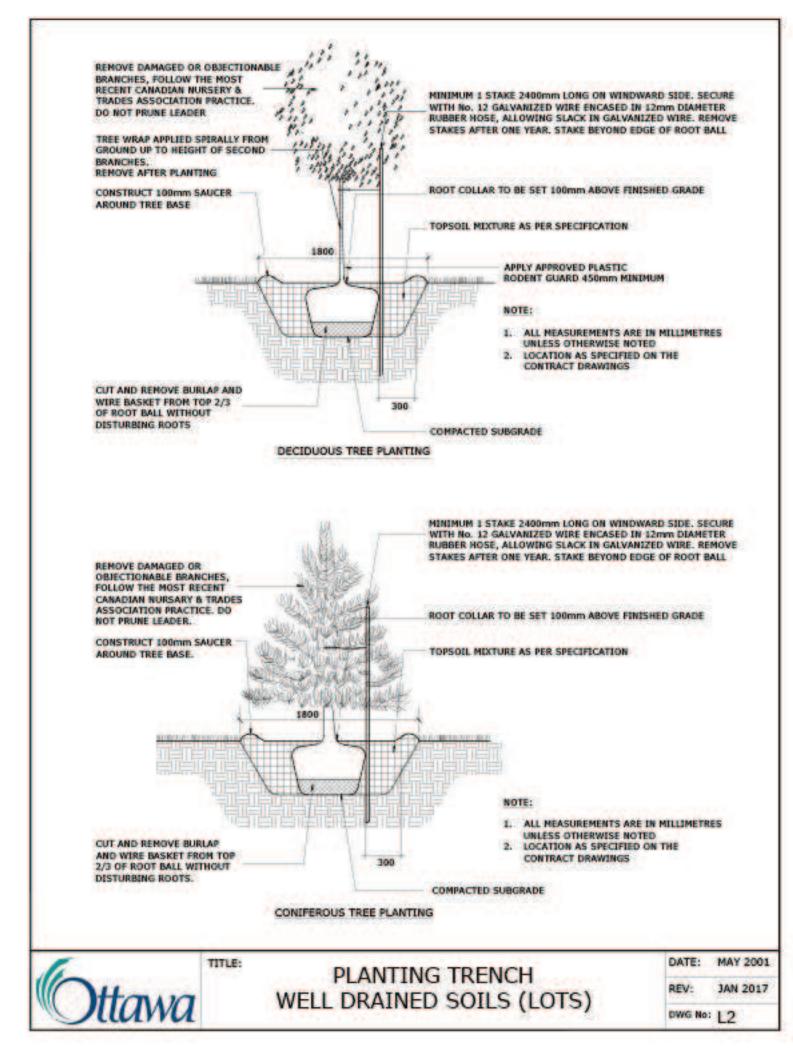

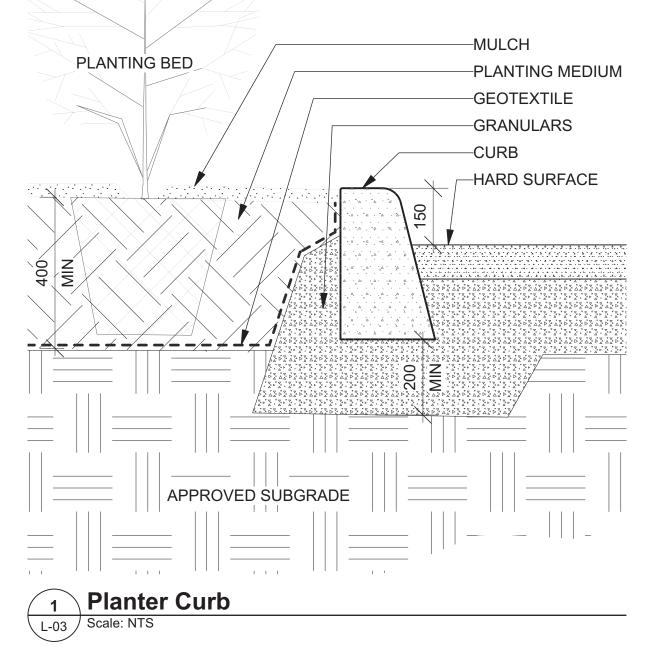



DEPARTMENT, CITY OF OTTAWA







DESIGN & SYSTEMS















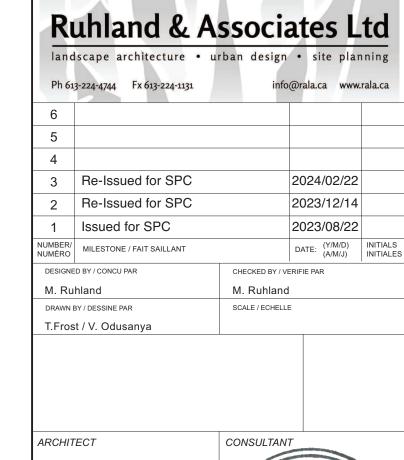

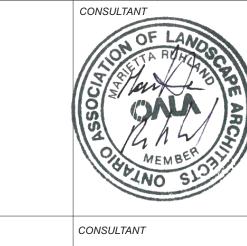

CONSULTANT CONSULTAN

PROJECT / LOCATION

THE NUKK

652 FLAGSTAFF DRIVE, OTTAWA ON.

DRAWING

DETAILS

SHEET NO.

PROJECT NO.

23-1719

L-03